

HVAC PLAN - SECOND FLOOR - BID

DEDUCT ITEM #3

1/4" = 1'-0"

CONSULTANTS: 25387 07/26/2018

VA FORM 08-623



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**MECHANICAL PLAN - SECOND FLOOR -**BID DEDUCT ITEM #3

Project Title
RENOVATE AND MODERNIZE HVAC SYSTEMS, BUILDING B6 Contract No.: VA255-17-D-0080 Task Order No.: 36C25518N1023 Obligation No.: 589-C81080

Project Number 589A7-17-300 Building Number Drawing Number

and Facilities Management

MECHANICAL GENERAL NOTES

IMMEDIATELY. MINOR CHANGES IN THE SCOPE OF THE DEMOLITION WORK SHALL NOT JUSTIFY AN ADDITIONAL

PROTECTIVE PLASTIC DROP CLOTHS TO PROTECT THE EXISTING OCCUPIED AREAS AND EQUIPMENT FROM DUST

CONSTRUCTION WORK AND SHALL

CONSTRUCTION DIRT DAILY, AND UPON

MAINS SHALL BE REFILLED WITH FLUID AND PROPERLY VENTED BY THIS CONTRACTOR, ONCE NEW WORK HAS

4. COORDINATE WITH THE OWNER THE REMOVAL AND REPLACEMENT OF ALL EXISTING CEILINGS, WALL, ETC. AS

. ALL CUTTING AND CHANNELING OF

CONTRACTOR SHALL PATCH AND REPLACE WITH MATERIAL SIMILAR TO

6. CUTTING OF STRUCTURAL MEMBERS IS

THIS CONTRACTOR SHALL GIVE FULL COOPERATION TO THE OWNER IN THE SCHEDULING AND PROCEDURE OF WORK AND SHALL TAKE EVERY PRECAUTION TO PREVENT DAMAGE

ADJACENT CONSTRUCTION.

FROM FREEZING TO EXISTING

B. RELOCATE EXISTING DUCTWORK, PIPING, ELECTRICAL CONDUITS, AND

ACCOMPLISH FINAL INSTALLATION AS

9. CAP ALL EXISTING DUCTWORK SHOWN TO BE DISCONNECTED AND NOT RE-

10. COORDINATE ROUTING OF PLUMBING AND HVAC PIPING WITH DUCTWORK, LIGHTS, ARCHITECTURAL CEILING AND STRUCTURAL ELEMENTS. PIPING SHALL RISE AND DROP, JOG OR OFFSET, AS REQUIRED TO AVOID CONFLICTS.

DUCTWORK SHALL TAKE PRECEDENCE OVER ALL PIPING, EXCEPT WHERE GRADE MUST BE MAINTAINED FOR

11. ANY EXPENSES RISING FROM LACK OF

CONTRACTOR'S EXPENSE. ALL DUCT AND PIPE ELEVATIONS SHOWN IN PARENTHESIS ARE BOTTOM OF DUCT

12. ALL SUPPLY, RETURN, AND EXHAUST BRANCHES TO GRILLES, REGISTERS, AND DIFFUSERS SHALL HAVE A MANUAL

13. PLENUM IS USED FOR RETURN AIR.

THE INTERNATIONAL FIRE CODE.

COMBUSTIBLES, PVC PIPING, AND ANY OTHER MATERIALS NOT ALLOWED BY

COORDINATION SHALL BE AT

OR PIPE UNLESS INDICATED OTHERWISE ON PLANS.

BALANCE DAMPER.

KEEP PLENUM FREE OF

CABLING AS NECESSARY TO

NOT ALLOWED.

SYSTEMS.

DRAINAGE.

EXISTING NON-STRUCTURAL ELEMENTS SHALL BE ACCOMPLISHED IN A NEAT AND WORKMANLIKE MANNER WITHOUT REMOVAL OF EXCESS MATERIALS. THIS

REQUIRED FOR MECHANICAL

FIELD VERIFY ALL EXISTING

2. CONTRACTOR SHALL PROVIDE

AND DEBRIS DURING THE

CLEAN THE AREAS OF ALL

COMPLETION OF THE WORK. . ALL DRAINED PIPING RISERS AND

BEEN INSTALLED.

DEMOLITION WORK.

CONDITIONS PRIOR TO BEGINNING WORK. BRING ANY DISCREPANCIES FROM THE DRAWINGS AND NOTES TO THE OWNER'S REPRESENTATIVE

Department of Veterans Affairs

Office of

Construction

Drawing Title


Approved: Project Director

Wichita, Kansas

07/26/18

BOH

MH103.3 Dwg.

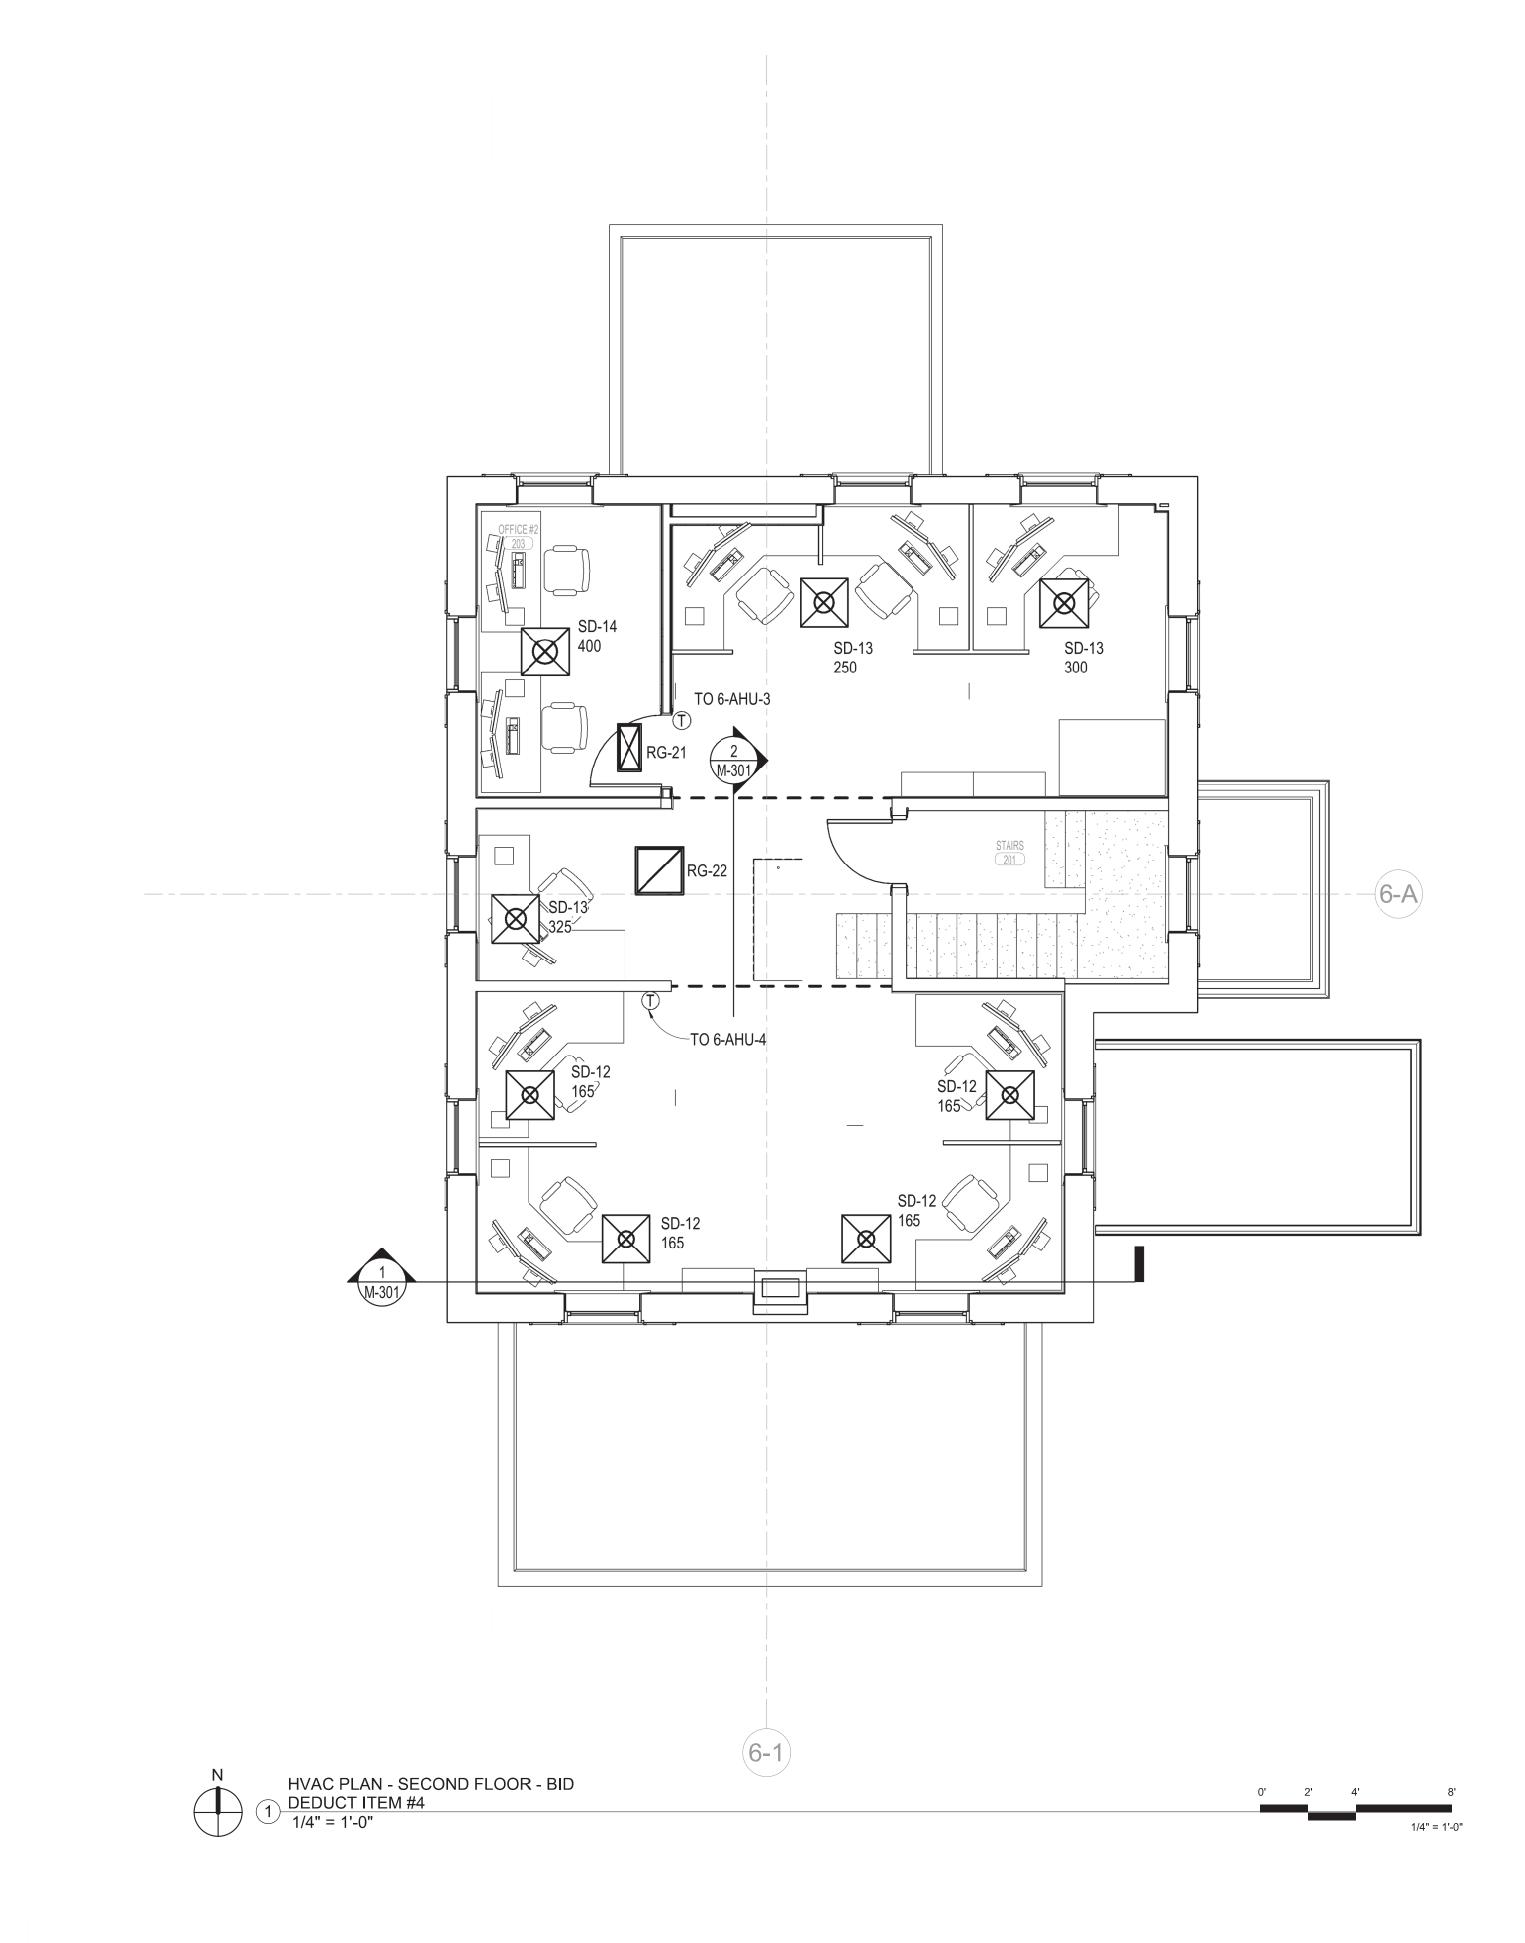

MECHANICAL GENERAL NOTES . FIELD VERIFY ALL EXISTING CONDITIONS PRIOR TO BEGINNING WORK. BRING ANY DISCREPANCIES FROM THE DRAWINGS AND NOTES TO THE OWNER'S REPRESENTATIVE IMMEDIATELY. MINOR CHANGES IN THE SCOPE OF THE DEMOLITION WORK SHALL NOT JUSTIFY AN ADDITIONAL . CONTRACTOR SHALL PROVIDE

PROTECTIVE PLASTIC DROP CLOTHS TO PROTECT THE EXISTING OCCUPIED AREAS AND EQUIPMENT FROM DUST AND DEBRIS DURING THE CONSTRUCTION WORK AND SHALL CLEAN THE AREAS OF ALL

CONSTRUCTION DIRT DAILY, AND UPON COMPLETION OF THE WORK. . ALL DRAINED PIPING RISERS AND MAINS SHALL BE REFILLED WITH FLUID

AND PROPERLY VENTED BY THIS CONTRACTOR, ONCE NEW WORK HAS BEEN INSTALLED. 1. COORDINATE WITH THE OWNER THE REMOVAL AND REPLACEMENT OF ALL EXISTING CEILINGS, WALL, ETC. AS REQUIRED FOR MECHANICAL

DEMOLITION WORK. . ALL CUTTING AND CHANNELING OF **EXISTING NON-STRUCTURAL ELEMENTS** SHALL BE ACCOMPLISHED IN A NEAT AND WORKMANLIKE MANNER WITHOUT REMOVAL OF EXCESS MATERIALS. THIS CONTRACTOR SHALL PATCH AND REPLACE WITH MATERIAL SIMILAR TO ADJACENT CONSTRUCTION.

6. CUTTING OF STRUCTURAL MEMBERS IS NOT ALLOWED. THIS CONTRACTOR SHALL GIVE FULL SCHEDULING AND PROCEDURE OF

COOPERATION TO THE OWNER IN THE WORK AND SHALL TAKE EVERY PRECAUTION TO PREVENT DAMAGE FROM FREEZING TO EXISTING SYSTEMS. B. RELOCATE EXISTING DUCTWORK,

PIPING, ELECTRICAL CONDUITS, AND CABLING AS NECESSARY TO ACCOMPLISH FINAL INSTALLATION AS

9. CAP ALL EXISTING DUCTWORK SHOWN TO BE DISCONNECTED AND NOT RE-

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OTHERWISE ON PLANS. 12. ALL SUPPLY, RETURN, AND EXHAUST BRANCHES TO GRILLES, REGISTERS, AND DIFFUSERS SHALL HAVE A MANUAL BALANCE DAMPER.

13. PLENUM IS USED FOR RETURN AIR. KEEP PLENUM FREE OF COMBUSTIBLES, PVC PIPING, AND ANY OTHER MATERIALS NOT ALLOWED BY THE INTERNATIONAL FIRE CODE.

CONSULTANTS:

VA FORM 08-623

ARCHITECT/ENGINEERS: 25387 07/26/2018

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Drawing Title

**MECHANICAL PLAN - SECOND FLOOR -**BID DEDUCT ITEM #4 Approved: Project Director

Project Title
RENOVATE AND MODERNIZE HVAC SYSTEMS, BUILDING B6 Contract No.: VA255-17-D-0080 Task Order No.: 36C25518N1023 Obligation No.: 589-C81080

Wichita, Kansas

07/26/18

Project Number 589A7-17-300 Building Number Drawing Number


Dwg.

RMH

BOH

Office of Construction and Facilities Management

MH103.4 Department of Veterans Affairs

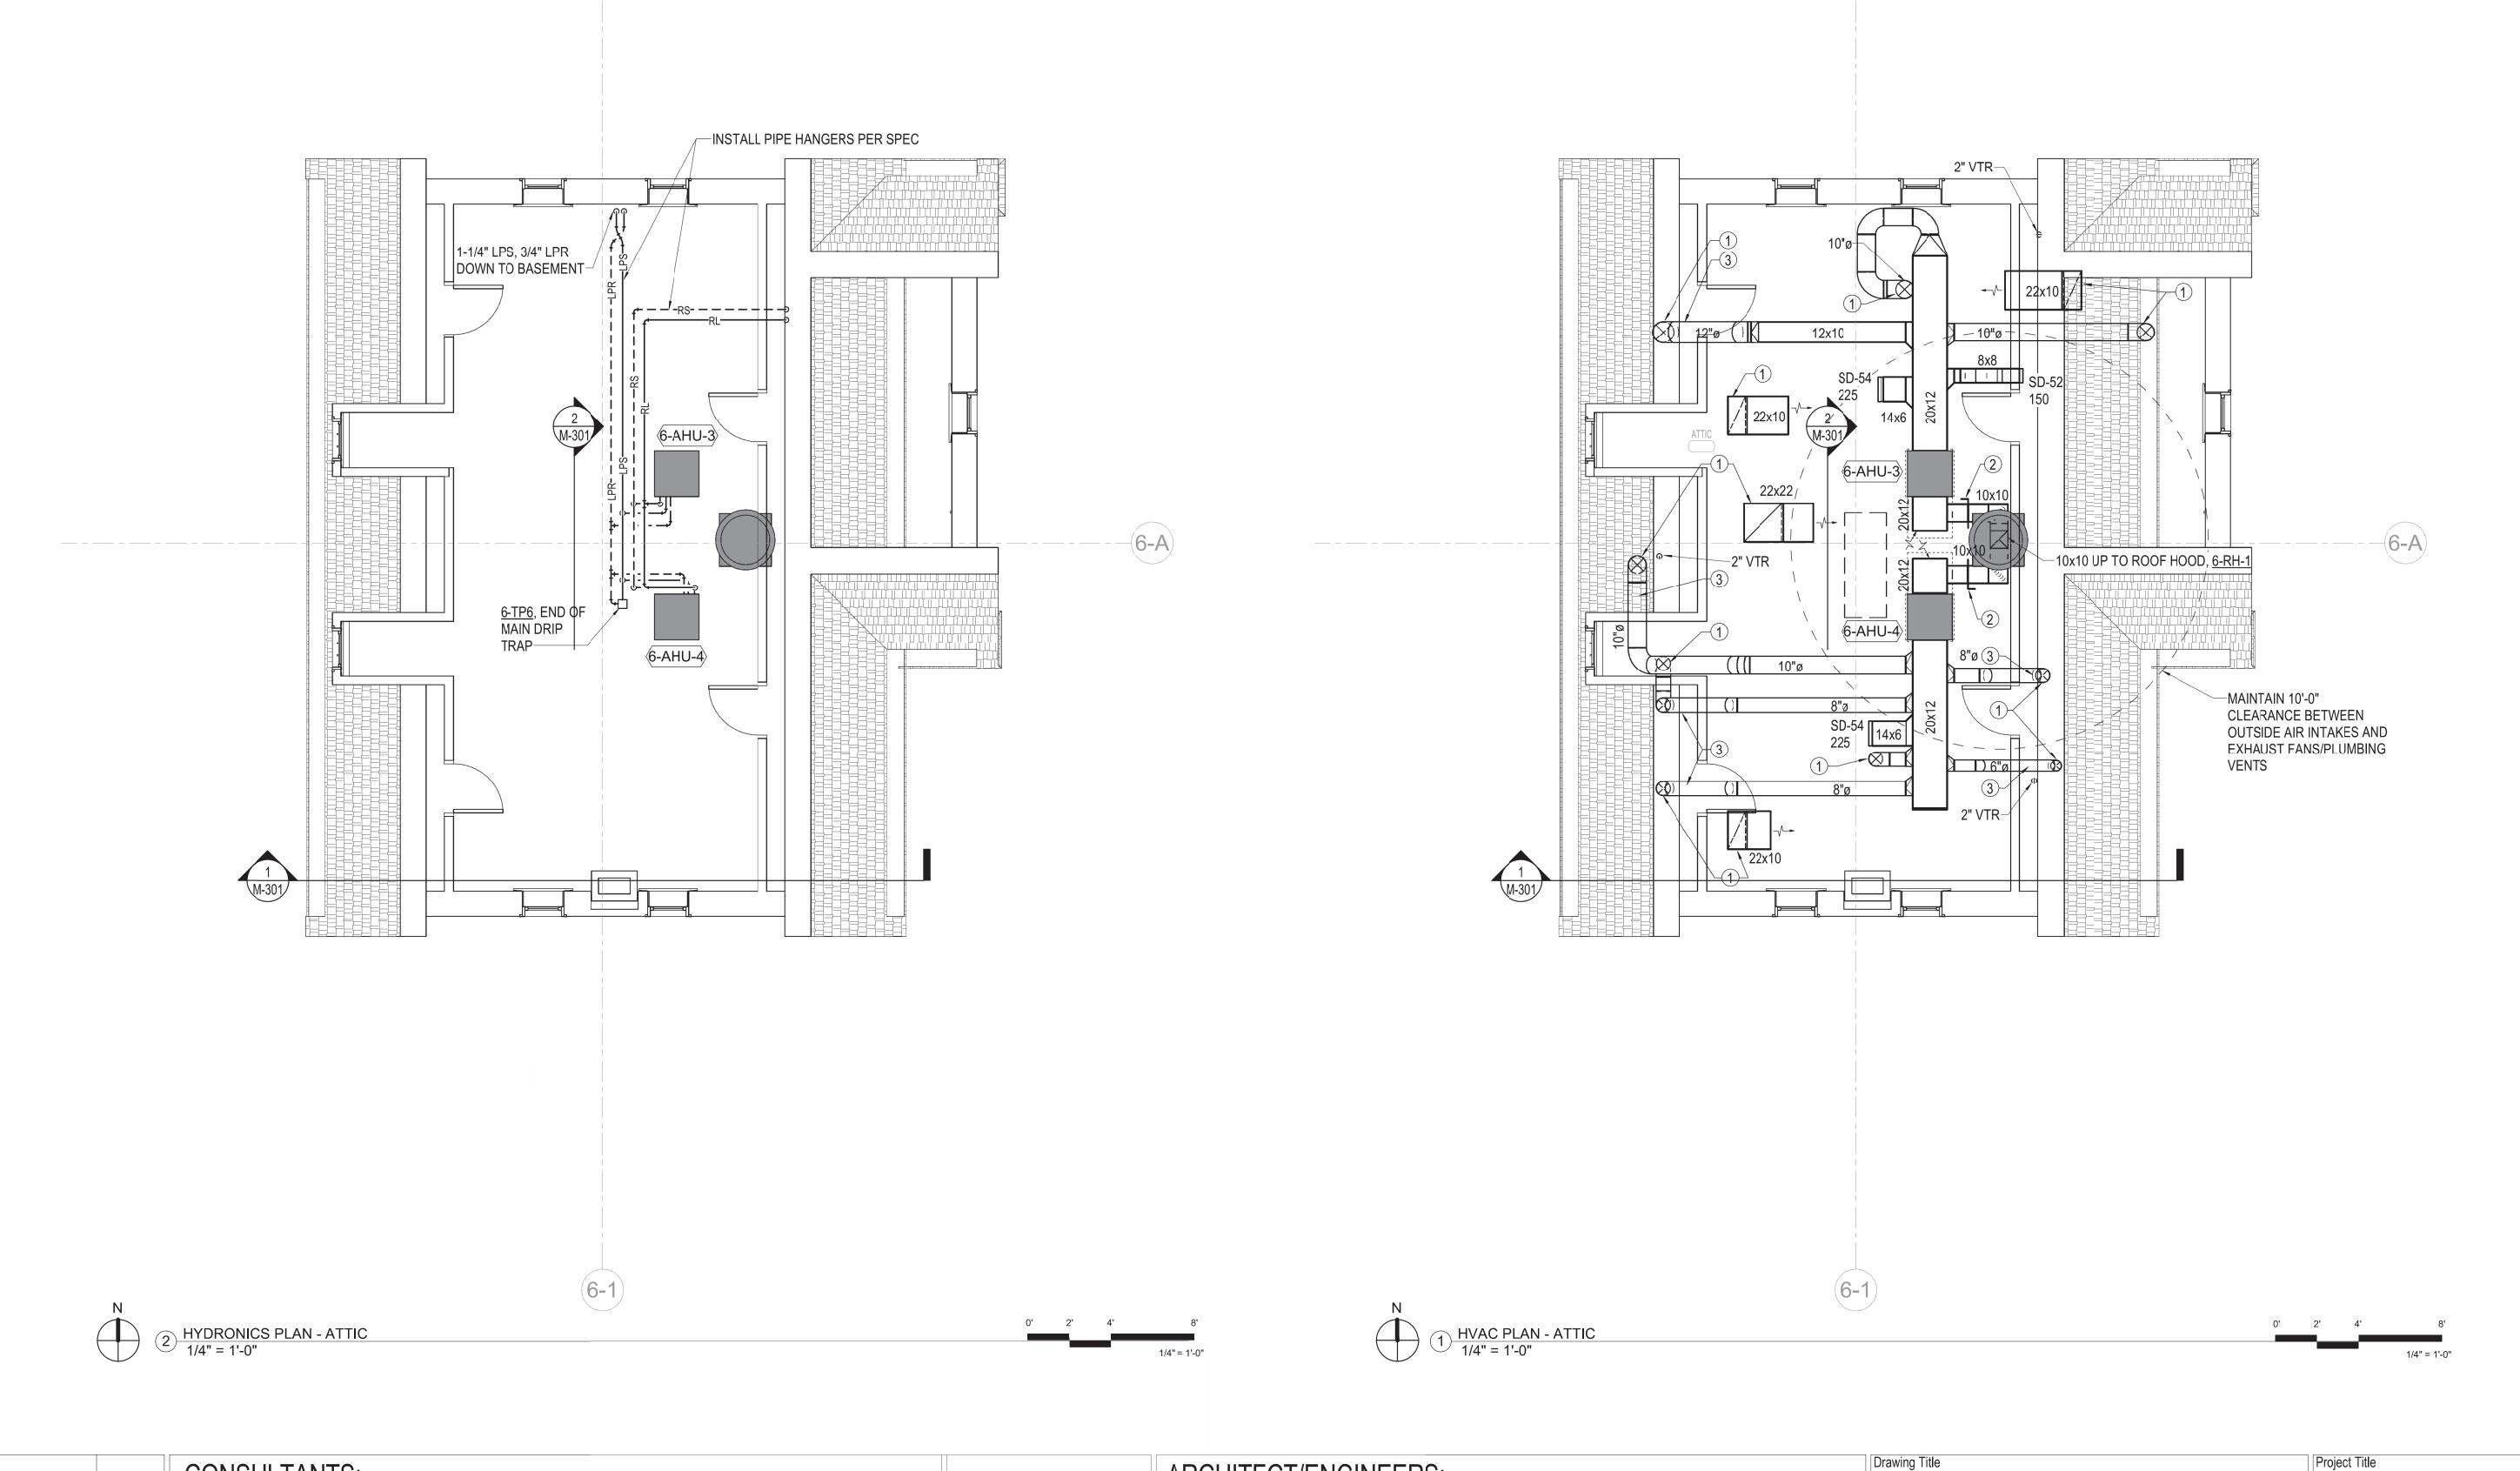

MECHANICAL GENERAL NOTES

FIELD VERIFY ALL EXISTING CONDITIONS PRIOR TO BEGINNING WORK. BRING ANY DISCREPANCIES FROM THE DRAWINGS AND NOTES TO THE OWNER'S REPRESENTATIVE IMMEDIATELY. MINOR CHANGES IN THE SCOPE OF THE DEMOLITION WORK SHALL NOT JUSTIFY AN ADDITIONAL

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12. ALL SUPPLY, RETURN, AND EXHAUST BRANCHES TO GRILLES, REGISTERS, AND DIFFUSERS SHALL HAVE A MANUAL BALANCE DAMPER.

13. PLENUM IS USED FOR RETURN AIR. KEEP PLENUM FREE OF COMBUSTIBLES, PVC PIPING, AND ANY OTHER MATERIALS NOT ALLOWED BY THE INTERNATIONAL FIRE CODE.

## **PLAN NOTES**

. DUCTWORK DOWN TO SECOND FLOOR DIFFUSER/REGISTER.

2. DAMPER IN OUTSIDE AIR DUCTS TO BE SET AT 160 CFM FOR EACH AHU. B. DUCTWORK INSTALLED IN NON-

VENTILATED ATTIC SPACE. NON-VENTILATED ATTIC SPACE WILL REQUIRE OUTDOOR INSULATION TO BE INSTALLED (REFERENCE SPECS).

CONSULTANTS:

VA FORM 08-62

25387 07/26/2018 74NSAS

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ARCHITECT/ENGINEERS:



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Project Title
RENOVATE AND MODERNIZE HVAC SYSTEMS, **MECHANICAL PLAN - ATTIC** 

BUILDING B6
Contract No.: VA255-17-D-0080
Task Order No.: 36C25518N1023
Obligation No.: 589-C81080 Wichita, Kansas

Project Number 589A7-17-300 Building Number


Office of Construction and Facilities Management

Department of Veterans Affairs

303 SOUTH TOPEKA WICHITA, KS 67202 316-262-2691 www.pec1.com

Drawing Number BOH 07/26/18

**MH104** Dwg.

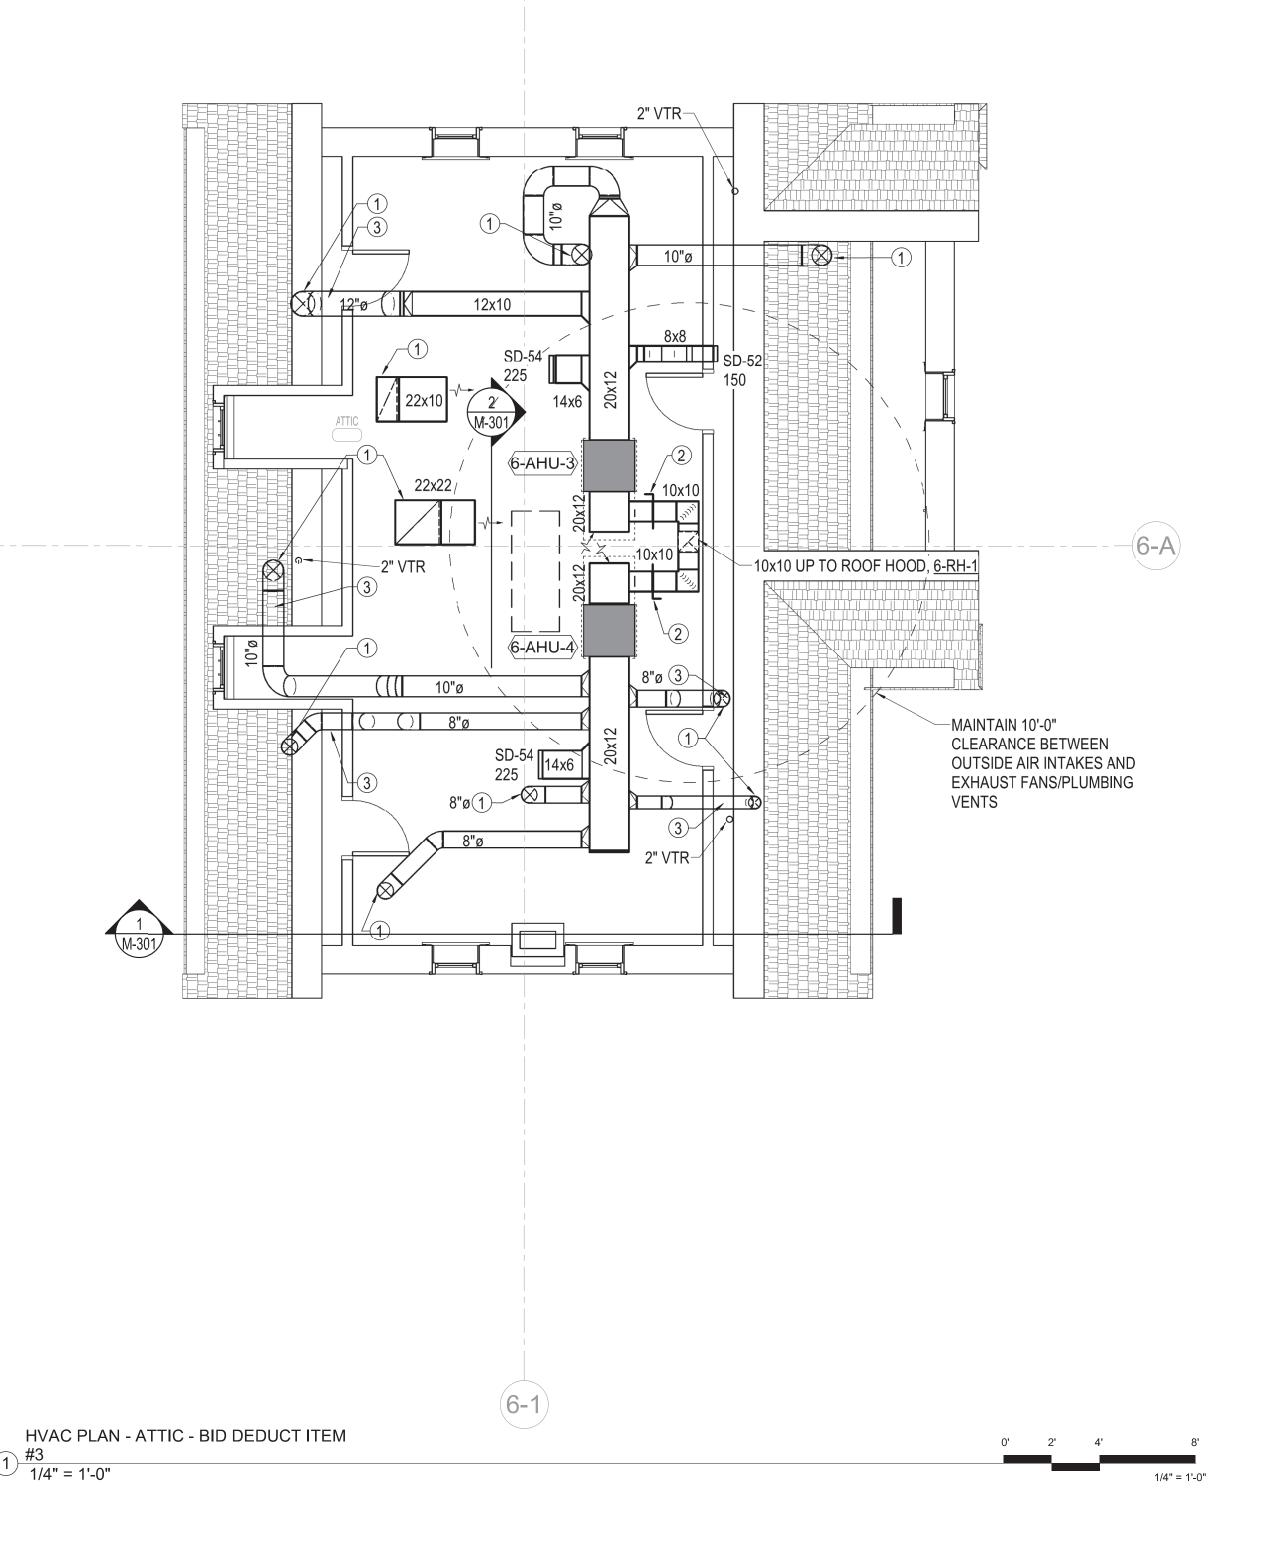

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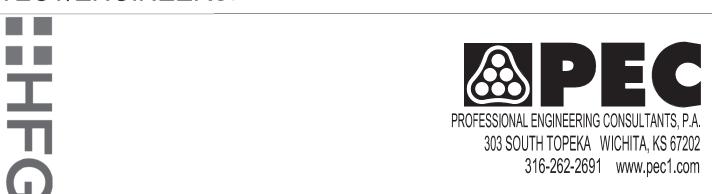
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CONSULTANTS:

VA FORM 08-623

ARCHITECT/ENGINEERS: 25387 07/26/2018

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Drawing Title **MECHANICAL PLAN - ATTIC - BID** 

**DEDUCT ITEM #3** Approved: Project Director

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Wichita, Kansas

07/26/18

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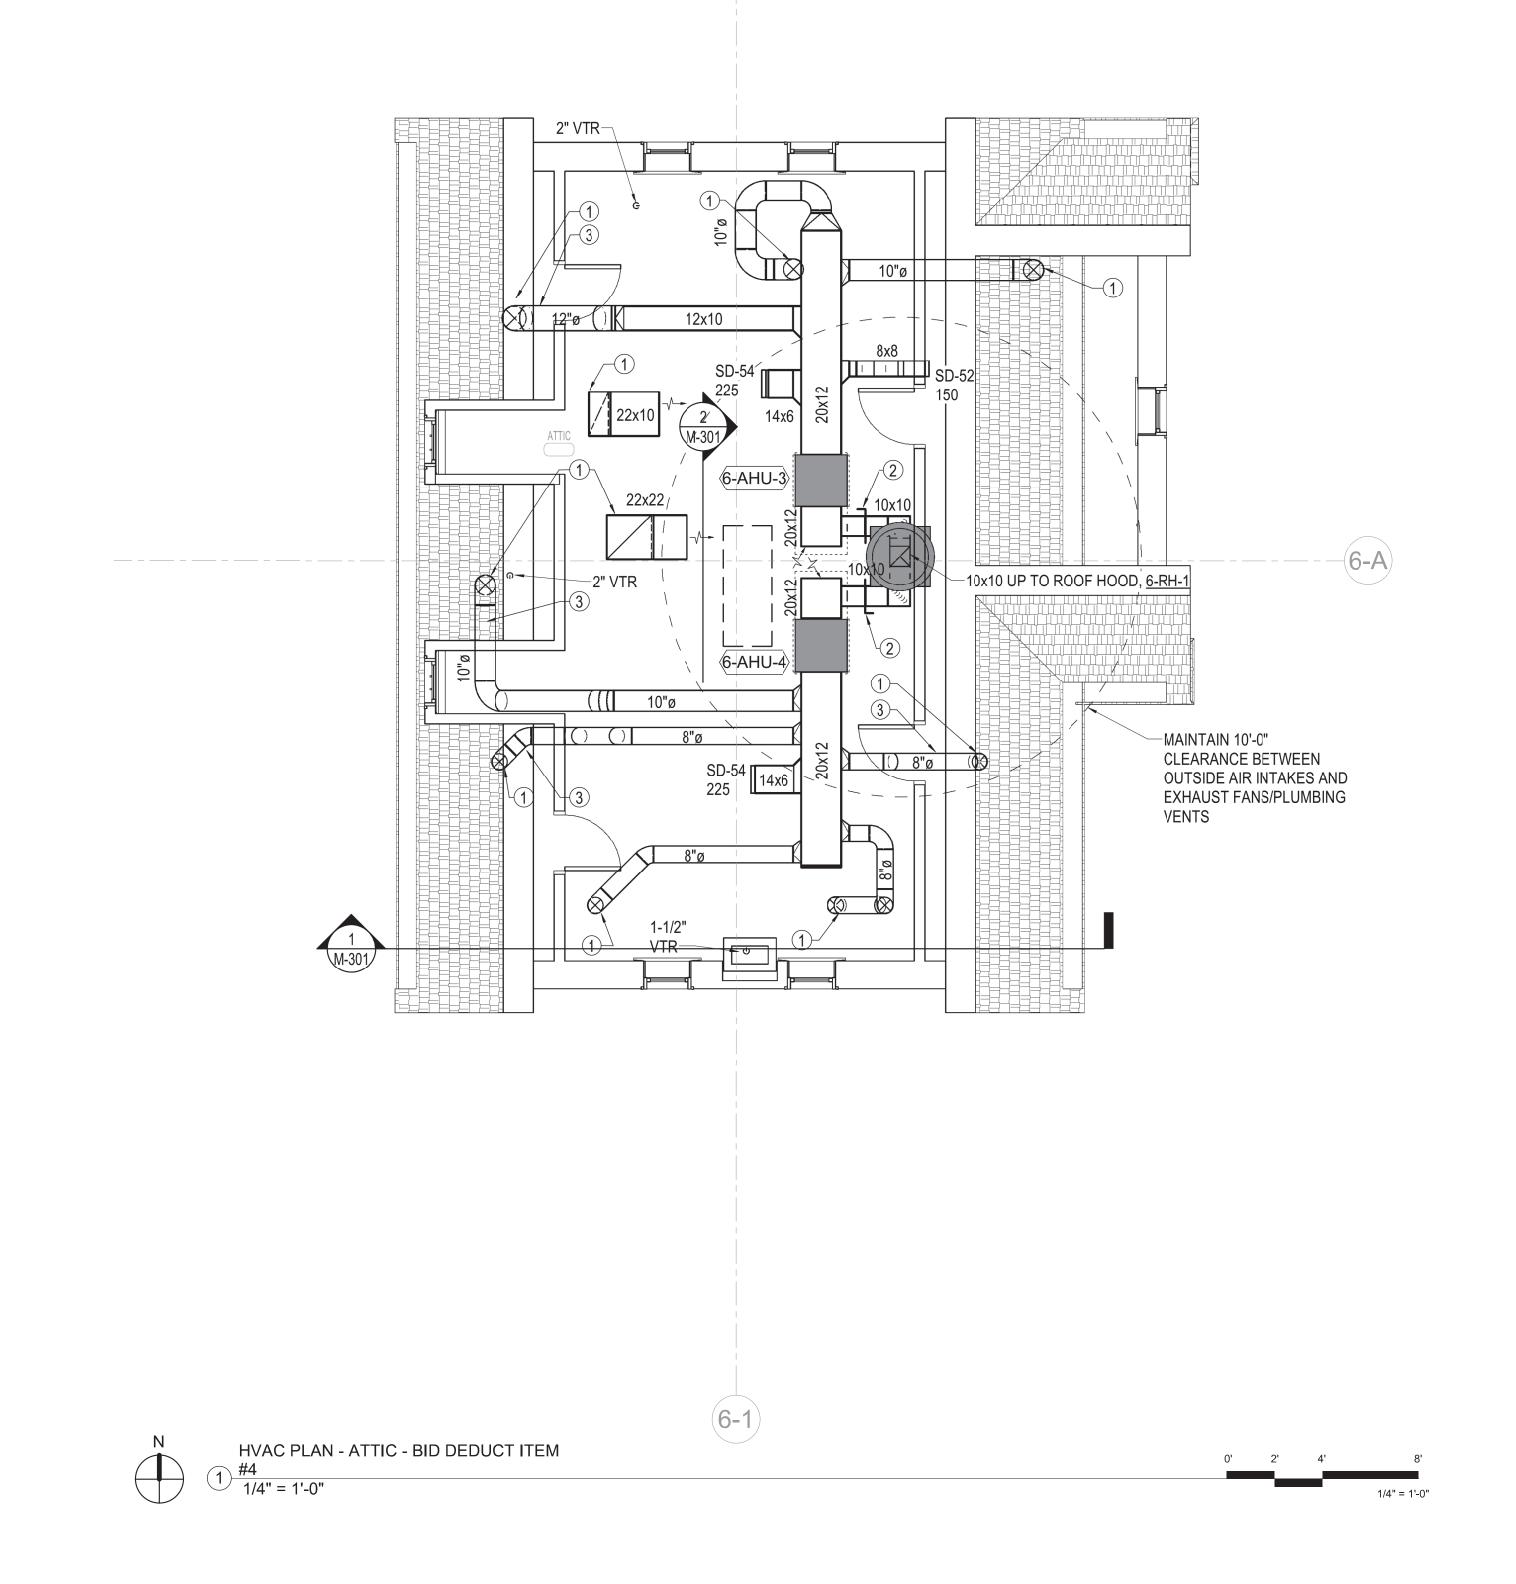
RMH

BOH

Construction and Facilities Management

Office of

MH104.3 Department of Veterans Affairs



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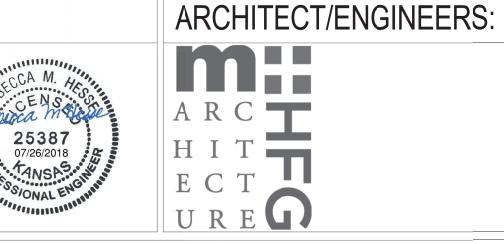
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CONSULTANTS:

VA FORM 08-623



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**MECHANICAL PLAN - ATTIC - BID DEDUCT ITEM #4** Approved: Project Director

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Wichita, Kansas

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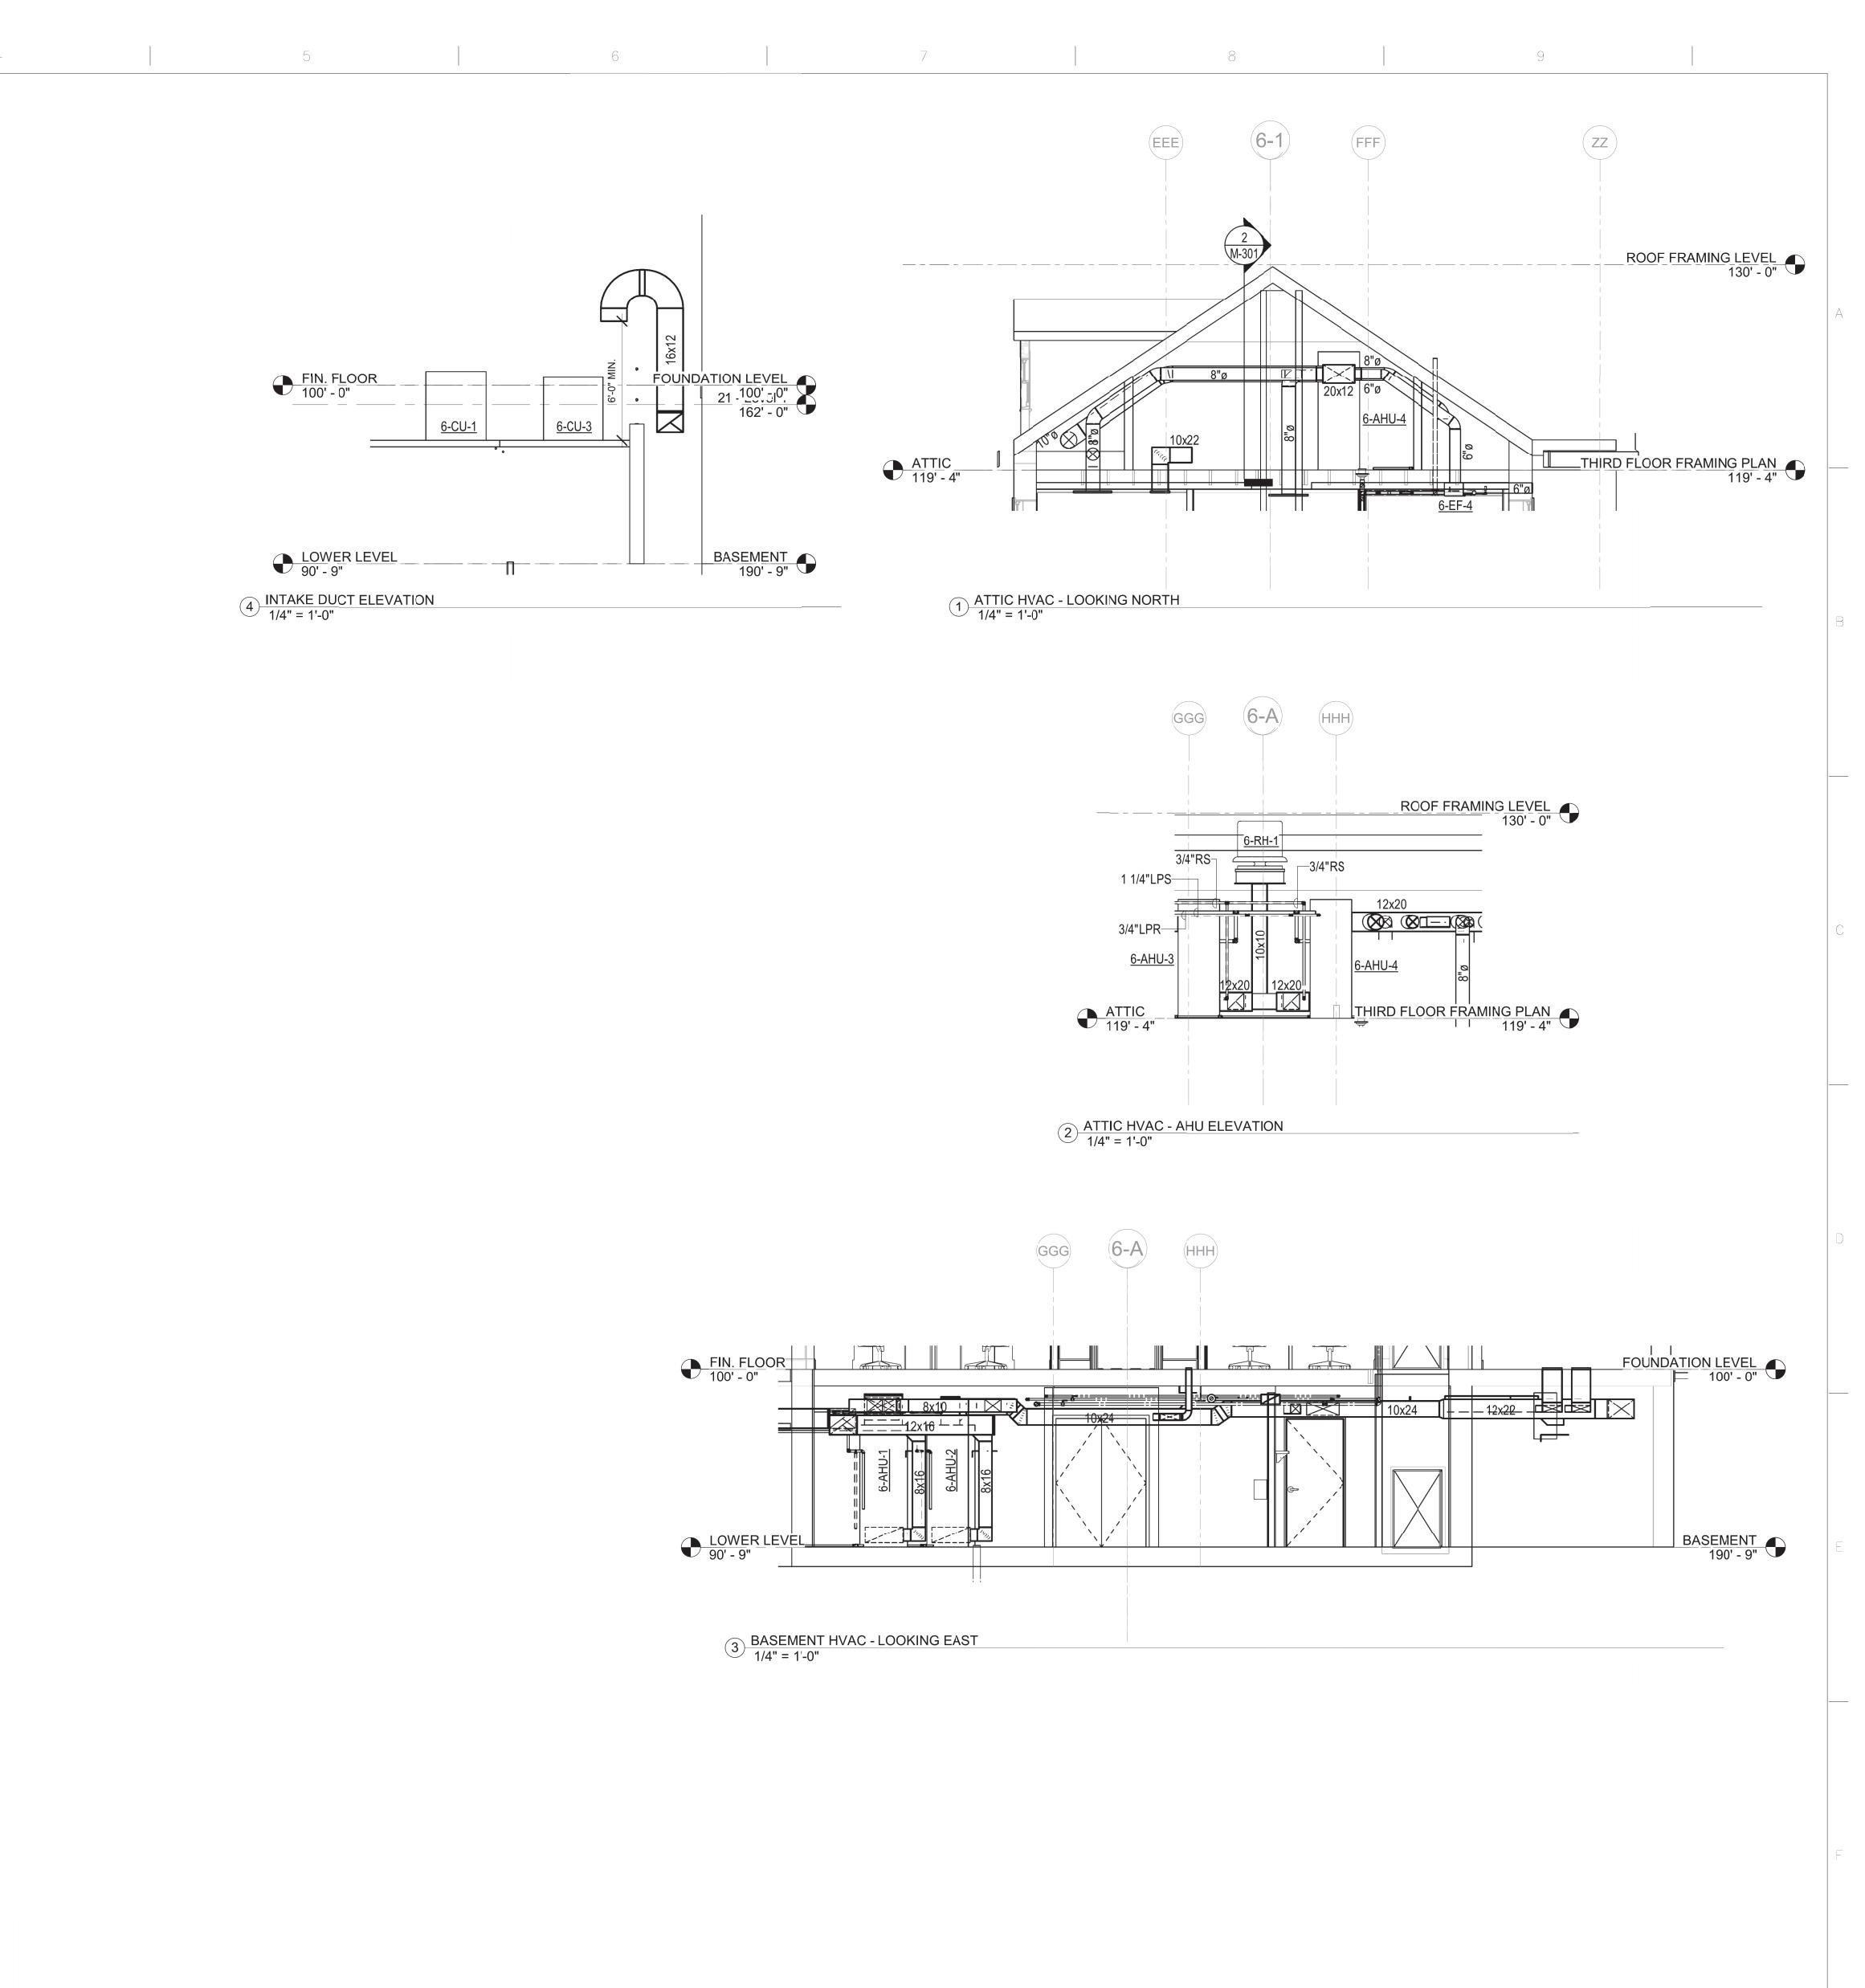
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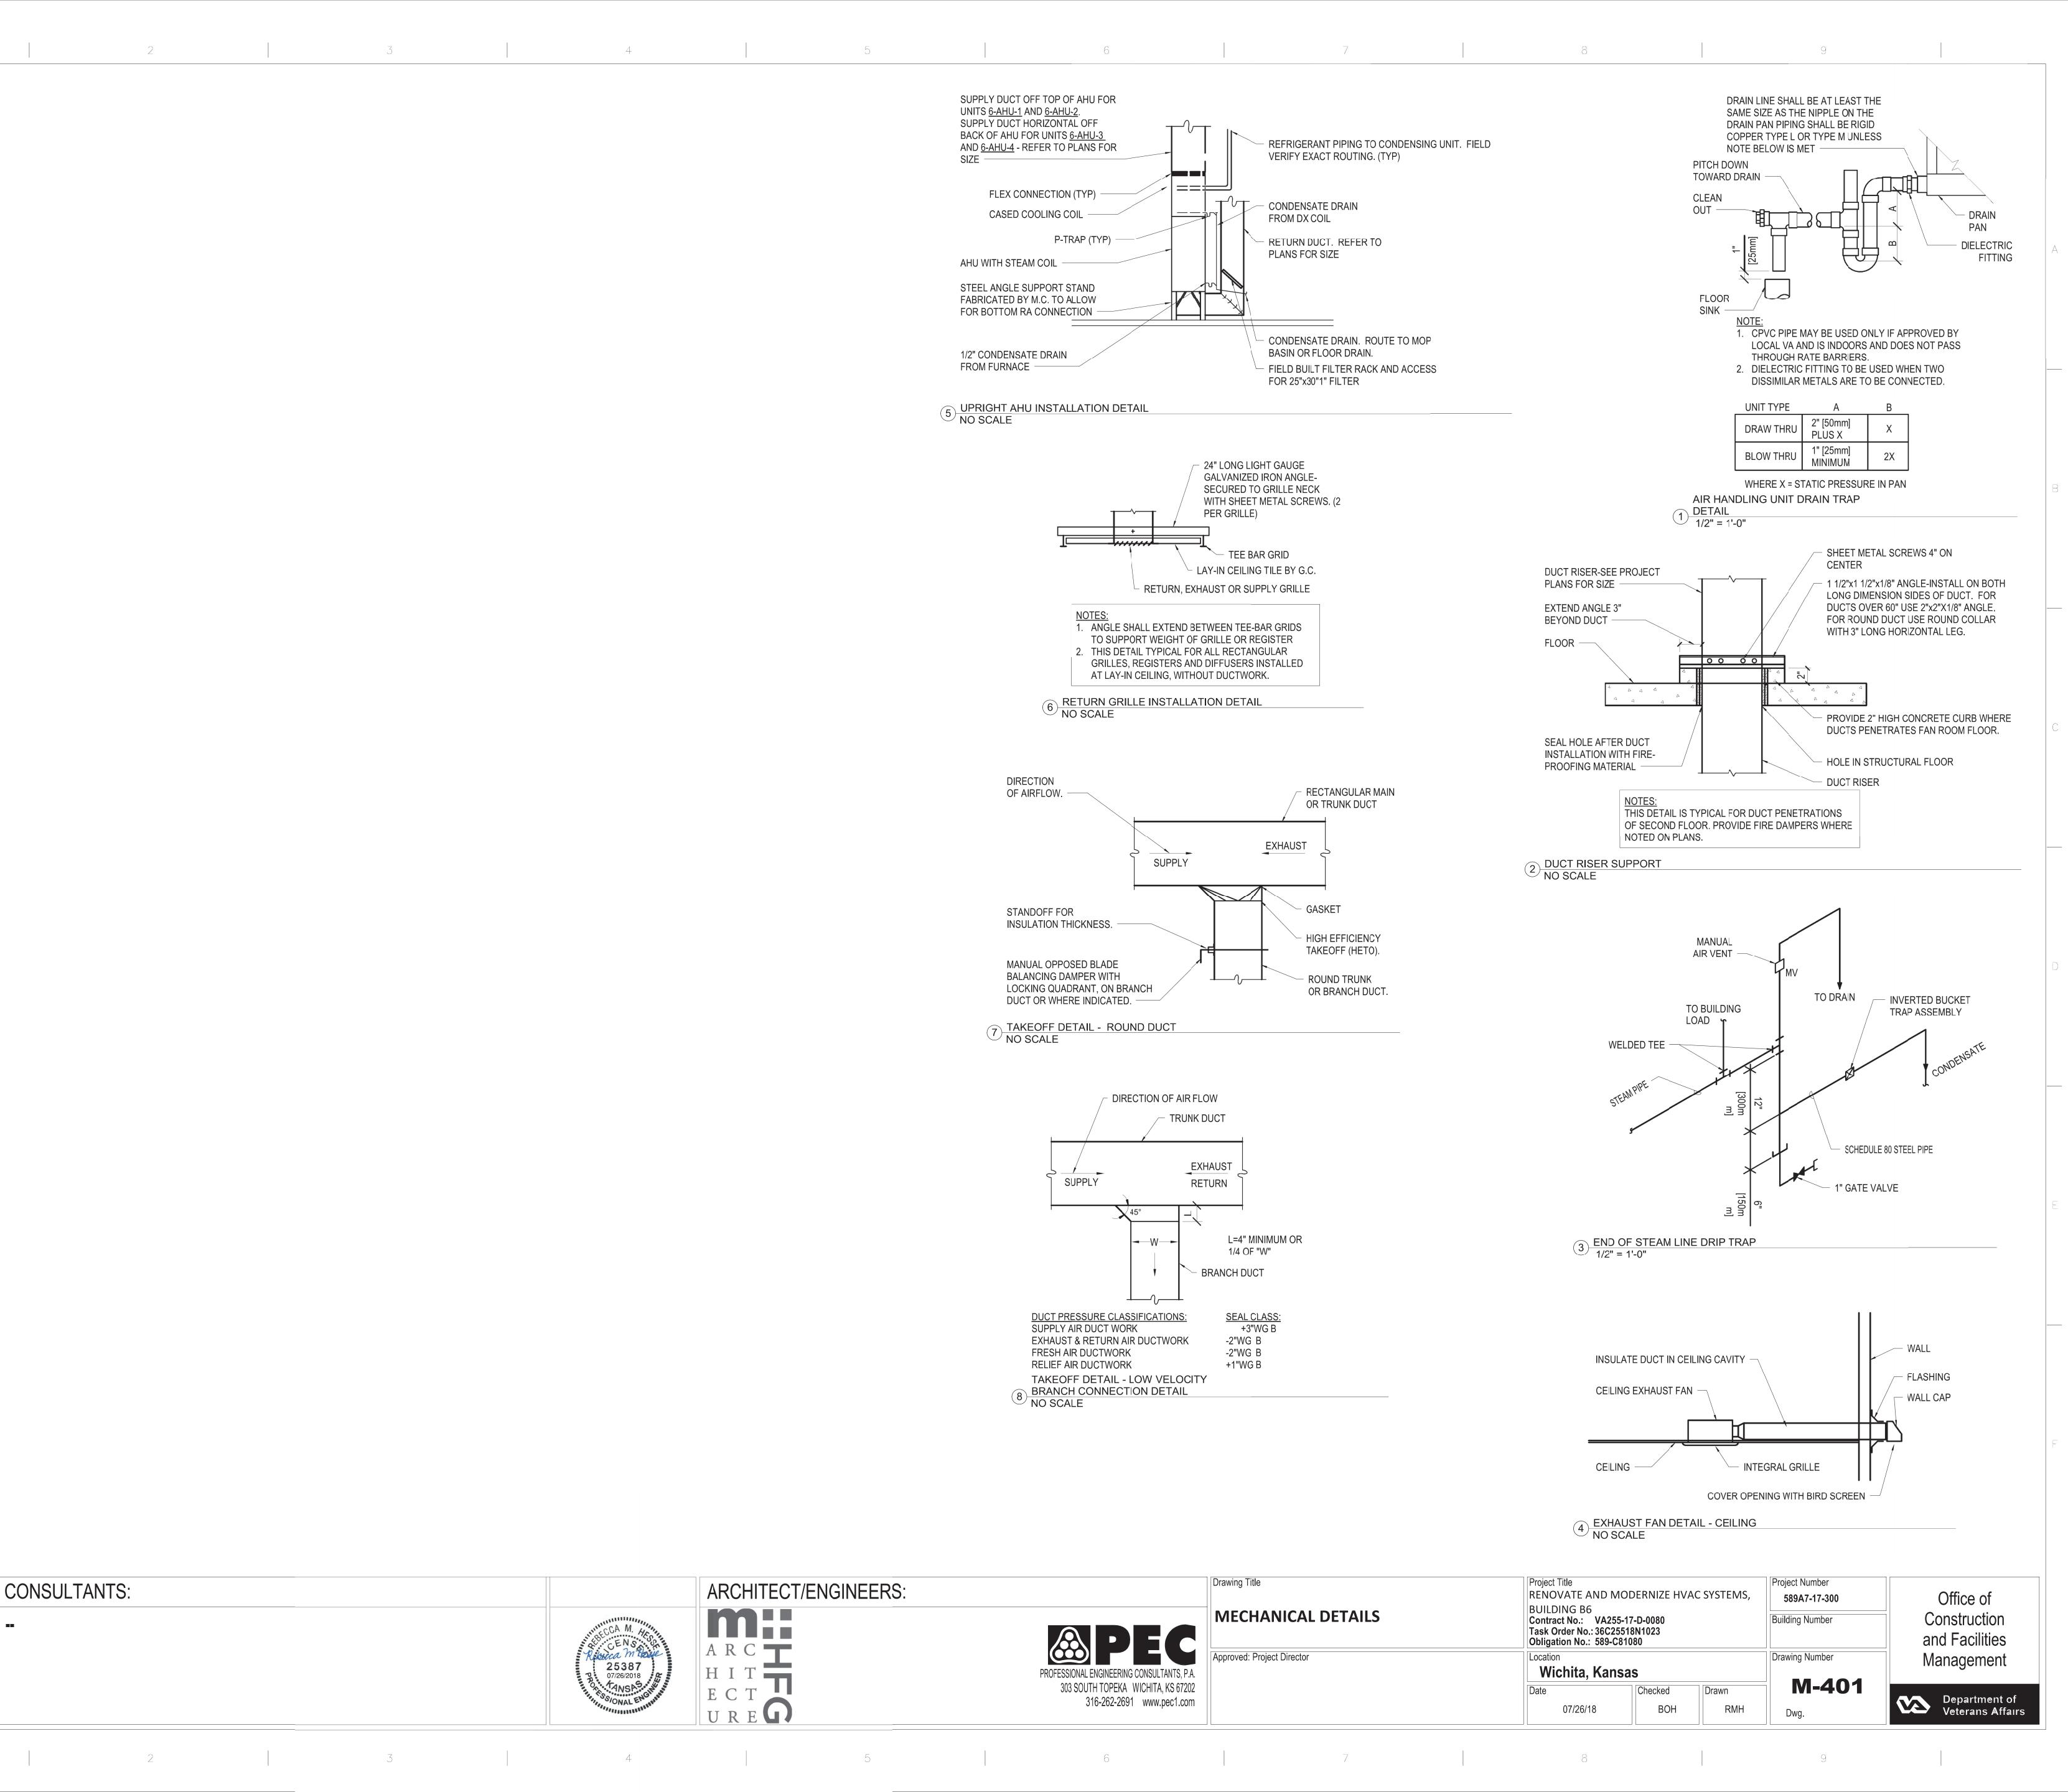
Office of Construction and Facilities Management

MH104.4 Department of Veterans Affairs





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CONSULTANTS:

25387 07/26/2018

													SCHEDU	<del></del>							
		AREA AND/OR	SYSTEM	AIR I	-LOW	MAX FACE	VELOCITY	AF	PD		TEMPER	RATURES		TOTAL C	APACITY	SENSIBLE	CAPACITY			D SUCTION	
MARK	LOCATION	BLDG SERVED	AND/OR	7				7."	_	E	AT	L	AT		7.1.7.0.11	02.10.522	0,11,10111	REFRIGERANT	TE	MP	REMARKS
		DED CERVED	SERVICE	CFM	[L/s]	FPM	[M/s]	IN WG	[Pa]	°F	[°C]	°F	[°C]	MBH	[kW]	MBH	[kW]		°F	[°C]	
-CC1	6-AHU-1	BSMT/1ST NORTH	6-AHU-1, 6-CU-1	1,575	[-]	500	[]	0.24	[]	80/65	[]	54/52	[-]	58.9	[]	44.4	[]	R-410a	45	[-]	LOW AMBIENT CAPABLE TO 0 D
-CC2	6-AHU-2	BSMT/1ST SOUTH	6-AHU-2, 6-CU-2	1,615	[-]	500	[]	0.24	[]	79/64	[]	54/52	[-]	56.2	[]	44.1	[]	R-410a	45	[-]	LOW AMBIENT CAPABLE TO 0 D
-CC3	6-AHU-3	2ND/ATTIC NORTH	6-AHU-3, 6-CU-3	1,325	[-]	500	[]	0.39	[]	75/62	[]	55/55	[-]	29.3	[]	29.3	[]	R-410a	45	[]	LOW AMBIENT CAPABLE TO 0 D
CC4	6-AHU-4	2ND/ATTIC SOUTH	6-AHU-4, 6-CU-4	1,210	[-]	500	[]	0.34	[]	75/62	[]	54/52	[]	34.1	[]	27.6	[]	R-410a	45	[]	LOW AMBIENT CAPABLE TO 0 DE

							AIR	COOLED	CONDE	NSING UI	VIT SC	HEDU	LE								
		SYSTEM	CAD	ACITY	SUCTIO	N TEMP	AMDIE	NT AIR	MAYCO	ND TEMP		COMP	RESSOR	MOTOR			CONDE	NSER FA	N MOTOR		
MARK	RK LOCATION	AND/OR	CAP	ACII I	300110	IN I EIVIP	AIVIDIE	INI AIK	IVIAX CO	IND I EIVIP	#	POV	NER	DUACE	VOLT	#	PO	WER	DUACE	VOLT	DEMARKS
		SERVICE	MBH	[kW]	F	[C]	F	[C]	F	[C]	COMP	RLA	[kW]	PHASE	VOLT	COND FAN	HP	[kW]	PHASE	VOLT	REMARKS
6-CU-1	NE LAWN	6-AHU-1	54.3	[]	45	[]	105	[]	105	[]	1	26	[]	1	208	1	0.33	[]	1	208	INSTALL ON CURB PER SPEC
6-CU-2	NE LAWN	6-AHU-2	54.3	[]	45	[]	105	[]	105	[]	1	26	[]	1	208	1	0.33	[]	1	208	INSTALL ON CURB PER SPEC
6-CU-3	NE LAWN	6-AHU-3	36.0	[]	45	[]	105	[]	105	[]	1	18.5	[]	1	208	1	0.33	[]	1	208	INSTALL ON CURB PER SPEC
6-CU-4	NE LAWN	6-AHU-4	36.0	[]	45	[]	105	[]	105	[]	1	18.5	[]	1	208	1	0.33	[]	1	208	INSTALL ON CURB PER SPEC

MARK	LOCATION	SYSTEM AND/OR	CAPACITY AT MII	N DIFF PRESSURE	MIN DIFF I	PRESSURE	MAX INLET	PRESSURE	TDADTVDE	TRA	AP SIZE	REMARKS
MAIN	LOCATION	SERVICE	LBS/HR	[kg/HR]	PSI	[kPa]	PSI	[kPa]	TRAP TYPE	IN	[mm]	KEWAKKS
6-TP1	BASEMENT	6-HC1	152	[]	5	[]	5	[-]	FLOAT AND THERMOSTATIC	3/4"	[]	1
6-TP2	BASEMENT	6-HC2	154	[-]	5	[]	5	[-]	FLOAT AND THERMOSTATIC	3/4"	[]	1
6-TP3	ATTIC	6-HC3	100	[-]	5	[]	5	[-]	FLOAT AND THERMOSTATIC	3/4"	[]	1
6-TP4	ATTIC	6-HC4	96	[-]	5	[]	5	[-]	FLOAT AND THERMOSTATIC	3/4"	[]	1
6-TP5	BASEMENT	END OF MAIN DRIP	23	[-]	5	[]	5	[-]	FLOAT AND THERMOSTATIC	3/4"	[]	1
6-TP6	ATTIC	END OF MAIN DRIP	15	[]	5	[]	5	[-]	FLOAT AND THERMOSTATIC	3/4"	[]	1

one eighth inch = one foot

0 4 8 16

VA FORM 08-6231

								AIR DEVICE	E SCHEDU	JLE (SUPPLY)						
			AIR F	FLOW		MAX	ADD		PANE	L/FRAME SIZE	NE	ECK SIZE				
MARK	TYPE		MIN	N	/AX	IVIAX	APD	MOUNTING	IN x IN	[mm v mm]	IN	lmm 1	NC	DAMPER	FINISH	REMARKS
		CFM	[L/s]	CFM	[L/s]	IN WG	[Pa]		IIN X IIN	[mm x mm]	IIV	mm ]				
SD-11	LOUVERED FACE	25	[]	75	[]	0.080	[]	CEILING	12 x 12	[300 x 300]	6" DIAM.	[ DIAM.]	22	OBD	WHITE	****
SD-12	LOUVERED FACE	100	[]	205	[-]	0.080	[-]	CEILING	24 x 24	[600 x 600]	8" DIAM.	[ DIAM.]	22	OBD	WHITE	
SD-13	LOUVERED FACE	250	[]	325	[-]	0.080	[-]	CEILING	24 x 24	[600 x 600]	10" DIAM.	[ DIAM.]	22	OBD	WHITE	****
SD-14	LOUVERED FACE	350	[]	500	[-]	0.080	[-]	CEILING	24 x 24	[600 x 600]	12" DIAM.	[ DIAM.]	22	OBD	WHITE	
SD-51	SUPPLY REGISTER	25	[]	75	[-]	0.050	[-]	SURFACE	6 x 6	[]	6 x 6	[]	18	OBD	WHITE	****
SD-52	SUPPLY REGISTER	100	[]	150	[-]	0.050	[-]	SURFACE	8 x 8	[]	8 x 8	[]	18	OBD	WHITE	****
SD-53	SUPPLY REGISTER	175	[]	250	[-]	0.050	[-]	SURFACE	10 x 8	[]	10 x 8	[]	18	OBD	WHITE	
SD-54	SUPPLY REGISTER	175	[]	250	[-]	0.050	[-]	SURFACE	14 x 6	[]	14 x 6	[]	18	OBD	WHITE	
SD-61	SUPPLY REGISTER	25	[]	100	[-]	0.040	[-]	FLOOR	12 x 4	[]	12 x 4	[]	20	OBD	ALUMINUM	А
SD-62	SUPPLY REGISTER	105	[]	130	[-]	0.040	[-]	FLOOR	12 x 5	[]	12 x 5	[]	20	OBD	ALUMINUM	А

1. SEE FLOOR PLAN FOR THROW PATTERN. 2. SEE DETAIL FOR DAMPER IN BRANCH DUCT SERVING EACH DIFFUSER. 3. PROVIDE SQUARE TO ROUND ADAPTER.

A. PROVIDE FLOOR REGISTER WITH "NO FLANGE FLUSH MOUNT" BORDER ON SURFACES WITHOUT CARPET OR PROVIDE WITH "CARPET CLAMP FLANGE" BORDER ON CARPETED SURFACES. PROVIDE WITH HEAVY DUTY CORE, 1/4" SPACING BETWEEN BARS, 15 DEG. DEFLECTION.

			AIR I	FLOW		MAX	۸DD		DANEI	FRAME SIZE	NI	CK SIZE				
MARK	TYPE	M	IN	M	AX	IVIAA	AFD	MOUNTING	FAINEL	TRAWIE SIZE	INC	ON SILL	NC	DAMPER	FINISH	REMARKS
		CFM	[L/s]	CFM	[L/s]	IN WG	[Pa]		IN x IN	[mm x mm]	IN x IN	[mm x mm]				
RG-21	PERFORATED	50	[]	700	[]	0.040	[]	CEILING	24 x 12	[600 x 300]	22 x 10	[-]	13	NONE	WHITE	
RG-22	PERFORATED	700	[]	1500	[]	0.040	[]	CEILING	24 x 24	[ 600 x 600 ]	22 x 22	[]	26	NONE	WHITE	
RR-51	REGISTER	0	[-]	230	[]	0.040	[]	FLOOR	12 x 6	[]	12 x 6	[-]	20	NONE	ALUMINUM	1

								_			FAN SCHED	ULE													
		AREA AND/OR	SYSTEM AND/OR	ΛID	R FLOW		TSP				FAN									MOTOR ELE	ECTRICAL				
MARK	LOCATION	BLDG SERVED	SERVICE	AIR	FLOW		101	TYPE	WHEEL	CLASS	ARRANGEMENT, ROTATION, AND	DIAME	ETER	MIN % EFF	DRIVE	FAN MAX	NO	OMINAL PO	WER	VOLT	PHASE	RPM	SPEED CONTROL	CONTROL SEQUENCE	REMARKS
				CFM	[L/s]	IN	[Pa]	ITPE	VVNECL	CLASS	DISCHARGE	IN	[mm]		DRIVE	RPM	AMPS	HP	[W]	VOLI	PHASE	KEIVI			
6-EF-1	CEILING	BSMT HSKPG	GEN. EXHAUST	75	[]	0.25	[]	CEILING			SIDEWALL WALL CAP DISCHARGE		[]		DIRECT		0.10		6.1	120	1		1	INTERLOCK WITH LIGHT	1
6-EF-2	CEILING	1ST FLR RR	GEN. EXHAUST	100	[]	0.25	[]	CEILING			SIDEWALL WALL CAP DISCHARGE		[]		DIRECT		0.20		8.4	120	1		1	INTERLOCK WITH LIGHT	1
6-EF-3	CEILING	1ST FLR RR	GEN. EXHAUST	100	[]	0.25	[]	CEILING			SIDEWALL WALL CAP DISCHARGE		[]		DIRECT		0.20		8.4	120	1		1	INTERLOCK WITH LIGHT	1
6-EF-4	CEILING	2ND FLR RR	GEN. EXHAUST	100	[]	0.25	[]	CEILING			SIDEWALL WALL CAP DISCHARGE		[]		DIRECT		0.20		8.4	120	1		1	INTERLOCK WITH LIGHT	1, OMIT IN BID DEDUCT ITEM #4
6-RH-1	ROOF	6-AHU-3, 6-AHU-4	OUTDOOR AIR	320	[]	0.25	[]						[]						-						2

1. FAN BASED ON LOW-PROFILE (7" DEEP) CEILING EXHAUST FAN WITH ROUND DUCT CONNECTION. ROUND DUCT TO CONNECT AND ROUTE TO BUILDING EXTERIOR WALL CAP. WALL CAP. WALL CAP. WALL CAP TO BE ALUMINUM FINISH, FIELD-PAINTABLE, AND PROVIDED WITH BIRD SCREEN AND BACKDRAFT DAMPER. ARCHITECT TO APPROVE GRILLE OPTION OF CEILING EXHAUST FAN IN SUBMITTALS. EXHAUST FAN SHALL BE INTERLOCKED WITH WALL LIGHT SWITCH. UPON ACTIVATION OF ROOM LIGHTS, FAN SHALL TURN ON.
2. GRAVITY INTAKE HOOD MOUNTED ON ROOF WITH BACKDRAFT DAMPER AND BIRDSCREEN.

ALL SELECTIONS ARE BASED ON AN ALTITUDE OF 1299 FT.

											AIR HA	NDLING UNI	T SCHEDULE	•								
		AREA AND/OR					AIR F	LOW							AFTER	FINAL						
MARK	LOCATION	BLDG SERVED	TYPE	AIR FLOW	SUF	PLY	MIN	NOA	RET	TURN	SUPPLY FAN	RETURN AIR FAN MARK	EXHAUST FAN MARK	FILTER	FILTER	FILTER	HEAT RECOVERY MARK	PREHEAT COIL MARK	COOLING COIL MARK	REHEAT COIL	HUMIDIFIER MARK	REMARKS
					CFM	[L/s]	CFM	[L/s]	CFM	[L/s]					MARK	MARK						
6-AHU-1	BLDG 6 BASEMENT	BASEMENT/1ST FLR NORTH	INDOOR UPRIGHT, VERTICAL DISCHARGE	CV	1,575	[]	400	[]	1,175	[]	1.5 HP, 208/1	-		2" FLAT, MERV 8	-		-	6-HC1	6-CC1		-	1, 2
6-AHU-2	BLDG 6 BASEMENT	BASEMENT/1ST FLR SOUTH	INDOOR UPRIGHT, VERTICAL DISCHARGE	CV	1,615	[]	400	[]	1,215	[]	1.5 HP, 208/1	-		2" FLAT, MERV 8	-	-	-	6-HC2	6-CC2		-	1, 2
6-AHU-3	BLDG 6 ATTIC	2ND FLR/ATTIC NORTH	INDOOR UPRIGHT, HORIZ DISCHARGE	CV	1,325	[]	160	[]	1,165	[]	0.75 HP, 208/1		-	2" FLAT, MERV 8	-	_	-	6-HC3	6-CC3		-	1, 3
6-AHU-4	BLDG 6 ATTIC	2ND FLR/ATTIC SOUTH	INDOOR UPRIGHT, HORIZ DISCHARGE	CV	1,210	[]	160	[]	1,050	[]	0.75 HP, 208/1			2" FLAT, MERV 8		_		6-HC4	6-CC4			1, 3

1. THE AHU WILL CONTAIN THE FOLLOWING COMPONENTS: BOTTOM PLENUM ACCESSORY FOR RETURN AIR, FILTER, PLANT STEAM HEATING COIL, DX COOLING COIL, SUPPLY FAN, AND DISCHARGE OUTLET.

AHU TO HAVE VERTICAL SUPPLY DISCHARGE, OFF TOP OF UNIT.
 AHU TO HAVE HORIZONTAL SUPPLY DISCHARGE, OFF BACK OF UNIT. MAXIMUM HEIGHT IN ATTIC IS 6'-8" (AVDIDING SLOPED CEILINGS).

											STEA	M HEATI	NG COIL	SCHEDU	JLE											
			SYSTEM		AID E	LOW	MAX FACE	VELOCITY	AF	חס		TEMPER	RATURES		TOTALMIN	CADACITY					STEAM					
MARK	LOCATION	AREA AND/OR BLDG SERVED	AND/OR	APPLICATION	AIR	·LOW	IVIAX FACE	VELOCITY	AF	טי	E	AT	L	_AT	TOTALIMIN	CAPACITY	ENT CON	NT VALVE	ENT	COIL	FL	OW		STEAM TRAF	)	REMARKS
		DEDO OLIVED	SERVICE		CFM	[L/s]	FPM	[M/s]	IN WG	[Pa]	°F	[°C]	°F	[°C]	MBH	[kW]	PSIG	[kPa]	PSIG	[kPa]	LBS/HR	[kg/HR]	MARK	LBS/HR	[kg/HR]	
6-HC1	6-AHU-1	BSMT/1ST NORTH	6-AHU-1	HEATING	1,575	[]	500	[]	0.11	[]	55.0	[-]	98.4	[]	74.0	[]	5	[]	5	[]	76.0	[]	6-TP1	152.0	[]	
6-HC2	6-AHU-2	BSMT/1ST SOUTH	6-AHU-2	HEATING	1,615	[]	500	[]	0.11	[]	55.0	[-]	97.9	[-]	75.0	[]	5	[]	5	[]	77.0	[]	6-TP2	154.0	[]	
6-HC3	6-AHU-3	2ND/ATTIC NORTH	6-AHU-3	HEATING	1,325	[]	500	[]	0.28	[]	55.0	[]	88.5	[-]	48.1	[]	5	[]	5	[]	50.0	[]	6-TP3	100.0	[]	-
6-HC4	6-AHU-4	2ND/ATTIC SOUTH	6-AHU-∠	HEATING	1,210	[]	500	[]	0.24	[]	55.0	[]	89.0	[]	46.1	[]	5	[]	5	[]	48.0	[]	6-TP4	96.0	[]	


	CONSULTANTS:		ARCHITECT/ENGINEERS:		Drawing Title	Project Title RENOVATE AND MODERNIZE HVAC SYSTEMS	Project Number 589A7-17-300	Office of
		STATE COA M. HOME		A PEC	MECHANICAL SCHEDULES	BUILDING B6 Contract No.: VA255-17-D-0080 Task Order No.: 36C25518N1023 Obligation No.: 589-C81080	Building Number	Construction and Facilities
		25387 07/26/2018	HIT	PROFESSIONAL ENGINEERING CONSULTANTS, P.A. 303 SOUTH TOPEKA WICHITA, KS 67202	Approved: Project Director	Location Wichita, Kansas	Drawing Number M-501	Management
Revisions: Date		TINGS/ONAL ENGINEERS	E C T U R E	316-262-2691 www.pec1.com		Date Checked Drawn 07/26/18 BOH RMH		Department of Veterans Affairs

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GENERAL EXHAUST CONTROL

EXHAUST FAN, <u>EF-1</u>, TO BE ENERGIZED CONTINUOUSLY.

EXHAUST FANS, <u>EF-2</u>, <u>EF-3</u>, AND <u>EF-4</u>, SHALL BE INTERLOCKED WITH WALL LIGHT SWITCH. UPON TURNING ON ROOM LIGHTS, EXHAUST FAN SHALL BE ENERGIZED.

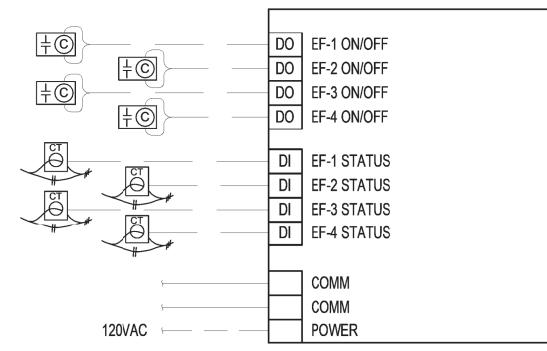


DDC CONTROLS TO TIE INTO EXISTING CAMPUS CONTROL SYSTEM

1 EXHAUST CONTROL NO SCALE

#### CV AIR HANDLER UNIT CONTROL

OCCUPIED MODE
THE OUTSIDE AIR DAMPER SHALL BE OPEN AND THE AHU FAN RUN
CONTINUOUSLY IN THE OCCUPIED MODE. ON A RISE IN TEMPERATURE, THE DX
COOLING SHALL BE CYCLED ON TO MAINTAIN THE COOLING TEMPERATURE
SETPOINT. WHEN THE SETPOINT IS MET, THE DX UNIT SHALL BE CYCLED OFF.
ON A FURTHER DROP IN SPACE TEMPERATURE, THE STEAM VALVE SHALL BE
MODULATED TO MAINTAIN THE HEATING TEMPERATURE SETPOINT. IF THE MIXED
AIR TEMPERATURE FALLS BELOW 38F, THE FREEZESTAT SHALL CLOSE THE
OUTSIDE AIR DAMPER, SHUT OFF THE SUPPLY FAN, AND SIGNAL AN ALARM
CONDITION.


UNOCCUPIED MODE
THE FANS ARE OFF, OA DAMPERS ARE CLOSED IN THE UNOCCUPIED MODE. ON A
RISE IN SPACE TEMPERATURE TO ABOVE SET-UP OR SET-BACK TEMPERATURE, THE
UNIT WILL BE RESTORED TO OCCUPIED MODE UNTIL SPACE TEMPERATURE REACHES
OCCUPIED SETPOINT.

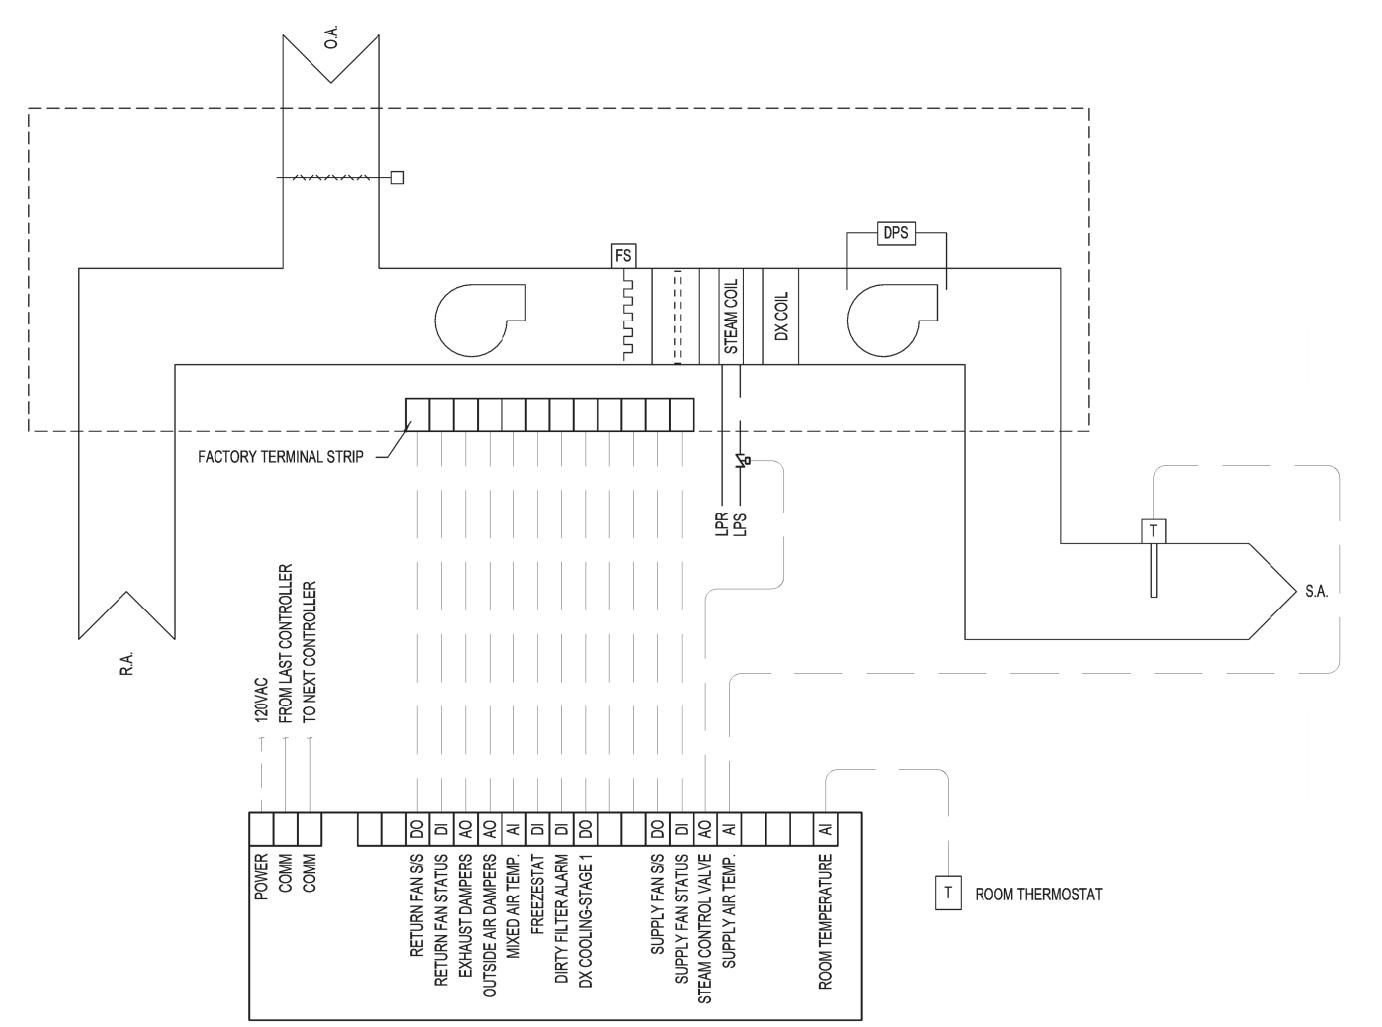

2 AHU CONTROL NO SCALE

CONSULTANTS:

VA FORM 08-623

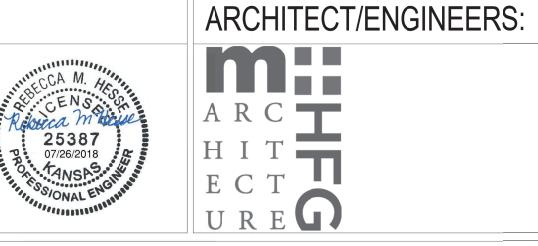

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Drawing Title
MECHANICAL CONTROLS
Approved: Project Director
, pp. 0.04

Project Title			Project Number
RENOVATE AND MOD	DERNIZE HVAC	SYSTEMS,	589A7-17-300
BUILDING B6 Contract No.: VA255-17 Task Order No.: 36C25518 Obligation No.: 589-C810	3N1023		Building Number
Location			Drawing Number
Wichita, Kansa	S		
Date	Checked	Drawn	M-701

Dwg.

ВОН

07/26/18

Office of Construction and Facilities Management

Department of Veterans Affairs