





EXTERIOR PERSPECTIVE

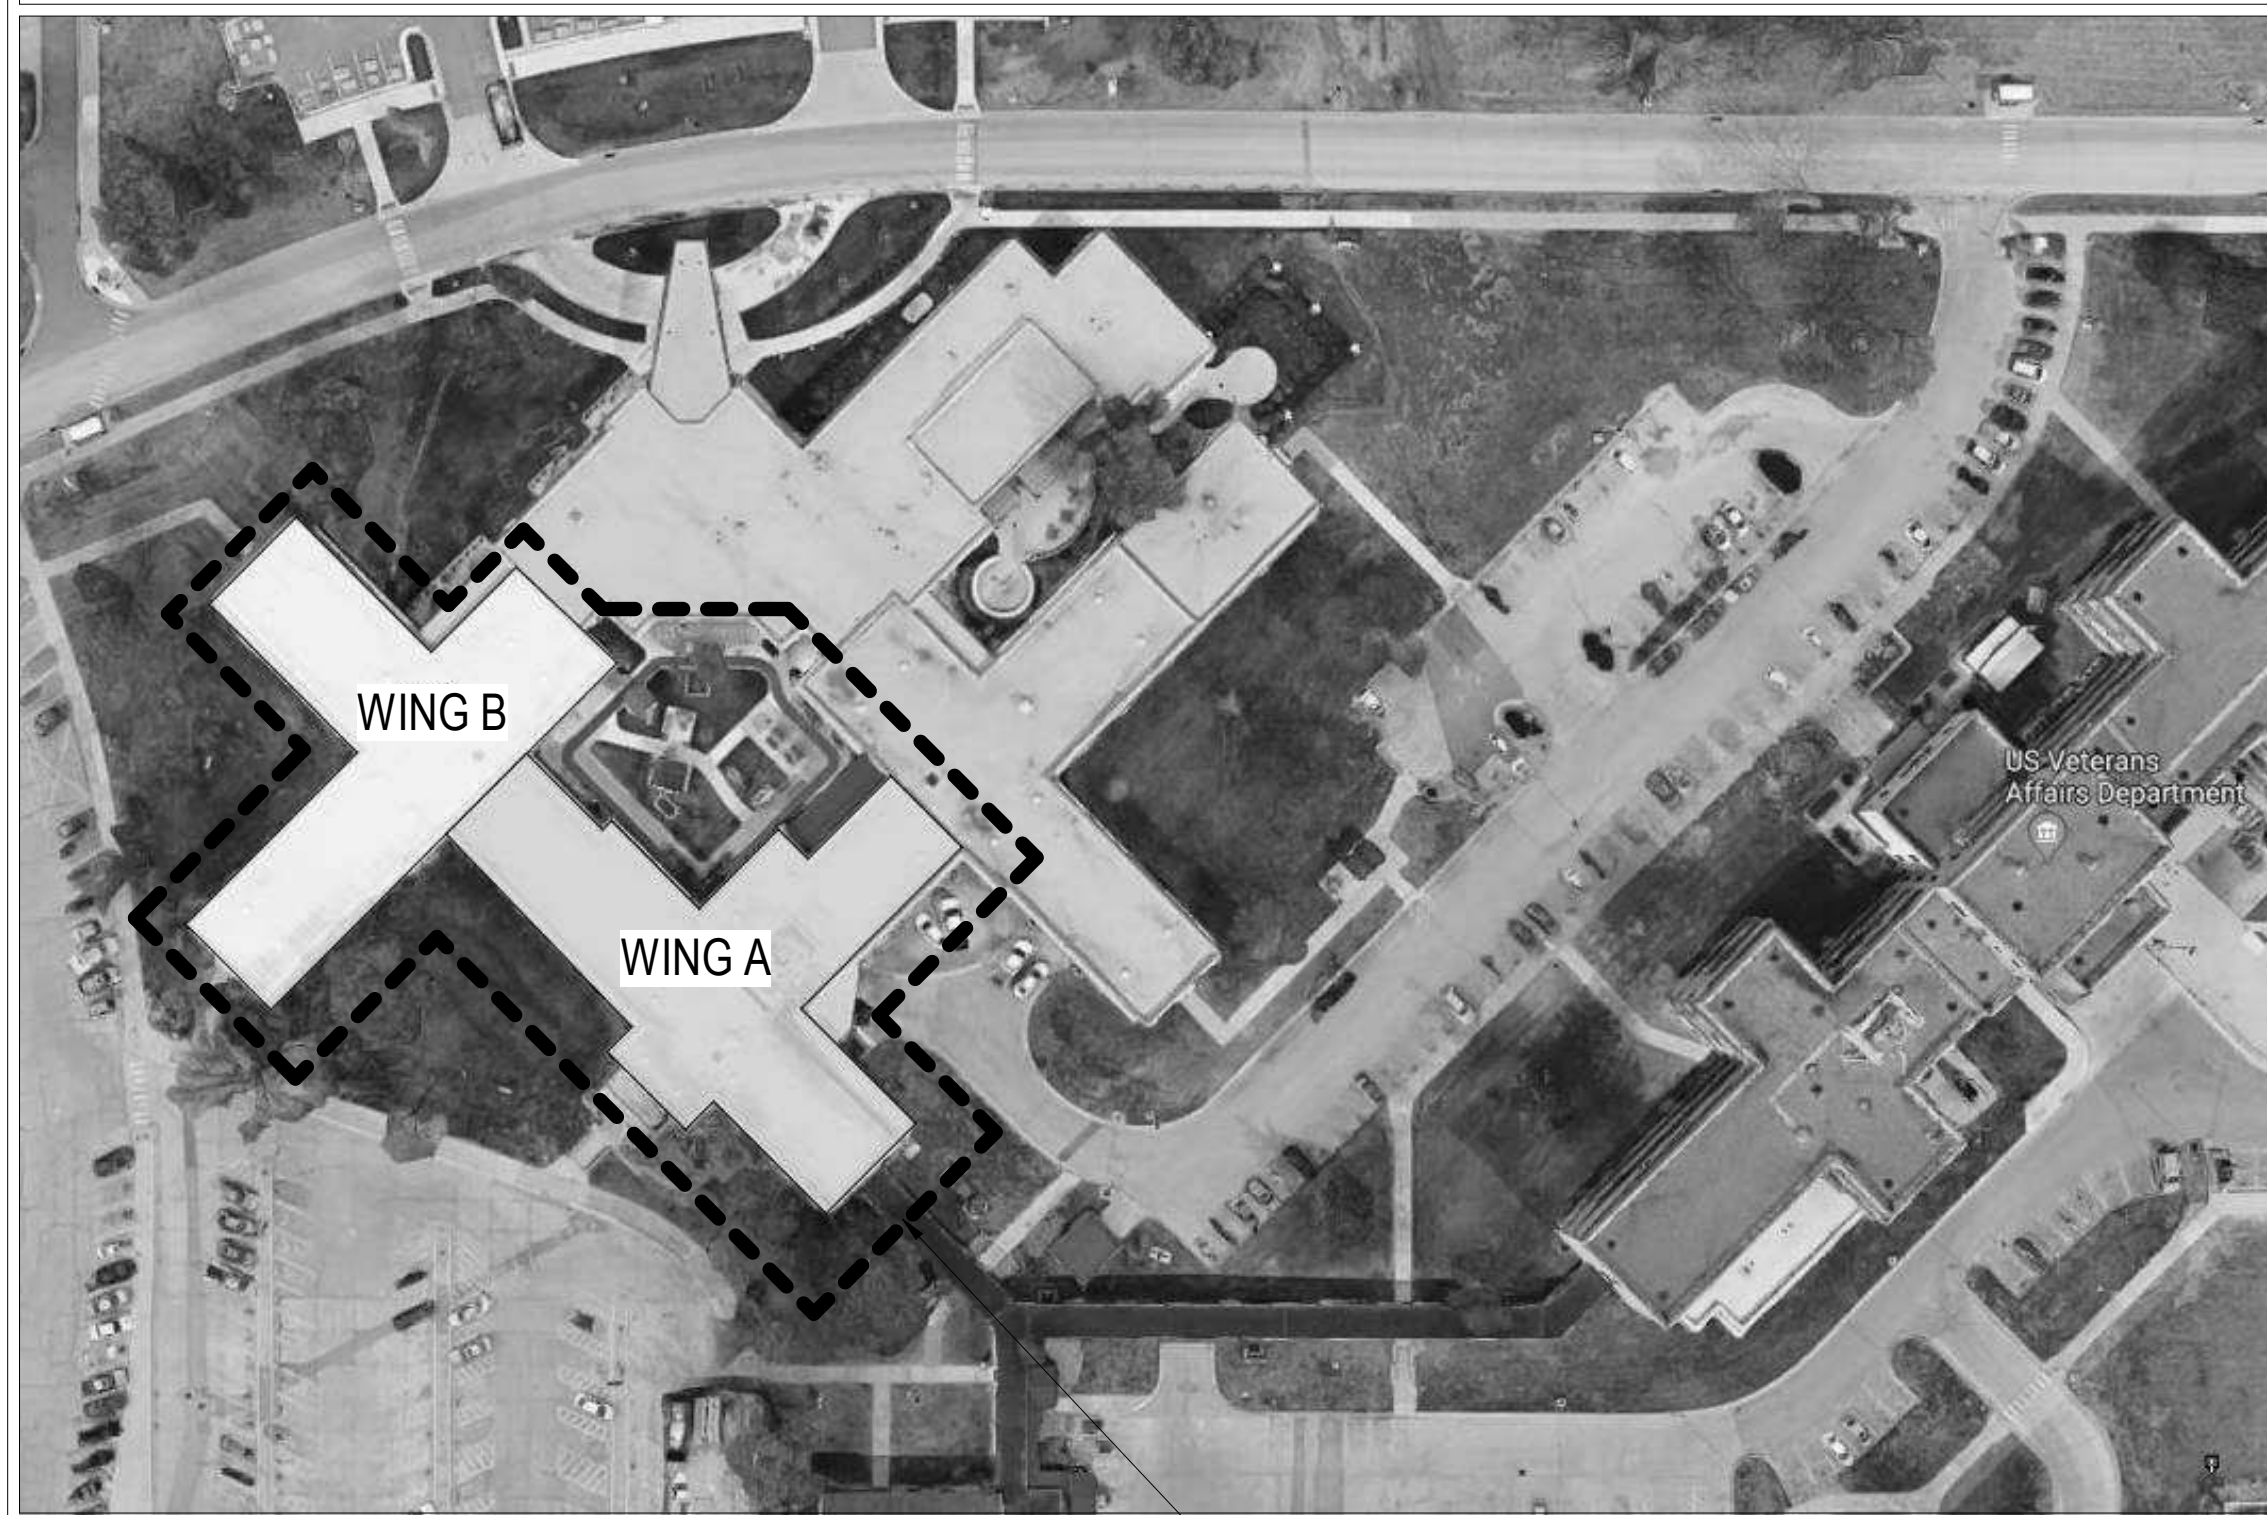

AREA PLAN

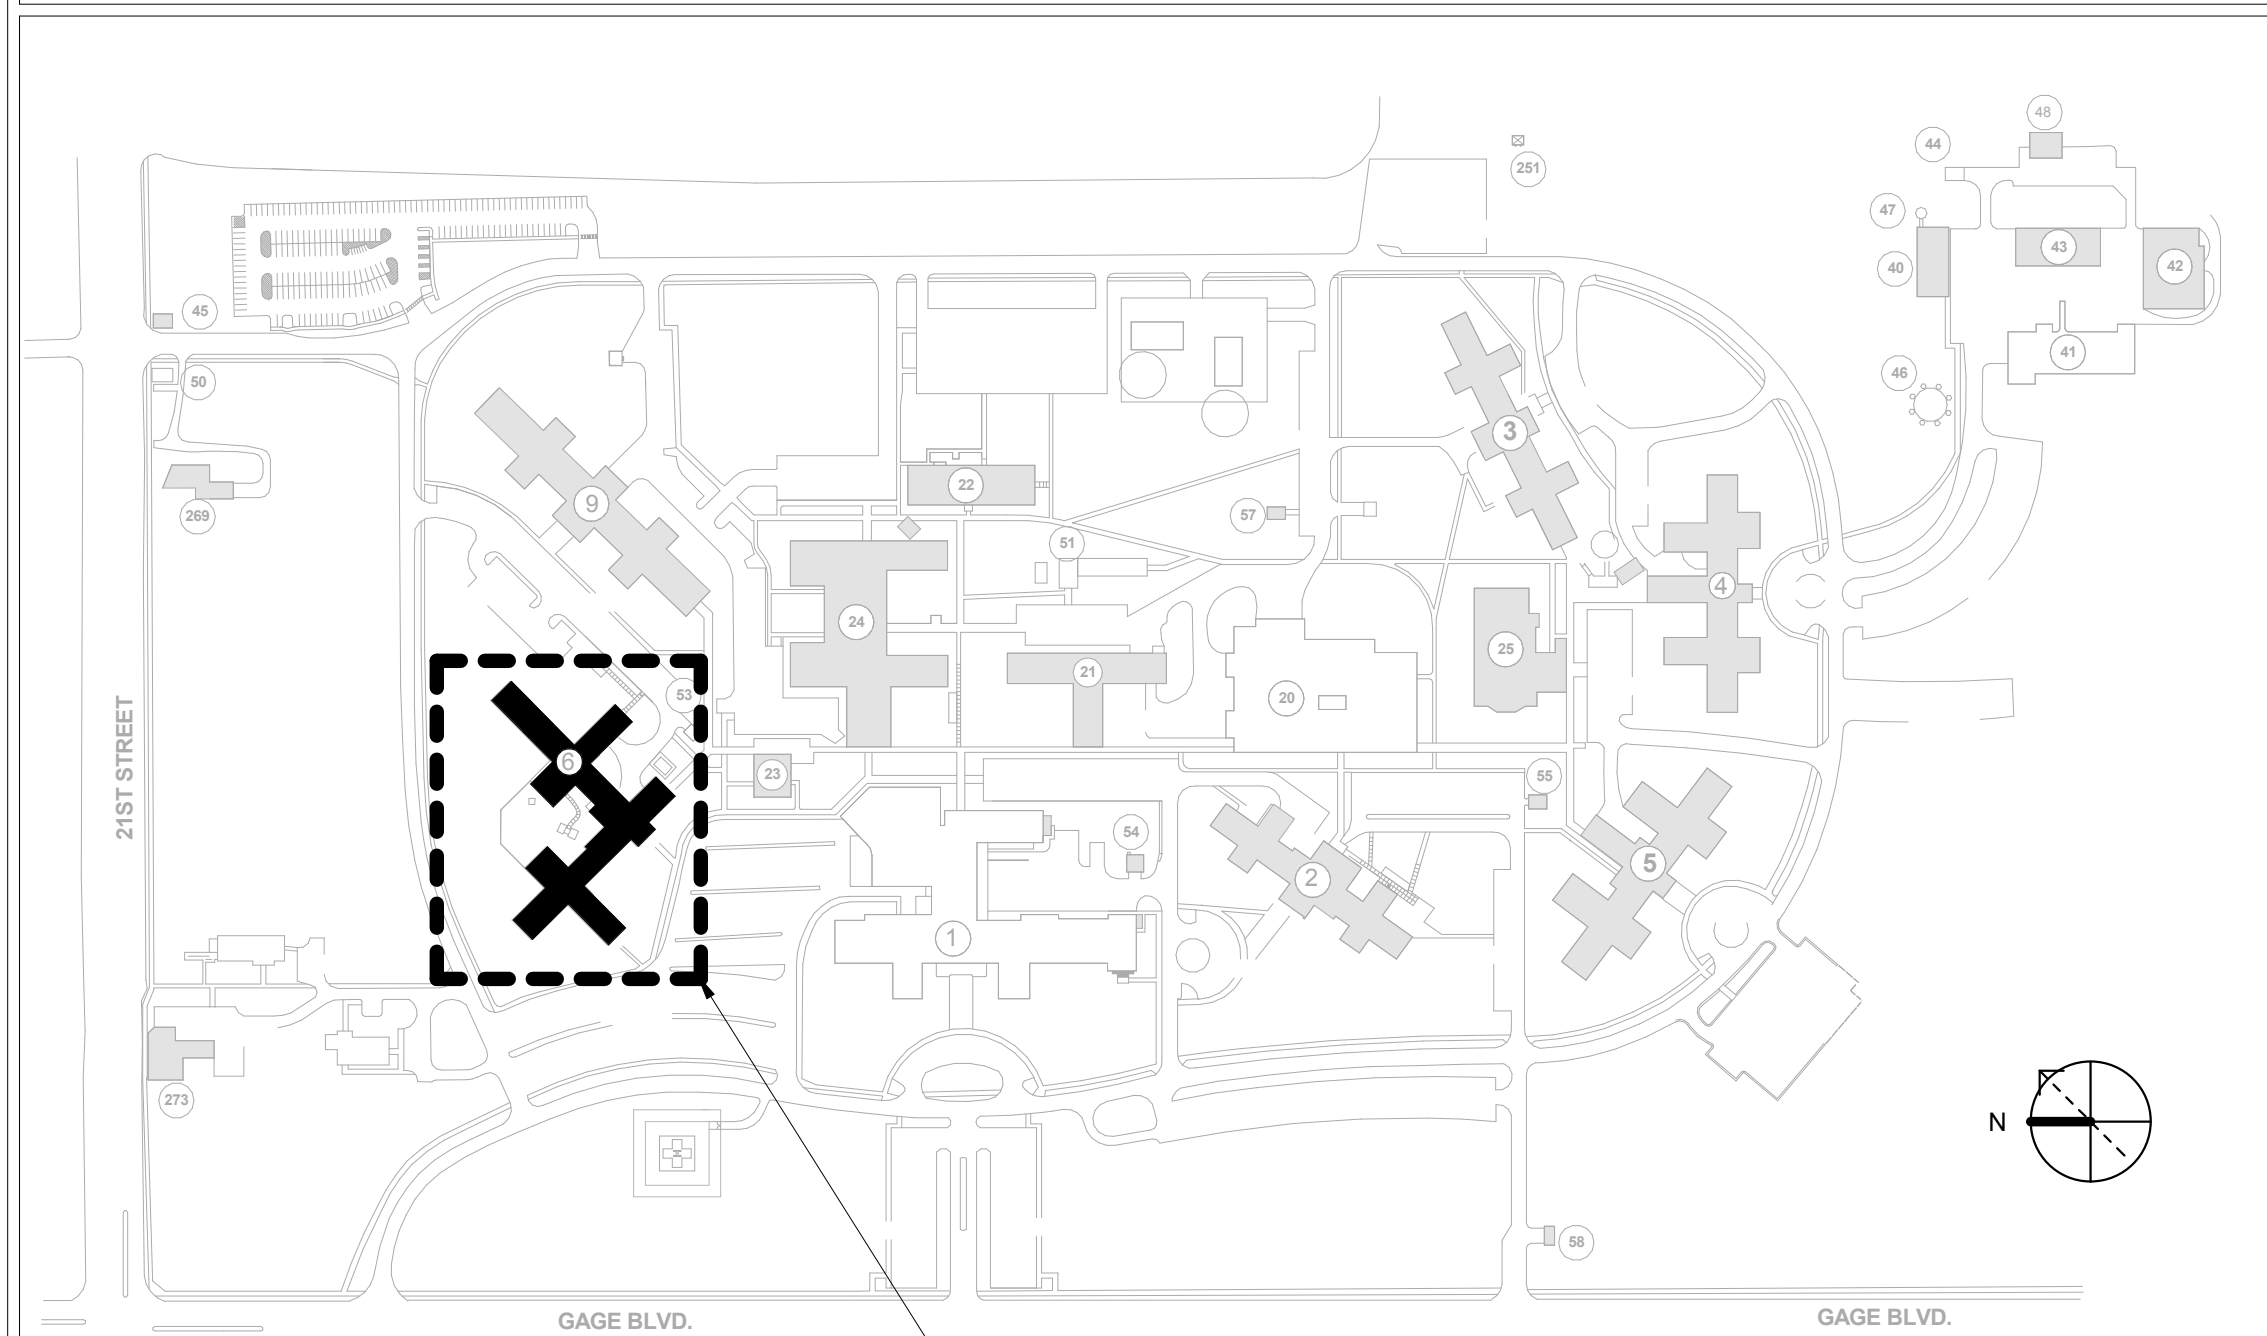

LOCATION PLAN

COLMERY-O'NEIL VA MEDICAL CENTER EASTERN KANSAS VA HEALTH CARE SYSTEM

2200 SW GAGE BLVD.
TOPEKA, KS 66622

BID DOCUMENTS

RENOVATE A & B WING BUILDING 6

VA PROJECT NUMBER: 589A5-19-116

SHEET INDEX			SHEET INDEX			SHEET INDEX		
SEQUENCE	SHEET NUMBER	SHEET NAME	SEQUENCE	SHEET NUMBER	SHEET NAME	SEQUENCE	SHEET NUMBER	SHEET NAME
[01] GENERAL			[06] PLUMBING			[08] ELECTRICAL		
1	6-GI-000	COVER	56	6-P-000	PLUMBING LEGEND	122	6-E-000	ELECTRICAL LEGEND
2	6-GI-001	GENERAL INFORMATION	57	6-PLD100A	PLUMBING WASTE DEMO PLAN - BASEMENT WING A FLOOR PLAN	123	6-ELD101A	ELECTRICAL LIGHTING DEMOLITION PLAN - A WING
3	6-GI-010	PARTITION TYPES	58	6-PLD100B	PLUMBING WASTE DEMO PLAN - BASEMENT WING B FLOOR PLAN	124	6-ELD101B	ELECTRICAL LIGHTING DEMOLITION PLAN - B WING
4	6-GI-102	ICRA PLAN / ICRA DETAILS / PHASING PLAN	59	6-PLD101A	PLUMBING WASTE DEMO PLAN - LEVEL 1 WING A FLOOR PLAN	125	6-EPD101A	ELECTRICAL POWER DEMOLITION PLAN - A WING
5	6-GI-103	LIFE SAFETY FLOOR PLAN	60	6-PLD101B	PLUMBING WASTE DEMO PLAN - LEVEL 1 WING B FLOOR PLAN	126	6-EPD101B	ELECTRICAL POWER DEMOLITION PLAN - B WING
6	6-GI-104	LIFE SAFETY OCCUPANCY CLASSIFICATION FLOOR PLAN	61	6-PPD100A	PLUMBING SUPPLY DEMO PLAN - BASEMENT WING A FLOOR PLAN	127	6-EPD102A	ELECTRICAL POWER DEMOLITION ROOF PLAN - A WING
7	6-GI-105	DEDUCT ALTERNATE PLAN	62	6-PPD100B	PLUMBING SUPPLY DEMO PLAN - BASEMENT WING B FLOOR PLAN	128	6-EPD102B	ELECTRICAL POWER DEMOLITION ROOF PLAN - B WING
			63	6-PPD101A	PLUMBING SUPPLY DEMO PLAN - LEVEL 1 WING A FLOOR PLAN	129	6-EL101A	ELECTRICAL LIGHTING PLAN - A WING
			64	6-PPD101B	PLUMBING SUPPLY DEMO PLAN - LEVEL 1 WING B FLOOR PLAN	130	6-EL101B	ELECTRICAL LIGHTING PLAN - B WING
[02] HAZARDOUS MATERIALS			65	6-FJ2100A	MEDICAL GAS DEMO PLAN - BASEMENT WING A FLOOR PLAN	131	6-EP101A	ELECTRICAL POWER PLAN - A WING
8	6-HA-001	WING A ENVIRONMENTAL REMEDIATION	66	6-FJ2100B	MEDICAL GAS DEMO PLAN - BASEMENT WING B FLOOR PLAN	132	6-EP101B	ELECTRICAL POWER PLAN - B WING
9	6-HA-002	WING B ENVIRONMENTAL REMEDIATION	67	6-FJ2101B	MEDICAL GAS DEMO PLAN - LEVEL 1 WING B FLOOR PLAN	133	6-EQ101A	ELECTRICAL MECHANICAL PLAN - A WING
10	6-HA-003	CRAWLSPACE ENVIRONMENTAL REMEDIATION	68	6-FL-100A	PLUMBING WASTE PLAN - BASEMENT WING A FLOOR PLAN	134	6-EQ101B	ELECTRICAL MECHANICAL PLAN - B WING
			69	6-FL-100B	PLUMBING WASTE PLAN - BASEMENT WING B FLOOR PLAN	135	6-EQ102A	ELECTRICAL ROOF PLAN - A WING
			70	6-FL-101A	PLUMBING WASTE PLAN - LEVEL 1 WING A FLOOR PLAN	136	6-EQ102B	ELECTRICAL ROOF PLAN - B WING
			71	6-FL-101B	PLUMBING WASTE PLAN - LEVEL 1 WING B FLOOR PLAN	137	6-E-401	ELECTRICAL ENLARGED FLOOR PLANS
[03] ARCHITECTURAL			72	6-PP-100A	PLUMBING SUPPLY PLAN - BASEMENT WING A FLOOR PLAN	138	6-E-501	ELECTRICAL DETAILS
11	6-AD-100A	WING A - DEMO FLOOR PLAN	73	6-PP-100B	PLUMBING SUPPLY PLAN - BASEMENT WING B FLOOR PLAN	139	6-E-502	ELECTRICAL DETAILS
12	6-AD-100B	WING B - DEMO FLOOR PLAN	74	6-PP-101A	PLUMBING SUPPLY PLAN - LEVEL 1 WING A FLOOR PLAN	140	6-E-601	ELECTRICAL ONE-LINE DIAGRAM
13	6-AS-100A	WING A - FLOOR PLAN	75	6-PP-101B	PLUMBING SUPPLY PLAN - LEVEL 1 WING B FLOOR PLAN	141	6-E-602	ELECTRICAL SCHEDULES
14	6-AS-100B	WING B - FLOOR PLAN	76	6-FJ-100A	MEDICAL GAS PLAN - BASEMENT WING A FLOOR PLAN	142	6-E-603	ELECTRICAL SCHEDULES
15	6-AS-101A	WING A - FF&E FLOOR PLAN	77	6-FJ-100B	MEDICAL GAS PLAN - BASEMENT WING B FLOOR PLAN	143	6-E-604	ELECTRICAL SCHEDULES
16	6-AS-101B	WING B - FF&E FLOOR PLAN	78	6-FJ-101B	MEDICAL GAS PLAN - LEVEL 1 WING B FLOOR PLAN	144	6-E-701	LIGHTING CONTROLS
17	6-AS-110A	WING A - ROOF PLAN	79	6-F-102A	PLUMBING PLAN - WING A ROOF PLAN	145	6-E-702	LIGHTING CONTROL DIAGRAMS
18	6-AS-110B	WING B - ROOF PLAN	80	6-PR-102B	PLUMBING PLAN - WING B ROOF PLAN			
19	6-AS-200A	WING A - REFLECTED CEILING PLAN	81	6-F-301	PLUMBING RISER DIAGRAMS	[09] TELECOMMUNICATIONS		
20	6-AS-200B	WING B - REFLECTED CEILING PLAN	82	6-F-302	PLUMBING RISER DIAGRAMS	146	6-T-000	TELECOMMUNICATIONS LEGEND
21	6-AS-400	WING A - FF&E - ENLARGED PLANS & ELEVATIONS	83	6-F-303	PLUMBING RISER DIAGRAMS	147	6-TD101A	TECHNOLOGY DEMOLITION PLAN - A WING
22	6-AS-401	WING A - FF&E - ENLARGED PLANS & ELEVATIONS	84	6-F-304	PLUMBING RISER DIAGRAMS	148	6-TD101B	TECHNOLOGY DEMOLITION PLAN - B WING
23	6-AS-402	WING A - FF&E - ENLARGED PLANS & ELEVATIONS	85	6-F-401	PLUMBING PARTIAL PLANS	149	6-6-T1101A	PUBLIC ADDRESS PLAN - A WING
24	6-AS-403	WING B - FF&E - ENLARGED PLANS & ELEVATIONS	86	6-F-402	PLUMBING PARTIAL PLANS	150	6-6-T1101B	PUBLIC ADDRESS PLAN - B WING
25	6-AS-404	WING A - FF&E - ENLARGED PLANS & ELEVATIONS	87	6-F-501	PLUMBING DETAILS I	151	6-TM101A	NURSE CALL AND MONITORING SYSTEMS PLAN - A WING
26	6-AS-405	WING B - FF&E - ENLARGED PLANS & ELEVATIONS	88	6-F-502	PLUMBING DETAILS II	152	6-TM101B	NURSE CALL AND MONITORING SYSTEMS PLAN - B WING
27	6-AS-500	DOOR, FRAME & WINDOW SCHEDULES & ELEVATIONS	89	6-F-601	PLUMBING SCHEDULES I	153	6-TN101A	COMMUNICATIONS PLAN - A WING
28	6-AS-500	INTERIOR FINISH SCHEDULES AND DETAILS				154	6-TN101B	COMMUNICATIONS PLAN - B WING
29	6-AS-611A	WING A - FINISH PLAN	[07] MECHANICAL			155	6-TY101A	SECURITY PLAN - A WING
30	6-AS-611B	WING B - FINISH PLAN	90	6-M-000	MECHANICAL LEGEND AND ABBREVIATIONS	156	6-TY101B	SECURITY PLAN - B WING
31	6-AS-612A	WING A - SIGNAGE PLAN	91	6-MD-100A	MECHANICAL DEMOLITION PLAN - WING A BASEMENT FLOOR PLAN	157	6-T-401	TECHNOLOGY ENLARGED FLOOR PLANS
32	6-AS-612B	WING B - SIGNAGE PLAN	92	6-MD-100B	MECHANICAL DEMOLITION PLAN - WING B BASEMENT FLOOR PLAN	158	6-T-501	TECHNOLOGY DETAILS
33	6-AS-700	PLAN & SECTION DETAILS	93	6-MHD101A	MECHANICAL HVAC DEMOLITION PLAN - WING A LEVEL 1 FLOOR PLAN	159	6-T-601	TECHNOLOGY RISER DIAGRAMS
34	6-AS-800	ARCHITECTURAL CASEWORK LEGEND	94	6-MHD101B	MECHANICAL HVAC DEMOLITION PLAN - WING B LEVEL 1 FLOOR PLAN	160	6-T-602	TECHNOLOGY SCHEDULES
35	6-AS-802	ARCHITECTURAL CASEWORK LEGEND	95	6-MPD101A	MECHANICAL PIPING DEMOLITION PLAN - LEVEL 1 WING A FLOOR PLAN	TOTAL SHEETS: 160		
36	6-AS-803	CASEWORK - ENLARGED PLANS & ELEVATIONS	96	6-MPD101B	MECHANICAL PIPING DEMOLITION PLAN - LEVEL 1 WING B FLOOR PLAN			
37	6-AS-804	CASEWORK - ENLARGED PLANS & ELEVATIONS	97	6-MD-102A	MECHANICAL DEMOLITION PLAN - WING A ROOF PLAN			
38	6-AS-805	CASEWORK - ENLARGED PLANS & ELEVATIONS	98	6-MD-102B	MECHANICAL DEMOLITION PLAN - WING B ROOF PLAN			
39	6-AS-806	CASEWORK - ENLARGED PLANS & ELEVATIONS	99	6-MH-101A	MECHANICAL HVAC DESIGN PLAN - WING A LEVEL 1 FLOOR PLAN			
40	6-AS-807	MILLWORK DETAILS	100	6-MH-101B	MECHANICAL HVAC DESIGN PLAN - WING B LEVEL 1 FLOOR PLAN			
41	6-AS-808	MILLWORK DETAILS	101	6-MR-100A	MECHANICAL PIPING DESIGN PLAN - BASEMENT FLOOR PLAN			
			102	6-MR-100B	MECHANICAL PIPING DESIGN PLAN - BASEMENT FLOOR PLAN			
			103	6-MR-101A	MECHANICAL PIPING DESIGN PLAN - WING A LEVEL 1 FLOOR PLAN			
			104	6-MR-101B	MECHANICAL PIPING DESIGN PLAN - WING B LEVEL 1 FLOOR PLAN			
			105	6-M-100A	MECHANICAL DESIGN PLAN - WING A ROOF PLAN			
			106	6-M-102B	MECHANICAL DESIGN PLAN - WING B ROOF PLAN			
			107	6-MH-103A	MECHANICAL HVAC DEDUCT ALTERNATE PLAN - WING A LEVEL 1 FLOOR PLAN			
			108	6-M-201	MECHANICAL FLOW DIAGRAMS			
			109	6-M-401	MECHANICAL ENLARGED PLANS I			
			110	6-M-402	MECHANICAL ENLARGED PLANS II			
			111	6-M-501	MECHANICAL DETAILS I			
			112	6-M-502	MECHANICAL DETAILS II			
			113	6-M-503	MECHANICAL DETAILS III			
			114	6-M-601	MECHANICAL SCHEDULES I			
			115	6-M-602	MECHANICAL SCHEDULES II			
			116	6-M-701	MECHANICAL CONTROLS I			
			117	6-M-702	MECHANICAL CONTROLS II			
			118	6-M-703	MECHANICAL CONTROLS III			
			119	6-M-704	MECHANICAL CONTROLS IV			
			120	6-M-705	MECHANICAL CONTROLS V			
			121	6-M-706	MECHANICAL CONTROLS VI			

ADDENDUM 01	11/26/2019	CONSULTANT INFORMATION		ARCHITECT		Office of Construction and Facilities Management		SHEET TITLE COVER		PROJECT PHASE BID DOCUMENTS		PROJECT TITLE RENOVATE A & B WING BUILDING 6		VA PROJECT NUMBER 589A5-19-116	
		STRUCTURAL / CIVIL ENGINEER	MECHANICAL / ELECTRICAL / PLUMBING / TECHNICAL ENGINEER	FIRE PROTECTION ENGINEER	SPUR DESIGN	Office of Construction and Facilities Management	Office of Construction and Facilities Management	APPROVED: PROJECT DIRECTOR	BID DOCUMENTS		PROJECT LOCATION 2200 SW GAGE BLVD. TOPEKA, KS 66622		BUILDING NUMBER 6		DRAWING NUMBER 6-GI-000
Revision #	Date	STAND STRUCTURAL ENGINEERING 11627 W. 112TH STREET, SUITE 200 OVERLAND PARK, KS 66210 (913) 214-2169	SPUR DESIGN 11020 KING STREET, SUITE 350 OVERLAND PARK, KS 66210 (405) 842-6100	POOLE FIRE PROTECTION, INC. 19910 W. 161ST STREET OLATH, KS 66062 (913) 829-8650	SPUR DESIGN 513 SW 23rd Street Overland Park, KS 66209 www.spur-design.com	Office of Construction and Facilities Management	Office of Construction and Facilities Management		FULLY SPRINKLERED		DATE 07/10/2019		CHECKED BY AWM	DRAWN BY JET	Dwg. 1 OF 160
					KS ARCH REG. NO. A-1139, EXP. 12/31/2019 KS ENGR REG. NO. E-2586, EXP. 12/31/2019	VA	U.S. Department of Veteran Affairs		FULLY SPRINKLERED		DATE 07/10/2019		CHECKED BY AWM	DRAWN BY JET	Dwg. 1 OF 160

GENERAL NOTES

- 1. DRAWINGS ARE PART OF A COMPLETE DOCUMENTS SET. CONTRACTOR SHALL CONFIRM ALL ITEMS REQUIRED BASED UPON THE OVERALL DESIGN INTENT OF THE ENTIRE DOCUMENT SET.
2. CONTRACTOR SHALL VERIFY ALL EXISTING CONDITIONS PRIOR TO BEGINNING ANY WORK TO CONFIRM THE ACCURACY OF THE DRAWINGS...
3. ALL AREAS NOT INVOLVED IN THE SCOPE OF WORK FOR THIS PROJECT SHALL BE KEPT CLEAN AND FREE OF OBSTRUCTIONS AT ALL TIMES.
4. ERECT BARRICADES AND WARNING SIGNS TO DIVERT AND WARN PASSERS BY OF THE CONSTRUCTION WORK. PROVIDE DUST PROOFING ENCLOSURES TO SEPARATE WORK AREAS FROM THE EXISTING FACILITIES.
5. ALL TRASH AND DEBRIS TO BE REMOVED ON A DAILY BASIS.
6. PROVIDE PROTECTION FOR ALL EXISTING SURFACES AND CONDITIONS TO REMAIN IN PLACE DURING THE SCOPE OF WORK. SHOULD ANY DAMAGE OCCUR, PATCH AND REPAIR ANY DAMAGE TO ADJACENT FINISHES TO MATCH EXISTING.
7. ANY DAMAGE CAUSED TO THE BUILDING OR OWNER EQUIPMENT SHALL BE REPAIRED OR REPLACED BACK TO ITS ORIGINAL CONDITIONS AT NO ADDITIONAL COST TO THE OWNER.
8. COVER ALL RETURN AIR GRILLES WITHIN THE AREA OF CONSTRUCTION TO PREVENT PARTICULATE MATERIAL FROM EXHAUSTING INTO SURROUNDING SPACES.
9. APPROPRIATE LIGHT FIXTURES SHALL BE TEMPORARILY SUSPENDED TO PROVIDE ADEQUATE LIGHTING LEVELS FOR CONSTRUCTION.
10. CONTRACTOR AND SUBCONTRACTORS ARE REQUIRED TO COORDINATE WITH OTHER DISCIPLINES TO INSTALL COMPLETE AND OPERATIONAL SYSTEMS. DRAWINGS AS A WHOLE, REPRESENT A COMPLETE SET AND DEPICT REQUIREMENTS FOR COMPLETE AND OPERATIONAL SYSTEMS. INDIVIDUAL DRAWINGS MAY NOT DEPICT COMPLETE AND ACCURATE INFORMATION TO COORDINATE COMPLETE AND OPERATIONAL SYSTEMS, BUT DO SO AS AN ENTIRE DOCUMENT TO BE REFERENCED WITH OTHER INDIVIDUAL DRAWINGS. CONTRACTOR AND SUBCONTRACTORS ARE REQUIRED TO REFERENCE OTHER SHEETS AND SPECIFICATIONS AS AN ENTIRE SET OF CONSTRUCTION DOCUMENTS THAT REFLECT WORK REQUIRED TO ACHIEVE A COMPLETE AND OPERATIONAL GOAL. LACK OF COORDINATION AND REVIEW OF DRAWINGS AND SPECIFICATIONS AS AN ENTIRE DOCUMENT TO INSTALL COMPLETE AND OPERATIONAL SYSTEMS, BEING OBVIOUS AND TYPICAL INDUSTRY STANDARD IDENTIFIED IN THE DRAWINGS AND SPECIFICATIONS, SHALL NOT BE IN ANY WAY AN ADDITIONAL COST TO THE GOVERNMENT.
11. CONTRACTOR SHALL SUBMIT A REQUEST, IN WRITING, TO INTERRUPT ANY SUCH SERVICES TO COR CONTRACTING OFFICERS REPRESENTATIVE 48 HOURS IN ADVANCE OF PROPOSED INTERRUPTION. REQUEST SHALL STATE REASON, DATE, EXACT TIME OF, AND APPROXIMATE DURATION OF SUCH INTERRUPTION. MAJOR INTERRUPTIONS OF ANY SYSTEM MUST BE REQUESTED, IN WRITING, AT LEAST 60 CALENDAR DAYS PRIOR TO THE DESIRED TIME AND SHALL BE PERFORMED AS DIRECTED BY THE COR. MAJOR INTERRUPTIONS SHALL BE COORDINATED WITH OTHER MAJOR INTERRUPTIONS AND MAY NOT BE SCHEDULED FOR ONE DISCIPLINE MORE THAN TWICE THROUGHOUT THE OVERALL CONSTRUCTION SCHEDULE UNLESS REQUESTED IN WRITING AND APPROVED BY THE COR. CONTRACTOR WILL BE ADVISED, IN WRITING, OF APPROVAL OF REQUEST, OR OF WHICH OTHER DATE AND/OR TIME SUCH INTERRUPTION WILL CAUSE THE LEAST INCONVENIENCE TO OPERATIONS OF THE MEDICAL CENTER. INTERRUPTION TIME APPROVED BY THE MEDICAL CENTER MAY OCCUR AT TIMES OTHER THAN CONTRACTOR'S NORMAL WORKING HOURS. SCHEDULE INTERRUPTION MAY BE ON WEEKENDS OR LATE HOURS AND MAY NOT BE AN ADDITIONAL COST TO THE GOVERNMENT. COORDINATE ALL INTERRUPTIONS THAT MAY AFFECT THE NORMAL OPERATION OF THE FACILITY WITH THE COR WHEN SUBMITTING THE CONSTRUCTION SCHEDULE OR UPDATES TO THE CONSTRUCTION SCHEDULE.
12. NO ASBESTOS CONTAINING MATERIALS ARE TO BE USED ON THIS PROJECT. SPUR DESIGN, THE A/E OF RECORD, CAN CERTIFY THAT NO ASBESTOS CONTAINING BUILDING MATERIALS (ACBM) OR LEAD BASED PAINT (LBP) PRODUCTS WERE DESIGNED/SPECIFIED AS BUILDING MATERIAL IN ANY OF THE CONSTRUCTION DOCUMENTS.


ENERGY REQUIREMENTS

ASHRAE 90.1 - 2016 EDITION
BUILDING LOCATION: TOPEKA, KANSAS
CLIMATE ZONE (FIGURE C301.1): ZONE 4A
INTERIOR DESIGN CONDITIONS: THE INTERIOR DESIGN TEMPERATURES FOR HEATING AND COOLING AS DEPICTED IN THE PROJECT DESIGN CONDITIONS SCHEDULE IN THE MECHANICAL CONTROL DRAWINGS SHALL BE THE MAXIMUM AND MINIMUM VALUES FOR THE ASSOCIATED TEMPERATURE CONTROL ZONES.
BUILDING ENVELOPE REQUIREMENTS (C402)
OPAQUE THERMAL ENVELOPE REQUIREMENTS (TABLE C402.1.3 / C402.1.4):
ROOFS: INSULATION: METAL BUILDING: R-30 c.i.; METAL FRAMED: R-19 + R-11.5; ATTIC AND OTHER: R-49
WALLS, ABOVE GRADE: MASS: METAL BUILDING: R-9.5 c.i.; METAL FRAMED: R-9 + R-15.8 c.i.; WOOD FRAMED AND OTHER: R-13 + R-3.8 c.i.
WALLS, BELOW GRADE: BELOW-GRADE WALL: R-7.5
FLOORS: MASS: R-14.6 c.i.; STEEL-FRAMED: R-30
SLAB-ON-GRADE: HEATED SLABS: R-15 for 24h; R-20 for 24h
OPAQUE DOORS: SWINGING: U-0.370; NONSWINGING: U-0.310
FENESTRATION (TABLE C402.4): VERTICAL FENESTRATION: U-FACTOR: NON-METAL FRAMING (ALL): U-0.31; METAL FRAMING, FIXED (CURTAIN WALL STOREFRONT): U-0.38; METAL FRAMING, OPERABLE: U-0.46; METAL FRAMING ENTRANCE DOOR: U-0.68


CODES, STANDARDS, AND EXECUTIVE ORDERS

PURPOSE: THE PUBLIC BUILDINGS AMENDMENT ACT OF 1988, PUBLIC LAW (PUB. L.) 100-678 REQUIRES FEDERAL AGENCIES TO FOLLOW NATIONAL RECOGNIZED "MODEL" BUILDING CODES. THE FEDERAL PARTICIPATION IN THE DEVELOPMENT AND USE OF VOLUNTARY STANDARDS, OFFICE OF MANAGEMENT AND BUDGET (OMB) CIRCULAR A-119, REQUIRES ALL EXECUTIVE AGENCIES TO RELY ON VOLUNTARY STANDARDS, BOTH DOMESTIC AND INTERNATIONAL, WHENEVER FEASIBLE, AND TO PARTICIPATE IN VOLUNTARY STANDARD BODIES.
GENERAL: VA HAS ADOPTED THE LATEST EDITION OF THE FOLLOWING CODES AND STANDARDS AS A MINIMUM FOR ALL PROJECTS PERFORMED IN THE MODERNIZATION, ALTERATION, ADDITION, OR IMPROVEMENT OF ITS REAL PROPERTY AND THE CONSTRUCTION OF NEW STRUCTURES. VA DESIGN MANUALS AND MASTER SPECIFICATIONS SPECIFY OTHER CODES AND STANDARDS THAT VA FOLLOWS ON ITS PROJECTS.
VA DIRECTIVES, DESIGN MANUALS, MASTER SPECIFICATIONS, VA NATIONAL CAD STANDARD APPLICATION GUIDE, AND OTHER GUIDANCE ON THE TECHNICAL INFORMATION LIBRARY (TIL) (HTTP://WWW.CFM.VA.GOV/TLI).
INTERNATIONAL BUILDING CODE (IBC) (ONLY WHEN SPECIFICALLY REFERENCED IN VA DESIGN DOCUMENTS, SEE NOTES BELOW)
NFPA 101 LIFE SAFETY CODE (SEE NOTES BELOW)
NFPA NATIONAL FIRE CODES WITH THE EXCEPTION OF NFPA 5000 AND NFPA 900
OCCUPATIONAL SAFETY AND HEALTH ADMINISTRATION (OSHA) STANDARDS.
VA SEISMIC DESIGN REQUIREMENTS, H-18-8
NATIONAL ELECTRICAL CODE (NEC)
INTERNATIONAL PLUMBING CODE (IPC)
SAFETY CODE FOR ELEVATORS AND ESCALATORS, AMERICAN SOCIETY OF MECHANICAL ENGINEERS (ASME) A 17.1.
ASME BOILER AND PRESSURE VESSEL CODE
ASME CODE FOR PRESSURE PIPING
ARCHITECTURAL BARRIERS ACT ACCESSIBILITY STANDARDS (ABAAAS) INCLUDING VA SUPPLEMENT, BARRIER FREE DESIGN GUIDE (PG-18-13)
BUILDING CODE REQUIREMENTS FOR REINFORCED CONCRETE, AMERICAN CONCRETE INSTITUTE AND COMMENTARY (ACI 318)
MANUAL OF STEEL CONSTRUCTION, LOAD AND RESISTANCE FACTOR DESIGN SPECIFICATIONS FOR STRUCTURAL STEEL BUILDINGS, AMERICAN INSTITUTE OF STEEL CONSTRUCTION (AISC)
ENERGY POLICY ACT OF 2005 (EPACT)
DOE INTERIM FINAL RULE: ENERGY CONSERVATION STANDARDS FOR NEW FEDERAL, COMMERCIAL AND MULTI-FAMILY HIGH-RISE RESIDENTIAL BUILDINGS AND NEW LOW-RISE RESIDENTIAL BUILDINGS, 10 CFR PARTS 433, 434 AND 435.
FEDERAL LEADERSHIP IN HIGH PERFORMANCE AND SUSTAINABLE BUILDINGS: MEMORANDUM OF UNDERSTANDING (MOU)
EXECUTIVE ORDER 13423: STRENGTHENING FEDERAL ENVIRONMENTAL, ENERGY, AND TRANSPORTATION MANAGEMENT.
THE PROVISIONS FOR CONSTRUCTION AND SAFETY SIGNS, STATED IN THE GENERAL REQUIREMENTS SECTION 01010 OF THE VA MASTER CONSTRUCTION SPECIFICATION.
VENTILATION FOR ACCEPTABLE INDOOR AIR QUALITY - ASHRAE STANDARD 62.1 - 2004.
SAFETY STANDARD FOR REFRIGERATION SYSTEMS - ASHRAE STANDARD 15 - 2007.
LOCAL CODES: AS AN AGENCY OF THE FEDERAL GOVERNMENT, VA IS NOT SUBJECT TO LOCAL IMPOSITION OF CODE ENFORCEMENT PROCEDURES (DRAWING REVIEWS, BUILDING PERMITS, INSPECTIONS, FEES, ETC.). VA MUST FUNCTION AS THE AUTHORITY HAVING JURISDICTION (AHJ) AND THIS HAS THE RESPONSIBILITY TO GUARD PUBLIC HEALTH AND SAFETY THROUGH ENFORCING ITS ADOPTED CODES. HOWEVER, LOCAL AUTHORITIES SHOULD BE NOTIFIED ABOUT PLANNED PROJECTS AND GIVEN OPPORTUNITY TO REVIEW DRAWINGS PROVIDED THAT VA DOES NOT PAY FOR REVIEW OR INSPECTION FEES.
NOTES:
1. NFPA 101 PRIMARILY ADDRESSES LIFE SAFETY AND FIRE PROTECTION FEATURES WHILE THE IBC ADDRESSES A WIDE RANGE OF CONSIDERATIONS, INCLUDING, BUT NOT LIMITED TO, STRUCTURAL STRENGTH, SEISMIC STABILITY, SANITATION, ADEQUATE LIGHT AND VENTILATION, AND ENERGY CONSERVATION. VA BUILDINGS MUST MEET THE REQUIREMENTS OF NFPA 101 AND DOCUMENTS REFERENCED BY NFPA 101 IN ORDER TO COMPLY WITH THE ACCREDITATION REQUIREMENTS OF THE JOINT COMMISSION. THEREFORE, DESIGNS SHALL COMPLY WITH THE REQUIREMENTS OF THE LATEST EDITION OF NFPA 101 AND DOCUMENTS REFERENCED THEREIN. DESIGN FEATURES NOT ADDRESSED BY NFPA 101 OR DOCUMENTS REFERENCED THEREIN SHALL COMPLY WITH THE REQUIREMENTS OF THE LATEST EDITION OF THE IBC OR AS OTHERWISE ADDRESSED ABOVE IN THIS PROGRAM GUIDE. FOR DESIGN FEATURES THAT ARE ADDRESSED BY BOTH THE IBC AS WELL AS NFPA 101 OR A DOCUMENT REFERENCED BY NFPA 101, THE REQUIREMENTS OF NFPA 101 OR THE DOCUMENT REFERENCED BY NFPA 101 SHALL BE USED EXCLUSIVELY (THIS APPLIES EVEN IF THE IBC REQUIREMENTS ARE DIFFERENT).
2. CONFLICTS BETWEEN NATIONALLY RECOGNIZED CODES AND VA REQUIREMENTS - SHOULD A CONFLICT EXIST BETWEEN VA REQUIREMENTS AND VA ADOPTED NATIONALLY RECOGNIZED CODES AND STANDARDS, THE CONFLICT SHALL BE BROUGHT TO THE ATTENTION OF VA. THE RESOLUTION OF THE CONFLICT SHALL BE MADE BY THE AUTHORITY HAVING JURISDICTION FOR VA TO ENSURE A CONSISTENT SYSTEM WIDE.


MATERIALS LEGEND

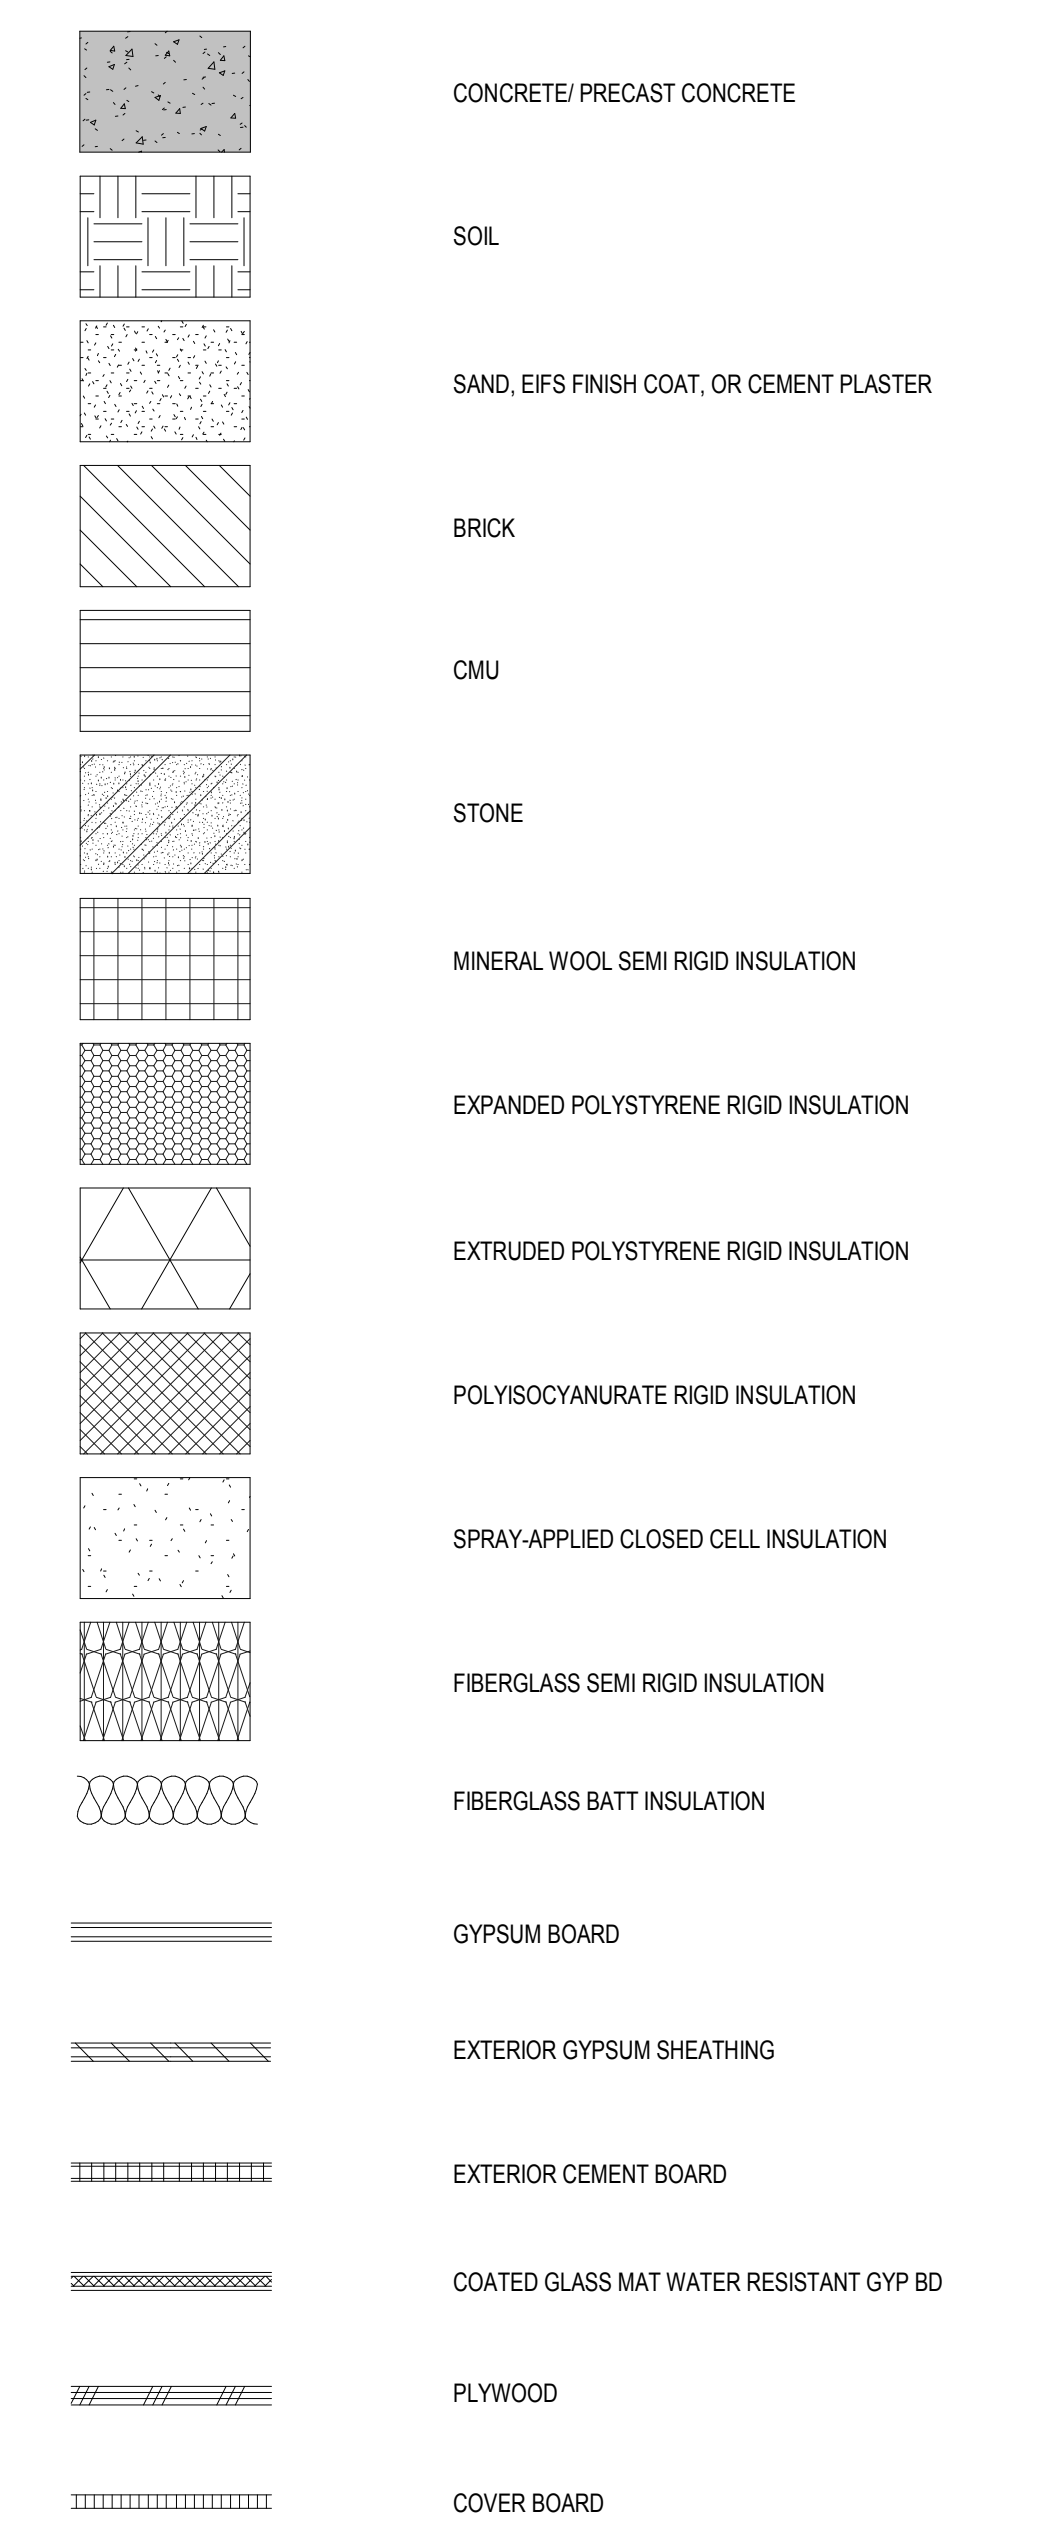

SYMBOLS LEGEND

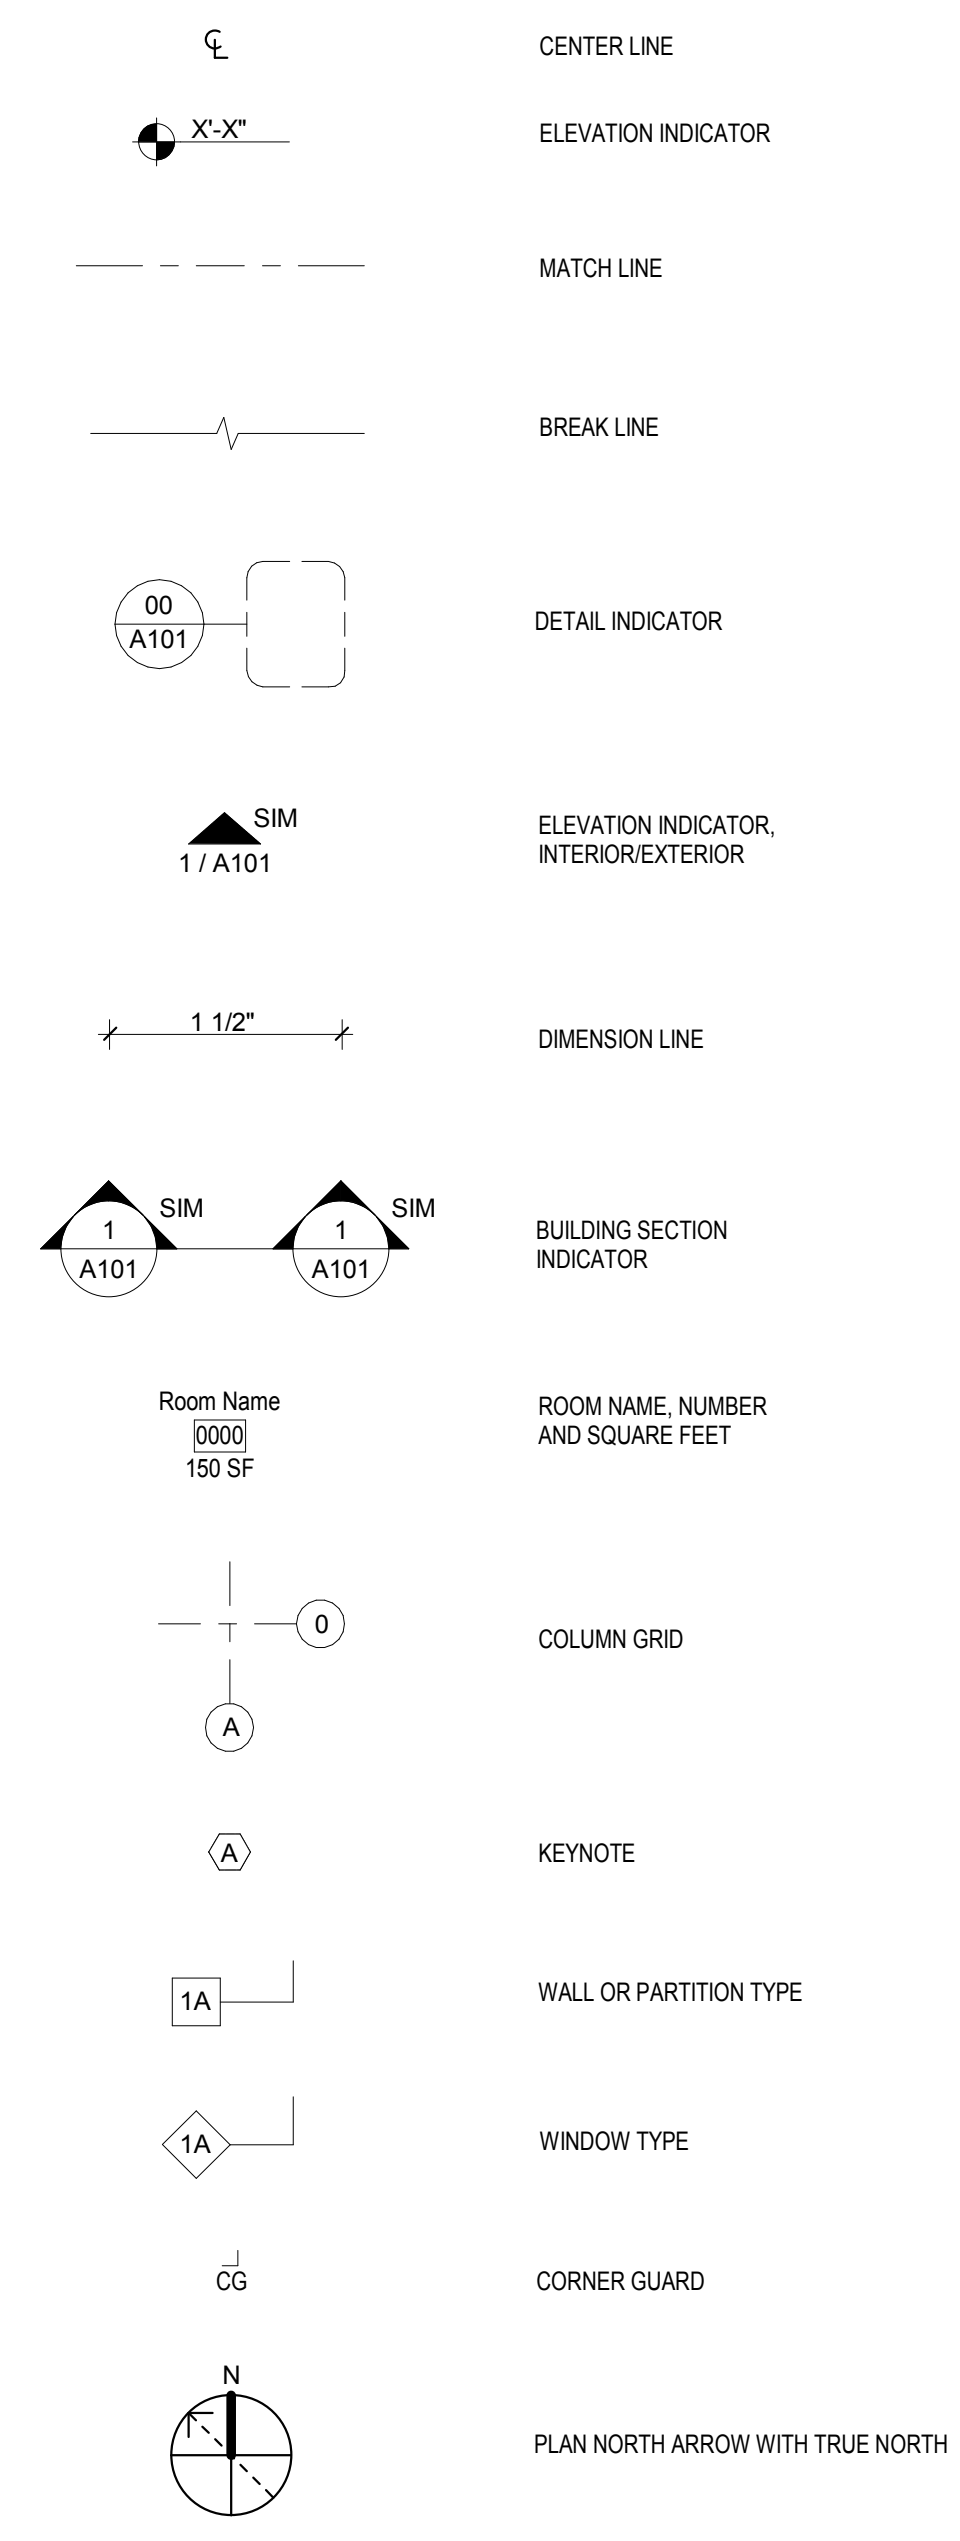


DOOR CLEARANCES

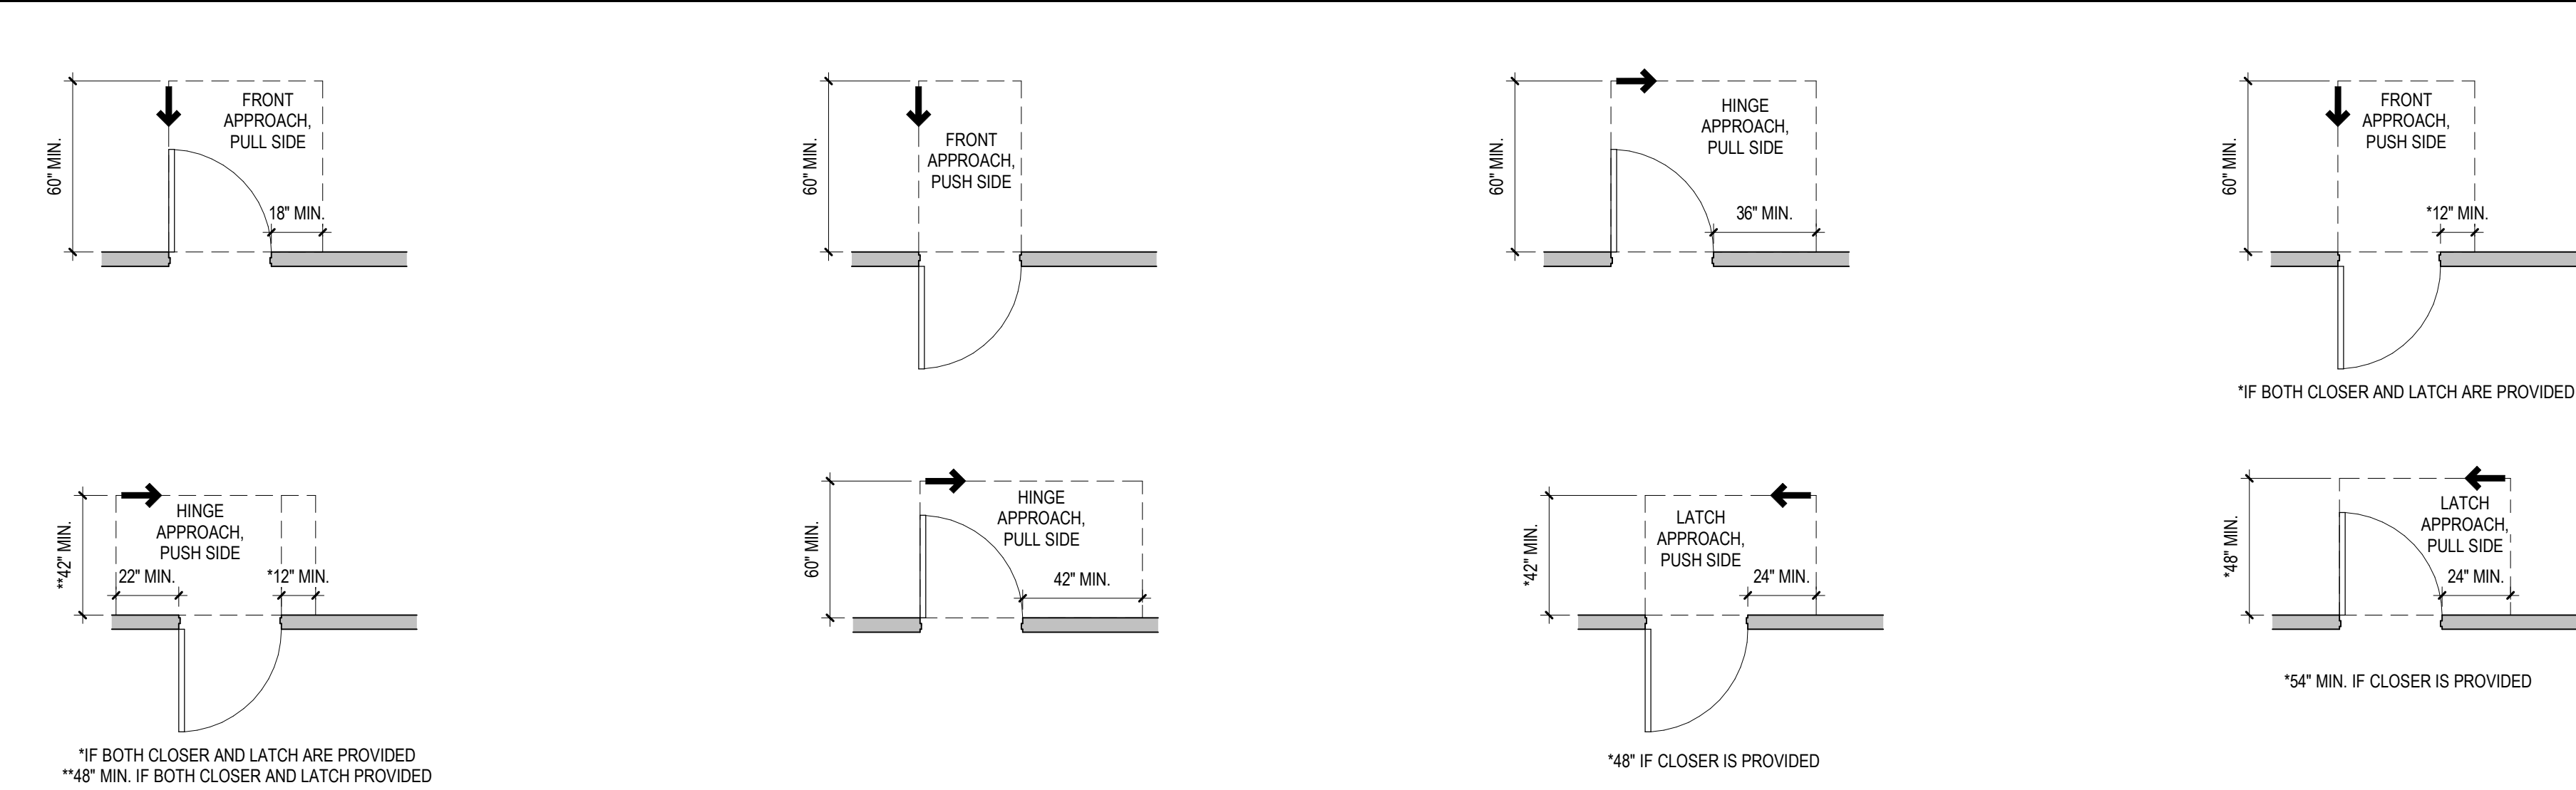

ARCHITECTURAL ABBREVIATIONS

Table of architectural abbreviations including ACS DR, ACS PNL, ACT, ACT (SP), AD, ADA, ADC, ADH, ADMIN, ADB, AFC, AFF, AFB, AFS, ALUM, AR, ASB, AWT, BAT, BEV, BLKT, BM, BOT, BRG, BRG PL, BRKT, BTWN, CAC, CB, CBB, COTV, C/C, CL, CMU, CONT, COR, CR, DEMO, DF, DIA, ELEC, EA, EQ, EQUIP, EXIST, EXP, EXT, ETR, F, FD, FEC, FF, FF&E, FT, FURR, FV, GA, GALV, GB, GD, GL, GROUT, GWB, HOR, HM, HORIZ, HS, HT, IN, INCH OR INCHES, KPL, KICKPLATE, LAV, LAY, LF, LVR, LF, MAX, MIN, MISC, MTD, MANUF, NIC, NO, NOM, NRC, OC, OPP, PNL, PVC, QA, QC, QTY, QUAL, R, RCP, RECPT, REF, REOD, REV, RM, RO, S, SCHED, SF, SIM, SPEC, SQ IN, SQ YD, STRUCT, STC, STD, STOR, T&G, THRU, TO, TOB, TOM, TOS, TYP, UNO, UTIL, VAR, V/C, V/V, W, WITH, W/O, WD, WDW, WR, X BRACE, SEALED CONCRETE, SCHEDULE, SQUARE FOOT (FEET), SIMILAR, SPECIFICATION, SQUARE INCH, SQUARE YARD, STRUCTURAL, SOUND TRANSMISSION CLASS, STANDARD, STORAGE, TONGUE AND GROOVE, THROUGH, TOP OF, TOP OF BEAM, TOP OF MASONRY, TOP OF STEEL, TYPICAL, UNLESS NOTED OTHERWISE, UTILITY, VARIES, VA PROVIDED / CONTRACTOR INSTALLED, VA PROVIDED / VA INSTALLED, W/ WITH, W/O WITHOUT, WALL COVERING OR WATER CLOSET, WOOD, WDW WINDOW, WR WASTE RECEPTACLE, X BRACE, CROSS BRACE.

FIXTURE MOUNTING HEIGHTS AND CLEARANCES

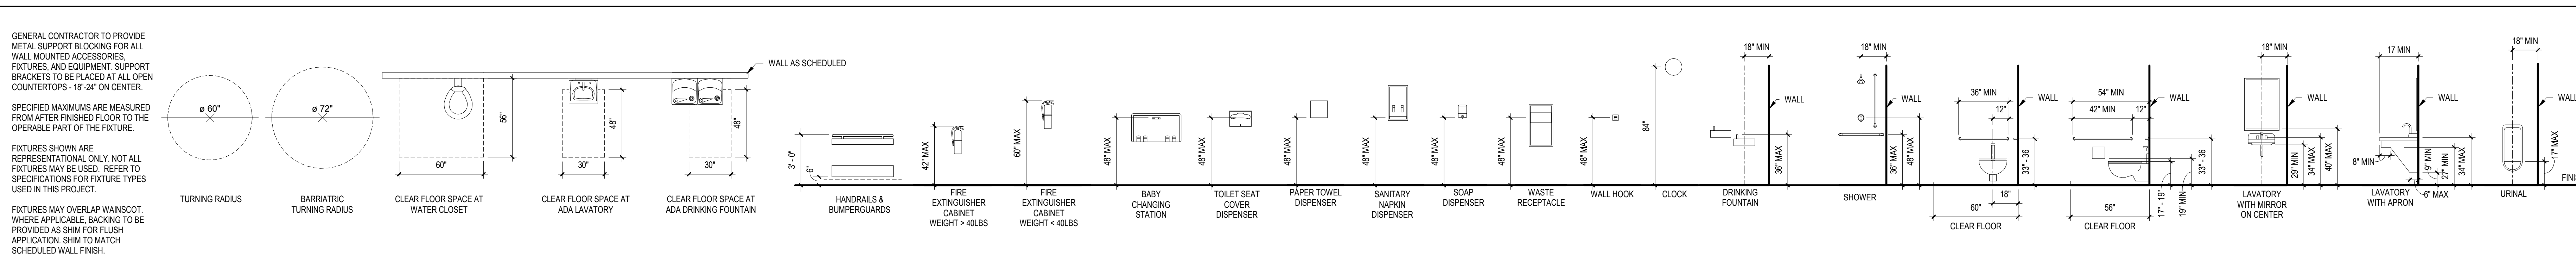

CONSULTANT INFORMATION

Table with columns for Revision # and Date, and rows for Structural/Civil Engineering, Mechanical/Electrical/Plumbing/Technical Engineering, and Fire Protection Engineering.

ARCHITECT

Logo for Spur Design, Kansas Architect, and contact information for KS ARCH REG. NO. A-1139, EXP. 12/31/2019.

Office of Construction and Facilities Management, U.S. Department of Veteran Affairs logo.

SHEET TITLE GENERAL INFORMATION

APPROVED: PROJECT DIRECTOR

PROJECT PHASE BID DOCUMENTS

FULLY SPRINKLERED

PROJECT TITLE RENOVATE A & B WING BUILDING 6


PROJECT LOCATION: 2200 SW GAGE BLVD. TOPEKA, KS 66622

VA PROJECT NUMBER 589A5-19-116


BUILDING NUMBER 6, DRAWING NUMBER 6-GI-001, Dwg. 2 OF 160

GENERAL PARTITION NOTES


- NOT ALL PARTITION TYPES SHOWN HERE MAY BE USED. REFER TO PLANS FOR LOCATION AND TYPES OF EACH PARTITION.
- PAINT CONTINUOUS 4" TALL, STENCILED LETTERS, ABOVE CEILING, ON BOTH SIDES OF ALL FIRE AND SMOKE WALLS DESIGNATING THE PARTITION RATING INDICATED ON THE LIFE SAFETY PLAN.
- REFER TO FINISH SCHEDULE AND INTERIOR ELEVATIONS FOR LOCATIONS OF ALL WALL TILE. PROVIDE AND INSTALL CEMENTITIOUS BACKER BOARD IN LIEU OF GWB AT ALL SCHEDULED TILE LOCATIONS, UNLESS NOTED OTHERWISE. TILE SHALL BE INSTALLED PER THE COUNCIL OF AMERICA LATEST STANDARDS FOR EACH TYPE OF BACKING MATERIAL REPRESENTED IN WALL/PARTITION.
- ALL SUSPENDED WALLS AND PARTITIONS SHALL HAVE GWB WHICH EXTENDS A MINIMUM OF 6" ABOVE THE SUSPENDED CEILING UNLESS SHOWN AND/OR NOTED OTHERWISE BY THE ARCHITECT.
- REFER TO STRUCTURAL DRAWINGS FOR ALL LOAD BEARING WALL CONDITIONS IN REGARDS TO STRUCTURAL REQUIREMENTS.
- "ALIGN" MEANS SIMILAR COMPONENTS OF CONSTRUCTION, E.G. WALLS, JAMBS, ETC. SHALL ALIGN ACROSS VOIDS AND JOINTS.
- PARTITIONS SHALL BE CONTINUOUS OVER DOORS SAME ADJACENT WALLS (UNLESS NOTED OTHERWISE) WHERE DRYWALL CONTIGUES ABOVE CEILING AND ABOVE THE CEILING LEVEL. UP TO THE STRUCTURE ABOVE. ALL GYPSUM BOARD RETURNS SHALL HAVE CORNER BEADS MINIMUM FLOOR TO CEILING. ALL PENETRATIONS IN DRYWALL CONSTRUCTION ABOVE FINISHED CEILING SHALL BE EFFECTIVELY SEALED TO PREVENT SOUND LEAKAGE AND FIRE STOPPING TAPE/CAULK AT ALL RATED PARTITIONS.
- ALL MECHANICAL CHASES AND OTHER NOTED CHASES ARE TO EXTEND UP TO THE UNDERSIDE OF THE DECK STRUCTURE ABOVE. ALL PLUMBING CHASES UNLESS OTHERWISE NOTED, SHALL EXTEND ABOVE THE HIGHEST ADJOINING CEILING AND BE BRACED TO STRUCTURE.
- ALL CONSTRUCTION DESIGNATED TO BE SUPPORTED BY ROOF STRUCTURE SHALL BE SUPPORTED BY TOP CHORD OF STRUCTURAL JOISTS AND NOT FROM THE METAL DECK.
- COORDINATE WITH MILLWORK DRAWINGS FOR PLACEMENT OF BLOCKING IN WALLS/PARTITIONS. ALL WOOD BLOCKING IS TO BE FIRE RETARDANT TREATED.
- IMPACT RESISTANT GWB, WHERE NOTED, IS OPTIONAL ABOVE 6" AFF AND BEHIND LOCKERS.
- SEAL THE TOP AND BOTTOM OF WALL AS WELL AS ALL PENETRATIONS WHERE SMOKE PARTITIONS ARE DESIGNATED ON THE LIFE SAFETY PLAN TO ELIMINATE THE PASSAGE OF SMOKE.
- ALL PARTITIONS THAT HOST PLUMBING FIXTURES SHALL RECEIVE MOLD / MOISTURE RESISTANT GWB IN LIEU OF REGULAR GWB.

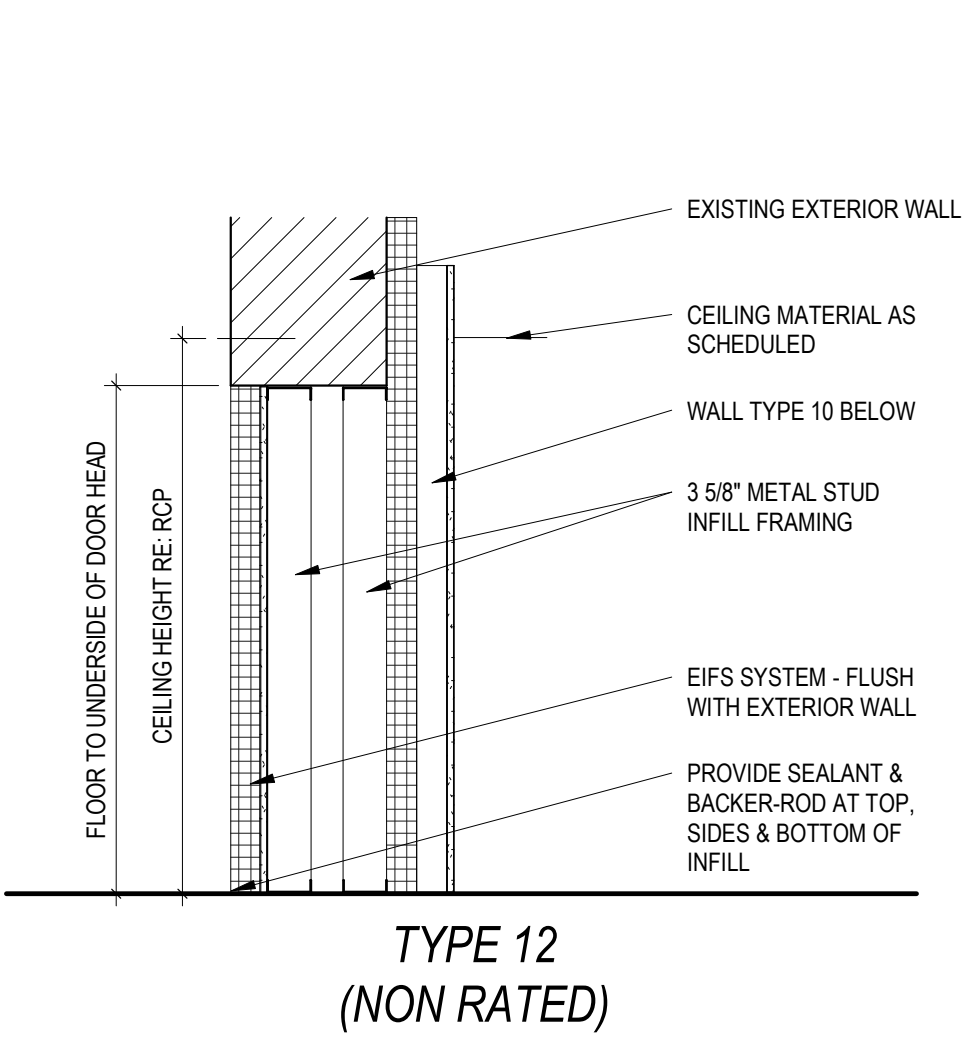


MARK	DETAILS
12A	EXTERIOR FACE: EIFS SYSTEM ON 3/8\"/>

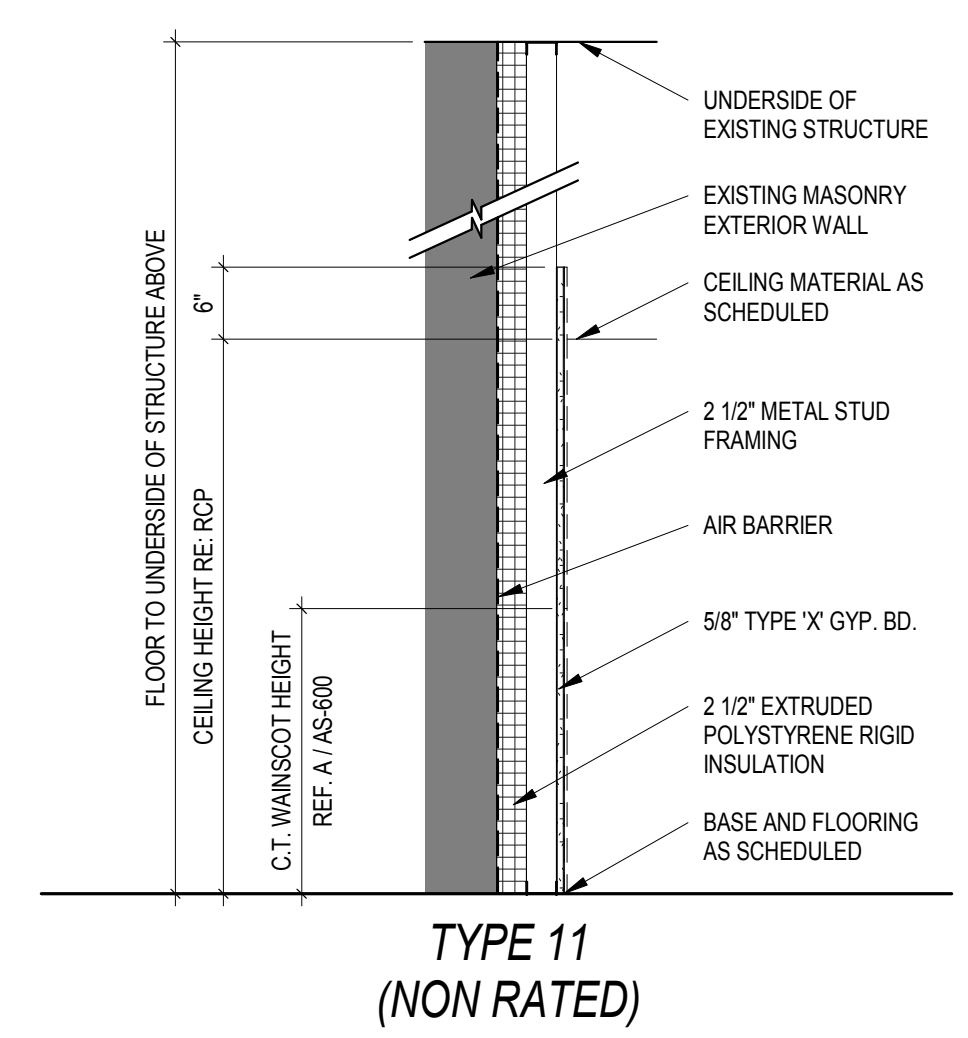


MARK	DETAILS
11A	1 LAYER 5/8\"/>
11B	1 LAYER 5/8\"/>
11C	1 LAYER 5/8\"/>

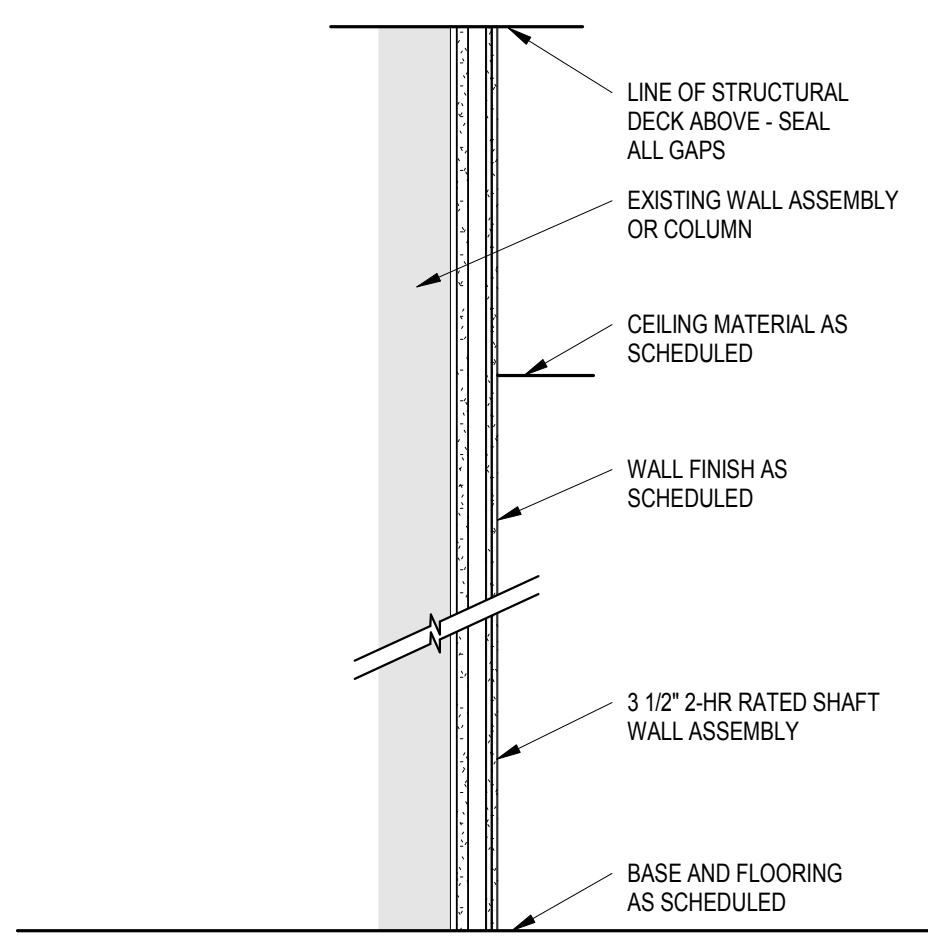


MARK	DETAILS
10A	2 LAYER 1/2\"/>
10B	

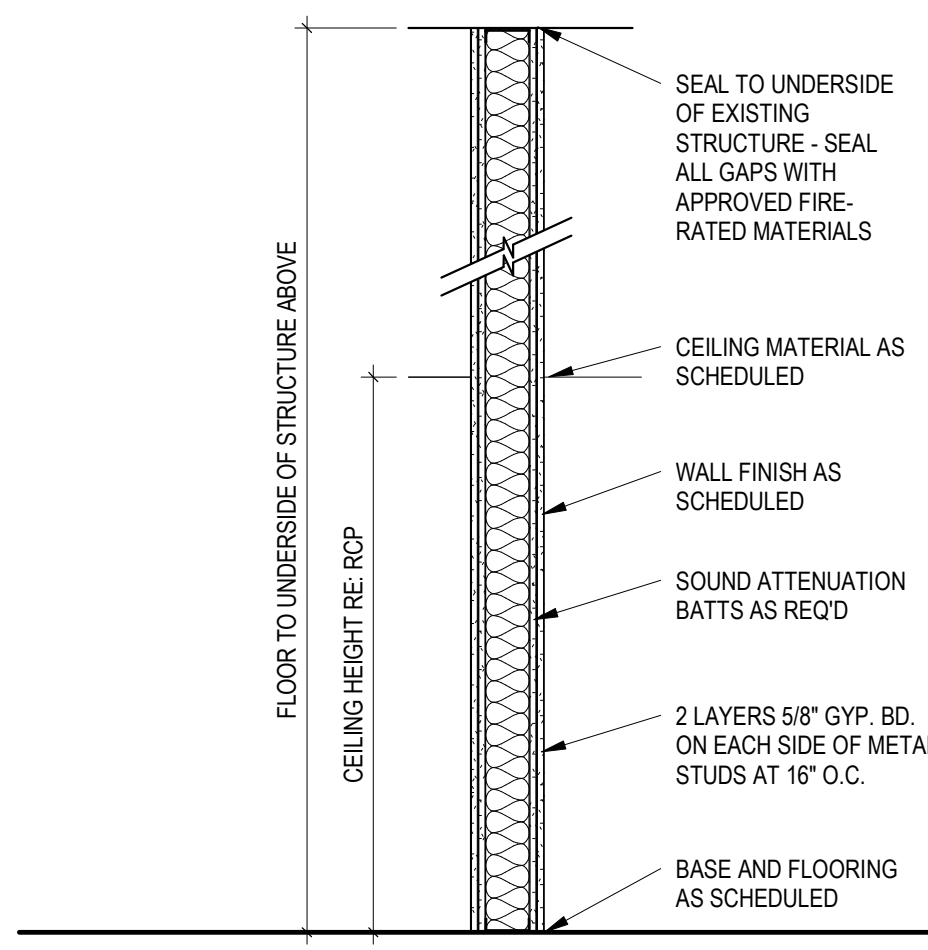


MARK	DETAILS
9A	2 LAYERS 5/8\"/>

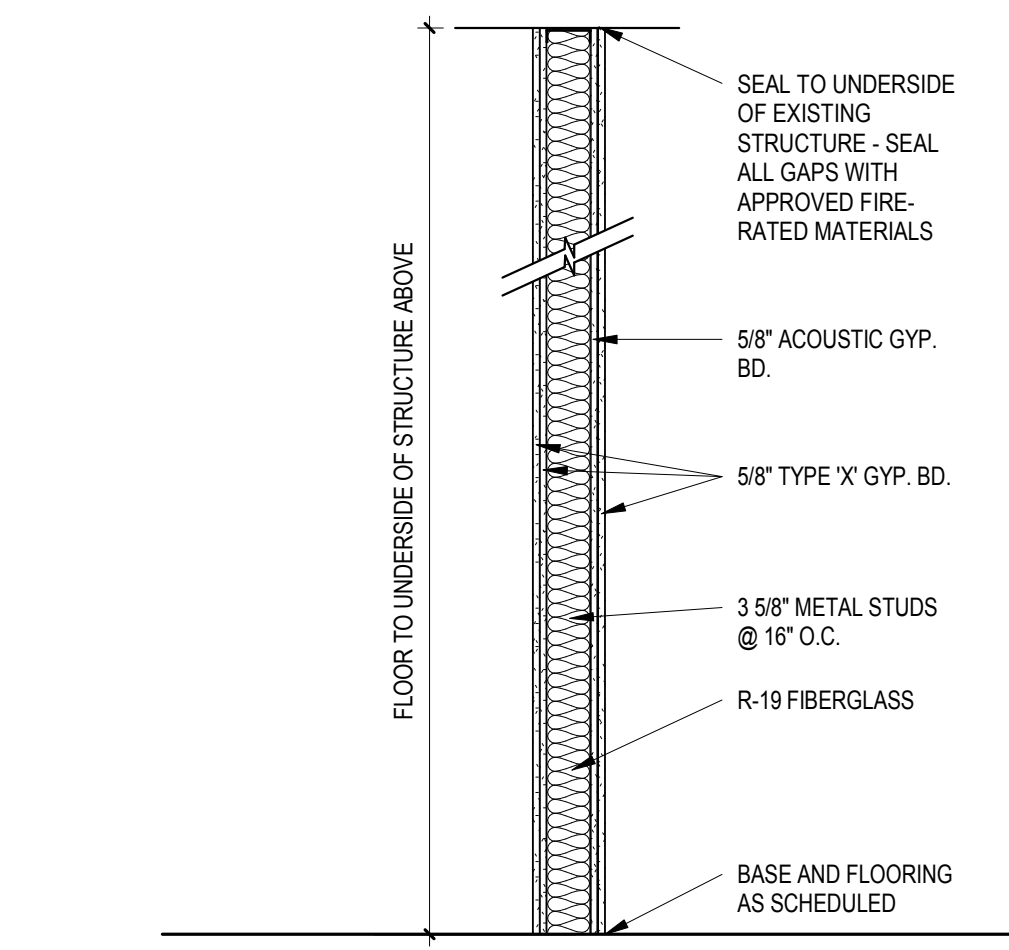


MARK	DETAILS
8A	2 LAYERS 5/8\"/>
NOTE	ADJUST CORRIDOR FRAMING TO ALIGN FACE OF WALL WITH ADJACENT NON-ACOUSTIC WALL TYPES

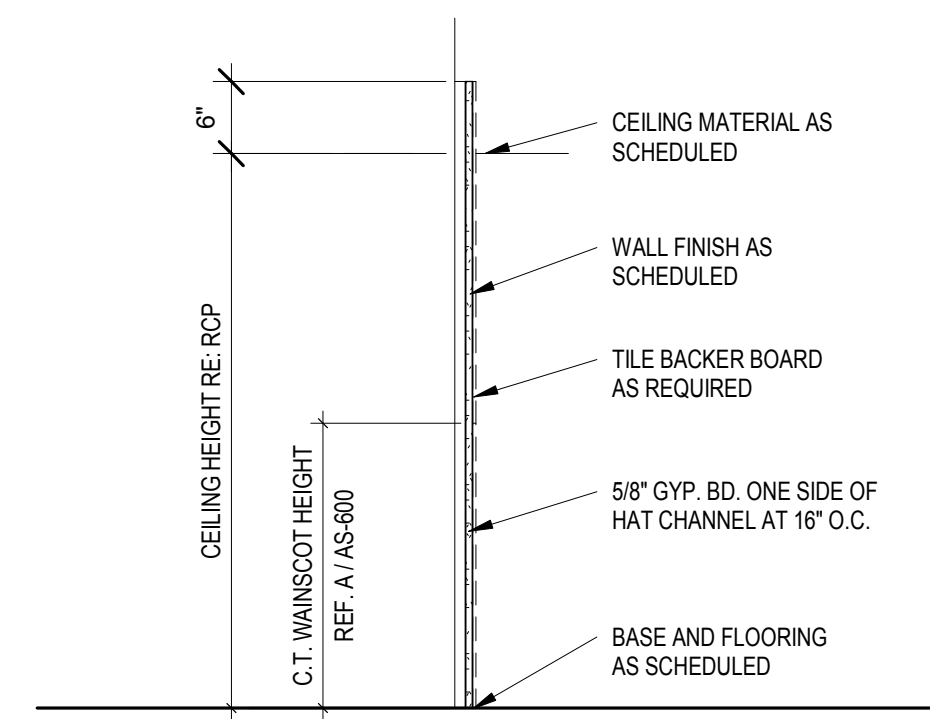


MARK	DETAILS
7A	1 LAYER 5/8\"/>
7B	1 LAYER 5/8\"/>
7C	1 LAYER 5/8\"/>

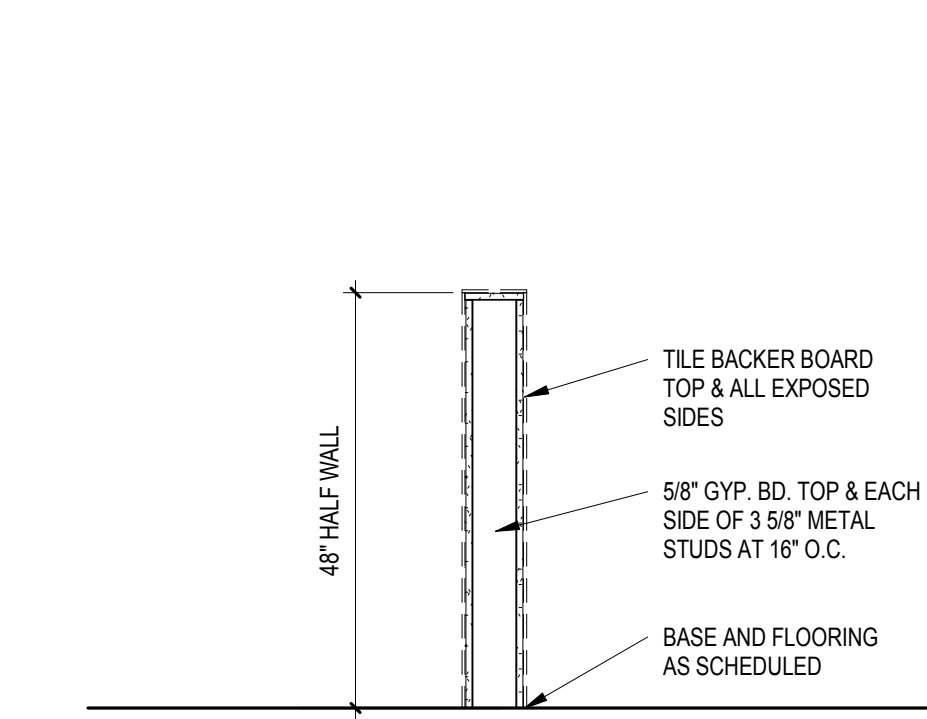


MARK	DETAILS
6A	1 LAYER 5/8\"/>

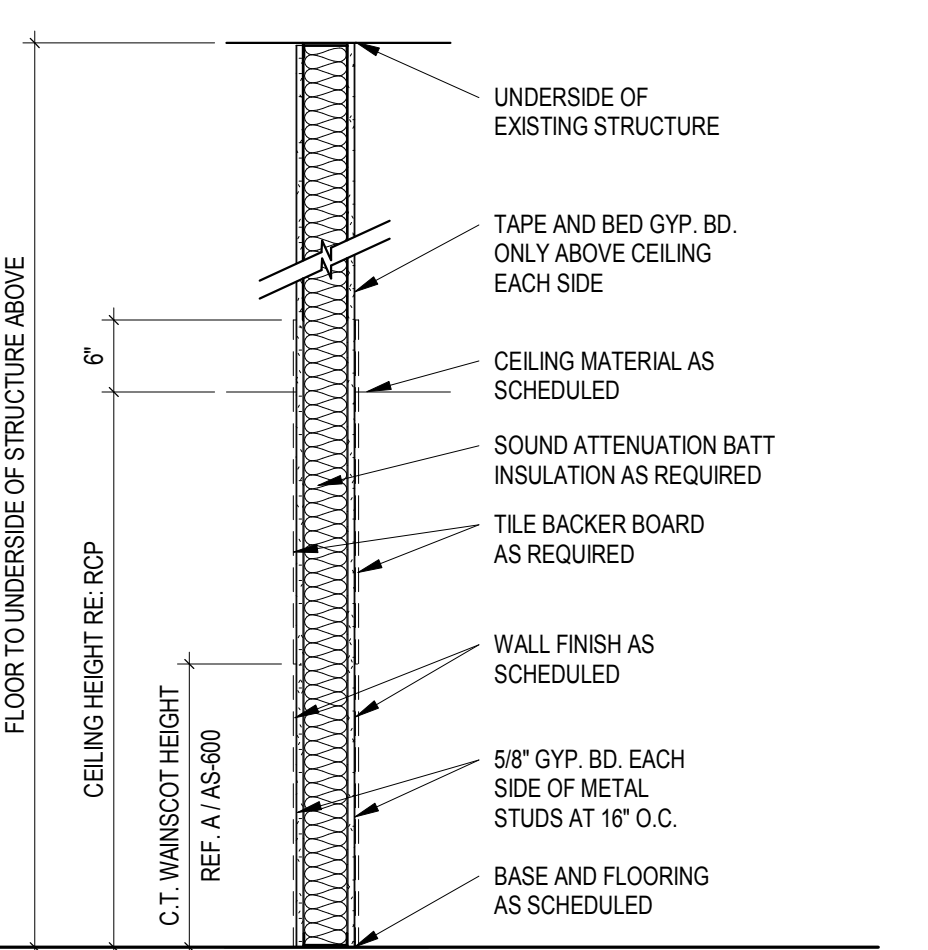


MARK	DETAILS
5A	1 LAYER 5/8\"/>
5B	1 LAYER 5/8\"/>
5C	1 LAYER 5/8\"/>
5D	1 LAYER 5/8\"/>

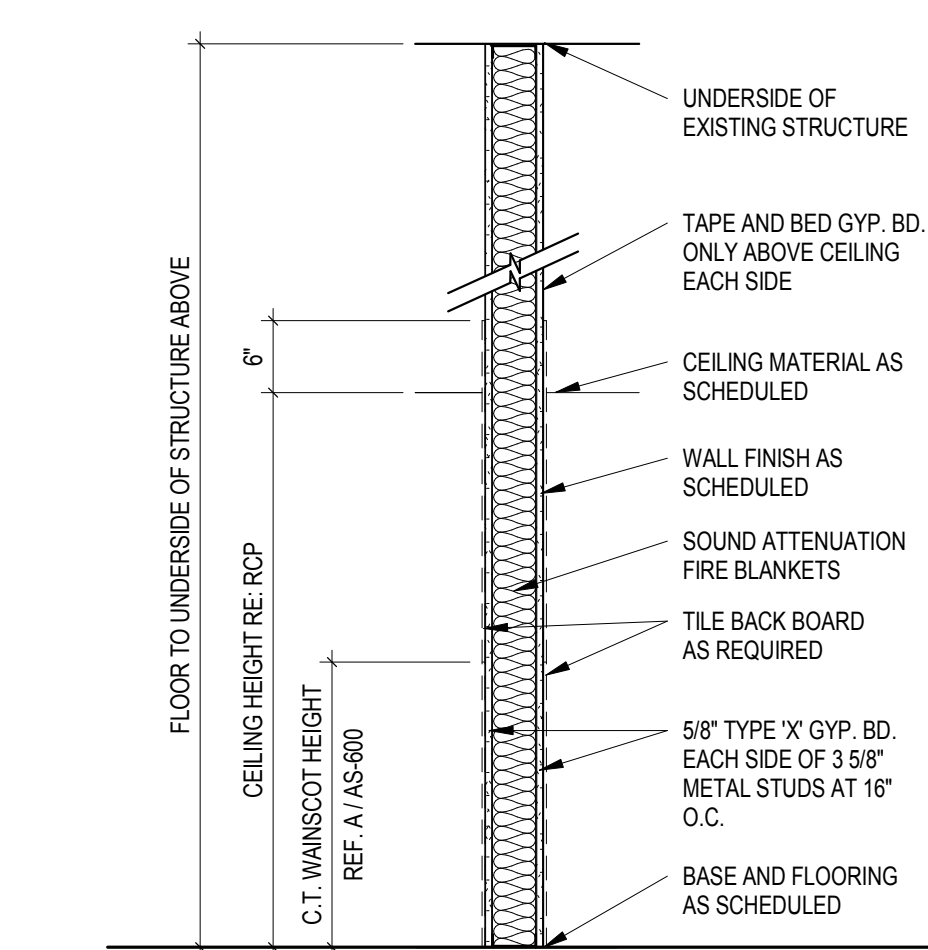


MARK	DETAILS
4A	1 LAYER 5/8\"/>
4B	1 LAYER 5/8\"/>
4C	1 LAYER 5/8\"/>

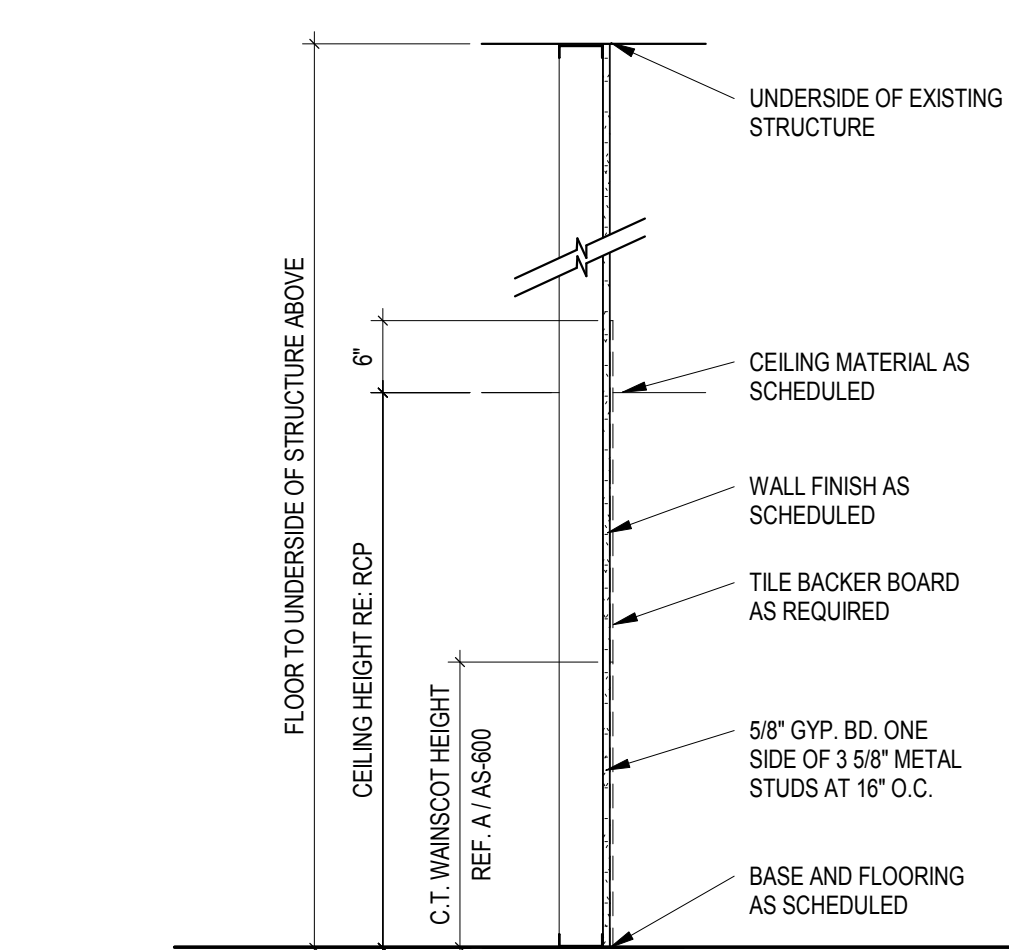

MARK	DETAILS
3A	1 LAYER 5/8\"/>
3B	1 LAYER 5/8\"/>
3C	1 LAYER 5/8\"/>
3D	1 LAYER 5/8\"/>

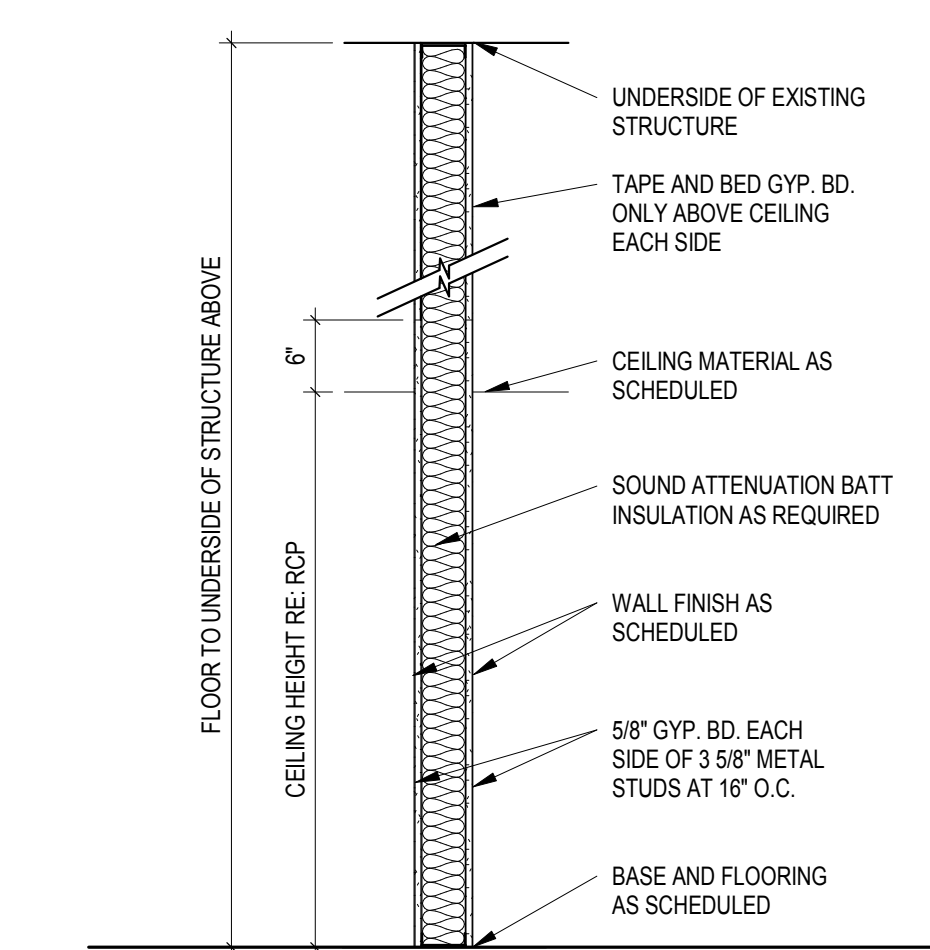

MARK	DETAILS
2A	1 LAYER 5/8\"/>
2B	1 LAYER 5/8\"/>

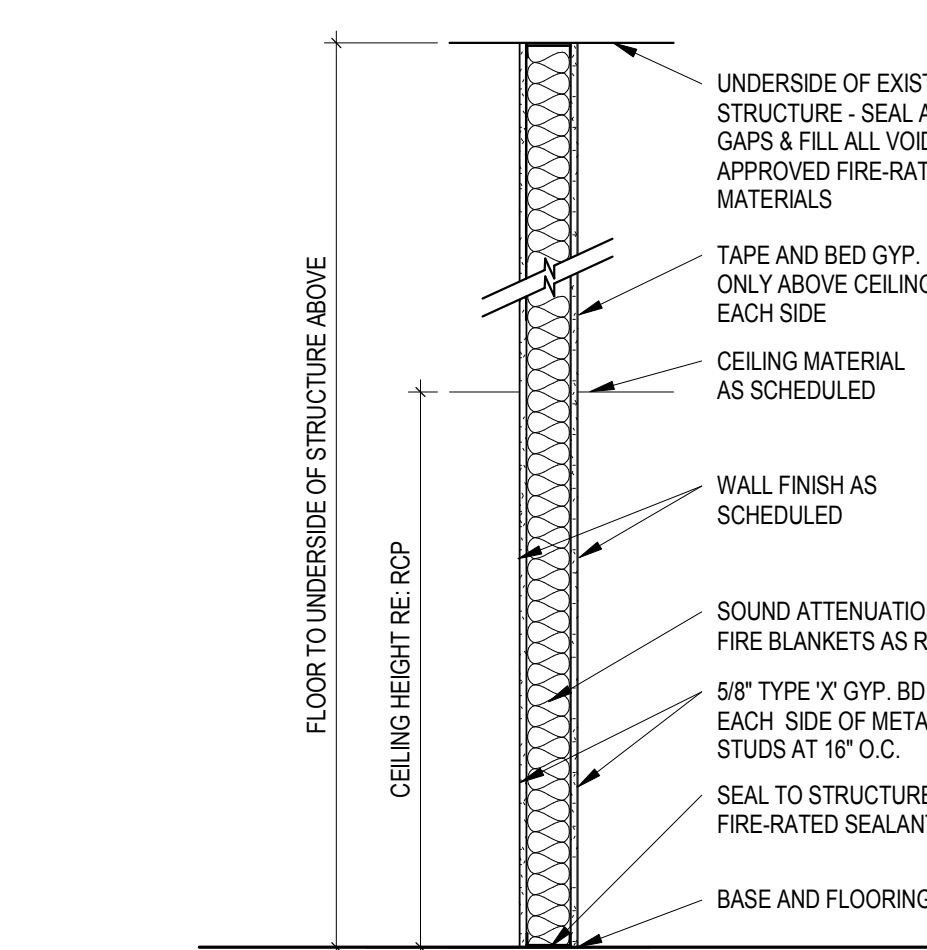

MARK	DETAILS
1A	1 LAYER 5/8\"/>
1B	1 LAYER 5/8\"/>

CONSULTANT INFORMATION

STRUCTURAL / CIVIL ENGINEER
 MECHANICAL / ELECTRICAL / PLUMBING / TECHNICAL ENGINEER
 FIRE PROTECTION ENGINEER

ARCHITECT



Office of Construction and Facilities Management
 U.S. Department of Veteran Affairs

SHEET TITLE
PARTITION TYPES

APPROVED: PROJECT DIRECTOR

PROJECT PHASE
BID DOCUMENTS

FULLY SPRINKLERED

PROJECT TITLE
RENOVATE A & B WING BUILDING 6

PROJECT LOCATION
2200 SW GAGE BLVD.
TOPEKA, KS 66622

VA PROJECT NUMBER
589A5-19-116


BUILDING NUMBER
6
DRAWING NUMBER
6-GI-010

DATE
07/10/2019


CHECKED BY
AWM

DRAWN BY
JET

Dwg. 3 OF 160


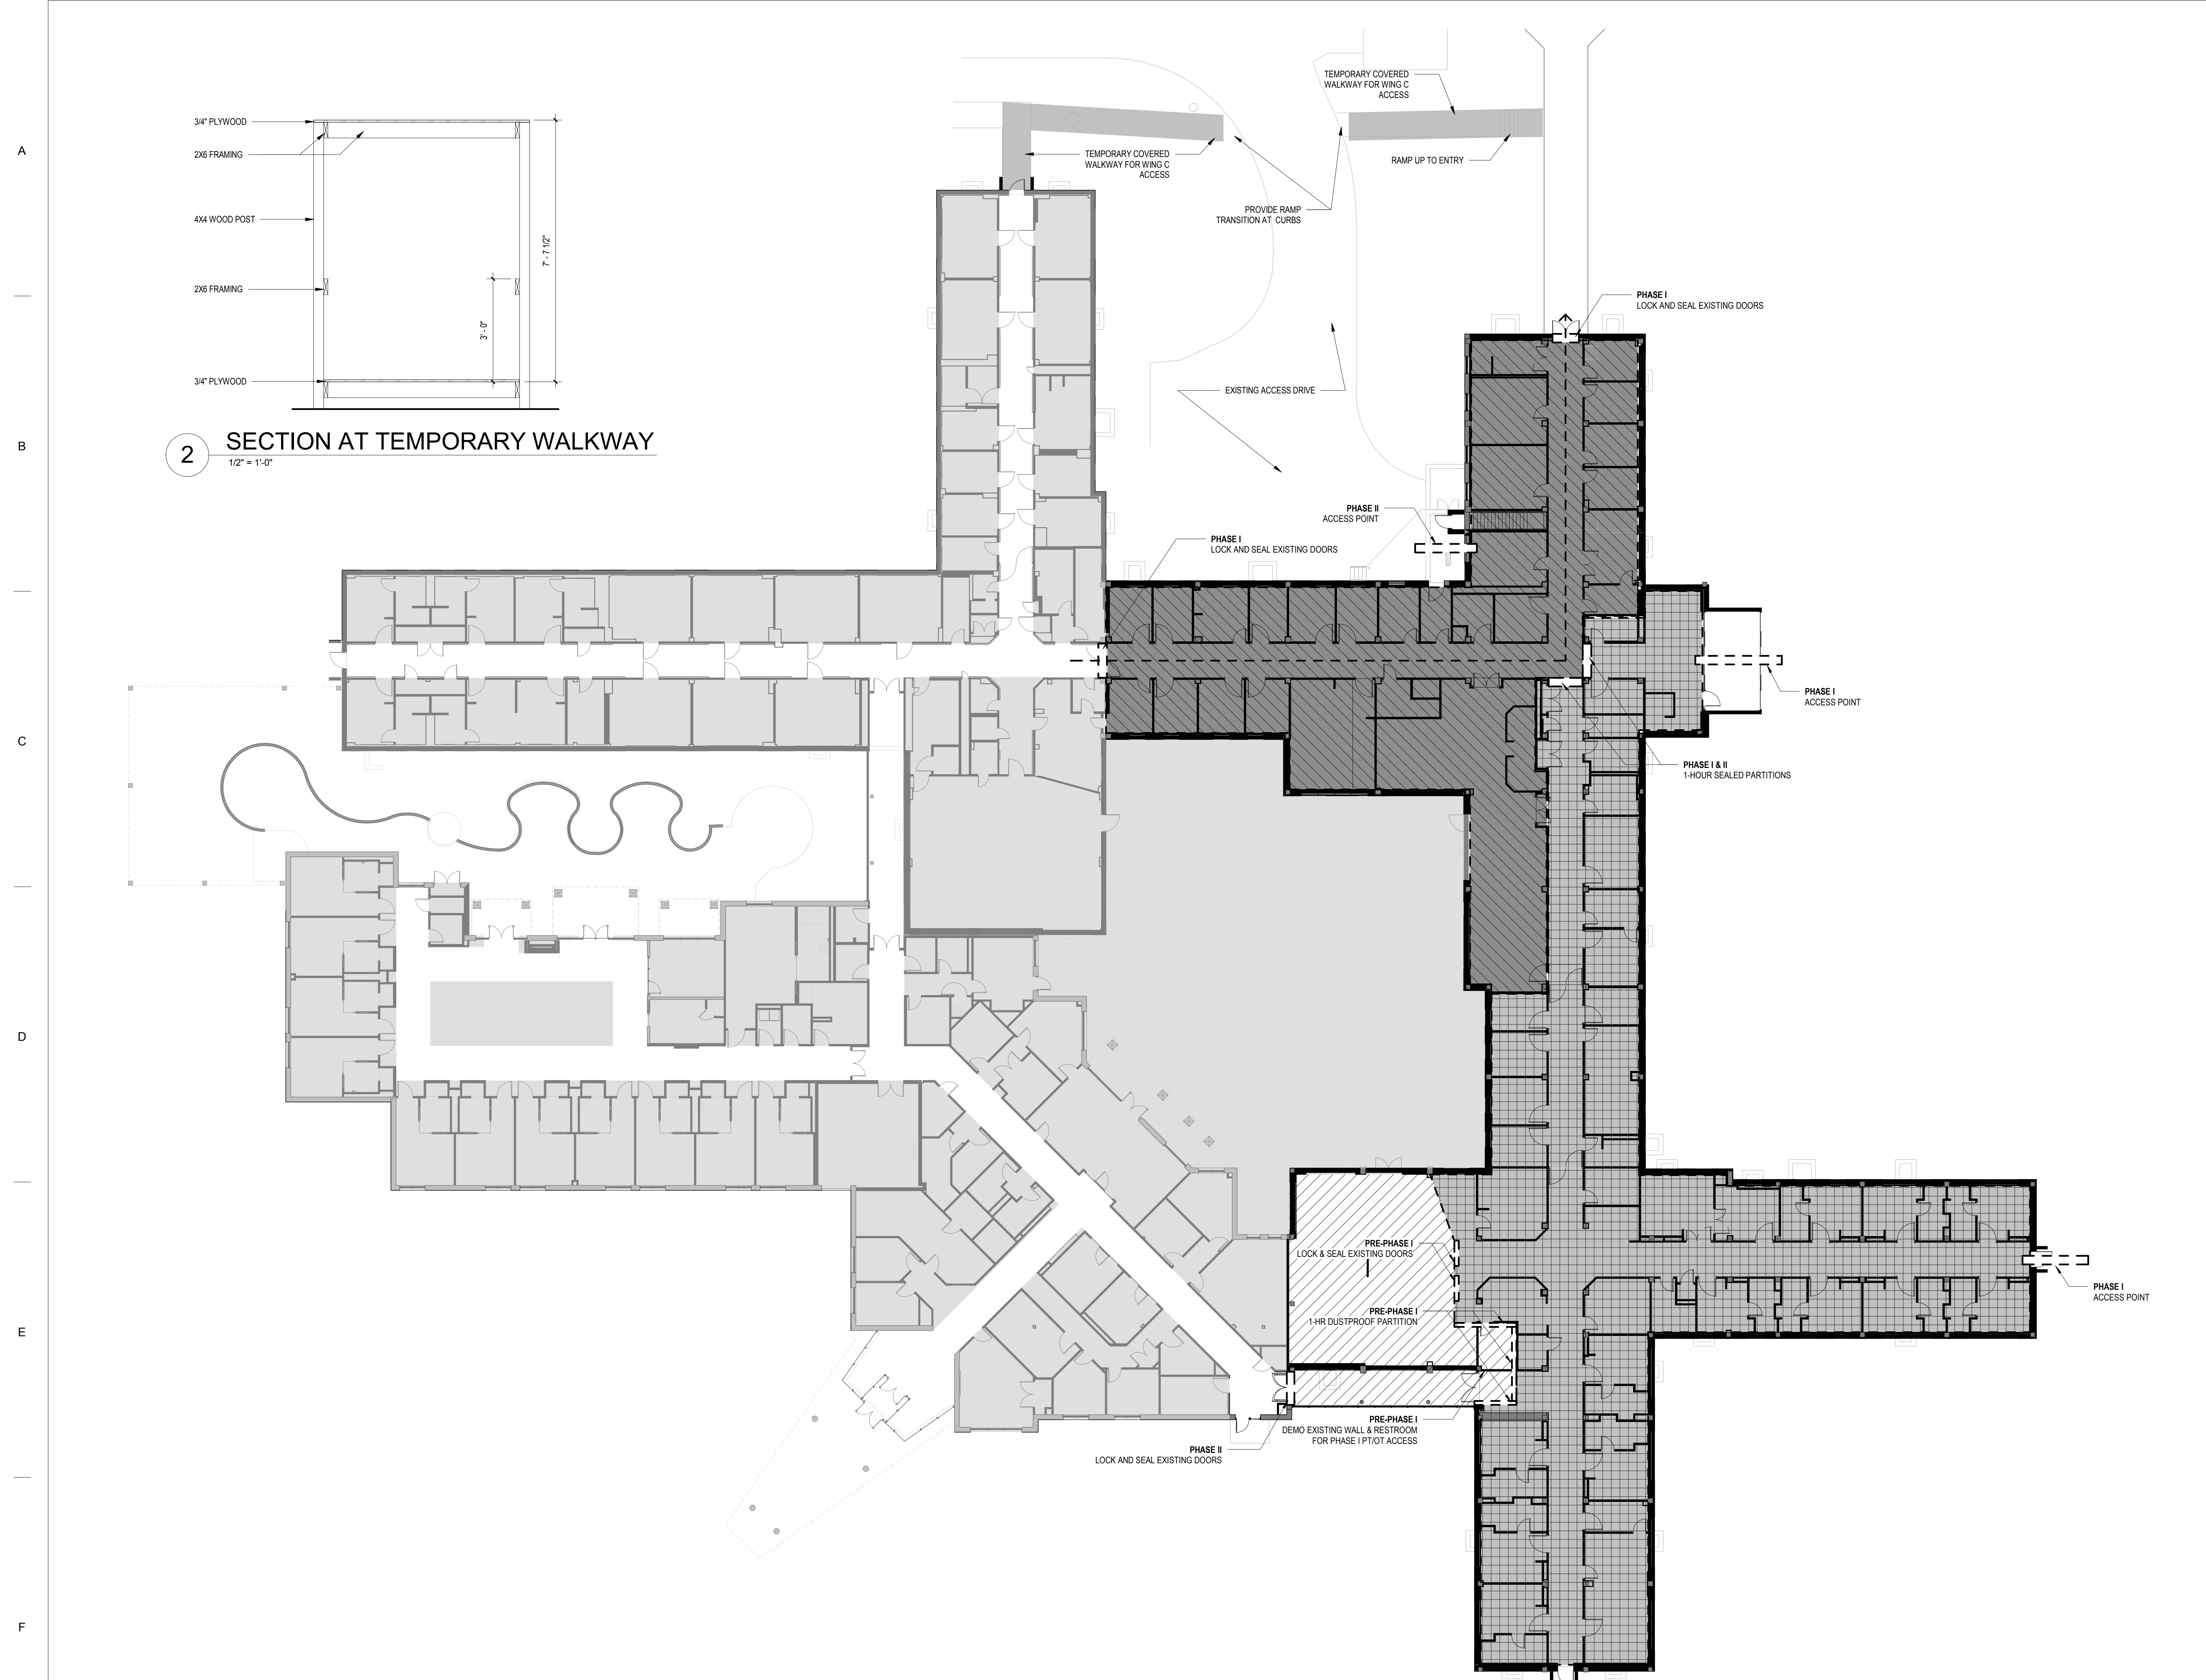


- ### GENERAL ICRA NOTES
- GENERAL NOTES**
- PROVIDE TEMPORARY 1-HOUR RATED SLAB-TO-SLAB BARRIERS CONSIST OF 3-5/8\"/>
- INTERNAL DEMOLITION AND CONSTRUCTION ACTIVITIES DUST AND DEBRIS CONTROL**
- USE A-WING SOUTH ENTRY AS PRIMARY CONSTRUCTION ACCESS FOR PHASE I - USE B-WING SOUTH EMERGENCY EXIT FOR ALTERNATE ACCESS AS PHASE I WORK PROGRESSES. USE NORTHEAST CONFERENCE ROOM FOR PHASE II CONSTRUCTION ACCESS.
 - TRAFFIC CONTROL: DESIGNATED ENTRY AND EXIT PROCEDURES SHALL BE DEFINED. EGRESS PATHS SHALL BE FREE OF DEBRIS. ONLY AUTHORIZED PERSONNEL SHALL BE ALLOWED TO ENTER THE CONSTRUCTION ZONE. SIGNAGE SHALL DIRECT PEDESTRIAN TRAFFIC AWAY FROM THE CONSTRUCTION AREA AND MATERIALS.
 - CONTRACTOR SHALL USE TWO CARTS TO TRANSFER CONSTRUCTION MATERIAL AND OUT OF THE PROJECT - CLEAN CART SHALL BE USED. THE NOT SO CLEAN CART SHALL BE USED BETWEEN THE MAIN ENTRY AND THE CONSTRUCTION STAGING PREP AREA.
 - DEMOLITION DEBRIS: DEBRIS SHALL BE REMOVED IN CARTS WITH TIGHTLY FITTED COVERS, USING DESIGNATED TRAFFIC ROUTE. EFFORTS SHALL BE MADE TO MINIMIZE USE OF ELEVATORS WITH AN EMPHASIS ON TRANSPORT DURING THE LOWEST PERIOD OF ACTIVITY. DEBRIS SHALL BE REMOVED DAILY AND AT TIMES SPECIFIED BY THE COR. IF CHUTES ARE USED TO DIRECT DEBRIS OUTSIDE, HIGH EFFICIENCY PARTICULATE AIR (HEPA) FILTERED NEGATIVE AIR MACHINES SHALL BE USED, AND THE CHUTE OPENING SHALL BE SEALED WHEN NOT IN USE. FILTERS SHALL BE BAGGED AND SEALED BEFORE BEING TRANSPORTED OUT OF THE CONSTRUCTION AREA. THE CONTRACTOR SHALL NOT HAUL DEBRIS THROUGH PATIENT-CARE AREAS WITHOUT PRIOR APPROVAL OF THE COR.
 - EXTERIOR WINDOWS: EXISTING WINDOWS SHALL BE PROTECTED TO PREVENT DAMAGE BY ADJACENT CONSTRUCTION WORK.
- VENTILATION AND ENVIRONMENTAL CONTROLS**
- AIR SYSTEM FLOW: THE COR VERIFY AND ACKNOWLEDGE CONTRACTOR WHETHER THE CONSTRUCTION AREA USES FRESH/OUTSIDE OR RE-CIRCULATED AIR. FILTERS SHALL BE ADDED OR RETURN VENTS COVERED AS NEEDED WITH FILTER MATERIAL OR PLASTIC. AIR MUST FLOW FROM CLEAN TO DIRTY PLACES.
 - NEGATIVE AIR PRESSURE: THE AIR WITHIN THE CONSTRUCTION AREA SHALL BE NEGATIVE WITH RESPECT TO SURROUNDING AREAS AND WITH NO DISRUPTION OF AIR SYSTEMS OF ADJACENT AREAS. USE OF THE NEGATIVE AIR PRESSURE SYSTEM WITHIN THE ENCLOSURE TO REMOVE DUST SHALL PASS AIR THROUGH AN INDUSTRIAL GRADE PORTABLE HEPA FILTER CAPABLE OF FILTRATION RATES OF 300-800 CUBIC FEET PER MINUTE (CFM/MIN), OR EXHAUST AIR DIRECTLY TO THE OUTSIDE IF APPROVED BY COR. IF EXHAUST SHALL BE TIED INTO A RE-CIRCULATED AIR SYSTEM, PRE-FILTER AND HEPA FILTER SHALL BE USED BEFORE EXHAUST TO PREVENT CONTAMINATION OF THE DUCTS.
 - ADJACENT AREAS: THE STATUS OF SEALED PENETRATIONS AND INTACT CEILING SHALL BE VERIFIED DAILY.
 - AIR EXCHANGE RATES AND PRESSURE RELATIONSHIPS: VAVC AND CONTRACTOR SHALL VERIFY AND MAINTAIN PROPER RATES IN CRITICAL AREAS NEAR CONSTRUCTION ACTIVITY AND ENSURE AIR IS NOT BEING RE-CIRCULATED WITHOUT FILTRATION FROM THE CONSTRUCTION AREA ELSEWHERE. PROVIDE AIR PRESSURE TESTING THROUGHOUT THE PROJECT IN THE FREQUENCY AS IDENTIFIED BY THE COR.
- DUST CONTROL PLAN NOTES**
- THIS PROJECT INCLUDES CONSTRUCTION ENTRY VESTIBULE, CONSTRUCTION ANTEROOM. THEY SHALL BE USED WHEN GOING INTO CONSTRUCTION AREA AND LEAVING THE CONSTRUCTION AREA AND TIGHT SEALS SHALL BE MAINTAINED AT THE FULL PERIMETER OF WALLS AND WALL PENETRATIONS. ANY DUST SHALL BE IMMEDIATELY CLEANED IF TRACKED OUTSIDE OF THE CONSTRUCTION BARRIER. UPON COMPLETION OF THE CONSTRUCTION PHASE, DUST BARRIERS SHALL BE REMOVED CAREFULLY AFTER VIA COR'S APPROVAL TO MINIMIZE SPREADING OF DUST AND THE CONTRACTOR SHALL HAVE TEMPORARY DUST PROTECTION IN PLACE BEFORE REMOVAL OF A PERMANENT BARRIER.

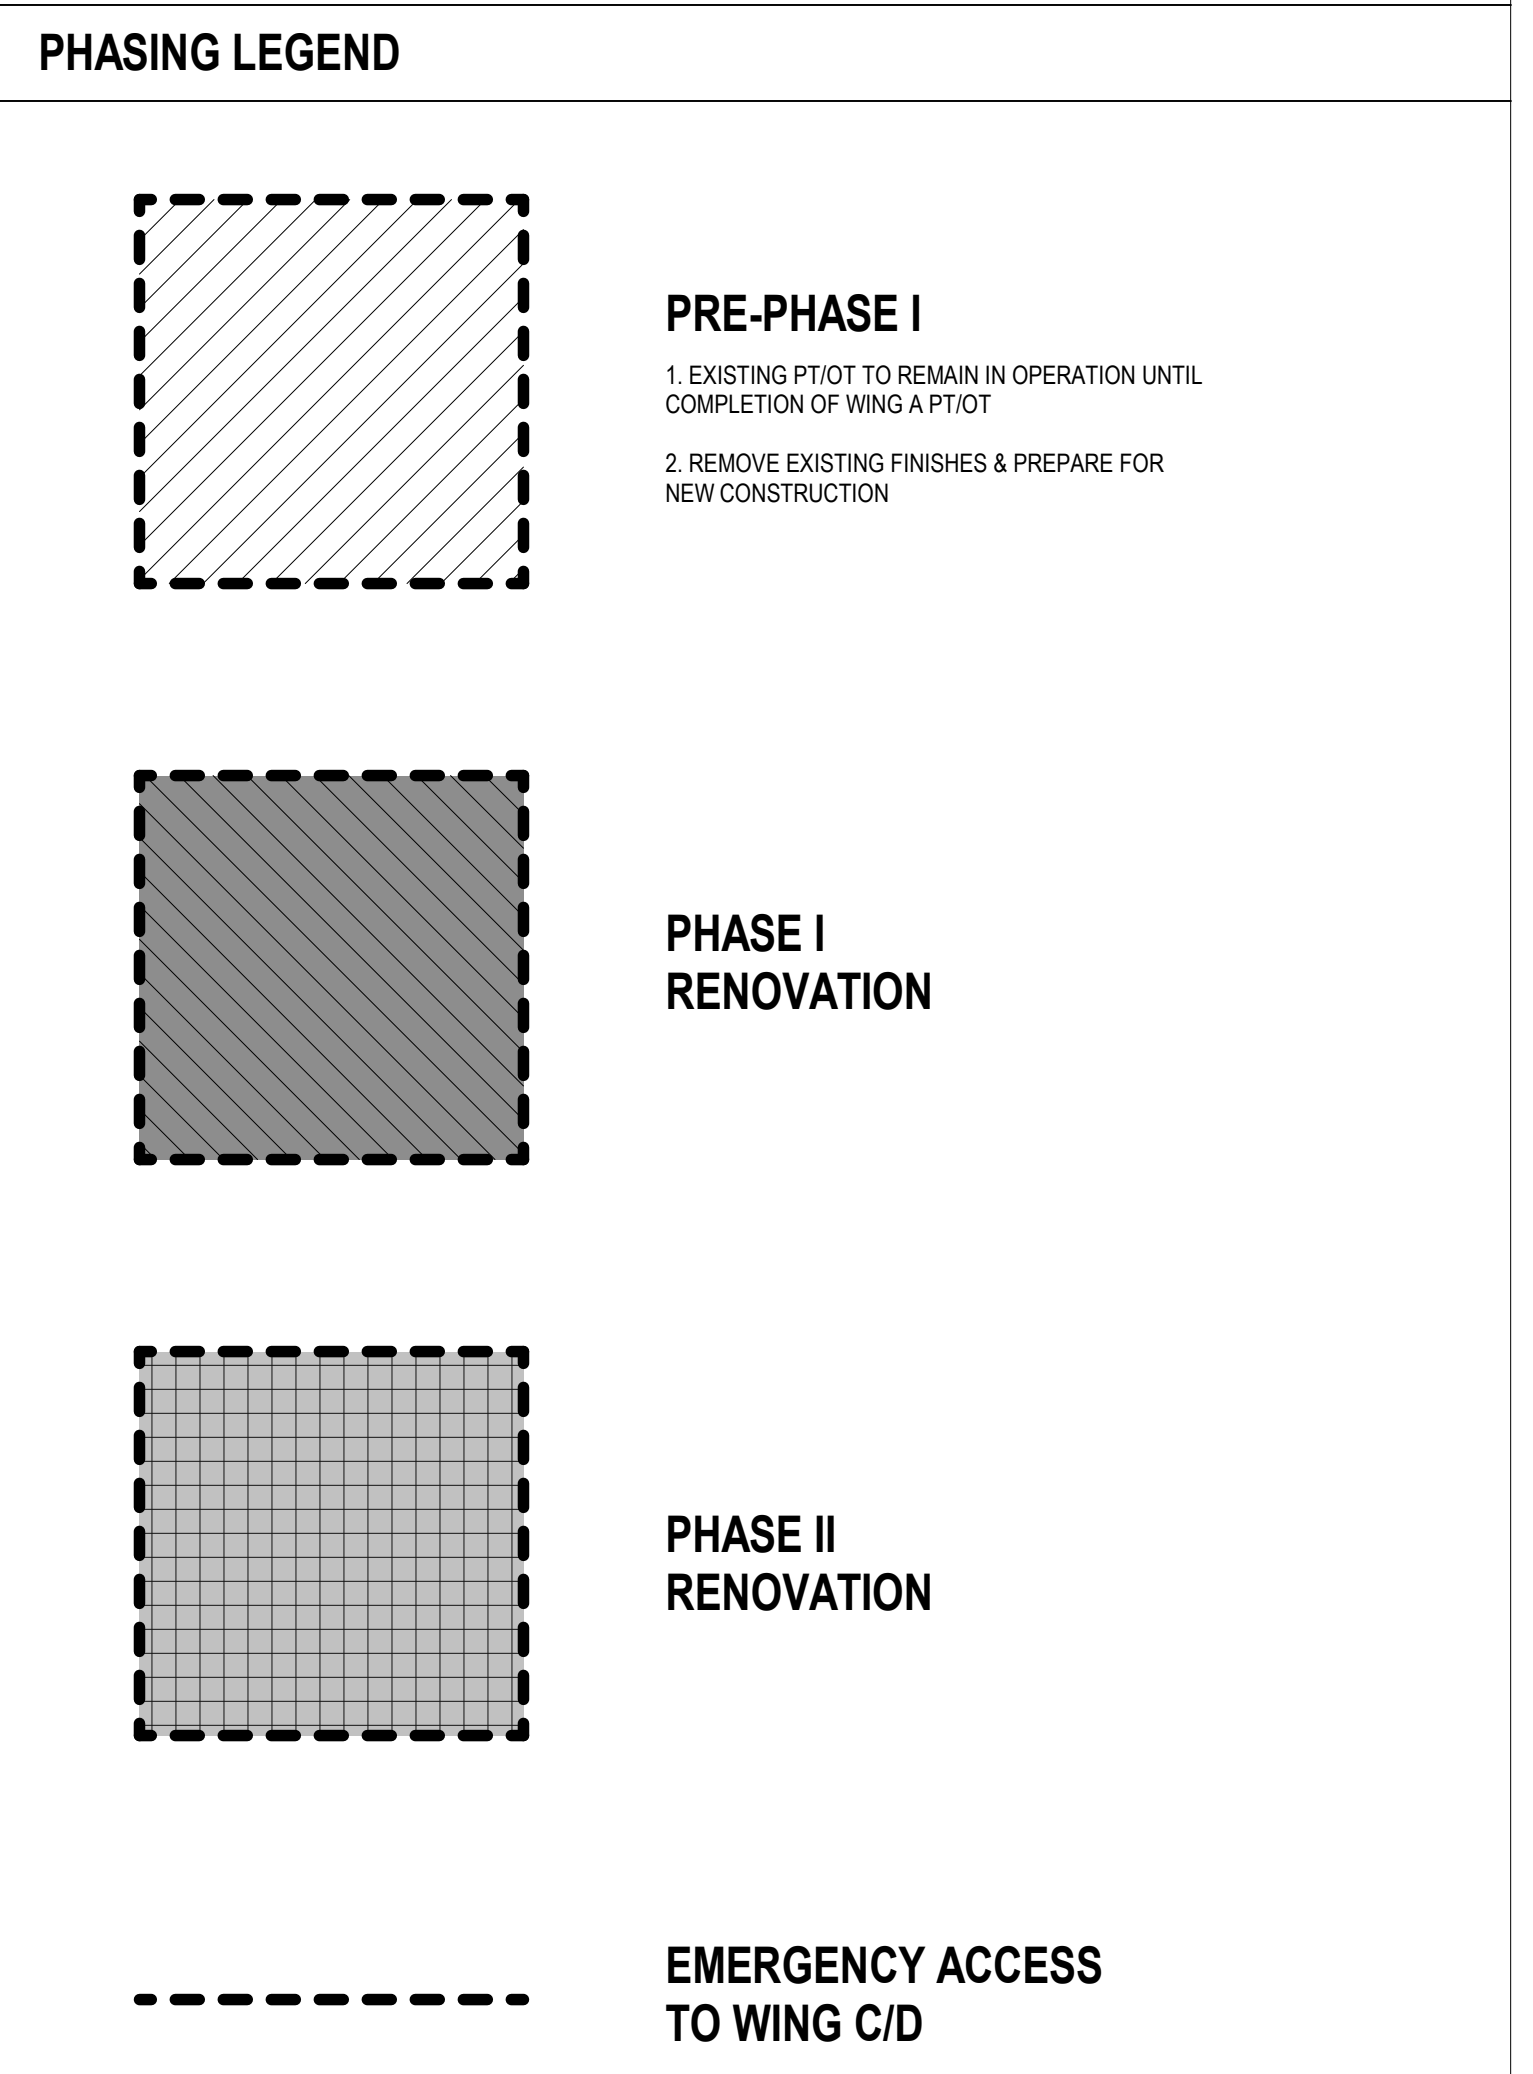

2 SECTION AT TEMPORARY WALKWAY
1/2" = 1'-0"

1 GENERAL - ICRA & PHASING
1/16" = 1'-0"

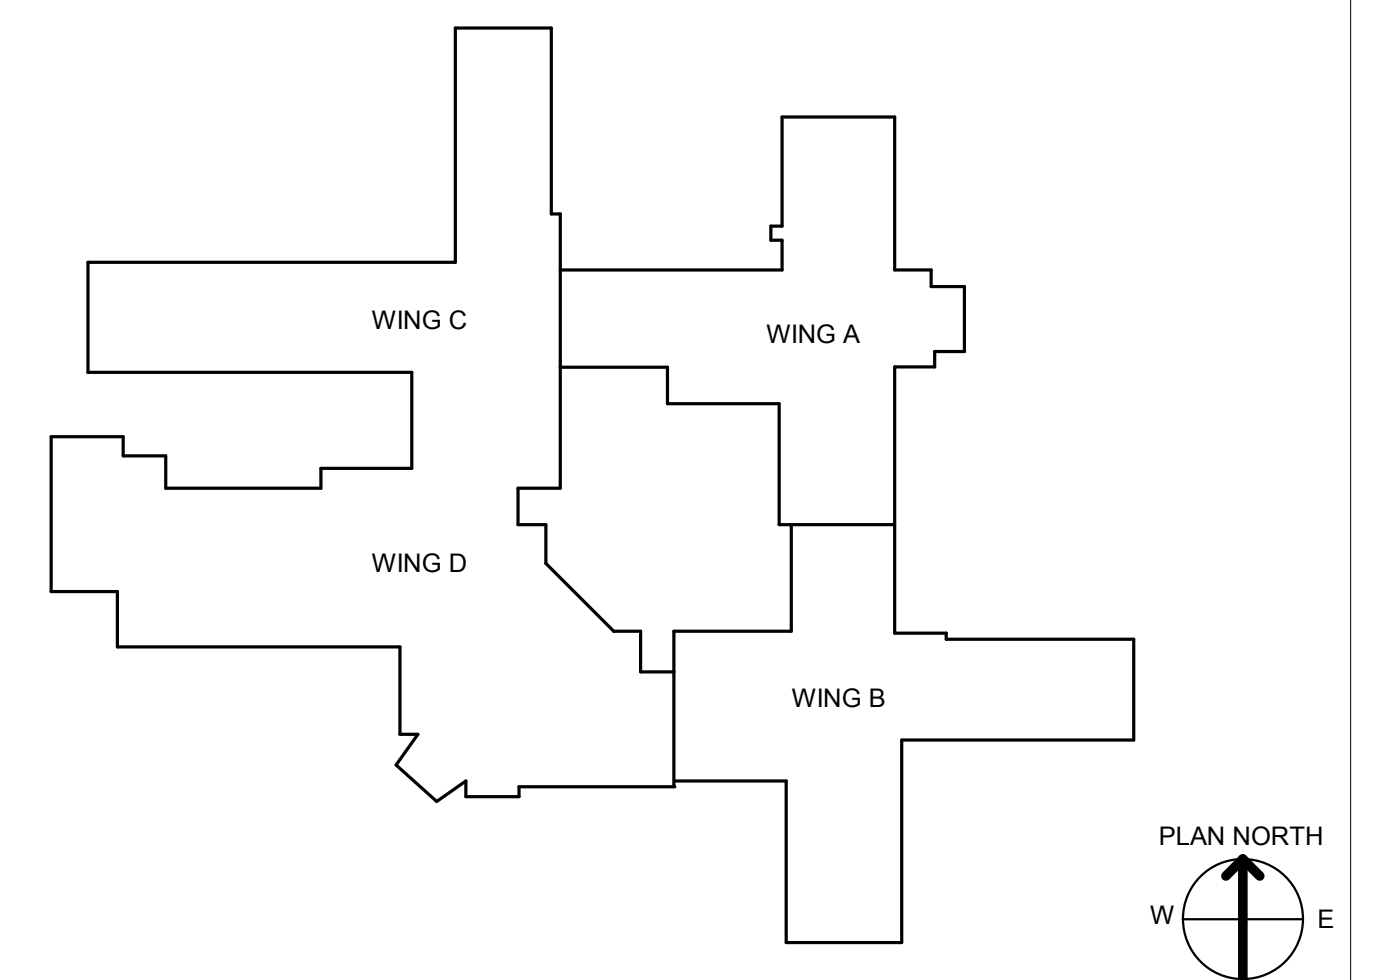
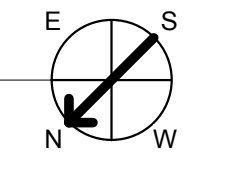


CONSULTANT INFORMATION STRUCTURAL / CIVIL ENGINEER: SPUR DESIGN, 11227 W. 112TH STREET, SUITE 200, OVERLAND PARK, KS 66210 (913) 214-2169 MECHANICAL / ELECTRICAL / PLUMBING / TECHNICAL ENGINEER: SPUR DESIGN, 11020 KING STREET, SUITE 350, OVERLAND PARK, KS 66210 (405) 842-6100 FIRE PROTECTION ENGINEER: POOLE FIRE PROTECTION, INC., 19910 W. 161ST STREET, OLATH, KS 66062 (913) 829-8650			ARCHITECT 513 SW 23th Street, Overland Park, KS 66159 11020 King Street, Suite 350, Overland Park, KS 66210 KS ARCH REG. NO. A-1139, EXP. 12/31/2019 KS ENGR REG. NO. E-2586, EXP. 12/31/2019		Office of Construction and Facilities Management VA U.S. Department of Veteran Affairs SHEET TITLE: ICRA PLAN / ICRA DETAILS / PHASING PLAN PROJECT PHASE: BID DOCUMENTS FULLY SPRINKLERED		PROJECT TITLE: RENOVATE A & B WING BUILDING 6 PROJECT LOCATION: 2200 SW GAGE BLVD. TOPEKA, KS 66622 VA PROJECT NUMBER: 589A5-19-116 BUILDING NUMBER: 6 DRAWING NUMBER: 6-GI-102 Dwg. 4 OF 160	
DATE: 07/10/2019 CHECKED BY: AWM DRAWN BY: JET		APPROVED: PROJECT DIRECTOR		DATE: 07/10/2019 CHECKED BY: AWM DRAWN BY: JET		DATE: 07/10/2019 CHECKED BY: AWM DRAWN BY: JET		

A
B
C
D
E
F

LIFE SAFETY LEGEND	
SYMBOL	DESCRIPTION
34	EGRESS CAPACITY TAG
32	ACTUAL CLEAR WIDTH
11	REQUIRED CLEAR WIDTH
170	ACTUAL EGRESS
170	MAXIMUM EGRESS CAPACITY
D	EGRESS COMPONENT
(D)DOOR (S)STARWAY	

OCCUPANCY USE LEGEND	
HATCH	USE DESCRIPTION
A	ASSEMBLY - LESS CONCENTRATED 150*/PERSON, NET
B	BUSINESS 150*/PERSON, GROSS
EE	EXERCISE ROOMS WITH EQUIPMENT 50*/PERSON, GROSS
R	RESIDENTIAL - BOARD AND CARE 200*/PERSON, GROSS
S	STORAGE 500*/PERSON, GROSS

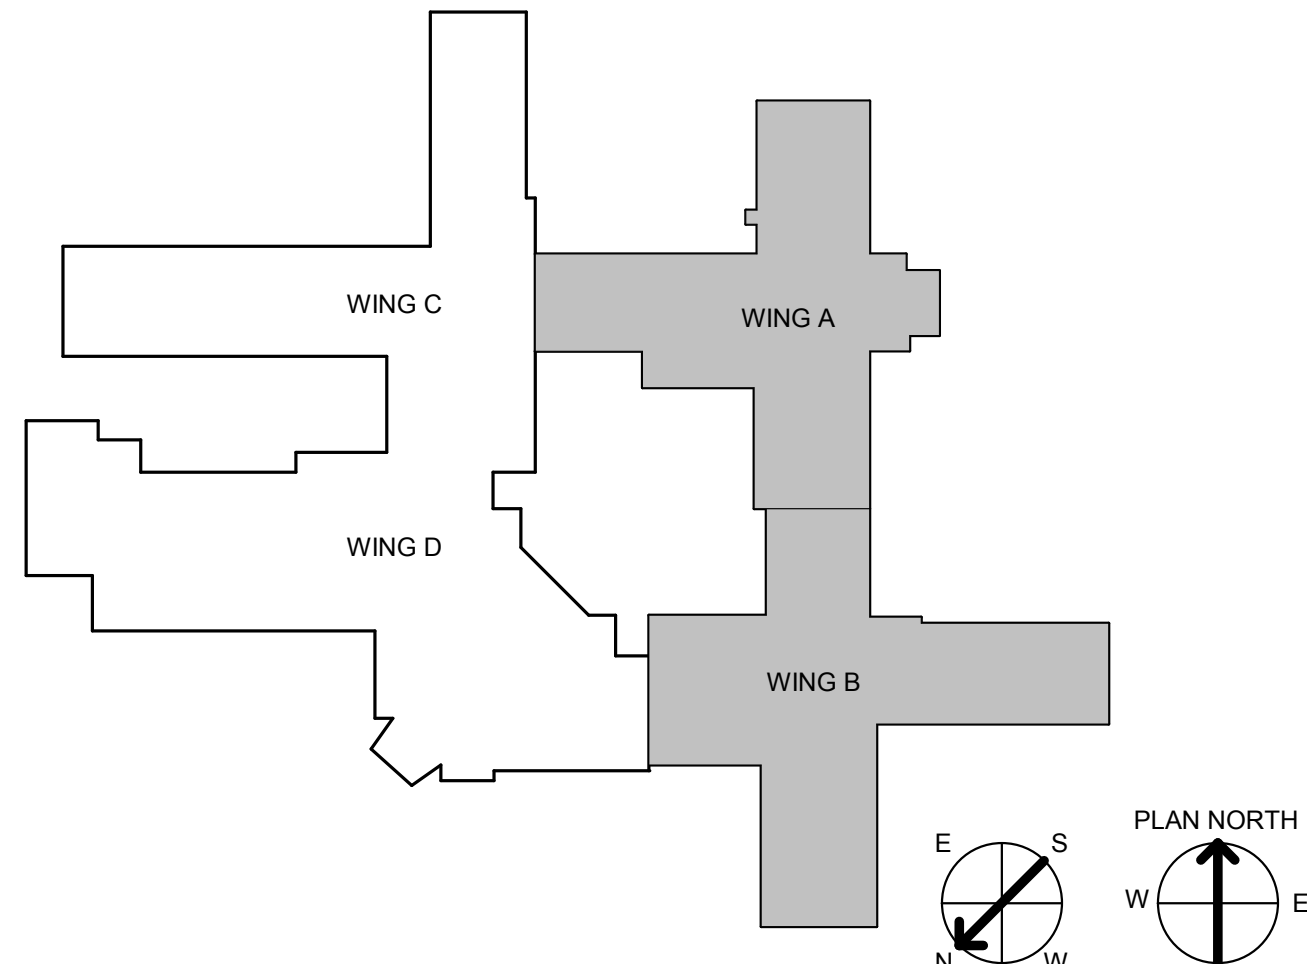
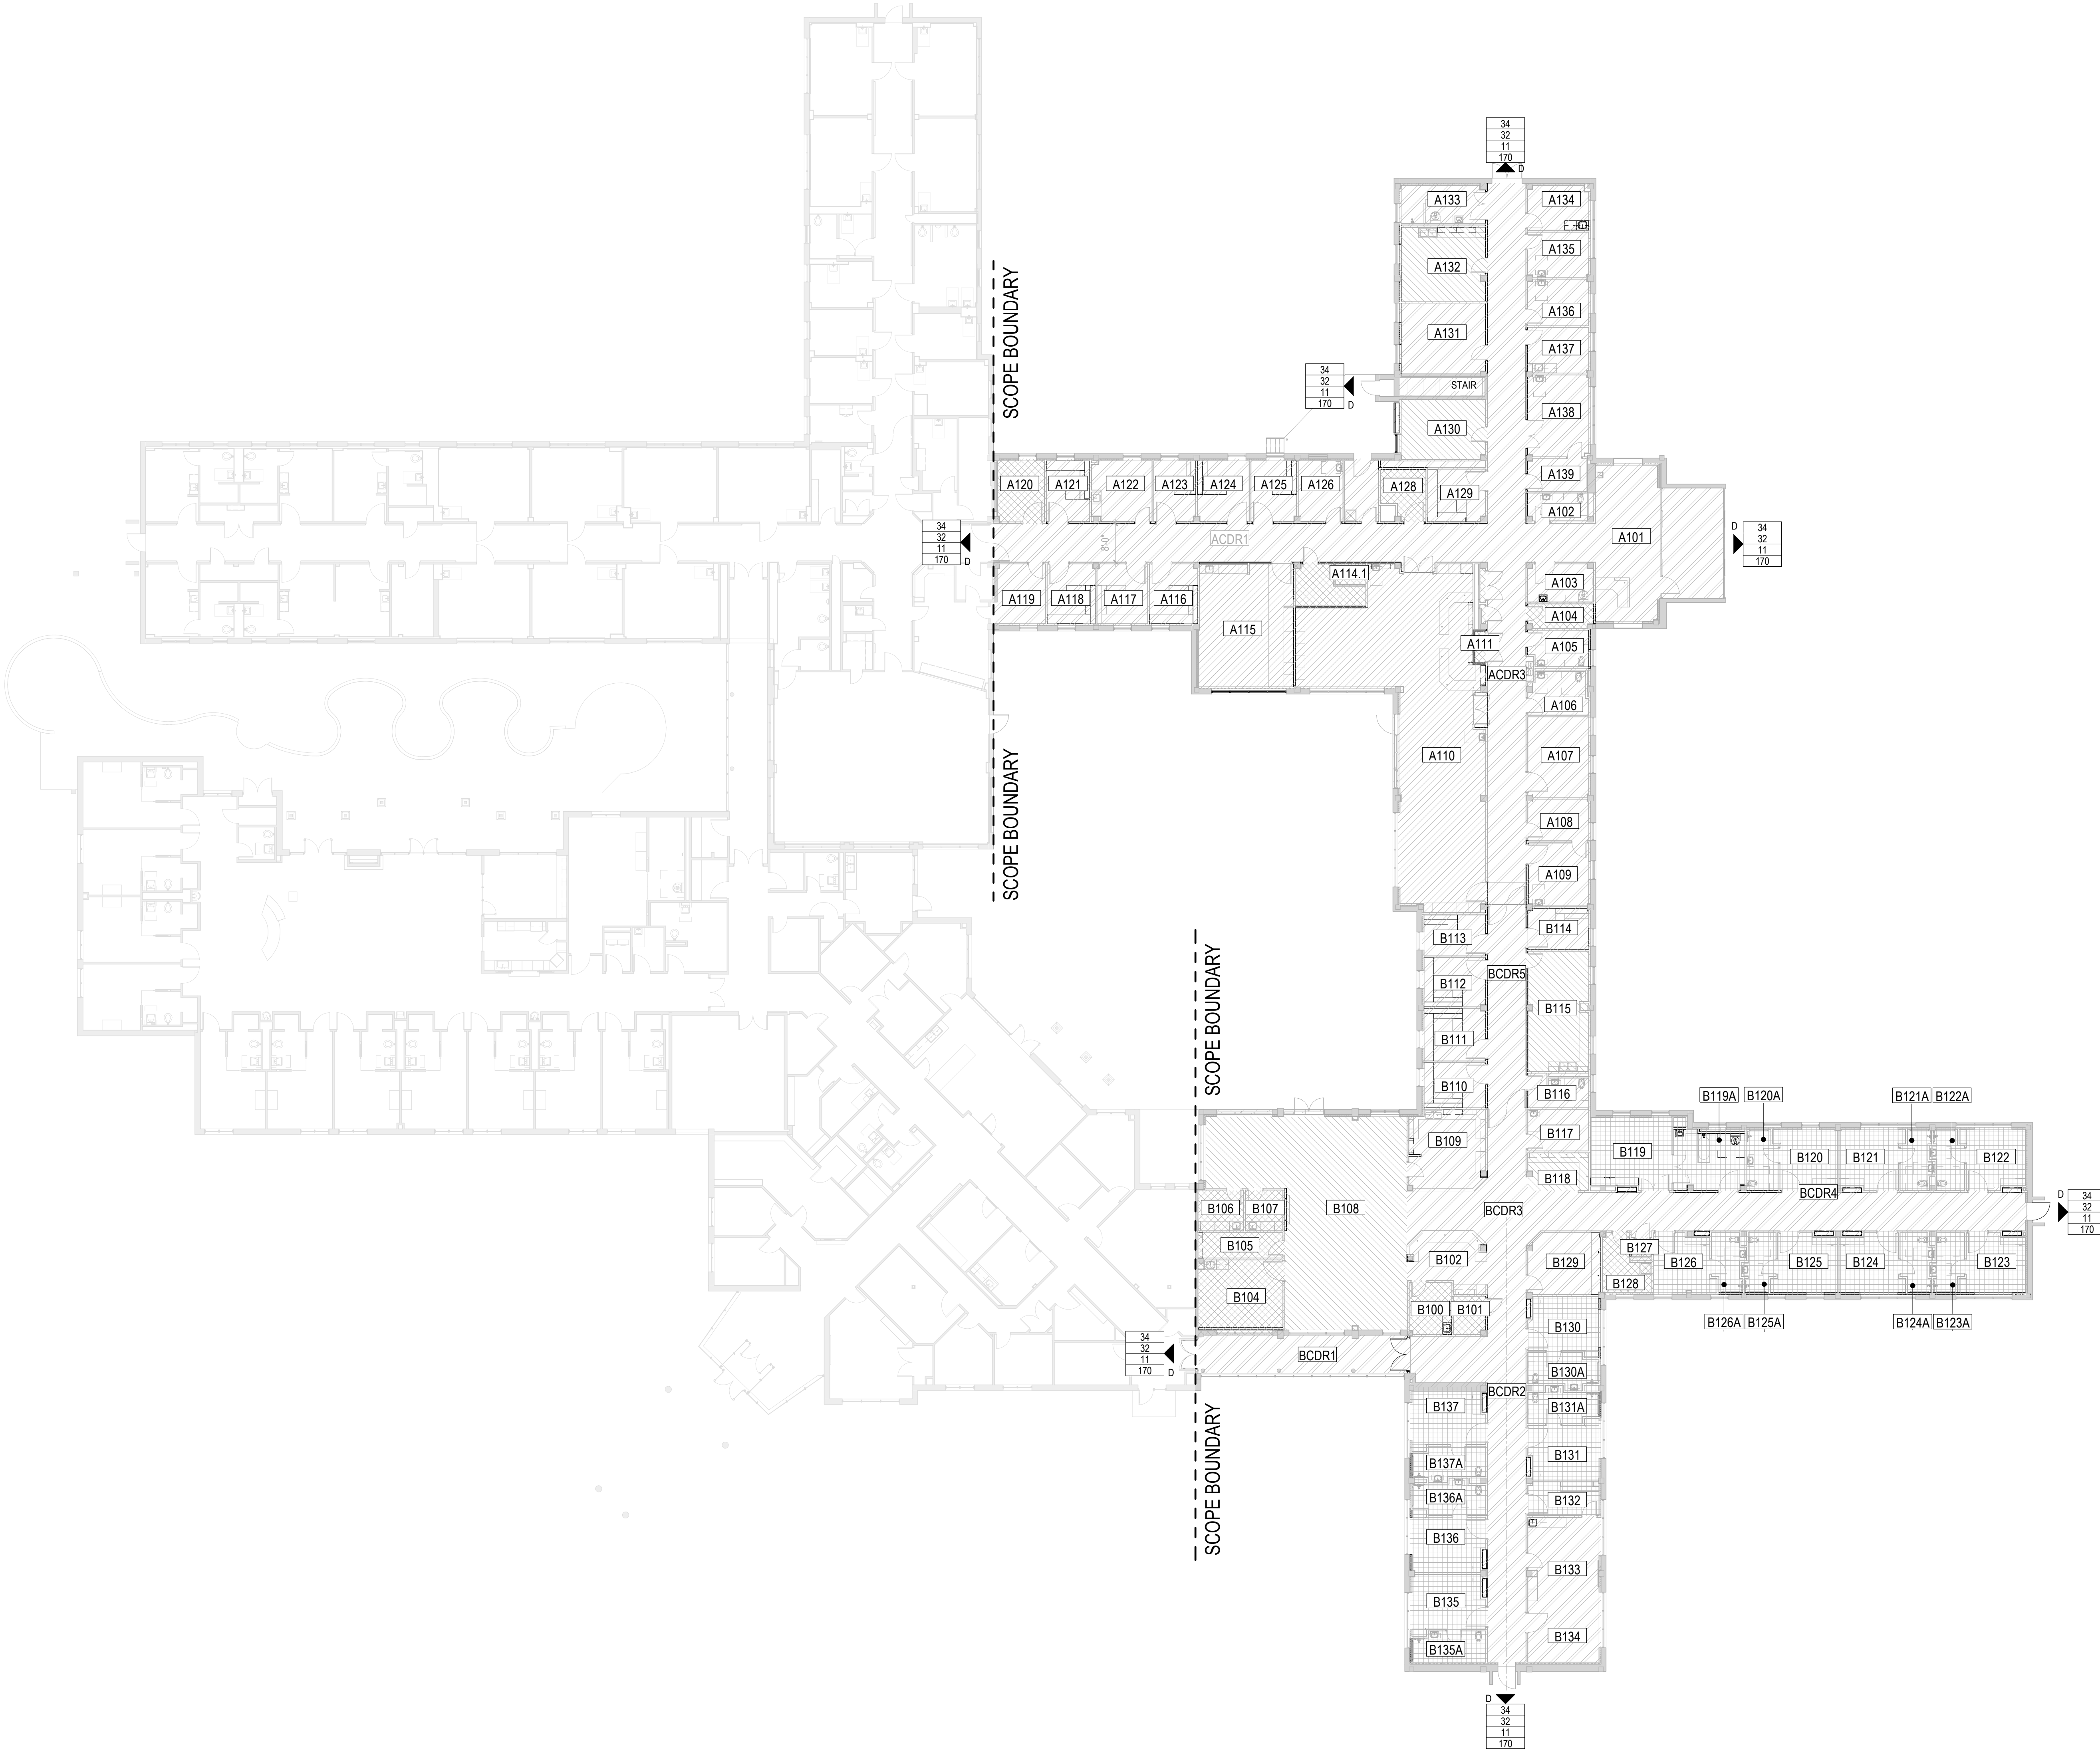


1 GENERAL - LIFE SAFETY OCCUPANCY CLASSIFICATION FLOOR PLAN
1/16" = 1'-0"

CONSULTANT INFORMATION STRUCTURAL / CIVIL ENGINEER: STAND STRUCTURAL ENGINEERING, 11827 W. 112TH STREET, SUITE 200, OVERLAND PARK, KS 66210 (913) 214-2169 MECHANICAL / ELECTRICAL / PLUMBING / TECHNICAL ENGINEER: SPUR DESIGN, 11020 KING STREET, SUITE 350, OVERLAND PARK, KS 66210 (405) 842-6100 FIRE PROTECTION ENGINEER: POOLE FIRE PROTECTION, INC., 19910 W. 161ST STREET, OLATH, KS 66062 (913) 829-8650			ARCHITECT 512 SW 23rd Street, Overland Park, KS 66159 10020 King Street, Suite 300, Overland Park, KS 66159 KS ARCH REG. NO. A-1139, EXP. 12/31/2019 KS ENGR REG. NO. E-2586, EXP. 12/31/2019		Office of Construction and Facilities Management VA U.S. Department of Veteran Affairs		SHEET TITLE: LIFE SAFETY FLOOR PLAN APPROVED: PROJECT DIRECTOR		PROJECT PHASE: BID DOCUMENTS FULLY SPRINKLERED		PROJECT TITLE: RENOVATE A & B WING BUILDING 6 PROJECT LOCATION: 2200 SW GAGE BLVD. TOPEKA, KS 66622		VA PROJECT NUMBER: 589A5-19-116 BUILDING NUMBER: 6 DRAWING NUMBER: 6-GI-103 Dwg. 5 OF 160	
Revision # Date		DATE: 07/10/2019		CHECKED BY: AWM		DRAWN BY: ECO								



LIFE SAFETY LEGEND	
SYMBOL	DESCRIPTION
← - -	PATH OF EGRESS
- - -	PATH OF EGRESS IDENTIFIER
◀	1/2-HOUR RATED FIRE BARRIER
◆	1-HOUR RATED FIRE BARRIER
◆◆	2-HOUR RATED FIRE BARRIER
S◆	1-HOUR RATED FIRE/SMOKE BARRIER
S◆◆	2-HOUR RATED FIRE/SMOKE BARRIER

OCCUPANCY CLASSIFICATION LEGEND	
■	BUSINESS
■	RESIDENTIAL - BOARD AND CARE

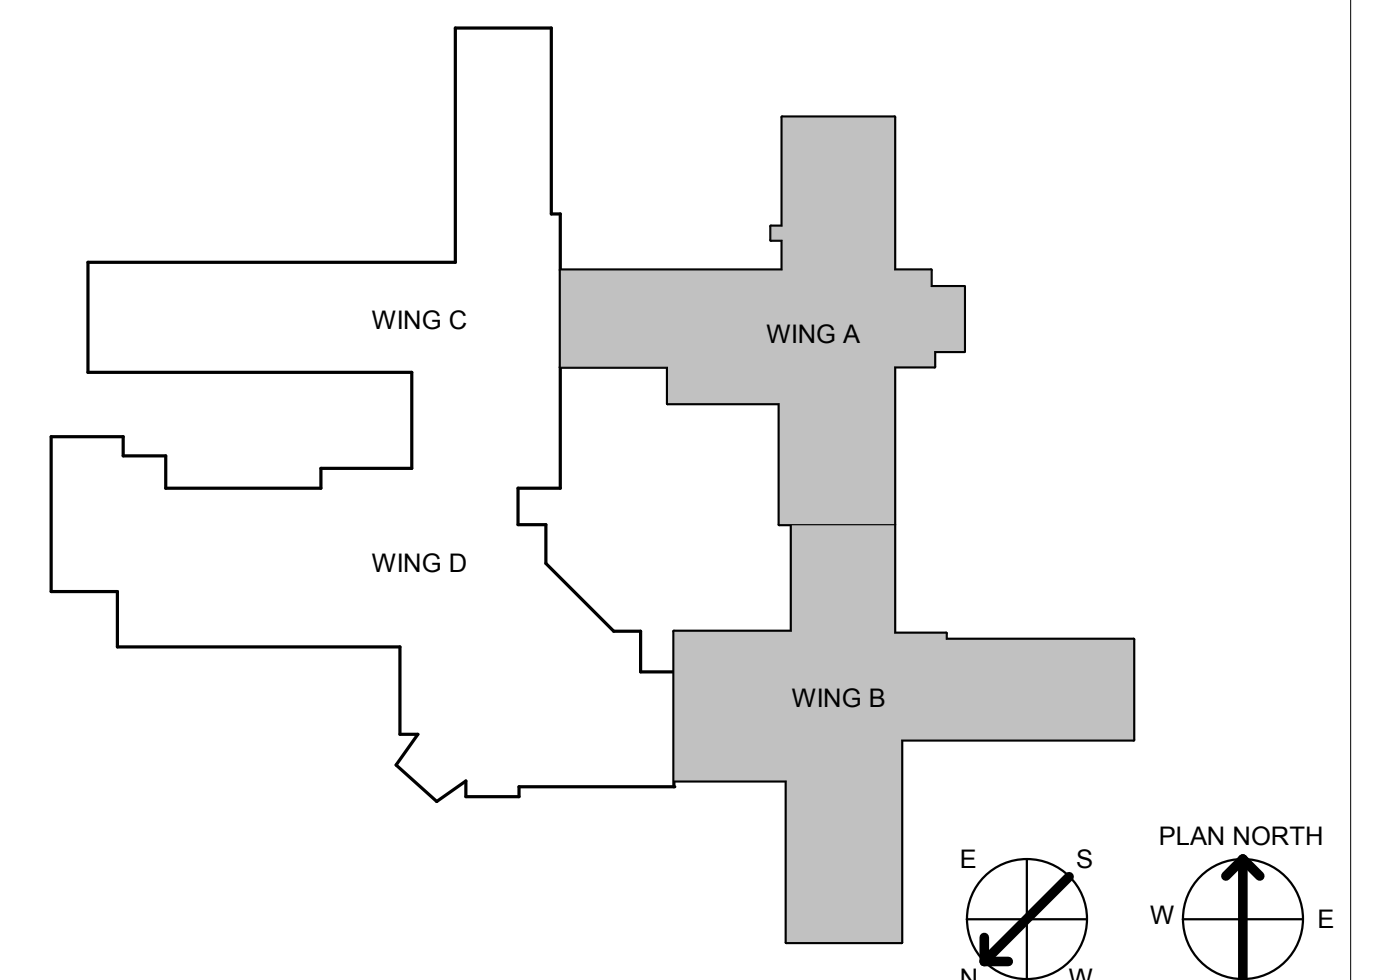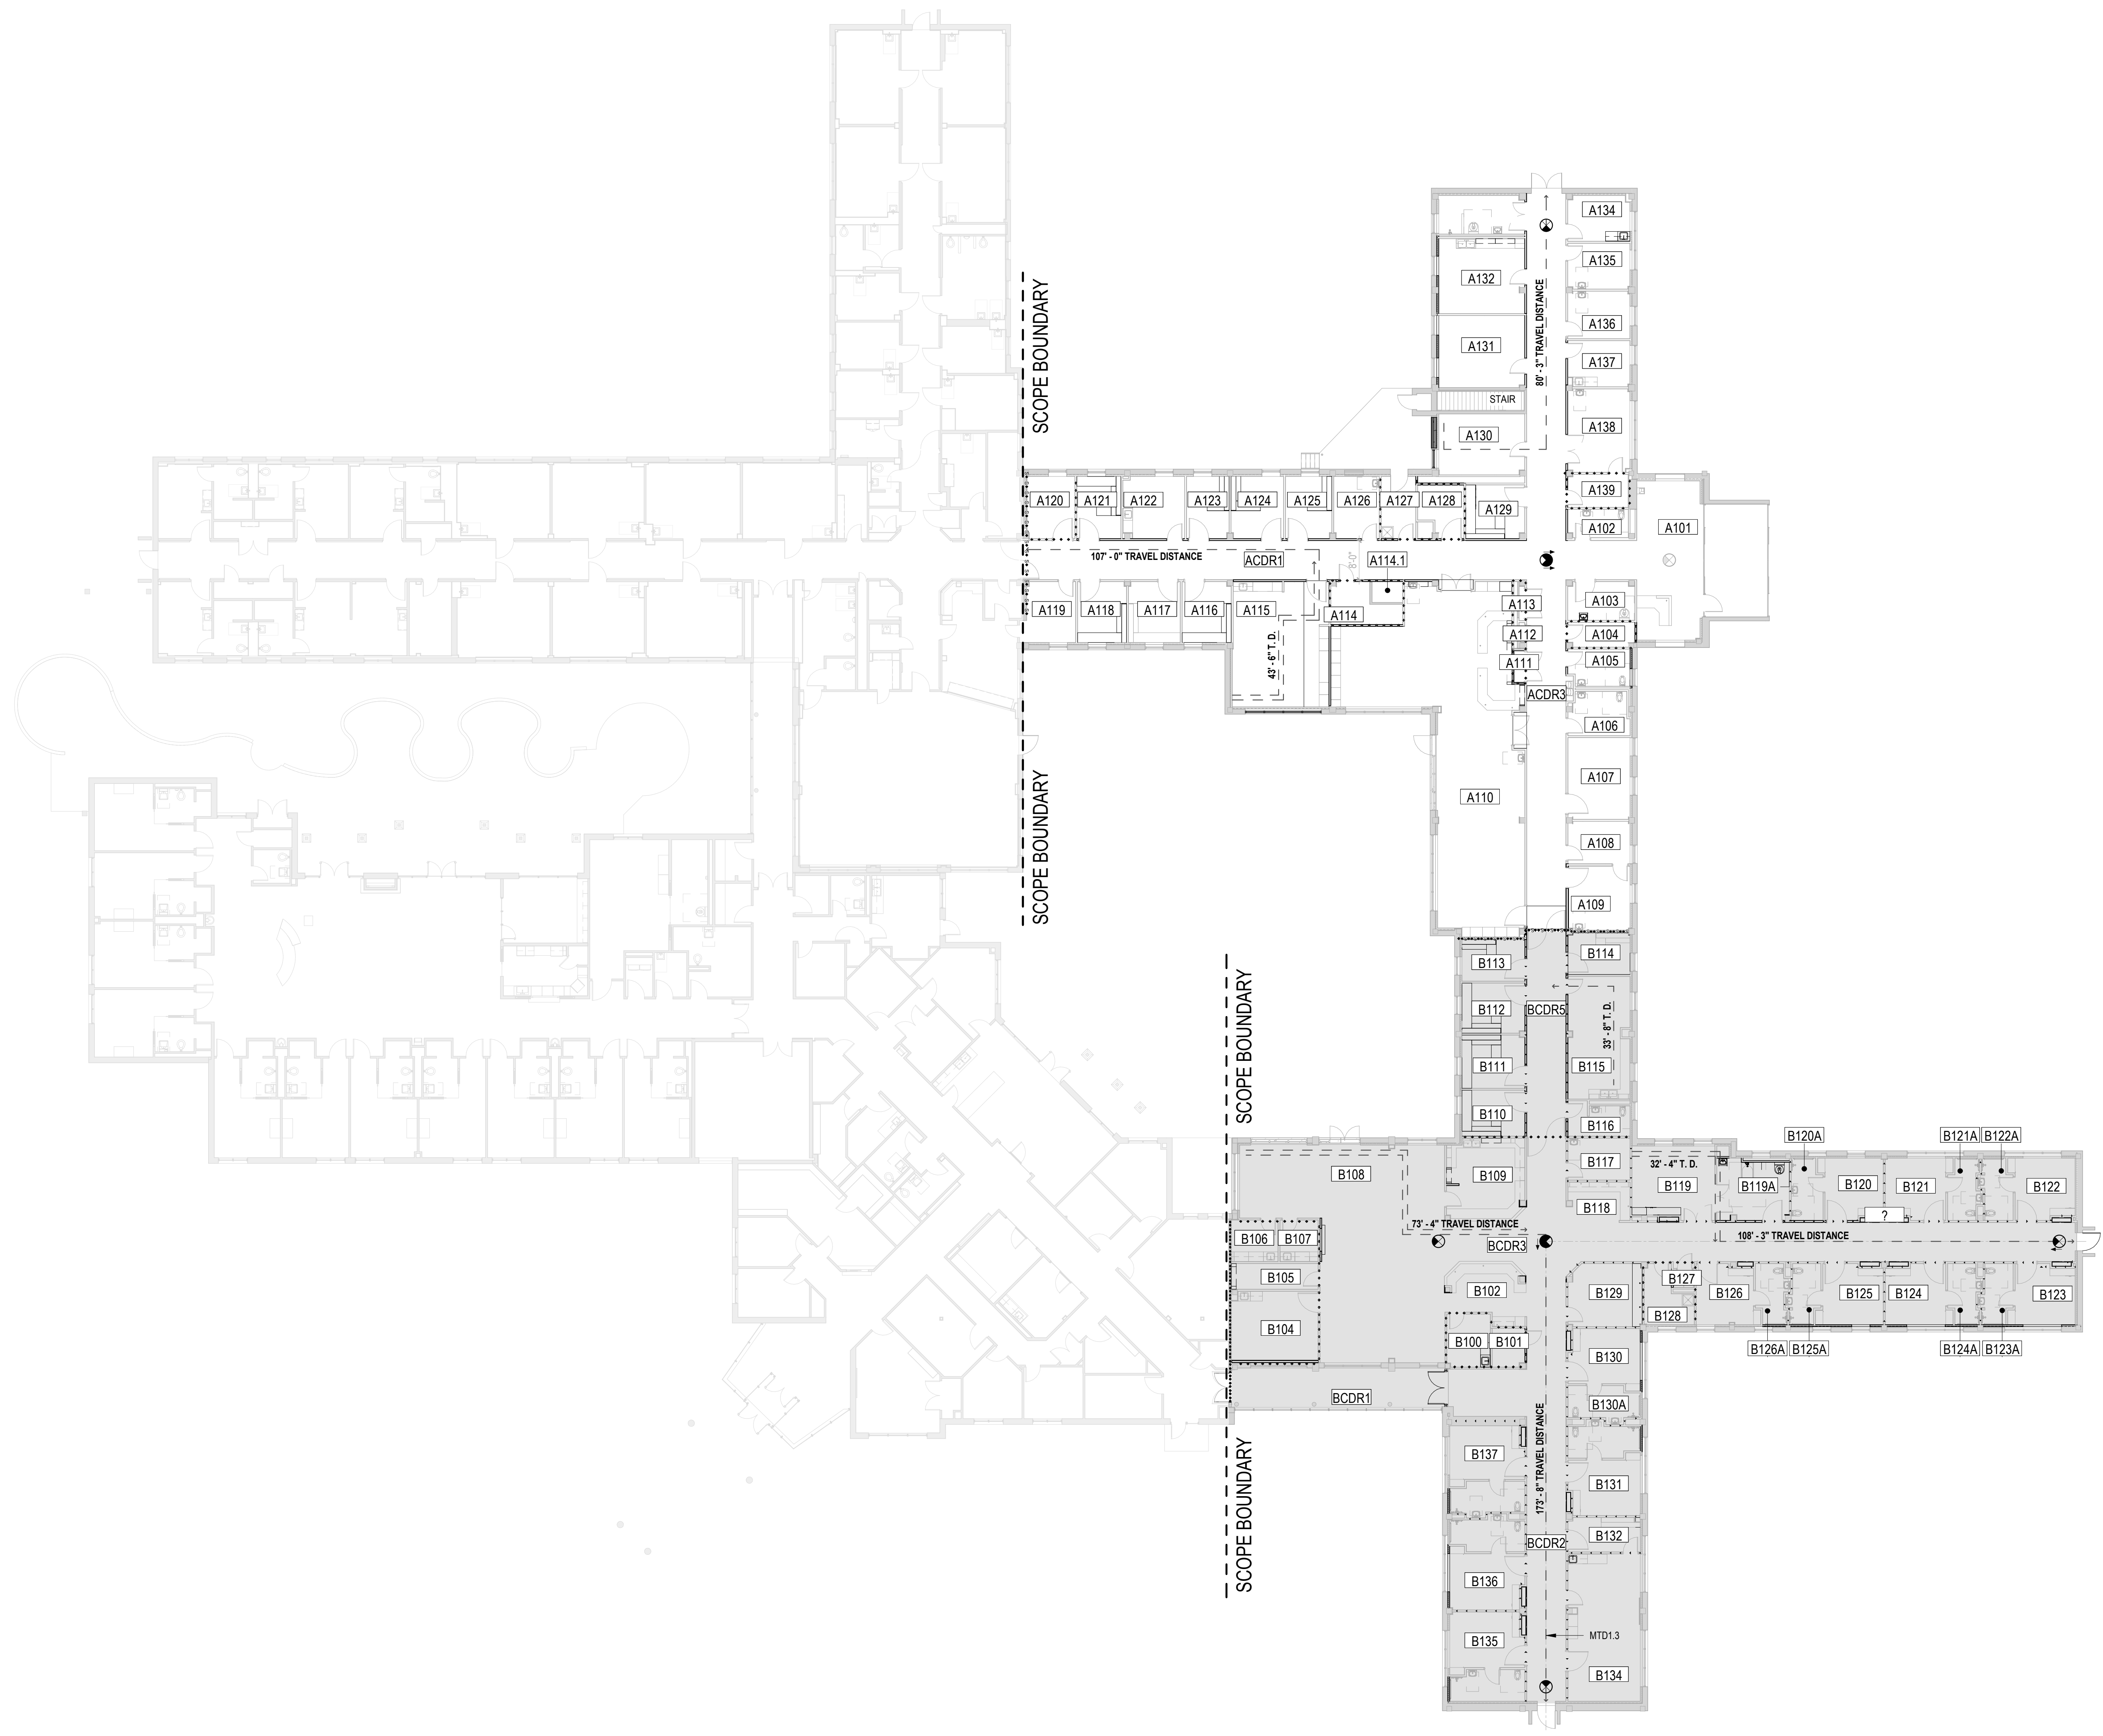

1 GENERAL - LIFE SAFETY FLOOR PLAN
1/16" = 1'-0"

CONSULTANT INFORMATION STRUCTURAL / CIVIL ENGINEER: STAND STRUCTURAL ENGINEERING, 11827 W. 112TH STREET, SUITE 200, OVERLAND PARK, KS 66210 (913) 214-2169 MECHANICAL / ELECTRICAL / PLUMBING / TECHNICAL ENGINEER: SPUR DESIGN, 11020 KING STREET, SUITE 350, OVERLAND PARK, KS 66210 (405) 842-6100 FIRE PROTECTION ENGINEER: POOLE FIRE PROTECTION, INC., 19910 W. 161ST STREET, OLATH, KS 66062 (913) 829-8650		ARCHITECT 512 5th Street, Overland Park, KS 66101 11020 King Street, Suite 300, Overland Park, KS 66101 KS ARCH REG. NO. A-1139, EXP. 12/31/2019 KS ENGR REG. NO. E-2586, EXP. 12/31/2019 		Office of Construction and Facilities Management VA U.S. Department of Veteran Affairs SHEET TITLE: LIFE SAFETY OCCUPANCY CLASSIFICATION FLOOR PLAN APPROVED: PROJECT DIRECTOR		PROJECT PHASE: BID DOCUMENTS FULLY SPRINKLERED		PROJECT TITLE: RENOVATE A & B WING BUILDING 6 PROJECT LOCATION: 2200 SW GAGE BLVD. TOPEKA, KS 66622 DATE: 07/10/2019 CHECKED BY: AWM DRAWN BY: ECO		VA PROJECT NUMBER: 589A5-19-116 BUILDING NUMBER: 6 DRAWING NUMBER: 6-GI-104 Dwg. 6 OF 160	
--	--	--	--	--	--	---	--	--	--	--	--

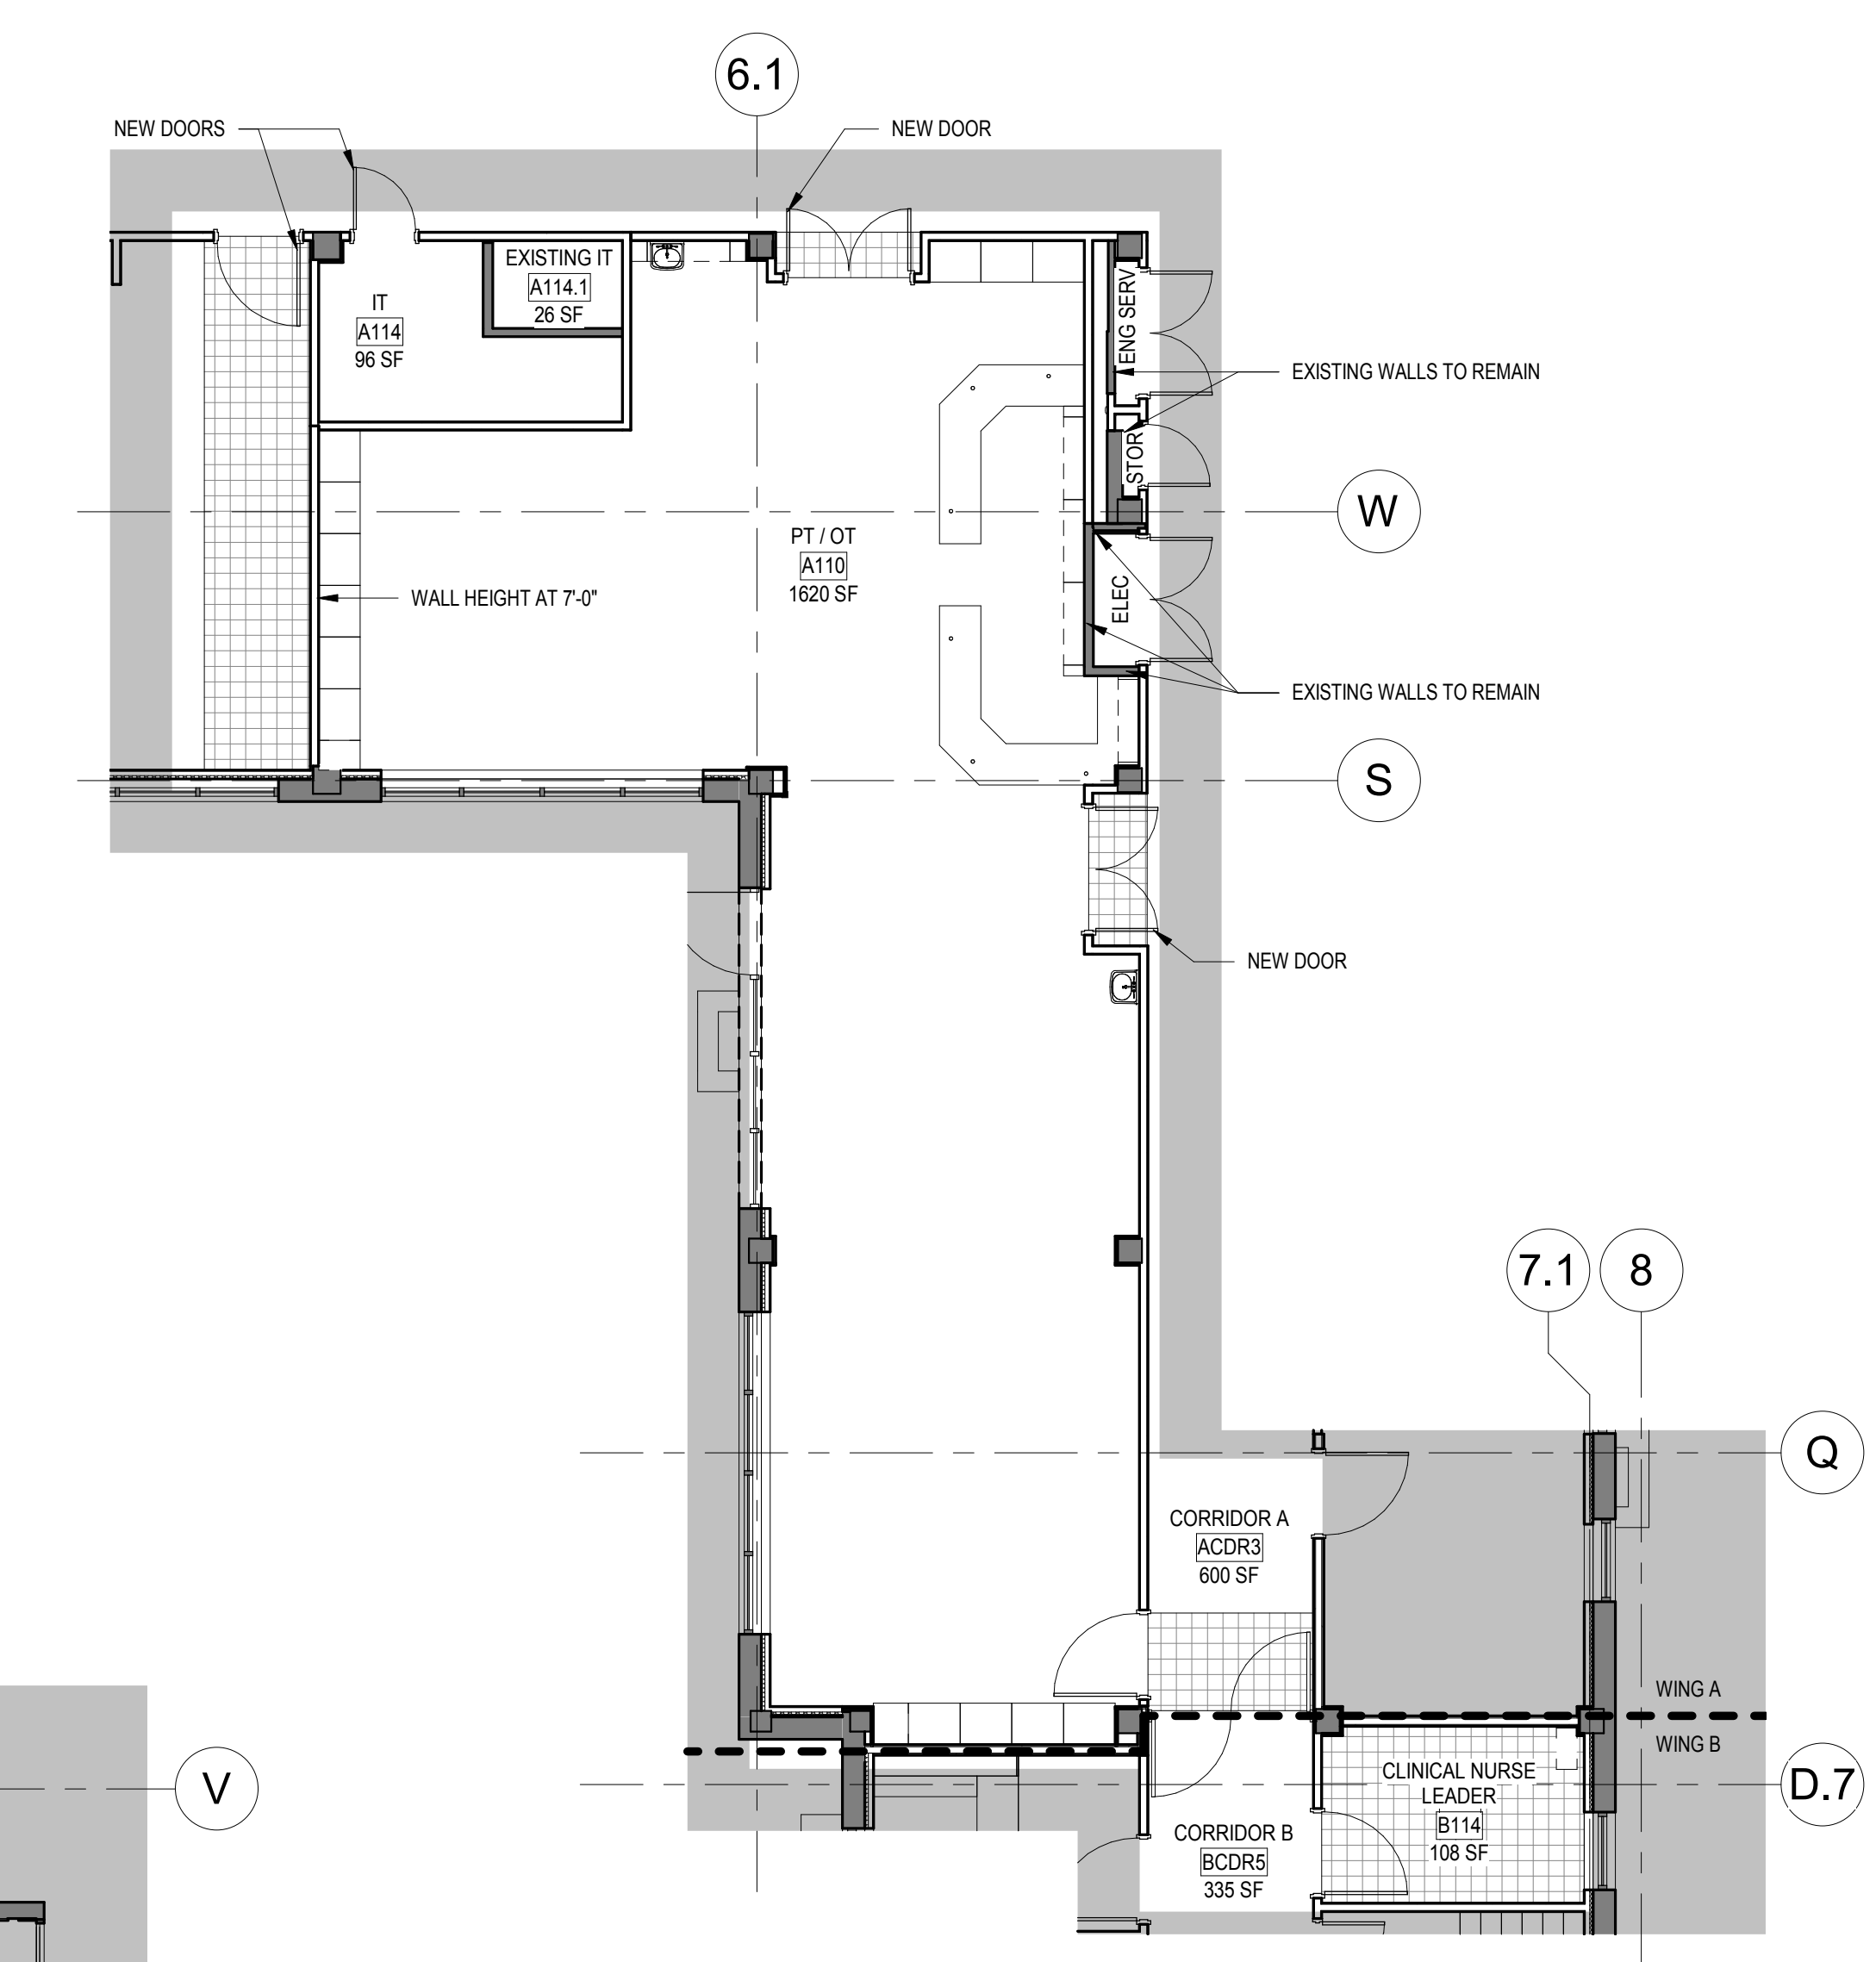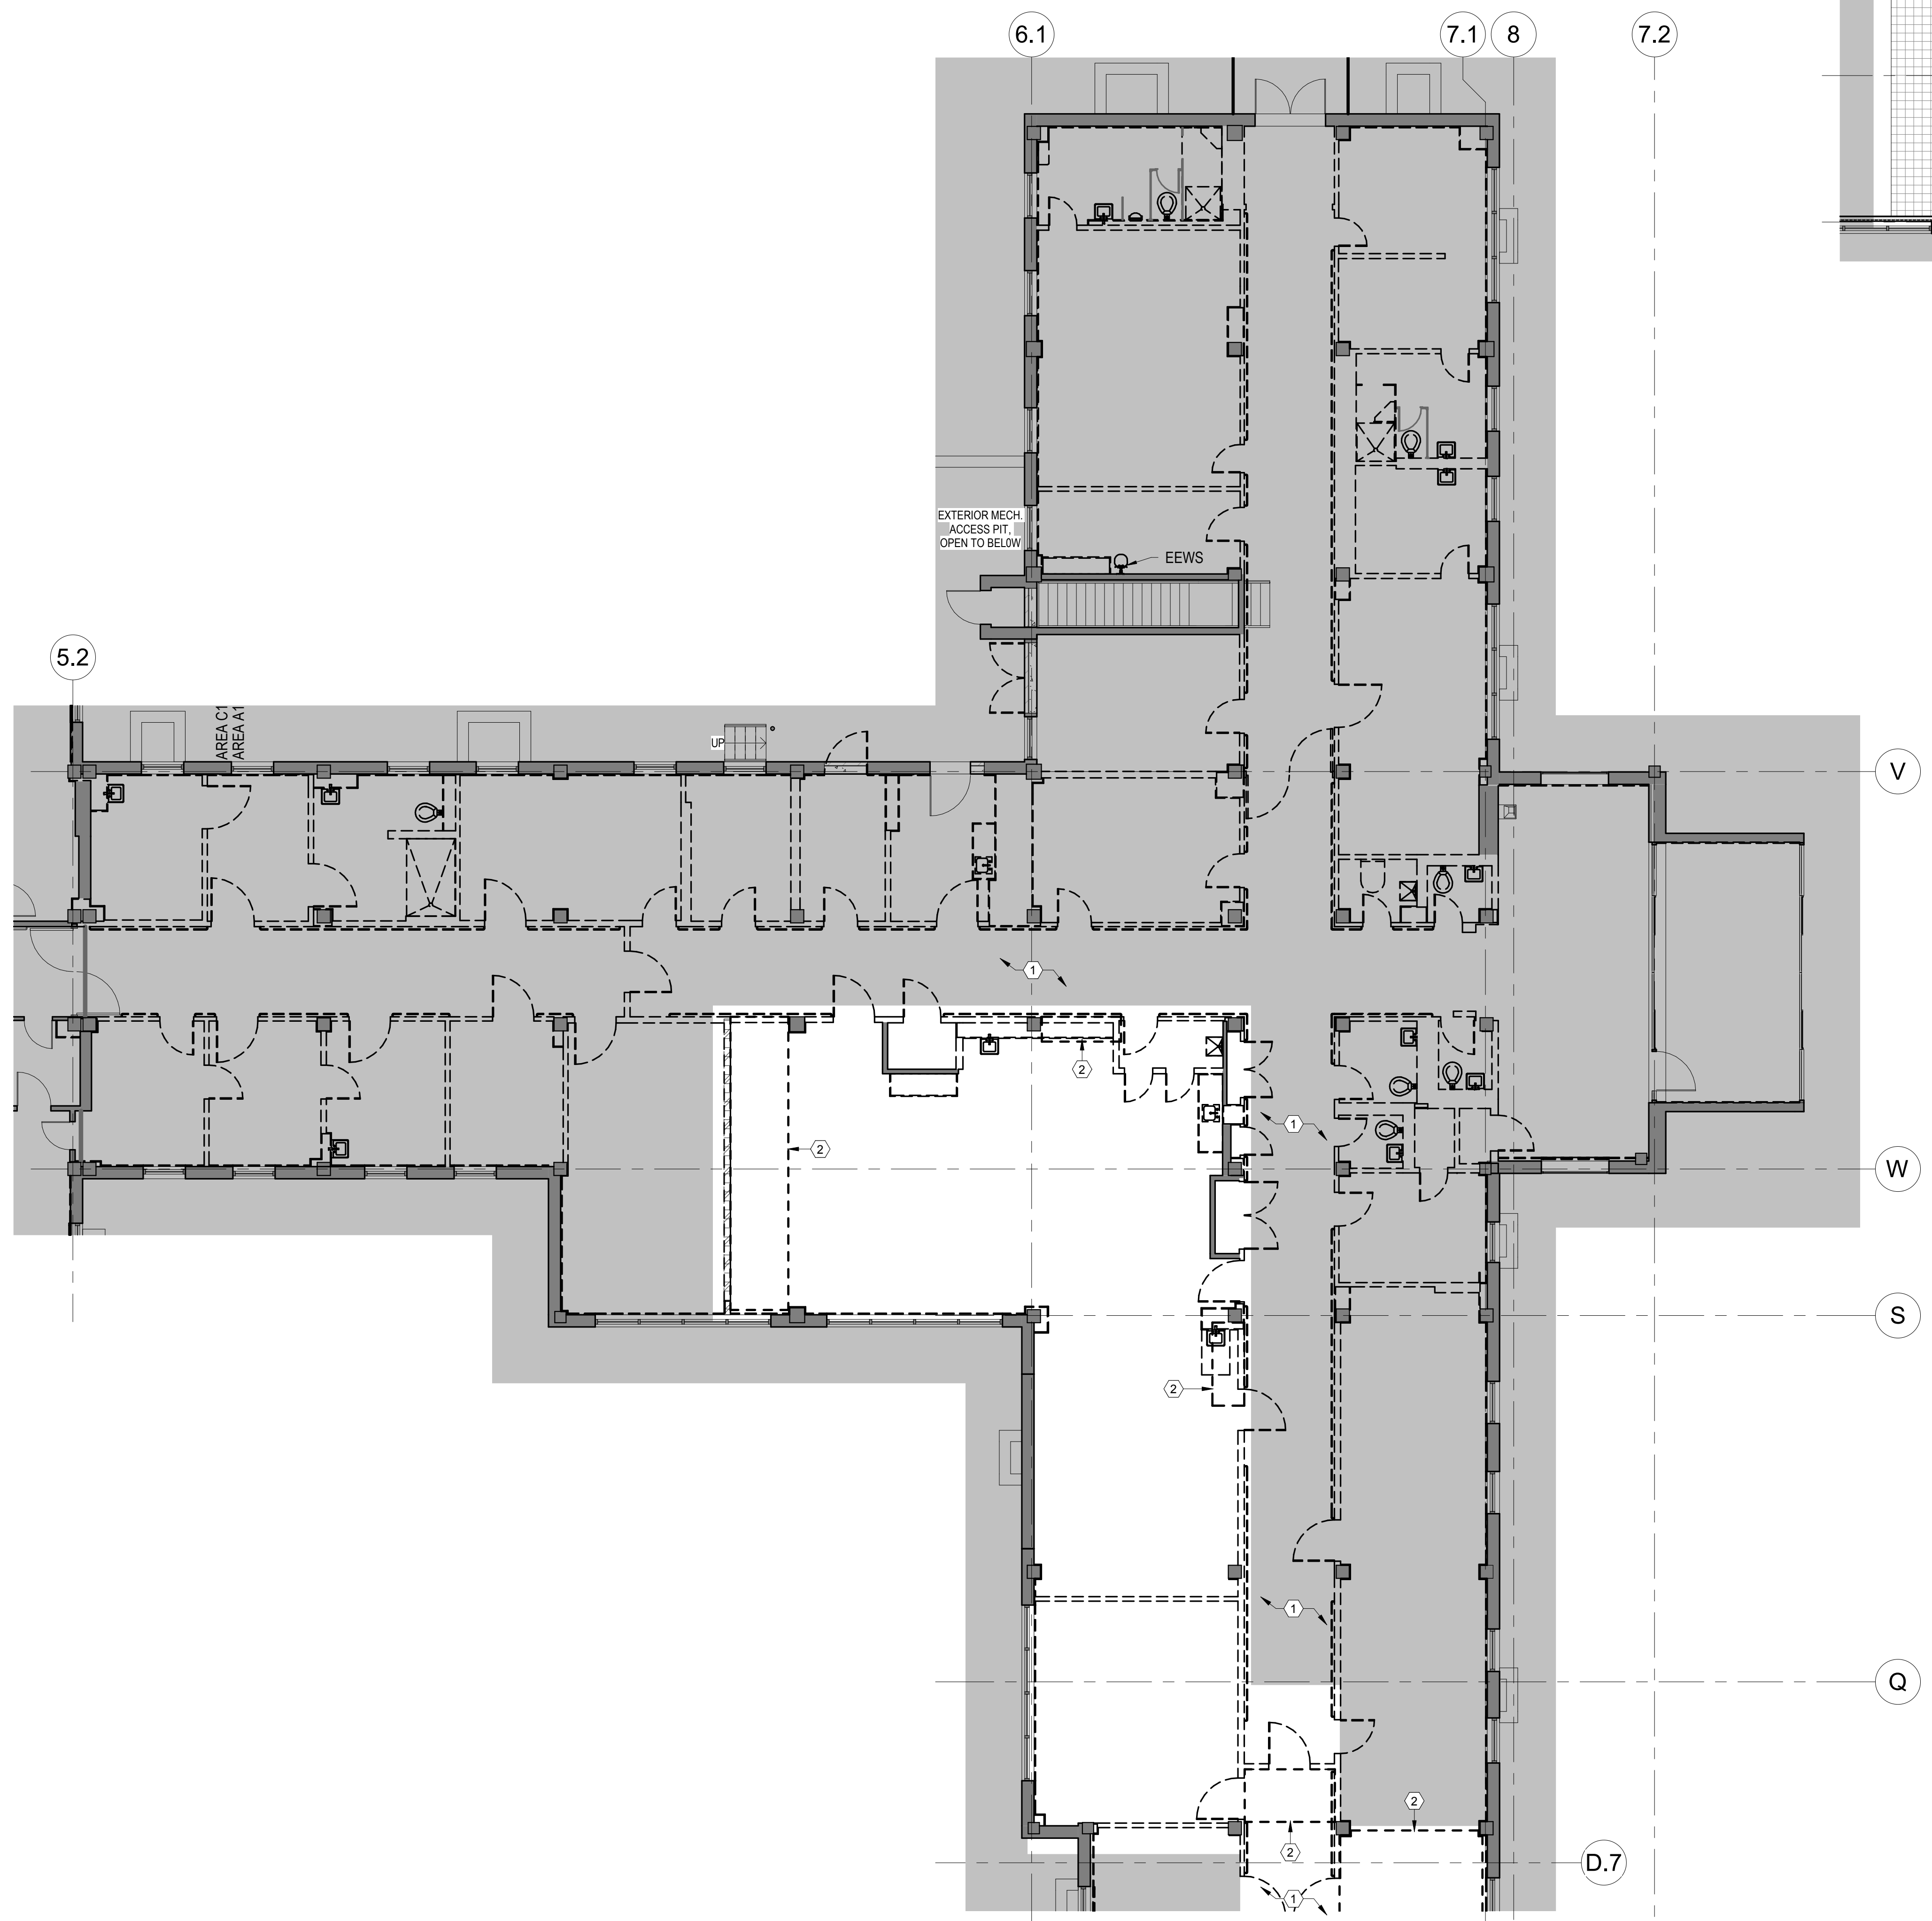


2 DEDUCT ALTERNATE - WING A - RENOVATION
1/8" = 1'-0"


GENERAL DEDUCT ALTERNATE NOTES
1. REFERENCE MECHANICAL, ELECTRICAL, AND PLUMBING DRAWINGS FOR DEDUCT COORDINATION BETWEEN DIVISIONS.

DEDUCT ALTERNATE DEMOLITION KEYNOTES
① PROTECT HALLWAY FLOORING AND CEILING DURING DEMOLITION
② REMOVE FLOORING

DEDUCT ALTERNATE LEGEND
VCT - TO MATCH EXISTING CORRIDOR FLOORING

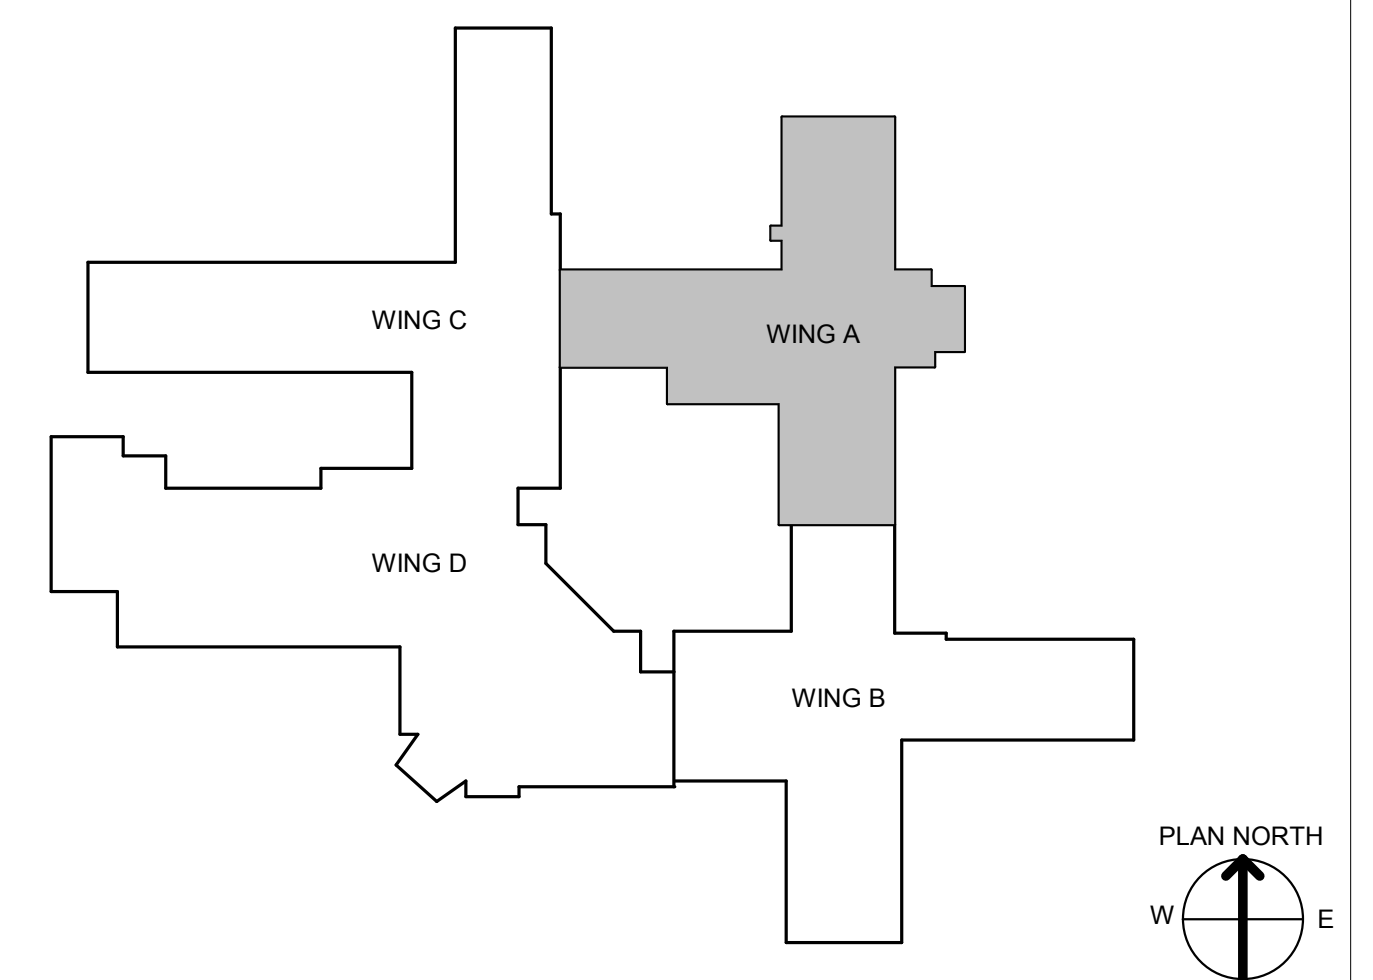

1 DEDUCT ALTERNATE - WING A - DEMOLITION
1/8" = 1'-0"


CONSULTANT INFORMATION STRUCTURAL / CIVIL ENGINEER STAND STRUCTURAL ENGINEERING 11627 W. 112TH STREET, SUITE 200 OVERLAND PARK, KS 66210 (913) 214-2169		MECHANICAL / ELECTRICAL / PLUMBING / TECHNICAL ENGINEER SPUR DESIGN 11020 KING STREET, SUITE 350 OVERLAND PARK, KS 66210 (405) 842-6100		FIRE PROTECTION ENGINEER POOLE FIRE PROTECTION, INC. 19910 W. 161ST STREET OLATH, KS 66062 (913) 829-8650		ARCHITECT  512 SW 23rd Street Overland Park, KS 66159 (913) 214-2169 KS ARCH REG. NO. A-1139, EXP. 12/31/2019 KS ENGR REG. NO. E-2586, EXP. 12/31/2019		Office of Construction and Facilities Management VA U.S. Department of Veteran Affairs		SHEET TITLE DEDUCT ALTERNATE PLAN APPROVED: PROJECT DIRECTOR		PROJECT PHASE BID DOCUMENTS FULLY SPRINKLERED		PROJECT TITLE RENOVATE A & B WING BUILDING 6 PROJECT LOCATION 2200 SW GAGE BLVD. TOPEKA, KS 66622		VA PROJECT NUMBER 589A5-19-116 BUILDING NUMBER 6 DRAWING NUMBER 6-GI-105 Dwg. 7 OF 160	
Revision # Date										DATE 07/10/2019		CHECKED BY AWM		DRAWN BY JET			

Keyed Notes - Abatement

- B1** PHASE 1 RENOVATION - NEGATIVE PRESSURE ENCLOSURE (NPE) BOUNDARY; ALL PENETRATIONS ARE TO BE SEALED OR OTHERWISE ISOLATED FROM NPE WITH 6 MIL LAYER OF FIRE RETARDANT (FR) POLY SHEETING AS A CRITICAL BARRIER. ACTIVE HVAC COMPONENTS MUST BE ISOLATED FROM NPE OR SHUT DOWN. NPE MUST BE MAINTAINED THROUGH CLEARANCE.
- B2** PHASE 2 RENOVATION - NEGATIVE PRESSURE ENCLOSURE (NPE) BOUNDARY; ALL PENETRATIONS ARE TO BE SEALED OR OTHERWISE ISOLATED FROM NPE WITH 6 MIL LAYER OF FIRE RETARDANT (FR) POLY SHEETING AS A CRITICAL BARRIER. ACTIVE HVAC COMPONENTS MUST BE ISOLATED FROM NPE OR SHUT DOWN. NPE MUST BE MAINTAINED THROUGH CLEARANCE.
- B3** HEPA FILTERED NEGATIVE AIR MACHINE (2000 CFM) TO MAINTAIN REGULATED AREA UNDER NEGATIVE PRESSURE DIFFERENTIAL OF 0.02 IN WG DURING REGULATED ACTIVITIES (VERIFY WITH ELECTRONIC RECORDING MANOMETER). EXHAUST AIR TO BE DISCHARGED OUTDOORS THROUGH PERIMETER ACCESS WELLS.
- B4** THREE STAGE WET DECONTAMINATION CHAMBER (W/SHOWER) TO BE CONSTRUCTED OF 6 MIL FR POLY AND USED FOR PERSONNEL DECONTAMINATION PURPOSES. NOTE THAT ACCESS TO CRAWL SPACE IS LIMITED TO AN ACCESS LADDER/HATCH.
- B5** TWO STAGE WASTE LOAD OUT CHAMBER TO BE CONSTRUCTED OF 6 MIL FR POLY AND USED FOR WASTE DECON PURPOSES. ACCOMMODATE SIZE OF WASTE CONTAINER COMPONENTS - CONSTRUCT ACCORDINGLY. NOTE THAT ACCESS TO CRAWL SPACE IS LIMITED TO AN ACCESS LADDER/HATCH.
- A1** ASBESTOS CONTAINING FLOOR TILE AND MASTIC - 1792 ft²
- A2** ASBESTOS CONTAINING FLOOR MASTIC ONLY - 855 ft²
- L1** LEAD GLAZED CERAMIC WALL TILE - 1715 ft²
- T1** TRANSITE PANEL - 40 units

General Notes - Abatement

1. ABATEMENT CONTRACTOR TO REMOVE KEY NOTED ASBESTOS AND LEAD BUILDING COMPONENTS WITHIN NEGATIVE PRESSURE ENCLOSURE (NPE). ALL REMOVED COMPONENTS TO BE DISPOSED BY ABATEMENT CONTRACTOR UNDER THIS SCOPE OF WORK.
2. ABATEMENT CONTRACTOR TO DEMO LEAD GLAZED WALL FINISHES DOWN TO SUBSTRATE WITHIN NPE IN ACCORDANCE WITH ARCHITECTURAL DEMOLITION CONSTRUCTION DOCUMENTS DRAWINGS. ALL REMOVED COMPONENTS TO BE DISPOSED BY ABATEMENT CONTRACTOR UNDER THIS SCOPE OF WORK.
3. ABATEMENT CONTRACTOR TO REMOVE EXISTING FLOORING DOWN TO SUBSTRATE WITHIN NPE IN ACCORDANCE WITH ARCHITECTURAL DEMOLITION CONSTRUCTION DOCUMENTS DRAWINGS. ALL REMOVED COMPONENTS TO BE DISPOSED BY ABATEMENT CONTRACTOR UNDER THIS SCOPE OF WORK.
4. ABATEMENT CONTRACTOR TO DEMO EXISTING HEAT CONVECTORS ALONG PERIMETER WALLS (AS NOTED) AND REMOVE EXISTING TRANSITE HEAT SHIELDS WITHIN NPE IN ACCORDANCE WITH ARCHITECTURAL DEMOLITION CONSTRUCTION DOCUMENTS DRAWINGS. ALL REMOVED COMPONENTS TO BE DISPOSED BY ABATEMENT CONTRACTOR UNDER THIS SCOPE OF WORK.
5. NPE SHALL BE CONSTRUCTED IN ACCORDANCE WITH TECHNICAL SPECIFICATIONS PROVIDED WITHIN CONSTRUCTION DOCUMENTS(02821319; 02821331; 02833313) INCLUDING: 6-MIL FIRE RETARDANT POLY SHEETING OVER CRITICAL BARRIERS; 3-STAGE WET DECONTAMINATION STATION; 2-STAGE WASTE LOAD OUT STATION; HEPA FILTERED NEGATIVE AIR MACHINES FOR NPE TO BE MAINTAINED AT -0.02 IN WG AND WITH MIN OF 4 AIR CHANGES PER HOUR; 18"x18" VIEWING WINDOW.
6. ALL ASBESTOS WASTES ARE TO BE LOADED OUT AND STORED WITHIN A LINED/LOCKED/LABELED WASTE DUMPSTER STORED ON SITE NO LATER THAN THE END OF EACH SHIFT.
7. ALL LEAD BEARING WASTES SHALL BE STORED AT A SECURE ON SITE LOCATION WITHIN LINED/LOCKED/LABELED/DATED DRUMS/CONTAINERS UNTIL HAZARDOUS WASTE STREAM CHARACTERIZATION PROCESS IS COMPLETE, WITH FINAL WASTE DISPOSAL UPON FINAL DETERMINATION IAW FEDERAL LAWS.

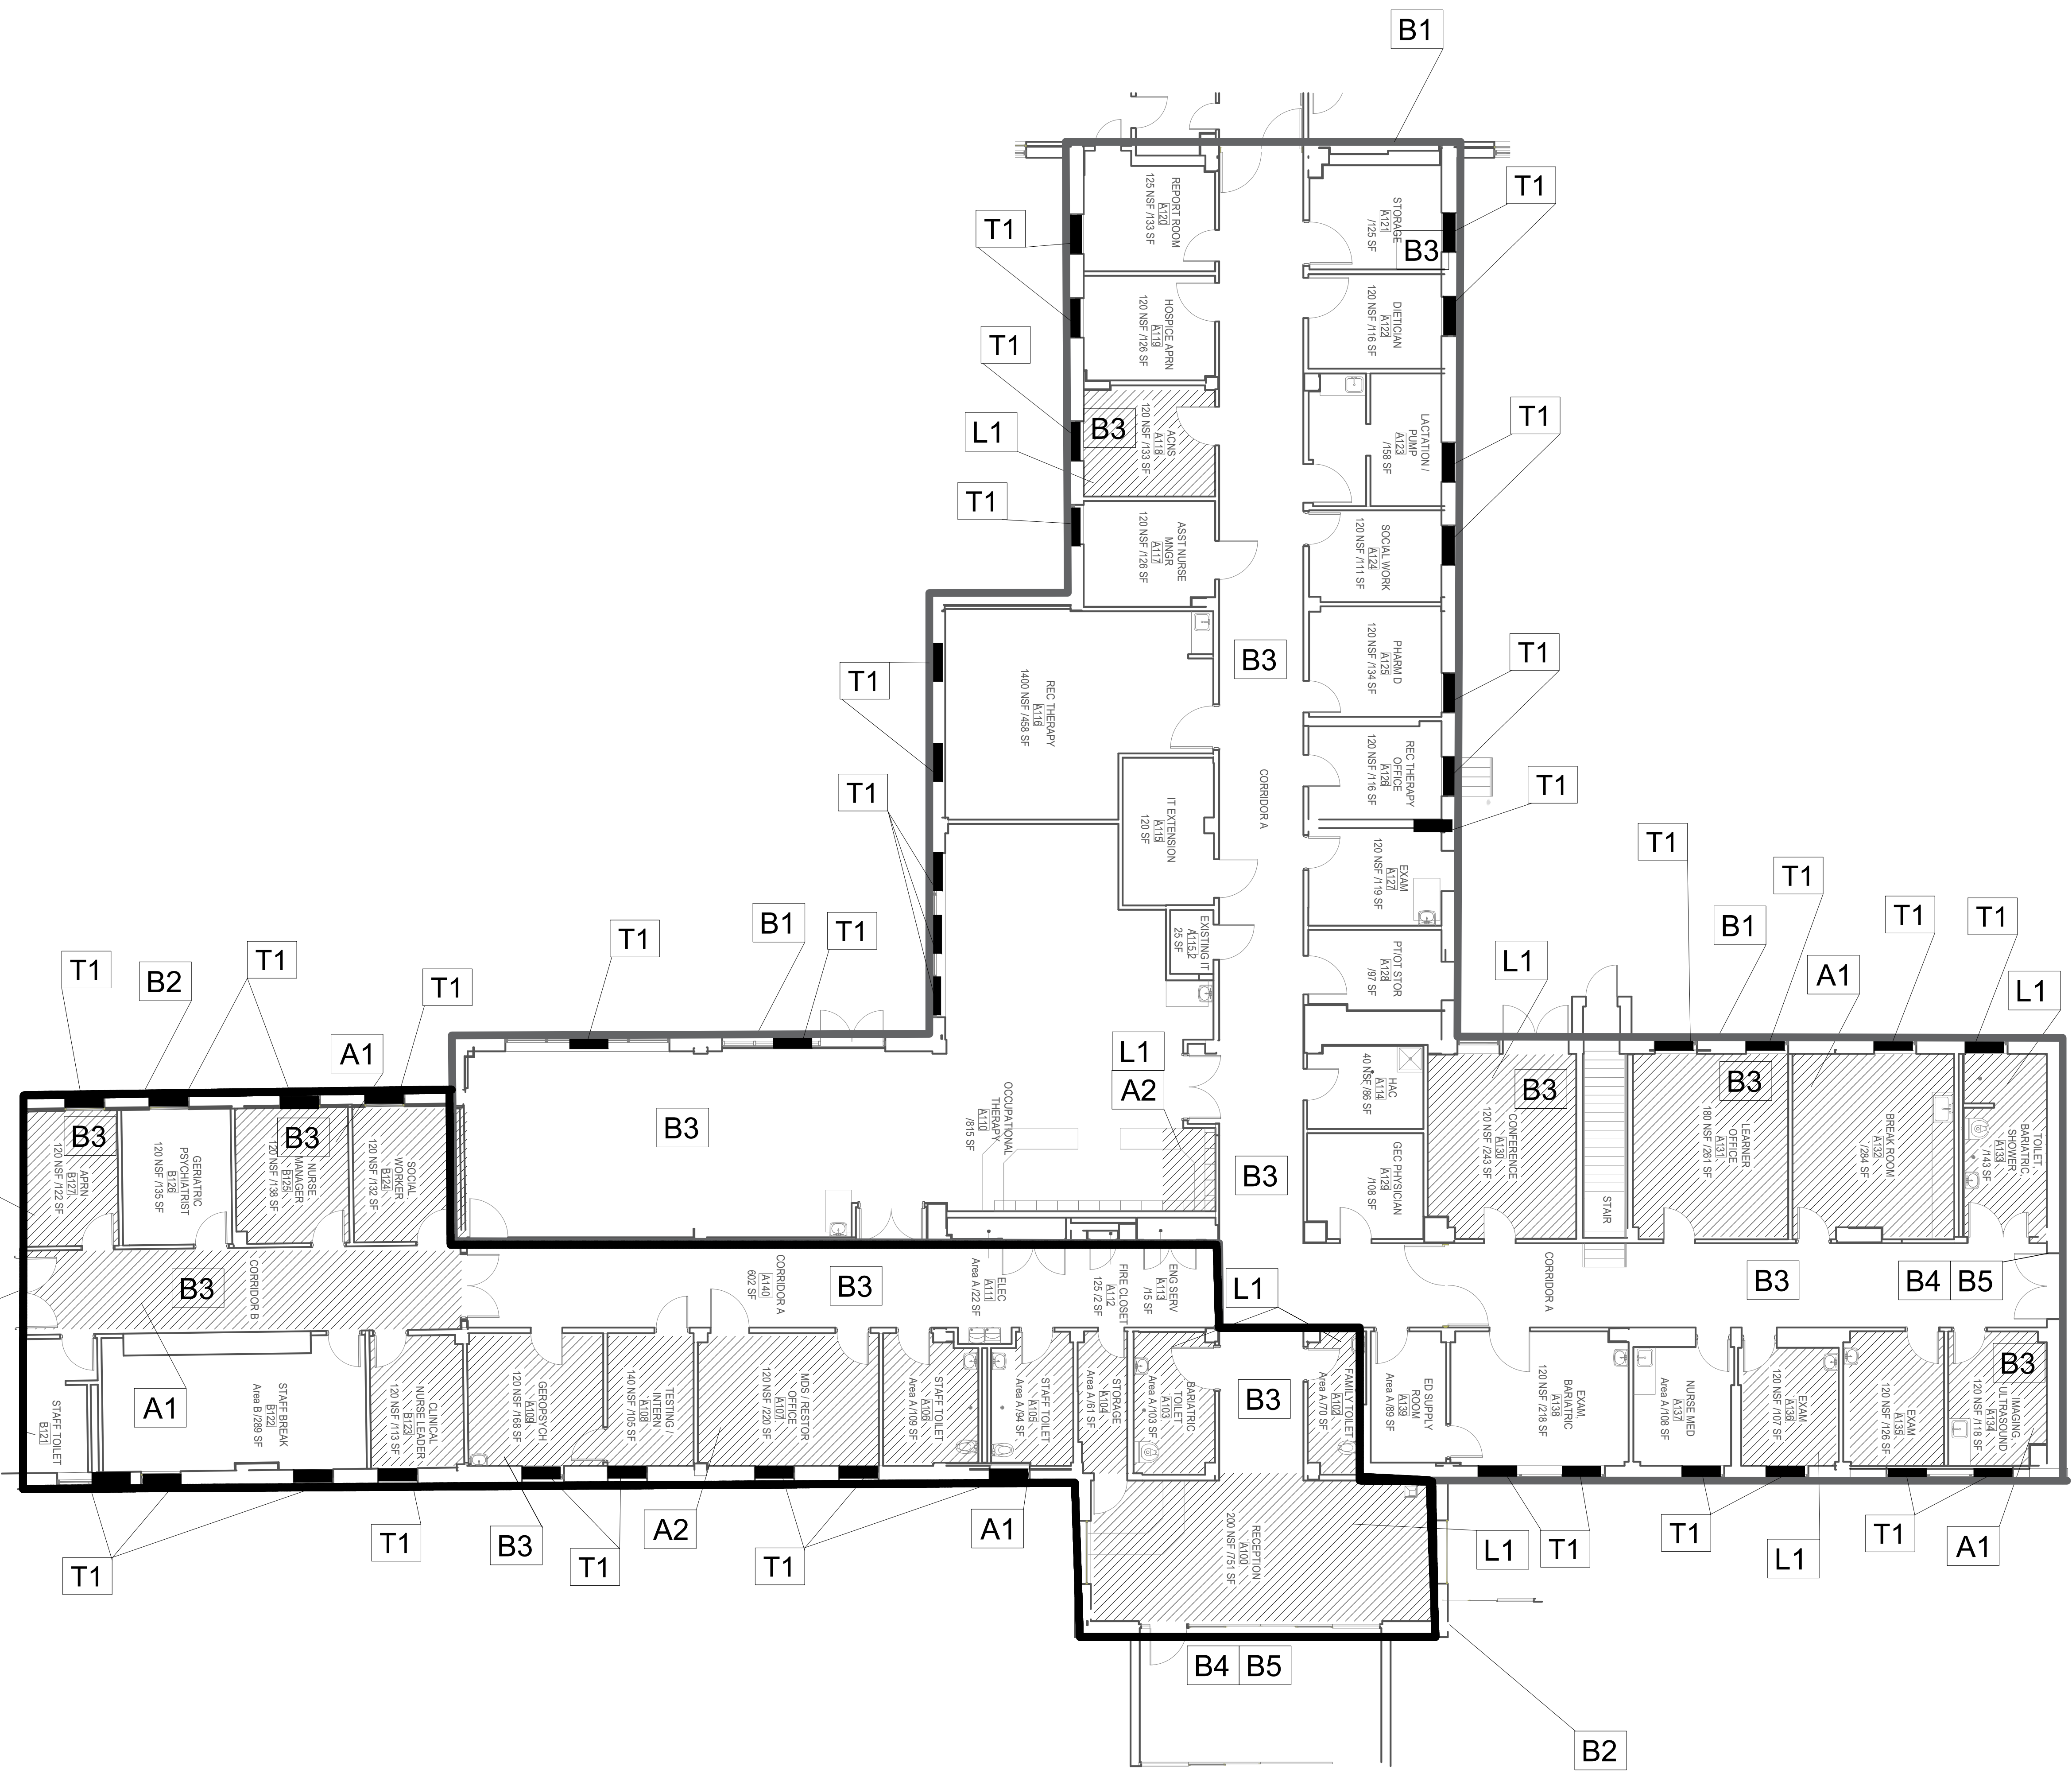

ENVIRONMENTAL REMEDIATION FLOOR PLAN - WING A
1/8" = 1'-0"

CONSULTANT INFORMATION

STRUCTURAL / CIVIL ENGINEER STAND STRUCTURAL ENGINEERING 11822 W. 112TH STREET, SUITE 200 OVERLAND PARK, KS 66210 (913) 214-2169	MECHANICAL / ELECTRICAL / PLUMBING / TECHNICAL ENGINEER SPUR DESIGN 11020 KING STREET, SUITE 350 OVERLAND PARK, KS 66210 (405) 842-6100	FIRE PROTECTION ENGINEER POOLE FIRE PROTECTION, INC. 19917 W. 101ST STREET OLATH, KS 66062 (913) 823-8550	ENVIRONMENTAL CONSULTANT RIVERFRONT SAFETY AND HEALTH 1120 OLIVE ST. SUITE 300 ST. LOUIS, MO 63101 (314) 436-9492
--	---	---	---

SPUR DESIGN
311 SW 25th Street
Overland Park, KS 66209
www.spurdesign.com

10200 King Street, Suite 300
Overland Park, KS 66209
www.spurdesign.com

KS ARCH REG. NO. A-1139, EXP. 12/31/2019
KS ENGR REG. NO. E-2586, EXP. 12/31/2019

Office of Construction and Facilities Management



SHEET TITLE
BASE BID WING A ENVIRONMENTAL REMEDIATION

APPROVED: PROJECT DIRECTOR

PROJECT PHASE
BID DOCUMENTS

FULLY SPRINKLERED

PROJECT TITLE
RENOVATE A & B WING BLDG 6

PROJECT LOCATION
2200 SW GAGE BLVD.
TOPEKA, KS 66622

DATE
7/10/2019

CHECKED BY
J.Rhyneer

DRAWN BY
C.Dey

VA PROJECT NUMBER
589A5-19-116

BUILDING NUMBER
6
DRAWING NUMBER
6-HA-1


Dwg. 8 OF 160

Keyed Notes - Abatement

- P1** PRE-PHASE 1 - NEGATIVE PRESSURE ENCLOSURE (NPE) BOUNDARY; ALL PENETRATIONS ARE TO BE SEALED OR OTHERWISE ISOLATED FROM NPE WITH 6 MIL LAYER OF FIRE RETARDANT (FR) POLY SHEETING AS A CRITICAL BARRIER. ACTIVE HVAC COMPONENTS MUST BE ISOLATED FROM NPE OR SHUT DOWN. NPE MUST BE MAINTAINED THROUGH CLEARANCE.
- B2** PHASE 2 RENOVATION - NEGATIVE PRESSURE ENCLOSURE (NPE) BOUNDARY; ALL PENETRATIONS ARE TO BE SEALED OR OTHERWISE ISOLATED FROM NPE WITH 6 MIL LAYER OF FIRE RETARDANT (FR) POLY SHEETING AS A CRITICAL BARRIER. ACTIVE HVAC COMPONENTS MUST BE ISOLATED FROM NPE OR SHUT DOWN. NPE MUST BE MAINTAINED THROUGH CLEARANCE.
- B3** HEPA FILTERED NEGATIVE AIR MACHINE (2000 CFM) TO MAINTAIN REGULATED AREA UNDER NEGATIVE PRESSURE DIFFERENTIAL OF 0.02 IN WG DURING REGULATED ACTIVITIES (VERIFY WITH ELECTRONIC RECORDING MANOMETER). EXHAUST AIR TO BE DISCHARGED OUTDOORS THROUGH PERIMETER ACCESS WELLS.
- B4** THREE STAGE WET DECONTAMINATION CHAMBER (W/SHOWER) TO BE CONSTRUCTED OF 6 MIL FR POLY AND USED FOR PERSONNEL DECONTAMINATION PURPOSES. NOTE THAT ACCESS TO CRAWL SPACE IS LIMITED TO AN ACCESS LADDER/HATCH.
- B5** TWO STAGE WASTE LOAD OUT CHAMBER TO BE CONSTRUCTED OF 6 MIL FR POLY AND USED FOR WASTE DECON PURPOSES. ACCOMMODATE SIZE OF WASTE CONTAINER COMPONENTS - CONSTRUCT ACCORDINGLY. NOTE THAT ACCESS TO CRAWL SPACE IS LIMITED TO AN ACCESS LADDER/HATCH.
- A1** ASBESTOS CONTAINING FLOOR TILE AND MASTIC - 3741 ft²
- T1** TRANSITE PANEL - 52 units

General Notes - Abatement

1. ABATEMENT CONTRACTOR TO REMOVE KEY NOTED ASBESTOS AND LEAD BUILDING COMPONENTS WITHIN NEGATIVE PRESSURE ENCLOSURE (NPE). ALL REMOVED COMPONENTS TO BE DISPOSED BY ABATEMENT CONTRACTOR UNDER THIS SCOPE OF WORK.
2. ABATEMENT CONTRACTOR TO DEMO LEAD GLAZED WALL FINISHES DOWN TO SUBSTRATE WITHIN NPE IN ACCORDANCE WITH ARCHITECTURAL DEMOLITION CONSTRUCTION DOCUMENTS DRAWINGS. ALL REMOVED COMPONENTS TO BE DISPOSED BY ABATEMENT CONTRACTOR UNDER THIS SCOPE OF WORK.
3. ABATEMENT CONTRACTOR TO REMOVE EXISTING FLOORING DOWN TO SUBSTRATE WITHIN NPE IN ACCORDANCE WITH ARCHITECTURAL DEMOLITION CONSTRUCTION DOCUMENTS DRAWINGS. ALL REMOVED COMPONENTS TO BE DISPOSED BY ABATEMENT CONTRACTOR UNDER THIS SCOPE OF WORK.
4. ABATEMENT CONTRACTOR TO DEMO EXISTING HEAT CONVECTORS ALONG PERIMETER WALLS (AS NOTED) AND REMOVE EXISTING TRANSITE HEAT SHIELDS WITHIN NPE IN ACCORDANCE WITH ARCHITECTURAL DEMOLITION CONSTRUCTION DOCUMENTS DRAWINGS. ALL REMOVED COMPONENTS TO BE DISPOSED BY ABATEMENT CONTRACTOR UNDER THIS SCOPE OF WORK.
5. NPE SHALL BE CONSTRUCTED IN ACCORDANCE WITH TECHNICAL SPECIFICATIONS PROVIDED WITHIN CONSTRUCTION DOCUMENTS(02821319; 02821331; 02833313) INCLUDING: 6-MIL FIRE RETARDANT POLY SHEETING OVER CRITICAL BARRIERS; 3-STAGE WET DECONTAMINATION STATION; 2-STAGE WASTE LOAD OUT STATION; HEPA FILTERED NEGATIVE AIR MACHINES FOR NPE TO BE MAINTAINED AT -0.02 IN WG AND WITH MIN OF 4 AIR CHANGES PER HOUR; 18"x18" VIEWING WINDOW.
6. ALL ASBESTOS WASTES ARE TO BE LOADED OUT AND STORED WITHIN A LINED/LOCKED/LABELED WASTE DUMPSTER STORED ON SITE NO LATER THAN THE END OF EACH SHIFT.
7. ALL LEAD BEARING WASTES SHALL BE STORED AT A SECURE ON SITE LOCATION WITHIN LINED/LOCKED/LABELED/DATED DRUMS/CONTAINERS UNTIL HAZARDOUS WASTE STREAM CHARACTERIZATION PROCESS IS COMPLETE, WITH FINAL WASTE DISPOSAL UPON FINAL DETERMINATION IAW FEDERAL LAWS.

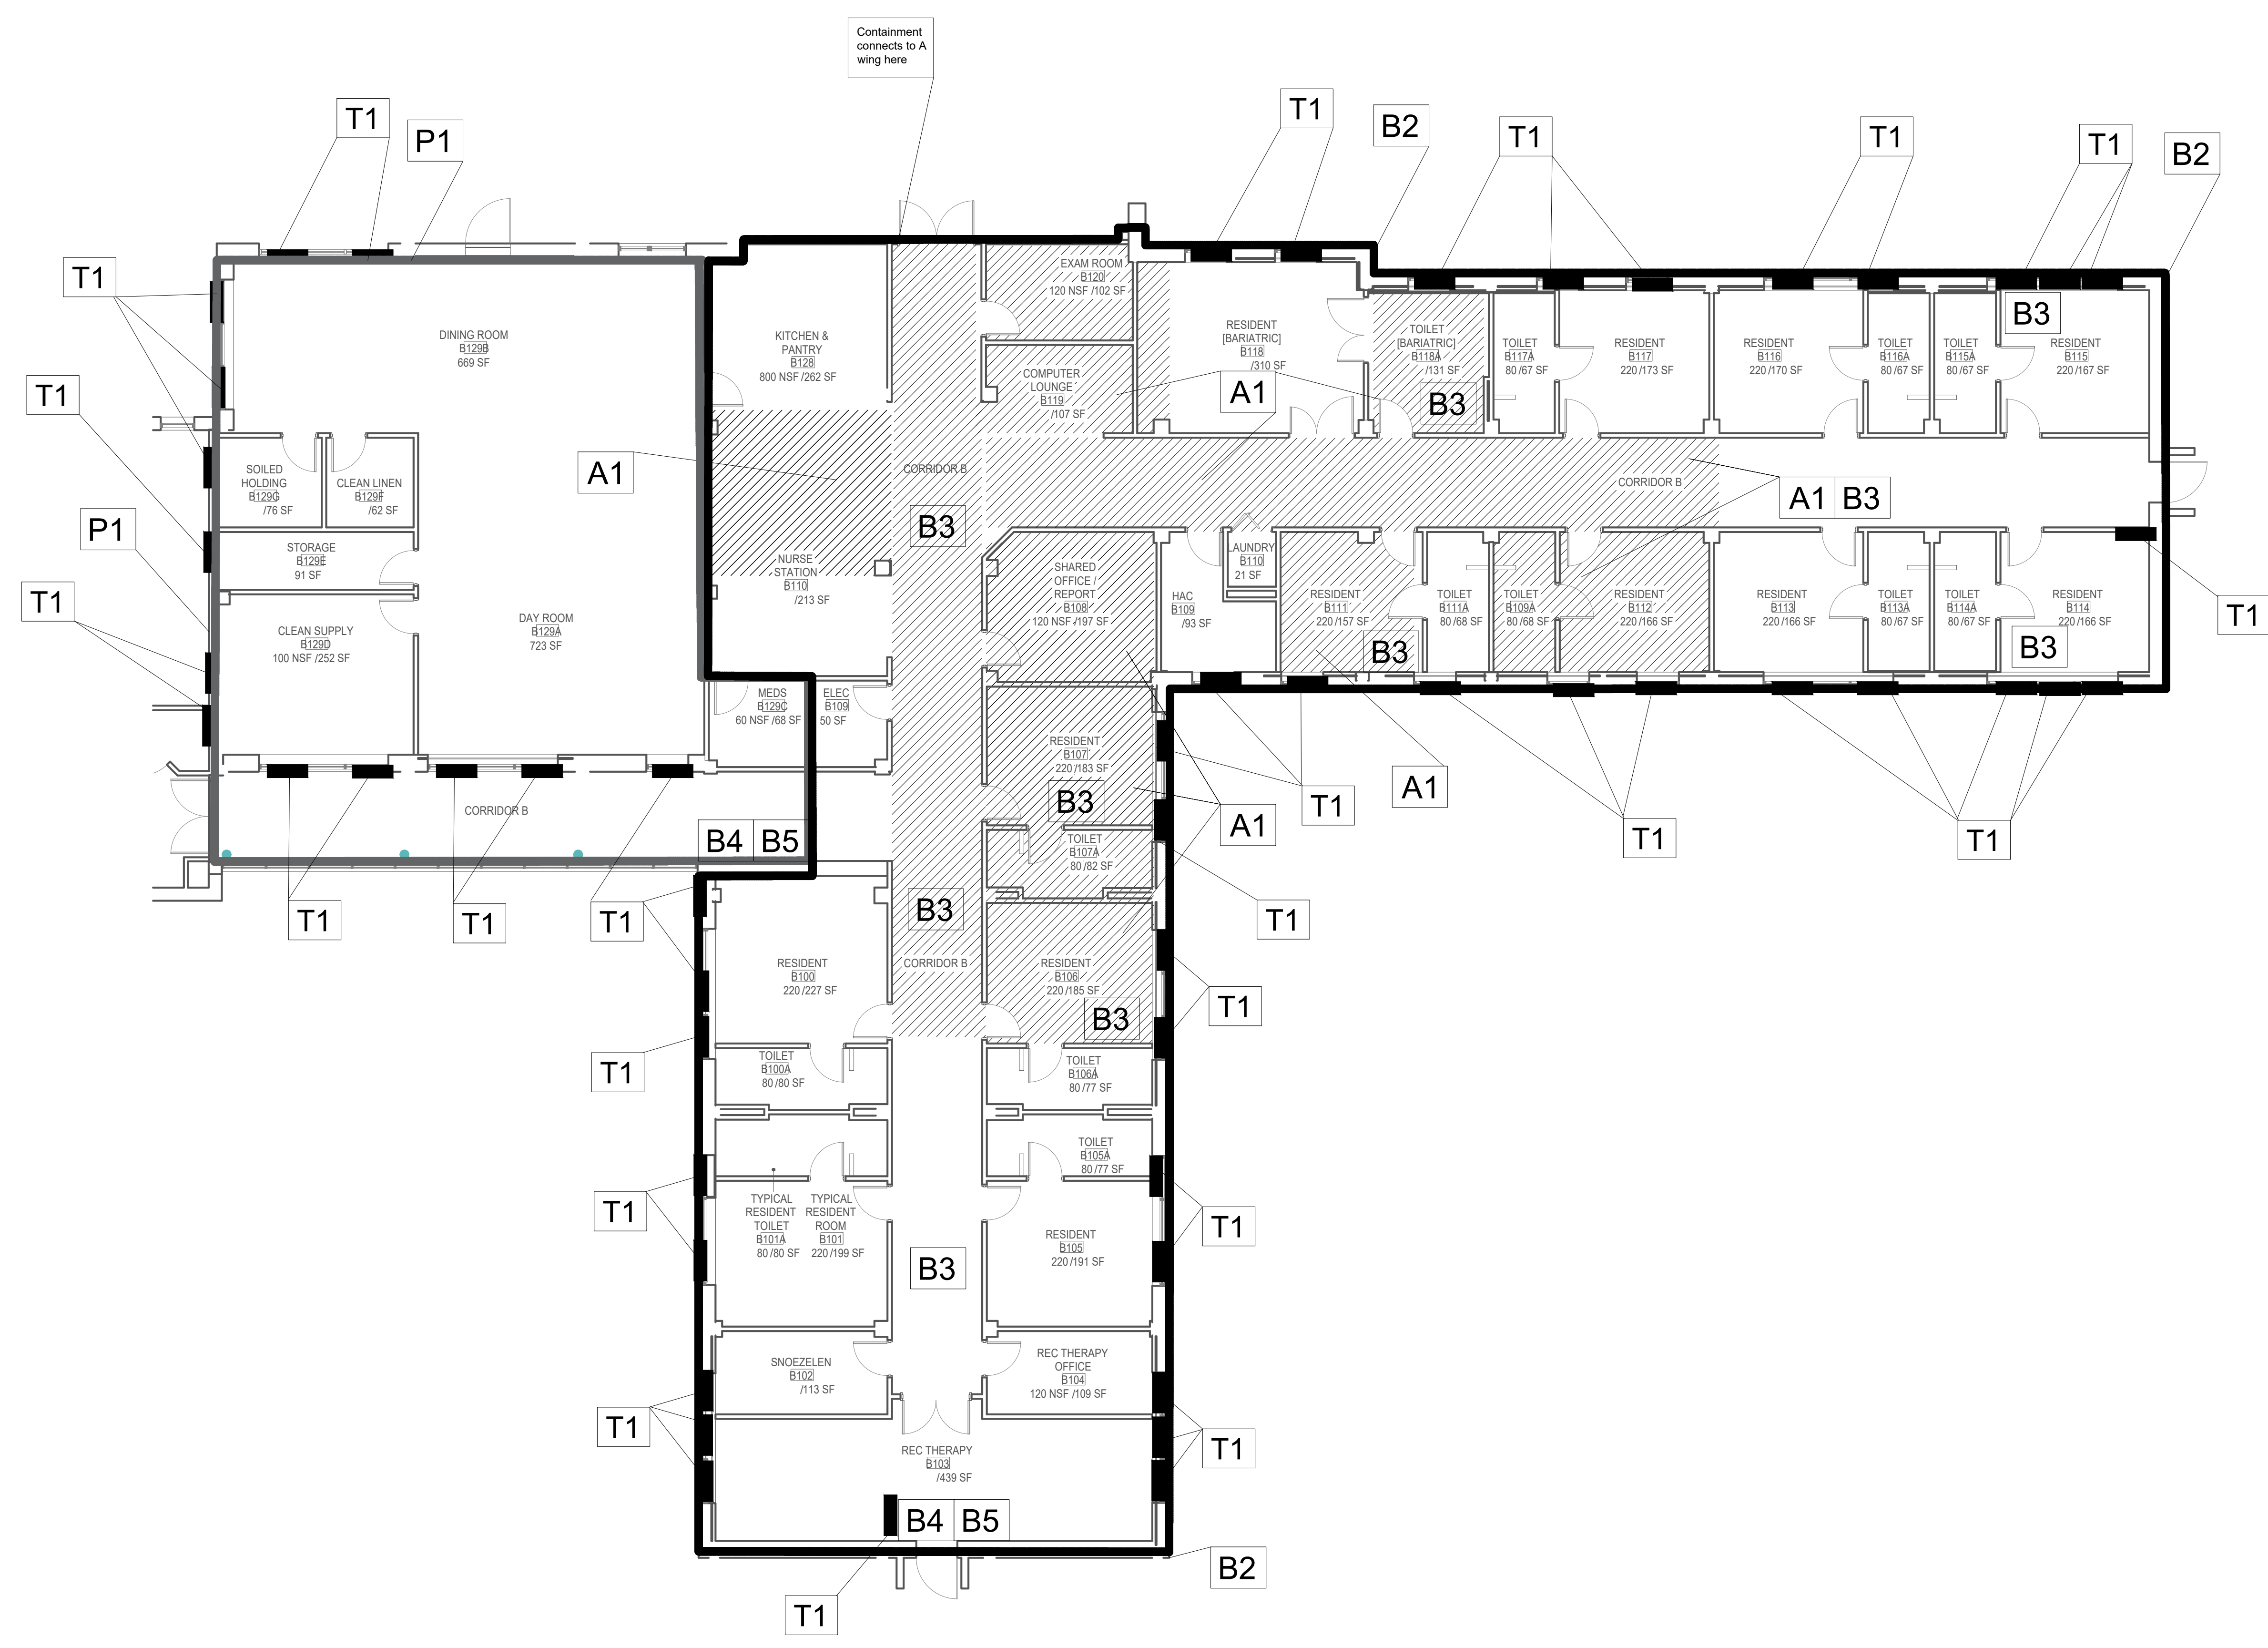

ENVIRONMENTAL REMEDIATION FLOOR PLAN - WING B
1/8" = 1'-0"

CONSULTANT INFORMATION

STRUCTURAL / CIVIL ENGINEER
STAND STRUCTURAL ENGINEERING
11827 W. 112TH STREET, SUITE 200
OVERLAND PARK, KS 66210
(913) 214-2169

MECHANICAL / ELECTRICAL / PLUMBING / TECHNICAL ENGINEER
SPUR DESIGN
11020 KING STREET, SUITE 350
OVERLAND PARK, KS 66210
(405) 942-6100

FIRE PROTECTION ENGINEER
POOLE FIRE PROTECTION, INC.
19910 W. 161ST STREET
OLATH, KS 66062
(913) 829-8650

ENVIRONMENTAL CONSULTANT
RIVERFRONT SAFETY AND HEALTH
1139 OLIVE ST., SUITE 300
ST. LOUIS, MO. 63101
(314) 436-9492



Office of Construction and Facilities Management
VA U.S. Department of Veteran Affairs

SHEET TITLE
BASE BID WING B ENVIRONMENTAL REMEDIATION

APPROVED: PROJECT DIRECTOR

PROJECT PHASE
BID DOCUMENTS

FULLY SPRINKLERED

PROJECT TITLE
RENOVATE A & B WING BLDG 6

PROJECT LOCATION
**2200 SW GAGE BLVD.
TOPEKA, KS 66622**

DATE
7/10/2019

CHECKED BY
J.Rhyneer


DRAWN BY
C.Dey

VA PROJECT NUMBER
589A5-19-116

BUILDING NUMBER
6

DRAWING NUMBER
6-HA-2

Dwg: **9 OF 160**

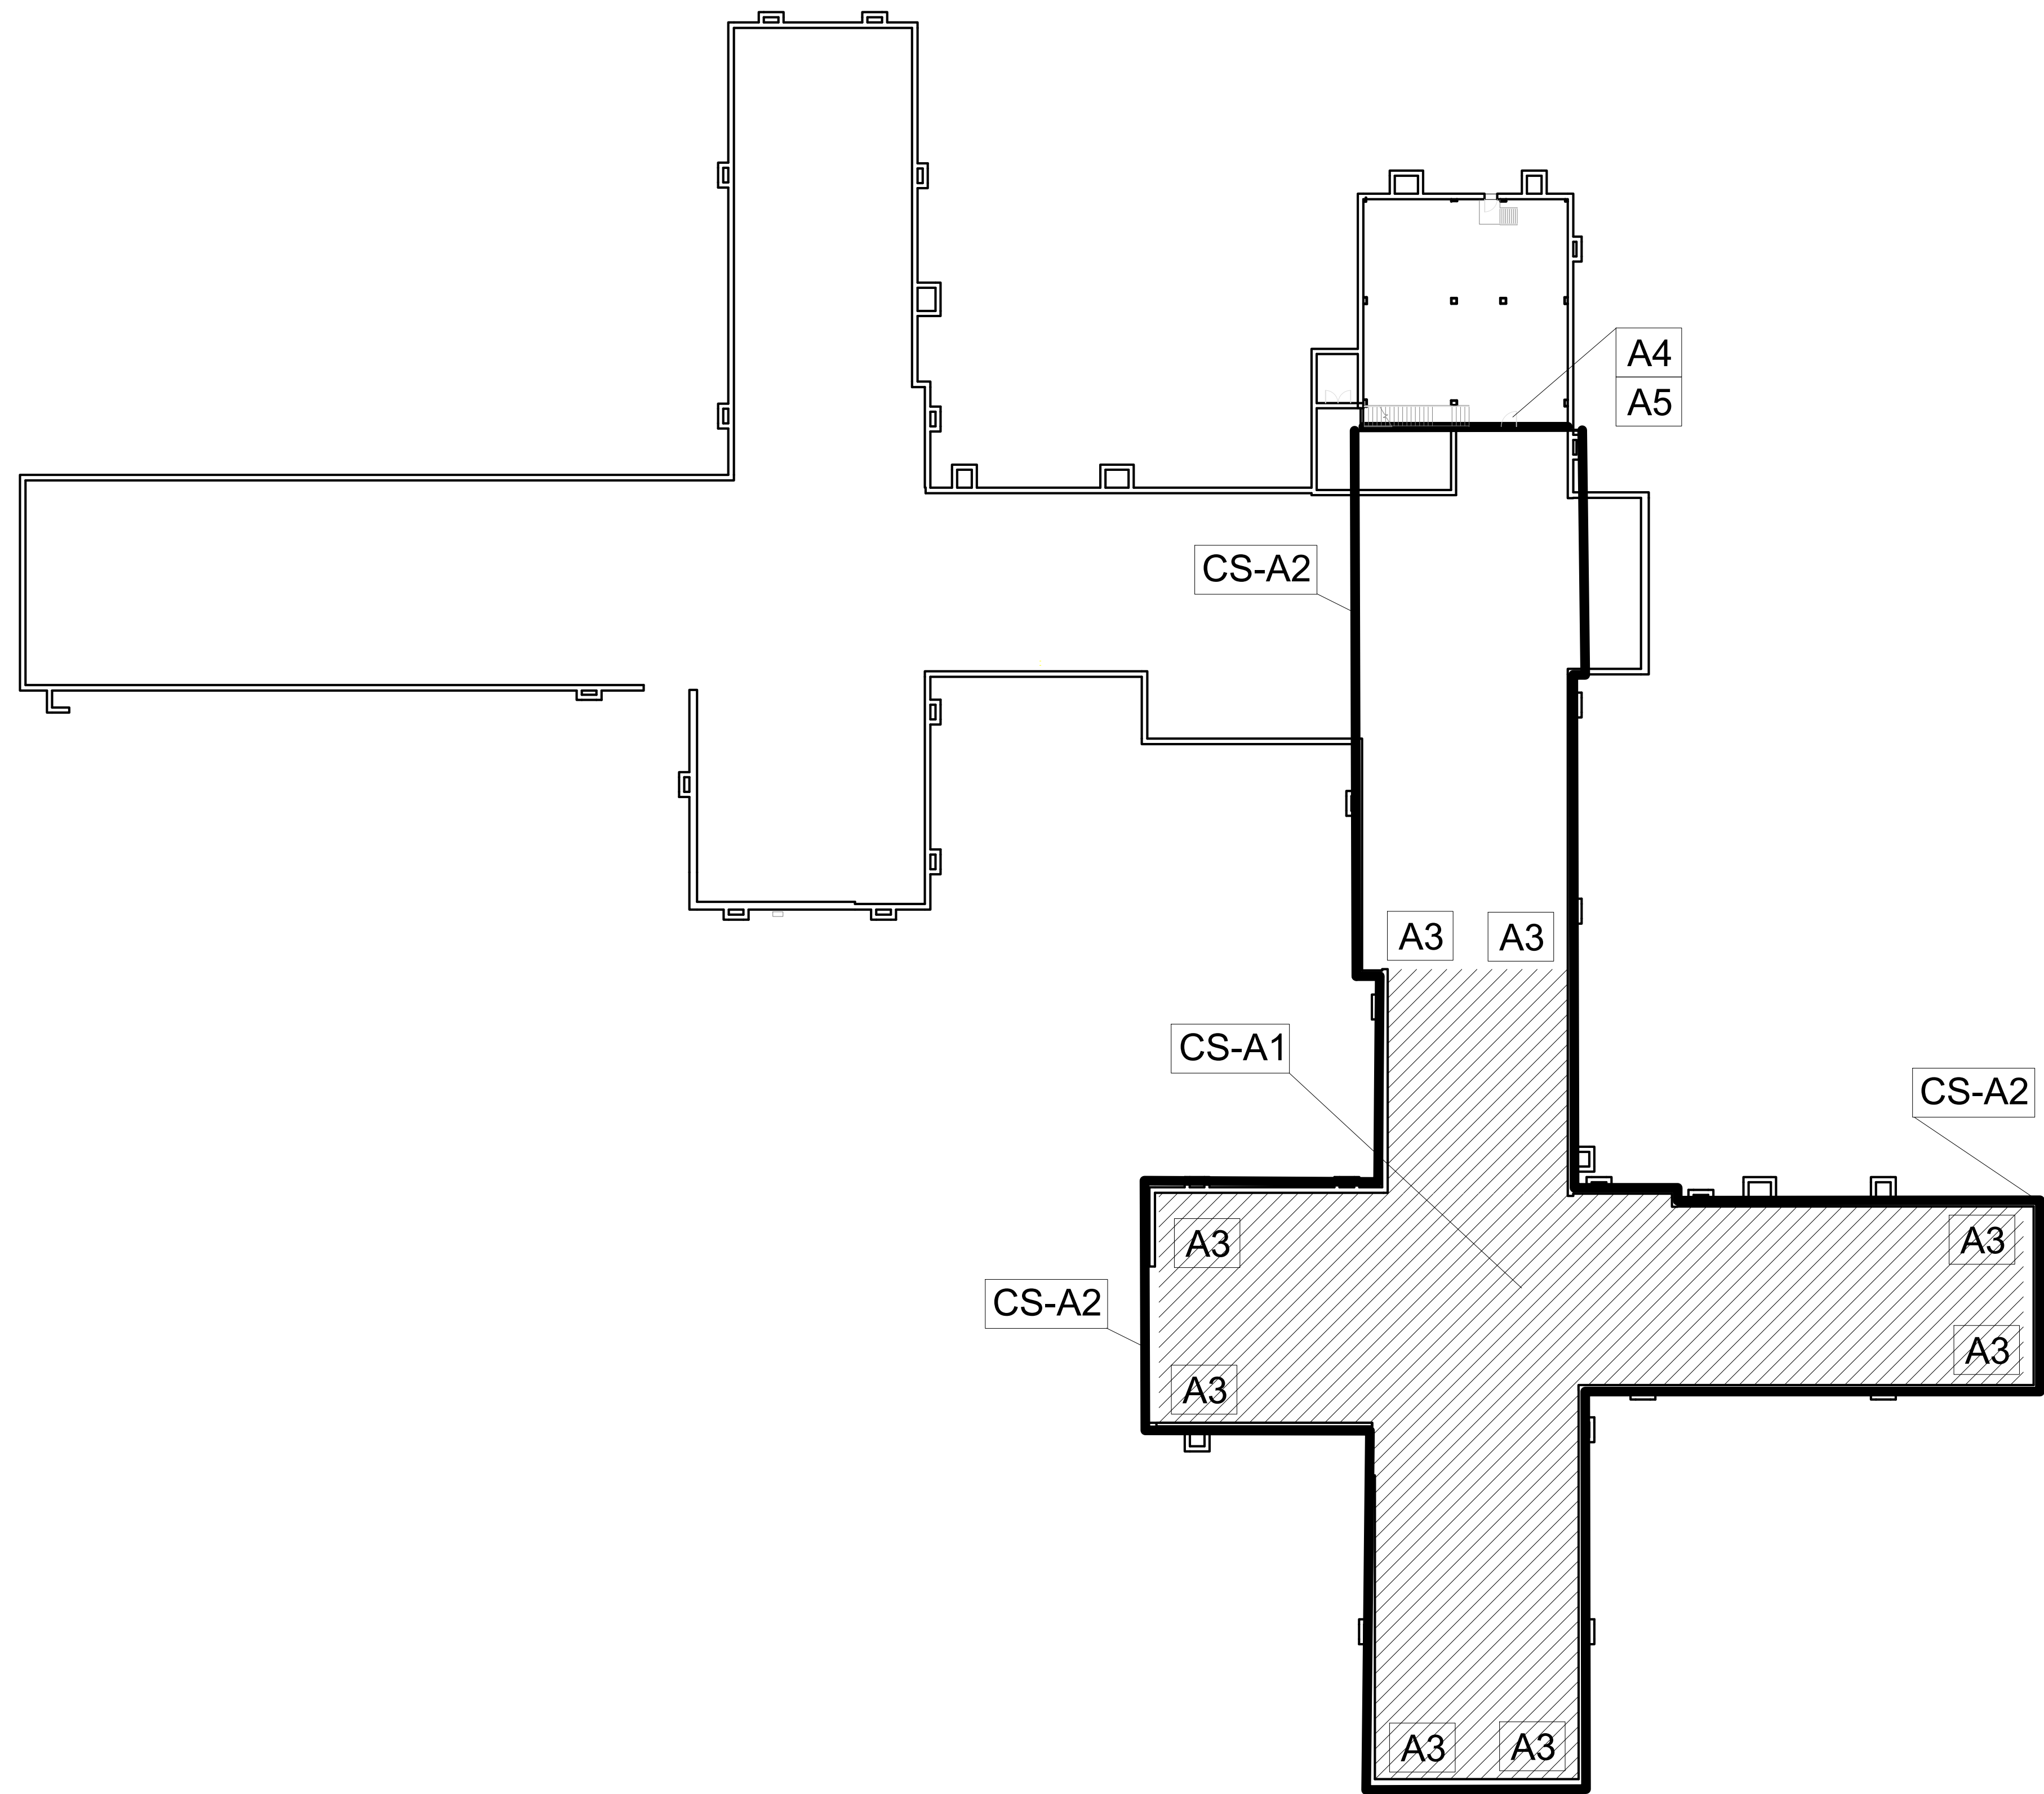

Keyed Notes - Abatement

- CS-A1** APPROXIMATELY 10,800 SF OF ASBESTOS CONTAMINATED CRAWLSPACE SOILS ARE TO BE FULLY ENCLOSED THROUGHOUT EXPOSED SOIL AREAS OF CRAWL SPACE. ENCLOSURE SHALL CONSIST OF INSTALLATION OF A 60 MILLIMETER THICK EPDM MEMBRANE OVER ALL EXPOSED SOIL SURFACES, WITH MEMBRANE SHEETS CHEMICALLY WELDED AT SEAMS (WITH 12" OVERLAP AT ALL SEAMS), AND PHYSICALLY SEALED ALONG PERIMETER EDGES (I.E. FURRING STRIPS AND TAP-CONS WITH MEMBRANE FOLDED OVER) TO CONCRETE WALLS AND/OR COLUMNS, AS NEEDED TO ENSURE AN AIR-TIGHT LAYER IS ACHIEVED AND MAINTAINED BETWEEN SOILS AND CRAWL SPACE.
- CS-A2** NEGATIVE PRESSURE ENCLOSURE (NPE) BOUNDARY; ALL PENETRATIONS ARE TO BE SEALED OR OTHERWISE ISOLATED FROM NPE WITH 6 MIL LAYER OF FIRE RETARDANT (FR) POLY SHEETING AS A CRITICAL BARRIER. ACTIVE HVAC COMPONENTS MUST BE ISOLATED FROM NPE OR SHUT DOWN. NPE MUST BE MAINTAINED THROUGH CLEARANCE.
- A3** HEPA FILTERED NEGATIVE AIR MACHINE (2000 CFM) TO MAINTAIN REGULATED AREA UNDER NEGATIVE PRESSURE DIFFERENTIAL OF 0.02 IN WG DURING REGULATED ACTIVITIES (VERIFY WITH ELECTRONIC RECORDING MANOMETER). EXHAUST AIR TO BE DISCHARGED OUTDOORS THROUGH PERIMETER ACCESS WELLS.
- A4** THREE STAGE WET DECONTAMINATION CHAMBER (W/SHOWER) TO BE CONSTRUCTED OF 6 MIL FR POLY AND USED FOR PERSONNEL DECONTAMINATION PURPOSES. NOTE THAT ACCESS TO CRAWL SPACE IS LIMITED TO AN ACCESS LADDER/HATCH.
- A5** TWO STAGE WASTE LOAD-OUT CHAMBER TO BE CONSTRUCTED OF 6 MIL FR POLY AND USED FOR WASTE DECON PURPOSES. ACCOMMODATE SIZE OF WASTE CONTAINER COMPONENTS - CONSTRUCT ACCORDINGLY. NOTE THAT ACCESS TO CRAWL SPACE IS LIMITED TO AN ACCESS LADDER/HATCH.

General Notes - Abatement

1. ABATEMENT CONTRACTOR TO CONDUCT ALL ASBESTOS RELATED WORK WITHIN A NEGATIVE PRESSURE ENCLOSURE (NPE). ALL ACM COMPONENTS TO BE REMOVED AND DISPOSED BY ABATEMENT CONTRACTOR UNDER THIS SCOPE OF WORK.
2. NPE SHALL BE CONSTRUCTED IN ACCORDANCE WITH TECHNICAL SPECIFICATIONS PROVIDED WITHIN CONSTRUCTION DOCUMENTS (02.82.11) INCLUDING: 6-MIL FIRE RETARDANT POLY SHEETING OVER CRITICAL BARRIERS (CEILING/WALL PENETRATIONS ONLY; ALL WALLS AND FLOORS TO BE CLEANED AND CLEARED); 3-STAGE WET DECONTAMINATION STATION; 2-STAGE WASTE LOAD OUT STATION; HEPA FILTERED NEGATIVE AIR MACHINES FOR NPE TO BE MAINTAINED AT -0.02 IN WG AND WITH MIN OF 4 AIR CHANGES PER HOUR; AND AN 18"X18" VIEWING WINDOW.
3. ALL ASBESTOS WASTES ARE TO BE LOADED OUT AND STORED WITHIN A LINED/LOCKED/LABELED WASTE DUMPSTER STORED ON SITE NO LATER THAN THE END OF EACH SHIFT.
4. ABATEMENT WORKERS SHALL WEAR ALL PPE REQUIRED/SPECIFIED WITHIN SPECIFICATION 02.82.11, INCLUDING: RESPIRATORY PROTECTION (FULL FACE POWERED AIR PURIFYING RESPIRATOR), DISPOSABLE SUITS, GLOVES AND RUBBER BOOTS, AT A MINIMUM.
5. ALL RESIDUAL DUSTS PRESENT ON UTILITY COMPONENTS, CONCRETE FLOORS, LEDGES AND NEWLY INSTALLED EPDM LAYER SHALL BE CLEANED USING HEPA VACUUM AND SUBJECT TO A WET WIPING FOLLOWING ENCLOSURE TO ACHIEVE CLEARANCE BY VISUAL INSPECTION AND AIR SAMPLING (TEM METHODS). EXPOSED/FRAYED/DAMAGED FIBERGLASS INSULATION COMPONENTS SHALL BE WRAPPED IN LAG CLOTH TO ASSIST WITH CLEANUP AND FINAL CLEARANCE SAMPLING.
6. FOLLOWING FINAL VISUAL INSPECTIONS AND CLEARANCE AIR SAMPLING BY VPIH, ALL SURFACES WITHIN CRAWLSPACE SHALL BE ENCAPSULATED WITH TWO COATS OF A TINTED ENCAPSULANT.
7. ALL OSHA REQUIRED AIR SAMPLING TO BE PERFORMED BY CPIH AND ALL CLEARANCE AND PERIMETER AIR MONITORING TO BE PERFORMED BY VPIH, AS PER 02.82.11.

ENVIRONMENTAL REMEDIATION FLOOR PLAN - CRAWLSPACE

1/8" = 1'-0"

CONSULTANT INFORMATION

STRUCTURAL / CIVIL ENGINEER STAND STRUCTURAL ENGINEERING 11827 W. 112TH STREET, SUITE 200 OVERLAND PARK, KS 66210 (913) 214-2169	MECHANICAL / ELECTRICAL / PLUMBING / TECHNICAL ENGINEER SPUR DESIGN 11020 KING STREET, SUITE 350 OVERLAND PARK, KS 66210 (405) 842-8100	FIRE PROTECTION ENGINEER POOLE FIRE PROTECTION, INC. 19910 W. 161ST STREET OLATH, KS 66062 (913) 825-8650	ENVIRONMENTAL CONSULTANT RIVERFRONT SAFETY AND HEALTH 1138 OLIVE ST, SUITE 300 ST. LOUIS, MO 63101 (314) 438-9492
--	---	---	---



KS ARCH REG. NO. A-1139, EXP. 12/31/2019
KS ENGR REG. NO. E-2586, EXP. 12/31/2019

Office of Construction and Facilities Management



SHEET TITLE
BASE BID CRAWLSPACE ENVIRONMENTAL REMEDIATION

APPROVED: PROJECT DIRECTOR

PROJECT PHASE
BID DOCUMENTS

FULLY SPRINKLERED

PROJECT TITLE
RENOVATE A & B WING BLDG 6

PROJECT LOCATION
**2200 SW GAGE BLVD.
TOPEKA, KS 66622**

DATE
7/10/2019

CHECKED BY
J.Rhyneer


DRAWN BY
C.Dey

VA PROJECT NUMBER
589A5-19-116


BUILDING NUMBER
6

DRAWING NUMBER
6-HA-3

Dwg. 10 OF 160

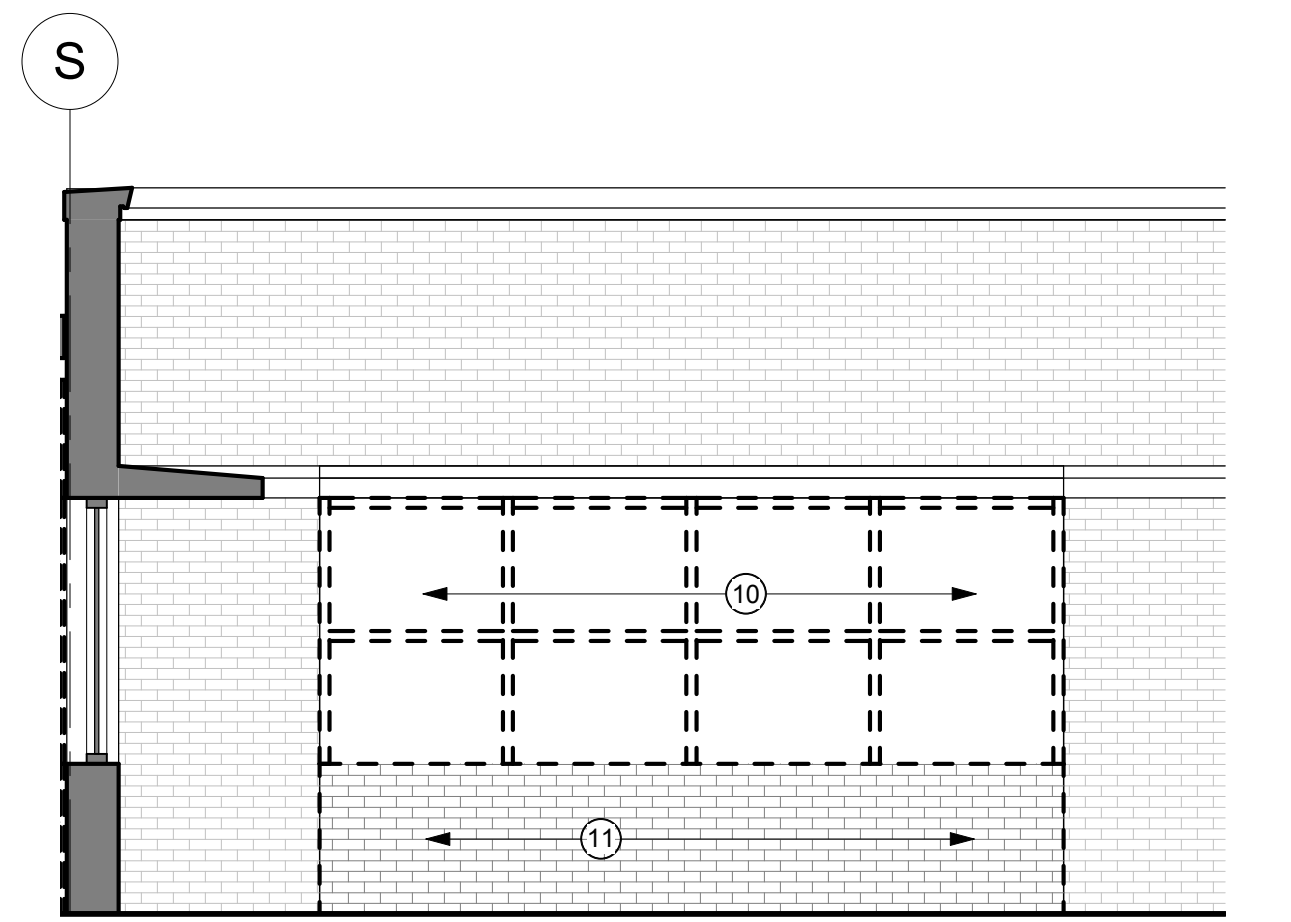

2 EXTERIOR ELEVATION - DEMOLITION
1/4" = 1'-0"


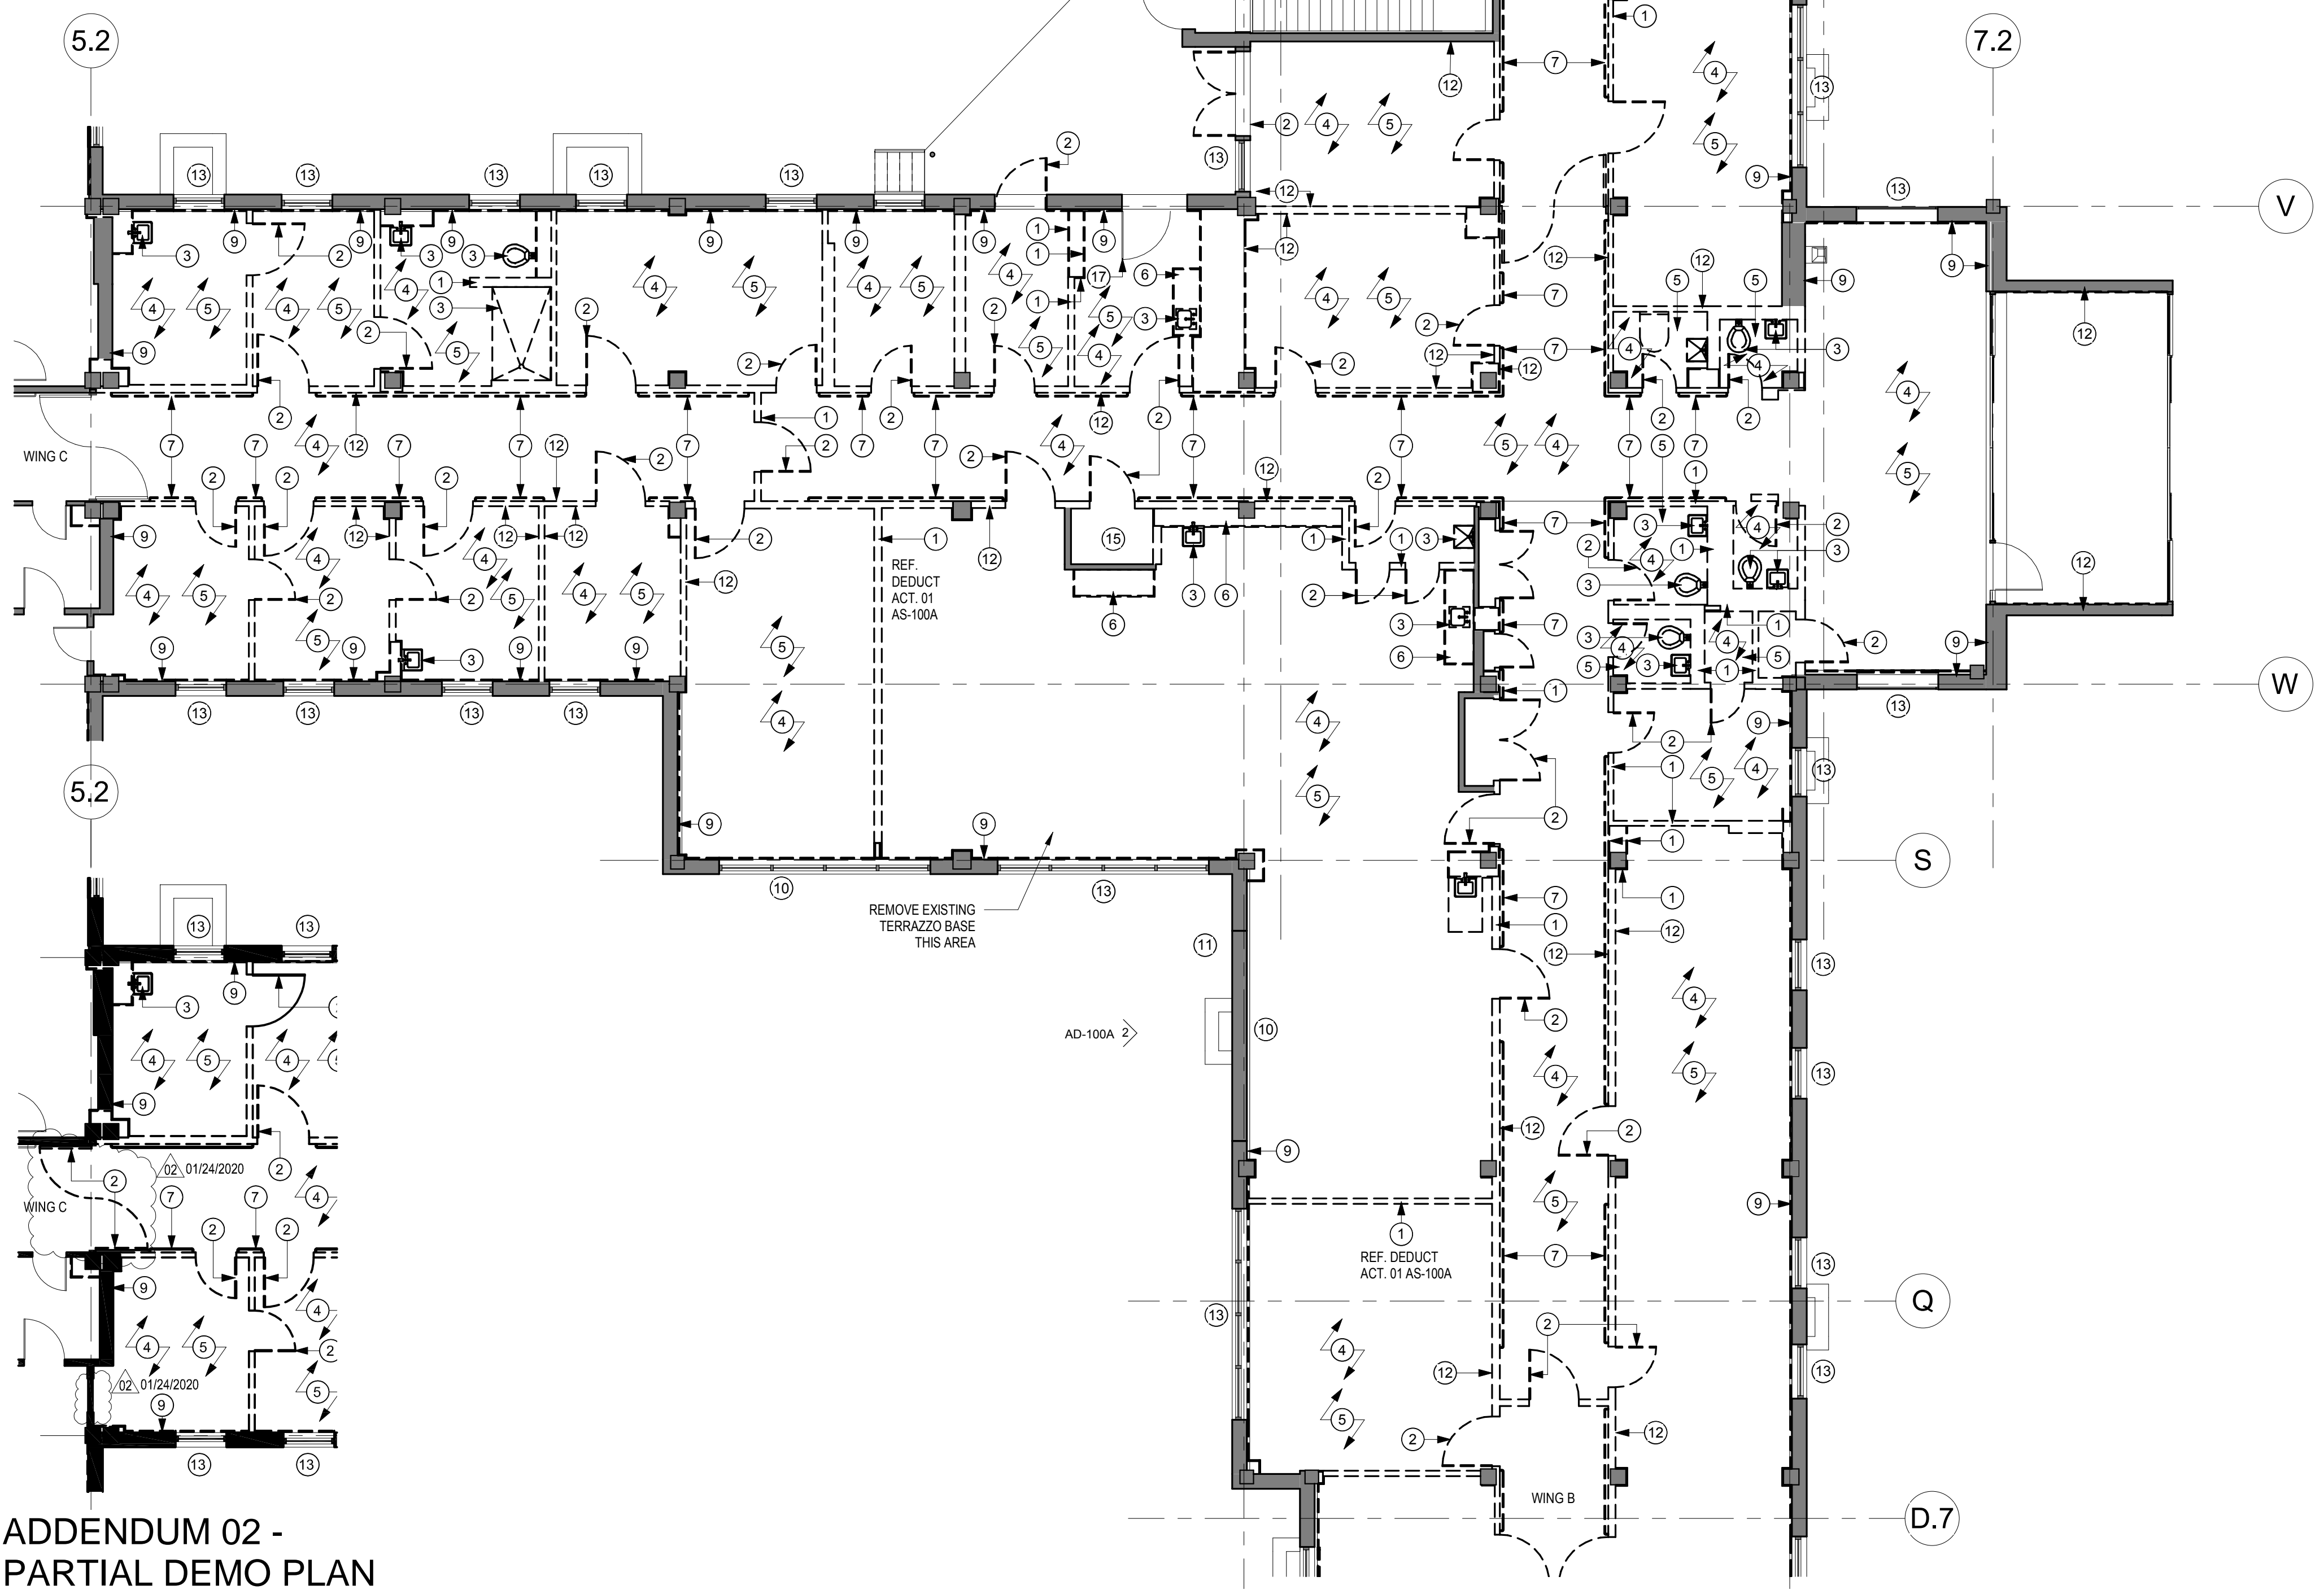


ADDENDUM 02 - PARTIAL DEMO PLAN


1 WING A - DEMOLITION FLOOR PLAN
1/8" = 1'-0"

- GENERAL DEMOLITION NOTES**
- DRAWINGS ARE PART OF A COMPLETE DOCUMENT SET. CONTRACTOR SHALL CONFIRM ALL ITEMS REQUIRED TO BE DEMOLISHED AND EXTENT OF DEMOLITION BASED UPON THE OVERALL INTENT OF THE ENTIRE DOCUMENT SET.
 - VERIFY ALL EXISTING CONDITIONS PRIOR TO BEGINNING ANY DEMOLITION TO CONFIRM ACCURACY IN THE DRAWINGS. REPORT ANY DISCREPANCIES TO CONTRACTING OFFICER. DO NOT SCALE THE DRAWINGS. FIELD VERIFY ALL DIMENSIONS AND EXISTING STRUCTURAL CONDITIONS.
 - ALL AREAS NOT INVOLVED IN THE SCOPE OF WORK FOR THIS PROJECT SHALL BE KEPT CLEAN AND FREE OF OBSTRUCTIONS AT ALL TIMES. ERECT BARRICADES AND WARNING SIGNS TO DIVERT AND WARN PASSERS-BY OF THE CONSTRUCTION WORK. PROVIDE FIRE-RATED DUST PROOFING ENCLOSURES TO SEPARATE WORK AREAS FROM THE EXISTING FACILITIES.
 - DURING DEMOLITION, PROVIDE PROTECTION FOR ALL EXISTING SURFACES AND CONDITIONS TO REMAIN IN PLACE DURING THE RENOVATION WORK. SHOULD ANY DAMAGE OCCUR, PATCH AND REPAIR TO MATCH EXISTING ADJACENT FINISHES.
 - ANY DAMAGE CAUSED TO THE BUILDING OR OWNER EQUIPMENT SHALL BE REPAIRED FOR REPLACED BACK TO ITS ORIGINAL CONDITIONS AT NO ADDITIONAL COST TO THE OWNER.
 - ALL ITEMS INDICATED WITH A DASHED LINE SHALL BE REMOVED IN THEIR ENTIRETY INCLUDING RELATED COMPONENTS. REMOVAL OF MECHANICAL, ELECTRICAL, AND PLUMBING SHOULD BE LIMITED TO WHAT IS NECESSARY FOR SAFE REMOVAL OF THE INDICATED WALL OR CEILING. APPROPRIATE LIGHT FIXTURES SHALL BE TEMPORARILY SUSPENDED TO PROVIDE ADEQUATE LIGHTING LEVELS FOR CONSTRUCTION.
 - CONTRACTOR TO DEMO ALL FIXTURES, CEILING, MECHANICAL, PLUMBING, AND ELECTRICAL AS REQUIRED TO COMPLETE THE SCOPE OF WORK OUTLINED WITHIN THE CONSTRUCTION DOCUMENTS.
 - CONTRACTOR TO REPAIR LEVEL EXISTING CONCRETE SUB-FLOOR TO REQUIRED CONDITIONS FOR NEW FLOORING INSTALLATION. CONTRACTOR TO INSURE CONCRETE SUB-FLOOR MOISTURE AND CONTENT & PH LEVELS ARE WITHIN ACCEPTABLE FLOORING MANUFACTURER LEVELS.
 - REPAIR EXISTING CONCRETE SUB-FLOOR TO SMOOTH & LEVEL CONDITION TO RECEIVE NEW FINISHES.
 - ALL ARTWORK TO BE REMOVED AND SALVAGED FOR REINSTALLATION.

- TEMPORARY BARRIERS**
- TEMPORARY CONSTRUCTION BARRIERS SHALL BE 3/8" METAL STUDS AT 16" O.C. WITH 5/8" TYPE 'X' GYPSUM WALLBOARD ON EACH SIDE TO EXTENT TO THE UNDERSIDE OF STRUCTURE ABOVE. PROVIDE NON-DAMAGING SEAL AT INTERSECTION WITH CEILING. TAPE ALL SEAMS AND PENETRATION OPENINGS TO PREVENT CONTAMINATION INTO ADJACENT SPACES NOT IN THE AREA OF WORK.
 - TEMPORARY CONSTRUCTION BARRIERS SHALL BE EITHER TYPE I OR TYPE II, AND NOTED ON THE DRAWINGS. TYPE I BARRIERS SHALL BE ANCHORED TO THE FLOORING SURFACE (WHICH IS INTENDED TO BE REPLACED WITH POWER-ACTUATED FASTENERS. TYPE II BARRIERS SHALL BE ANCHORED TO THE FLOORING SURFACE (WHICH IS INTENDED TO REMAIN) BY TAPING BOTTOM STUDY TRACK TO FLOOR SURFACE OR BY OTHER METHODS WHICH WILL NOT HARM FLOOR SURFACE.

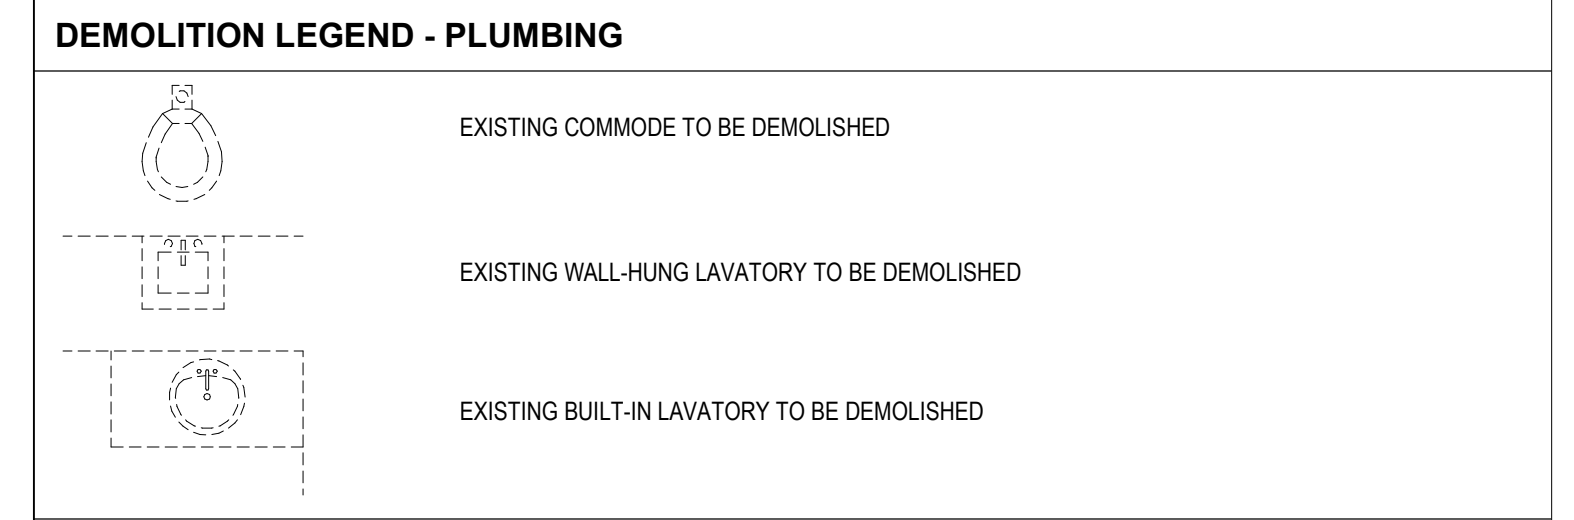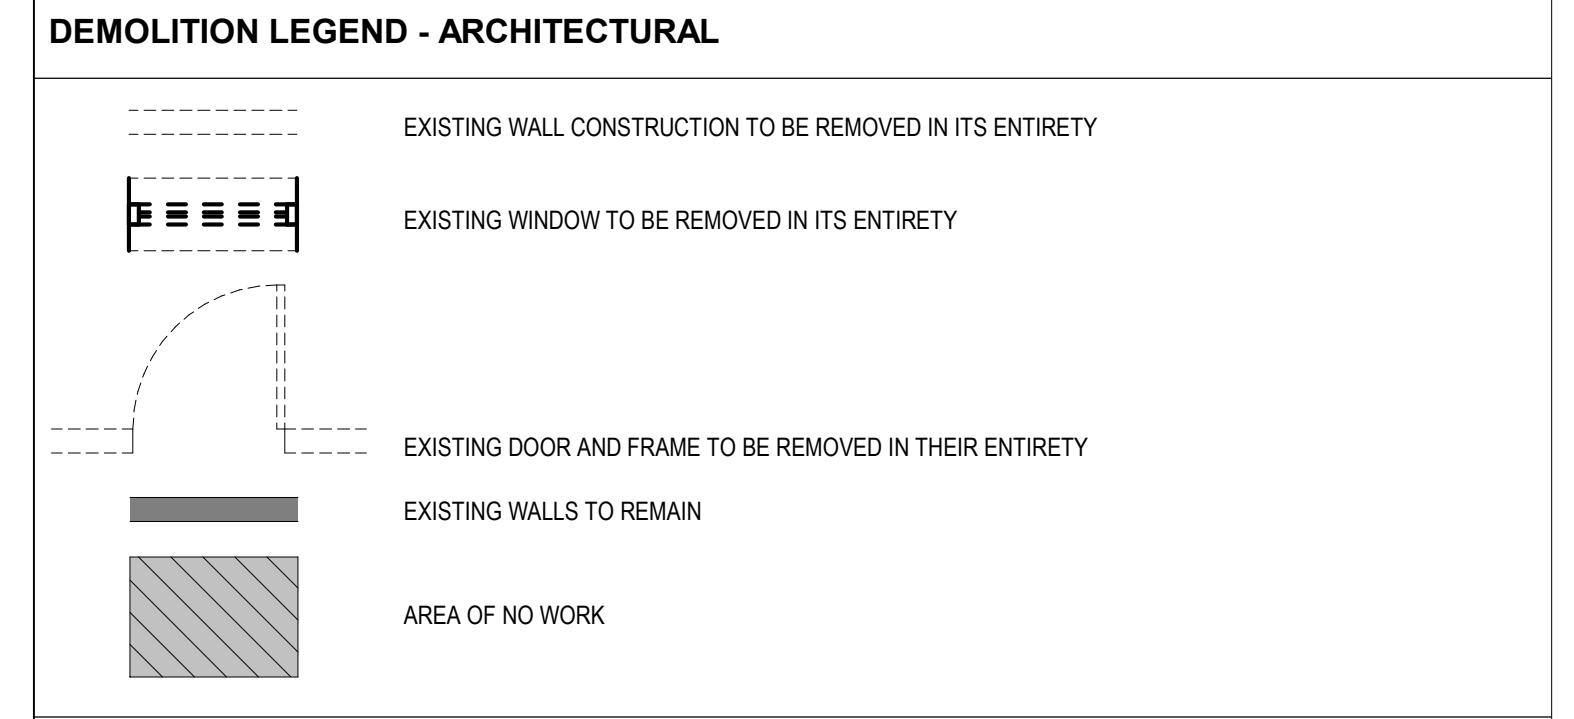

- DEMOLITION KEYNOTES**
- REMOVE EXISTING WALL CONSTRUCTION IN ITS ENTIRETY
 - REMOVE & RETAIN EXISTING DOOR & FRAME. SALVAGED DOOR & FRAMES TO BE RETURNED TO THE VA
 - REMOVE EXISTING PLUMBING FIXTURES AND ASSOCIATED PLUMBING. REFERENCE PLUMBING DRAWINGS
 - REMOVE EXISTING CEILING, LIGHT FIXTURES, DIFFUSERS, AND ELECTRICAL WORK IN THIS AREA. REFERENCE ELEC. & MECH. DRAWINGS
 - REMOVE EXISTING FLOORING IN ITS ENTIRETY. CLEAN & PREPARE SUB-FLOOR SURFACE FOR NEW FLOORING PER RENOVATION PLAN
 - REMOVE EXISTING CASEWORK AND MILLWORK IN ITS ENTIRETY
 - REMOVE EXISTING HANDRAIL, CRASH RAIL & WALL PROTECTION
 - REMOVE EXISTING BATHROOM PARTITION
 - REMOVE INTERIOR WALL FINISH TO INTERIOR FACE OF MANSORY
 - REMOVE EXISTING WINDOW / LOUVER
 - REMOVE EXISTING MASONRY BELOW WINDOW AS INDICATED - SAW CUT AT JAMBS FOR CLEAR CONDITION
 - REMOVE EXISTING WALL FINISH AND BASE - PREPARE SURFACE FOR NEW FINISH
 - EXISTING WINDOW TO REMAIN - CONTRACTOR TO PROTECT DURING CONSTRUCTION
 - PROTECT EXISTING EXPANSION JOINT
 - COORDINATE WALL REMOVAL WITH I.T.
 - REMOVE MASONRY AS INDICATED
 - PREPARE EXISTING DOOR FOR NEW FINISHES

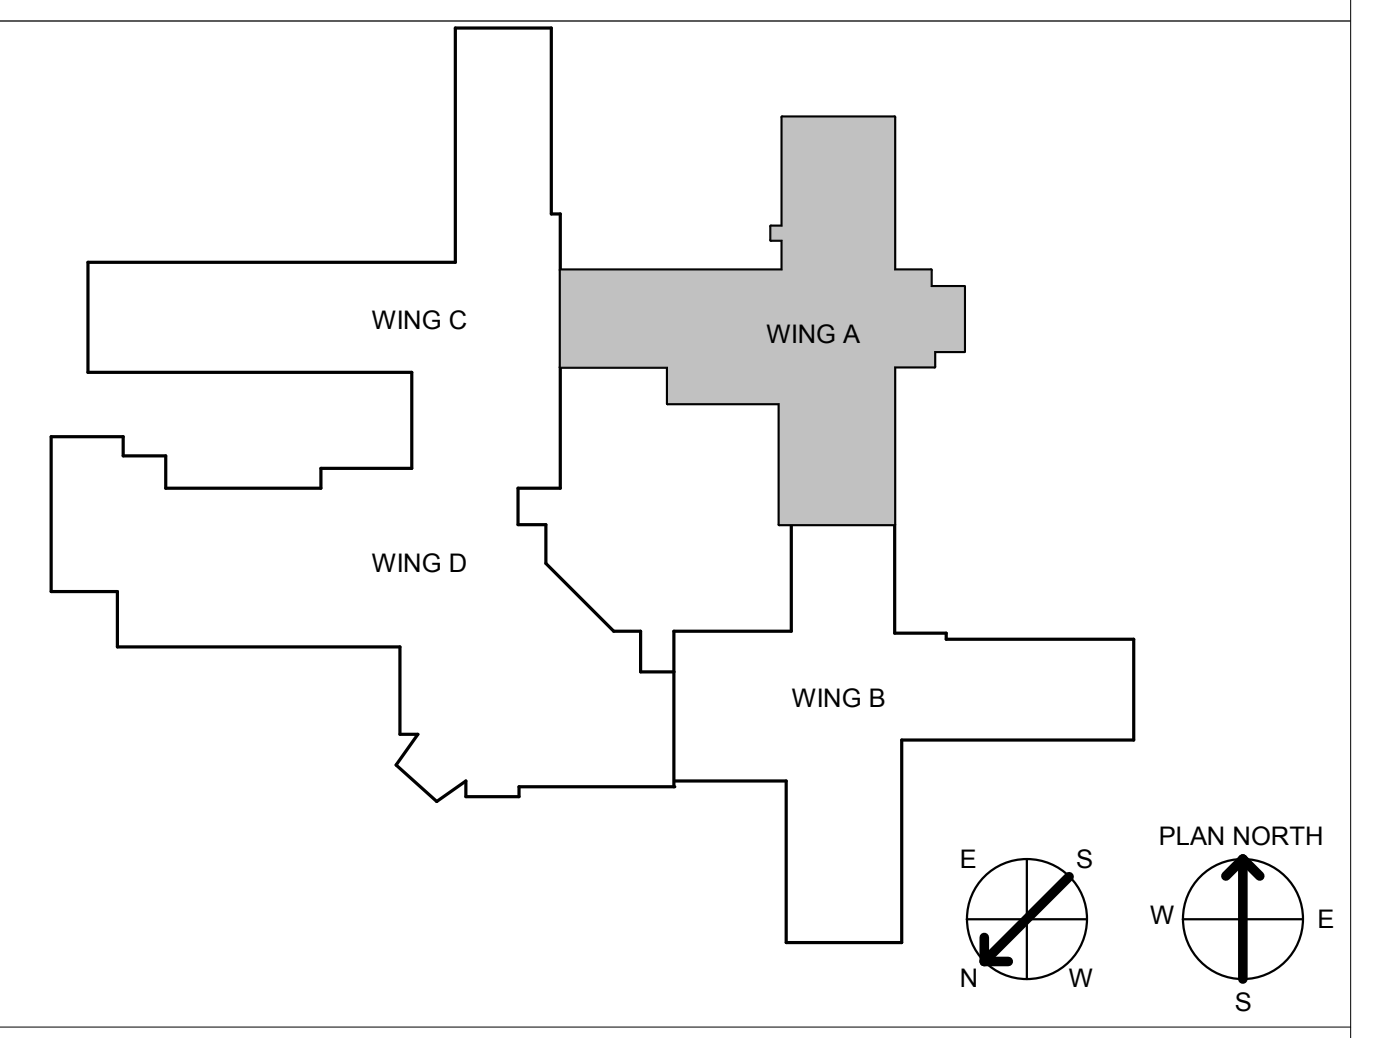

ADDENDUM 02	01/24/2020
Revision #	Date

CONSULTANT INFORMATION

STRUCTURAL / CIVIL ENGINEER	MECHANICAL / ELECTRICAL / PLUMBING / TECHNICAL ENGINEER	FIRE PROTECTION ENGINEER
STAND STRUCTURAL ENGINEERING 11827 W. 112TH STREET, SUITE 200 OVERLAND PARK, KS 66210 (913) 214-2169	SPUR DESIGN 11020 KING STREET, SUITE 350 OVERLAND PARK, KS 66210 (405) 842-6100	POOLE FIRE PROTECTION, INC. 19910 W. 161ST STREET OLATH, KS 66062 (913) 829-8650

ARCHITECT

SPUR DESIGN

312 SW 23rd Street
Overland Park, KS 66209
spur-design.com

10000 Ring Street, Suite 300
Overland Park, KS 66209
spur-design.com

KS ARCH REG. NO. A-1139, EXP. 12/31/2019
KS ENGR REG. NO. E-2586, EXP. 12/31/2019

6728
MAY 10, 2017
KANSAS ARCHITECT

Office of Construction and Facilities Management

VA U.S. Department of Veteran Affairs

SHEET TITLE
WING A - DEMO FLOOR PLAN

APPROVED: PROJECT DIRECTOR

PROJECT PHASE
BID DOCUMENTS

FULLY SPRINKLERED

PROJECT TITLE
RENOVATE A & B WING BUILDING 6

PROJECT LOCATION
2200 SW GAGE BLVD.
TOPEKA, KS 66622

DATE
07/10/2019

CHECKED BY
AWM

DRAWN BY
JET


VA PROJECT NUMBER
589A5-19-116

BUILDING NUMBER
6


DRAWING NUMBER
6-AD-100A

Dwg. 11 OF 160

A
B
C
D
E
F

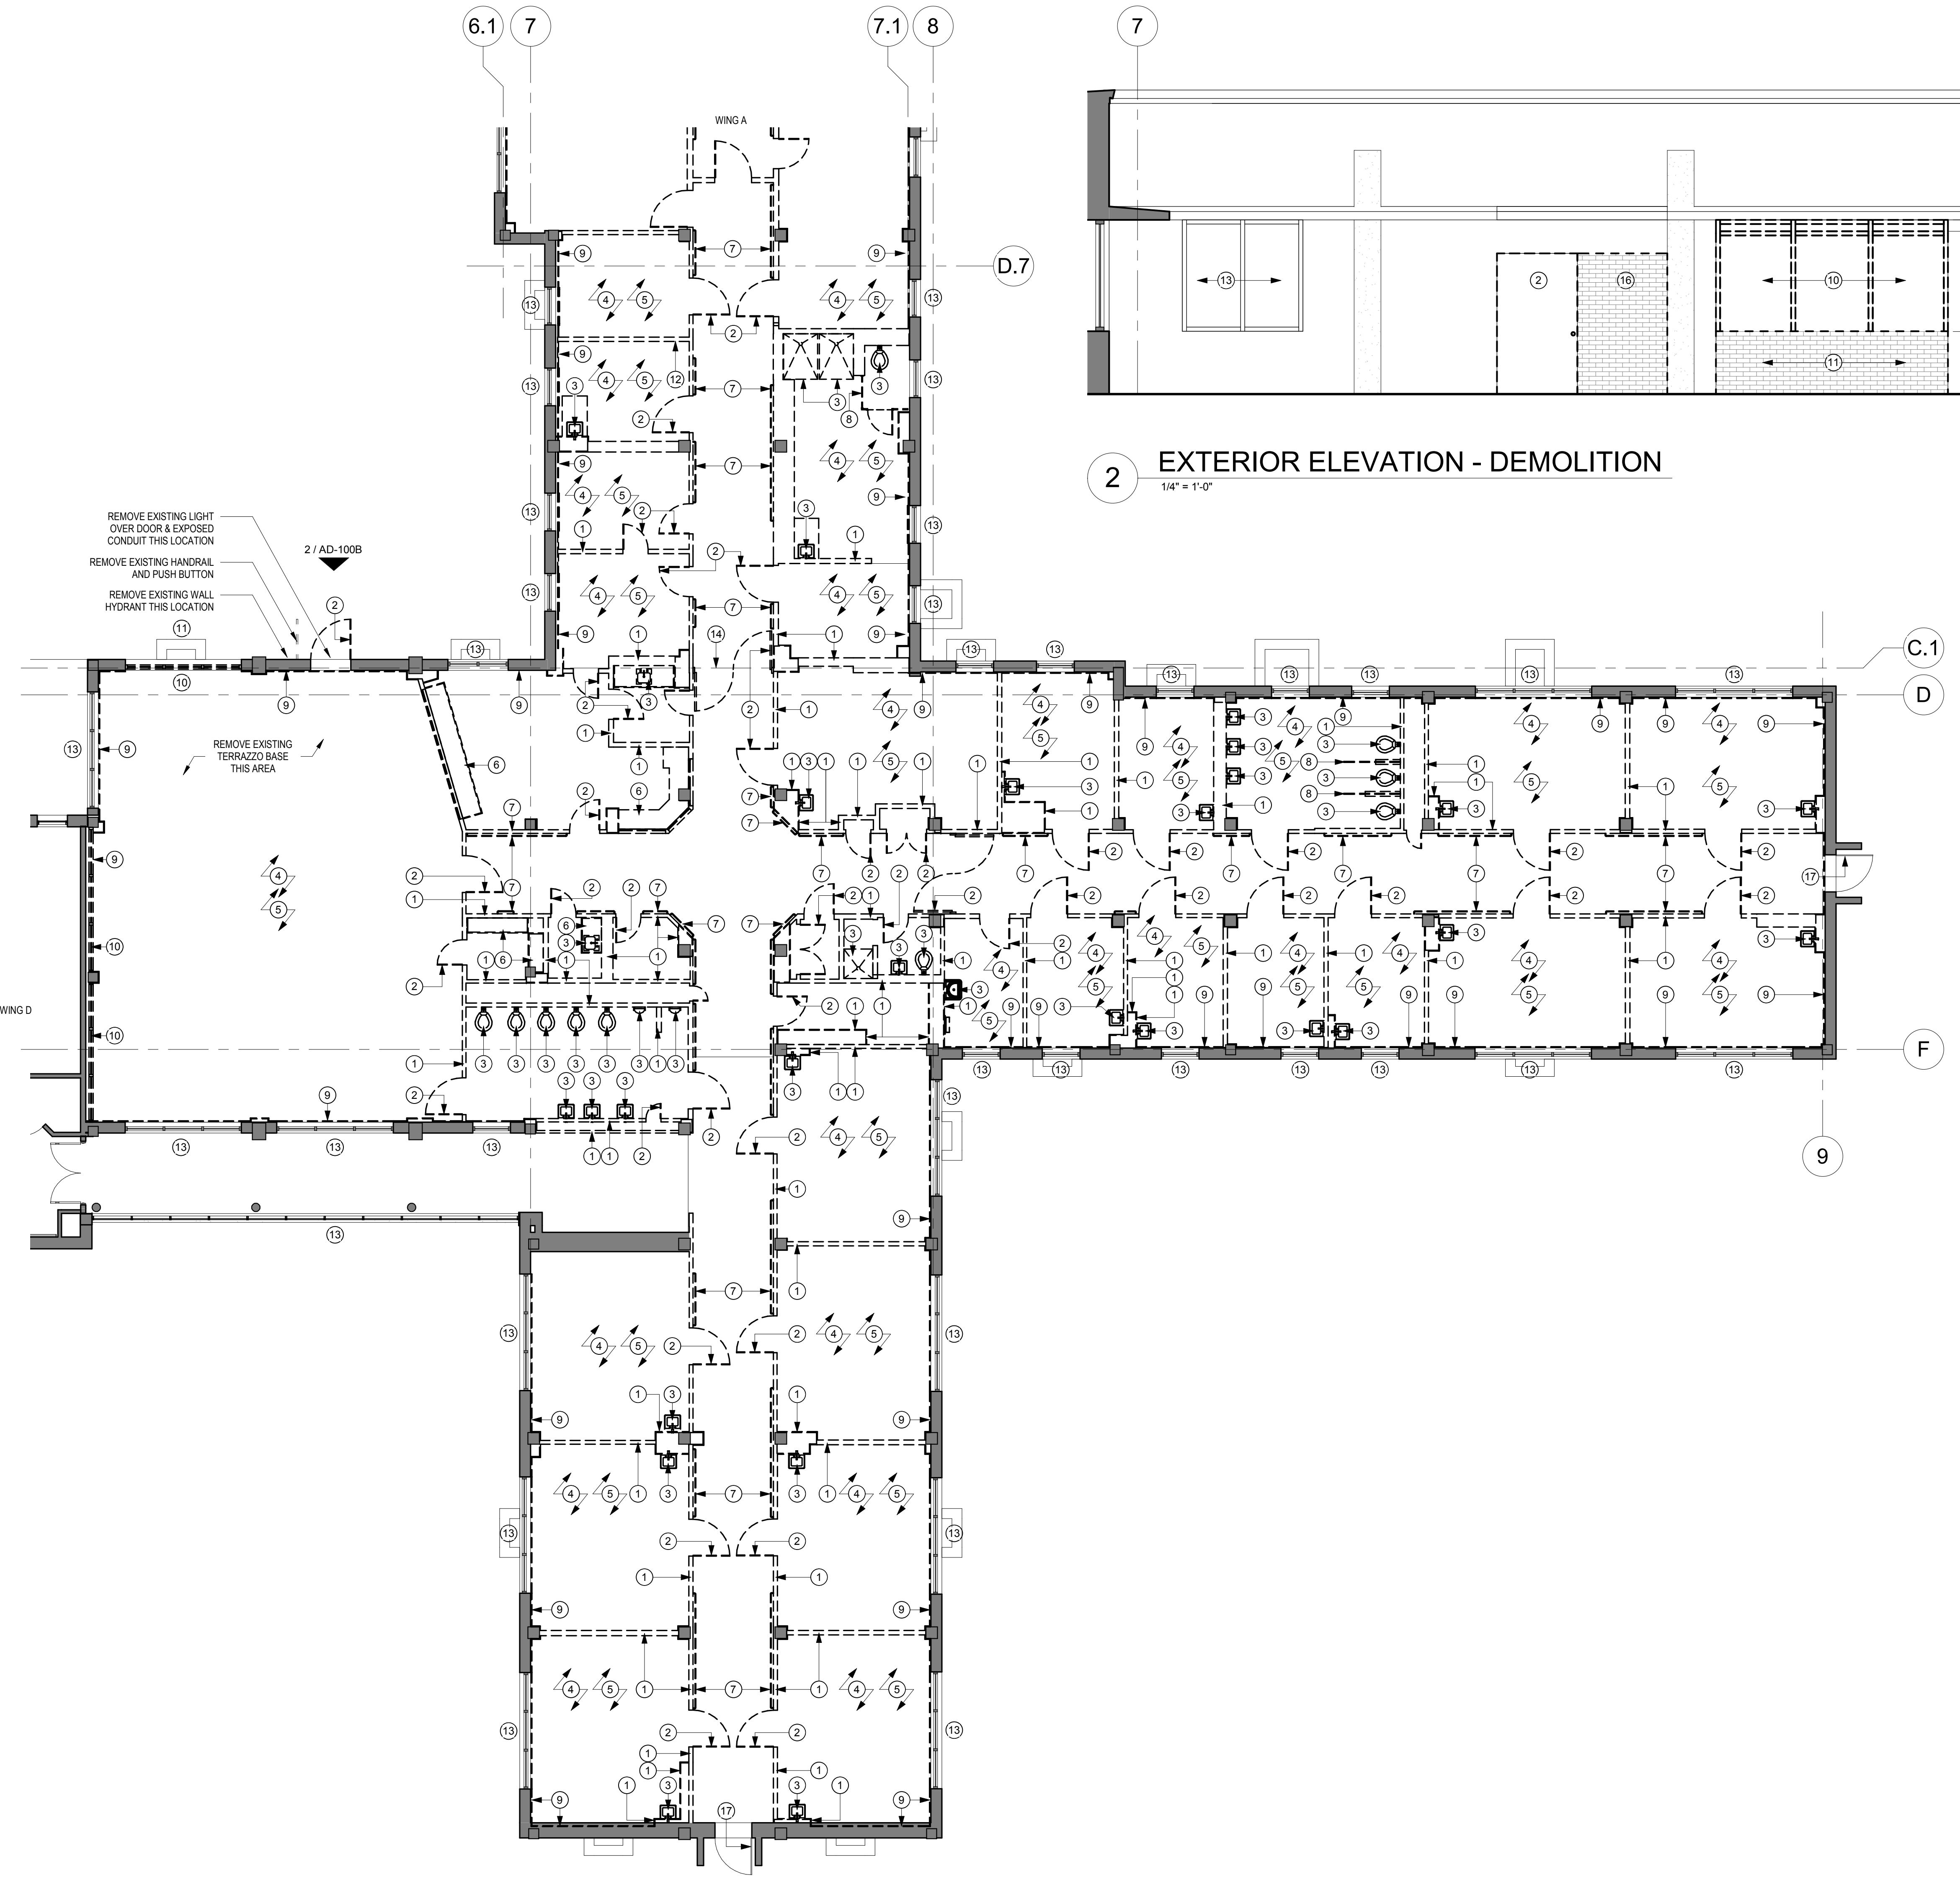



1 WING B - DEMOLITION FLOOR PLAN
1/8" = 1'-0"

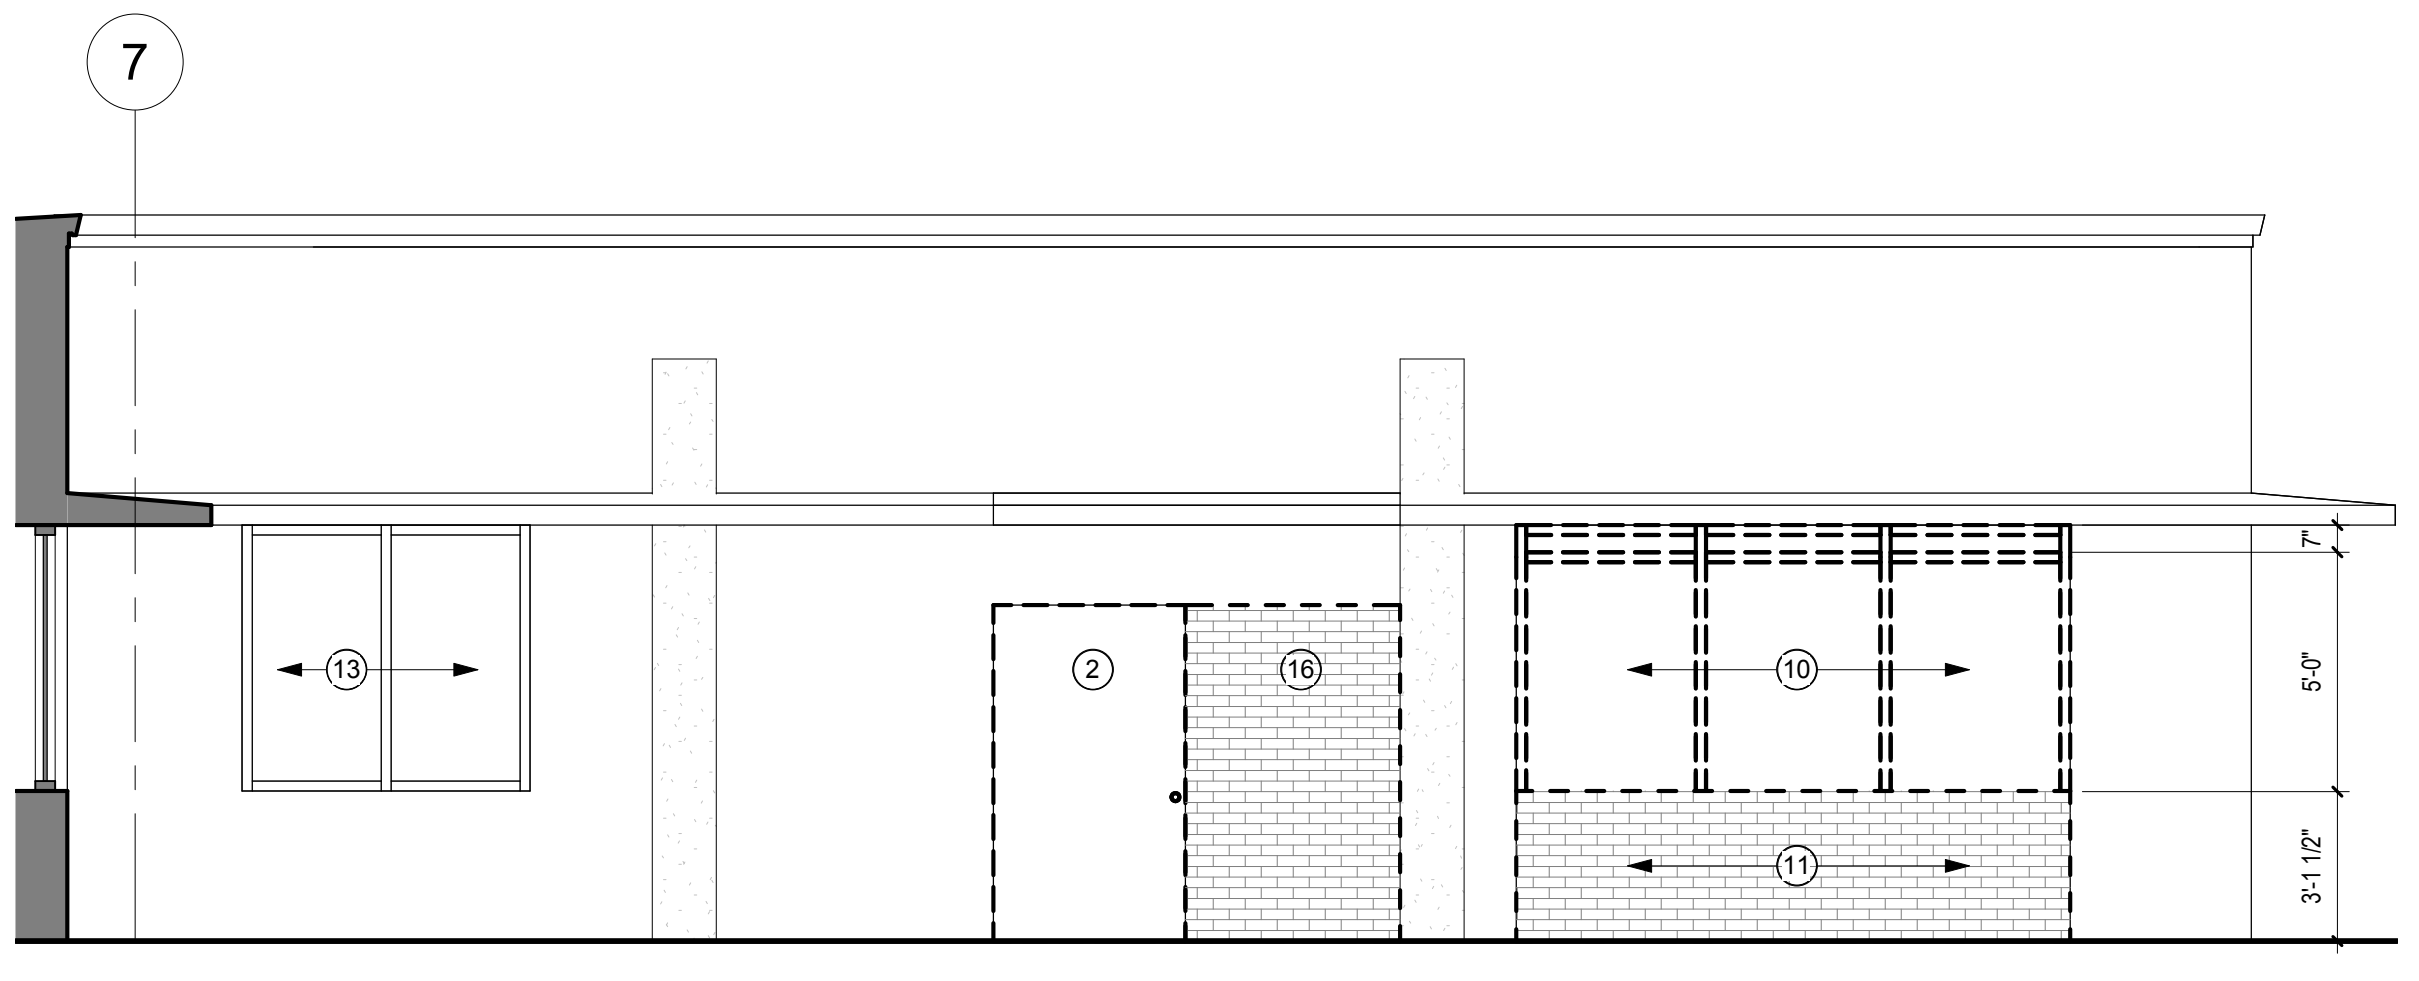


2 EXTERIOR ELEVATION - DEMOLITION
1/4" = 1'-0"

- GENERAL DEMOLITION NOTES**
- DRAWINGS ARE PART OF A COMPLETE DOCUMENT SET. CONTRACTOR SHALL CONFIRM ALL ITEMS REQUIRED TO BE DEMOLISHED AND EXTENT OF DEMOLITION BASED UPON THE OVERALL INTENT OF THE ENTIRE DOCUMENT SET.
 - VERIFY ALL EXISTING CONDITIONS PRIOR TO BEGINNING ANY DEMOLITION TO CONFIRM ACCURACY IN THE DRAWINGS. REPORT ANY DISCREPANCIES TO CONTRACTING OFFICER. DO NOT SCALE THE DRAWINGS. FIELD VERIFY ALL DIMENSIONS AND EXISTING STRUCTURAL CONDITIONS.
 - ALL AREAS NOT INVOLVED IN THE SCOPE OF WORK FOR THIS PROJECT SHALL BE KEPT CLEAN AND FREE OF OBSTRUCTIONS AT ALL TIMES. ERECT BARRICADES AND WARNING SIGNS TO DIVERT AND WARN PASSERS-BY OF THE CONSTRUCTION WORK.
 - PROVIDE FIRE-RATED DUST PROOFING ENCLOSURES TO SEPARATE WORK AREAS FROM THE EXISTING FACILITIES DURING DEMOLITION. PROVIDE PROTECTION FOR ALL EXISTING SURFACES AND CONDITIONS TO REMAIN IN PLACE DURING THE RENOVATION WORK. SHOULD ANY DAMAGE OCCUR, PATCH AND REPAIR TO MATCH EXISTING ADJACENT FINISHES.
 - ANY DAMAGE CAUSED TO THE BUILDING OR OWNER EQUIPMENT SHALL BE REPAIRED FOR REPLACED BACK TO ITS ORIGINAL CONDITIONS AT NO ADDITIONAL COST TO THE OWNER.
 - ALL ITEMS INDICATED WITH A DASHED LINE SHALL BE REMOVED IN THEIR ENTIRETY INCLUDING RELATED COMPONENTS.
 - REMOVAL OF MECHANICAL, ELECTRICAL, AND PLUMBING SHOULD BE LIMITED TO WHAT IS NECESSARY FOR SAFE REMOVAL OF THE INDICATED WALL OR CEILING. APPROPRIATE LIGHT FIXTURES SHALL BE TEMPORARILY SUSPENDED TO PROVIDE ADEQUATE LIGHTING LEVELS FOR CONSTRUCTION.
 - CONTRACTOR TO DEMO ALL FIXTURES, CEILINGS, MECHANICAL, PLUMBING, AND ELECTRICAL AS REQUIRED TO COMPLETE THE SCOPE OF WORK OUTLINED WITHIN THE CONSTRUCTION DOCUMENTS.
 - CONTRACTOR TO REPAIR LEVEL EXISTING CONCRETE SUB-FLOOR TO REQUIRED CONDITIONS FOR NEW FLOORING INSTALLATION. CONTRACTOR TO INSURE CONCRETE SUB-FLOOR MOISTURE AND CONTENT & PH LEVELS ARE WITHIN ACCEPTABLE FLOORING MANUFACTURER LEVELS.
 - REPAIR EXISTING CONCRETE SUB-FLOOR TO SMOOTH & LEVEL CONDITION TO RECEIVE NEW FINISHES.
 - ALL ARTWORK TO BE REMOVED AND SALVAGED FOR REINSTALLATION.

- TEMPORARY BARRIERS**
- TEMPORARY CONSTRUCTION BARRIERS SHALL BE 3/8" METAL STUDS AT 16" O.C. WITH 5/8" TYPE 'X' GYPSUM WALLBOARD ON EACH SIDE TO EXTEND TO THE UNDERSIDE OF STRUCTURE ABOVE. PROVIDE NON-DAMAGING SEAL AT INTERSECTION WITH GELING TAPE. ALL SEAMS AND PENETRATION OPENINGS TO PREVENT CONTAMINATION INTO ADJACENT SPACES NOT IN THE AREA OF WORK.
 - TEMPORARY CONSTRUCTION BARRIERS SHALL BE EITHER TYPE I OR TYPE II, AND NOTED ON THE DRAWINGS. TYPE I BARRIERS SHALL BE ANCHORED TO THE FLOORING SURFACE (WHICH IS INTENDED TO BE REPLACED WITH POWER ACTUATED FASTENERS. TYPE II BARRIERS SHALL BE ANCHORED TO THE FLOORING SURFACE (WHICH IS INTENDED TO REMAIN) BY TAPING BOTTOM STUDY TRACK TO FLOOR SURFACE OR BY OTHER METHODS WHICH WILL NOT HARM FLOOR SURFACE.

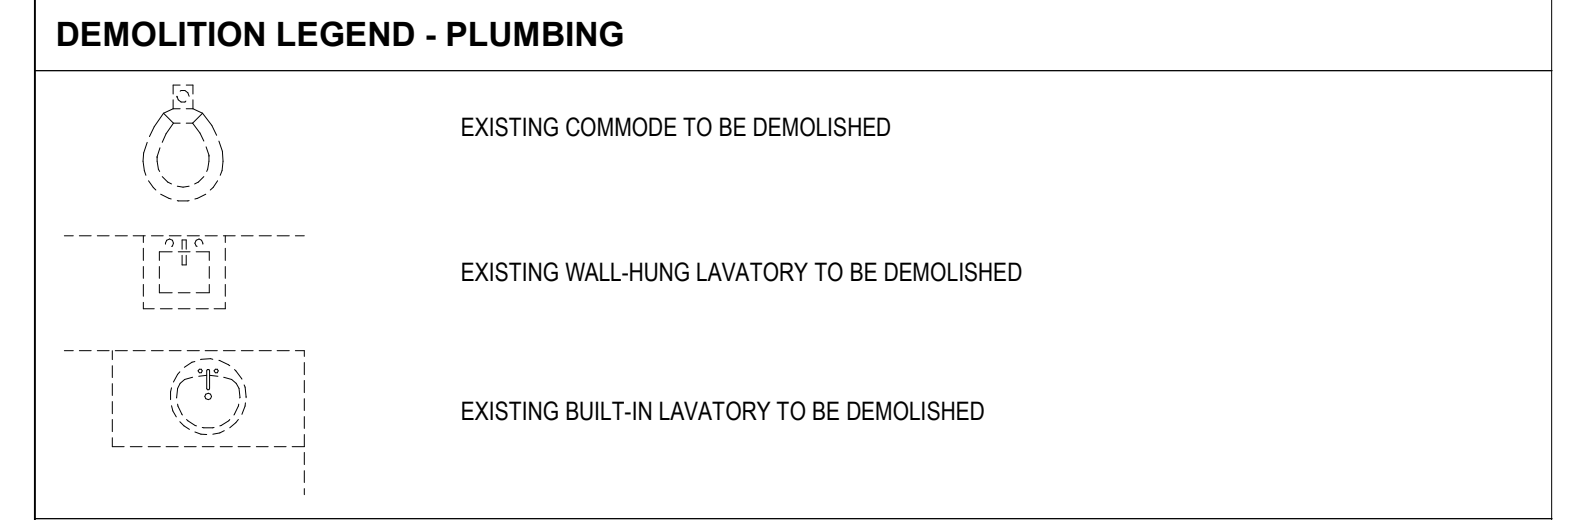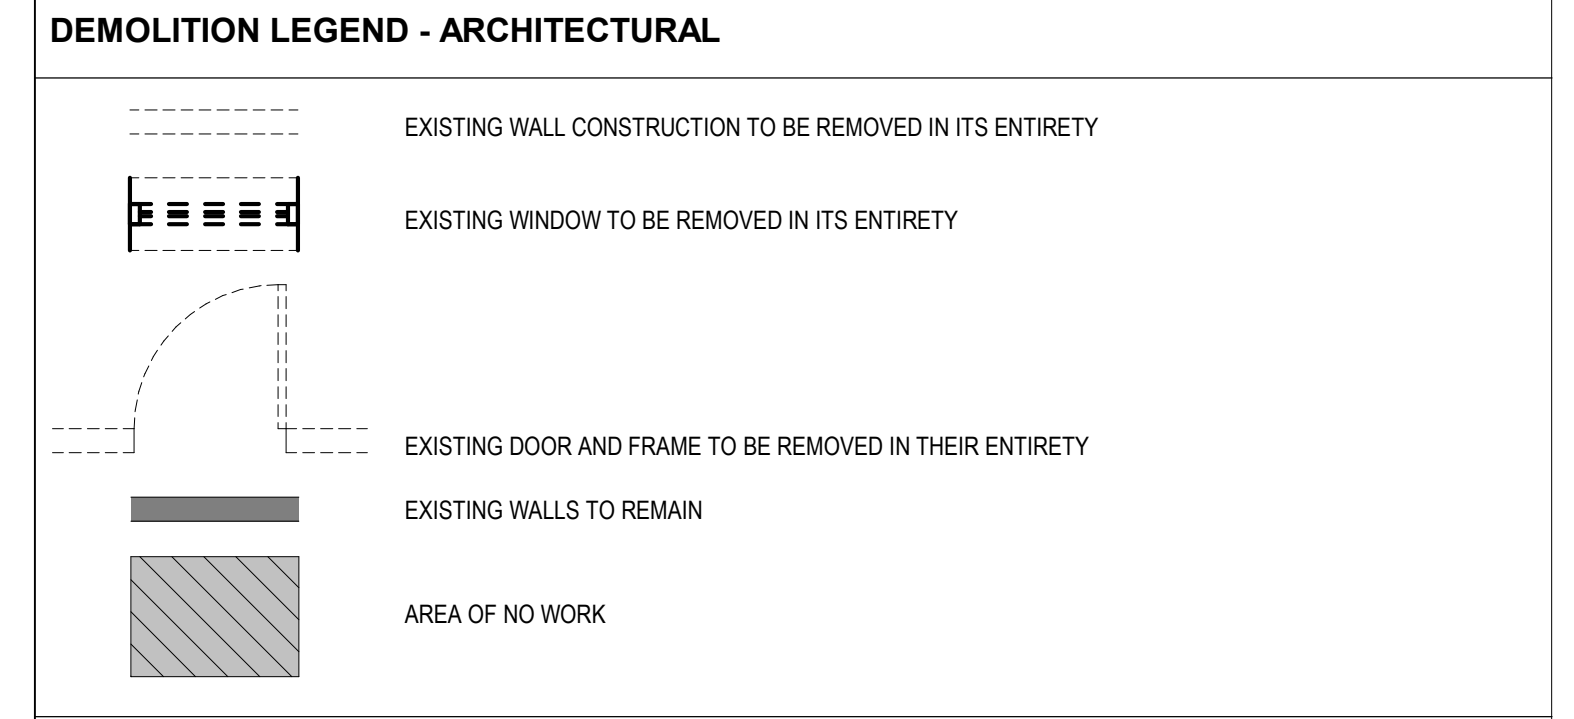


- DEMOLITION KEYNOTES**
- REMOVE EXISTING WALL CONSTRUCTION IN ITS ENTIRETY
 - REMOVE & RETAIN EXISTING DOOR & FRAME. SALVAGED DOOR & FRAMES TO BE RETURNED TO THE VA
 - REMOVE EXISTING PLUMBING FIXTURES AND ASSOCIATED PLUMBING. REFERENCE PLUMBING DRAWINGS
 - REMOVE EXISTING CEILING, LIGHT FIXTURES, DIFFUSERS, AND ELECTRICAL WORK IN THIS AREA. REFERENCE ELEC. & MECH. DRAWINGS
 - REMOVE EXISTING FLOORING IN ITS ENTIRETY. CLEAN & PREPARE SUB-FLOOR SURFACE FOR NEW FLOORING PER RENOVATION PLAN
 - REMOVE EXISTING CASEWORK AND MILLWORK IN ITS ENTIRETY
 - REMOVE EXISTING HANDRAIL, CRASH RAIL & WALL PROTECTION
 - REMOVE EXISTING BATHROOM PARTITION
 - REMOVE INTERIOR WALL FINISH TO INTERIOR FACE OF MANSORY
 - REMOVE EXISTING WINDOW / LOUWER
 - REMOVE EXISTING MASONRY BELOW WINDOW AS INDICATED - SAW CUT AT JAMBS FOR CLEAN CONDITION
 - REMOVE EXISTING WALL FINISH AND BASE - PREPARE SURFACE FOR NEW FINISH
 - EXISTING WINDOW TO REMAIN - CONTRACTOR TO PROTECT DURING CONSTRUCTION
 - PROTECT EXISTING EXPANSION JOINT
 - COORDINATE WALL REMOVAL WITH I.T.
 - REMOVE MASONRY AS INDICATED
 - PREPARE EXISTING DOOR FOR NEW FINISHES

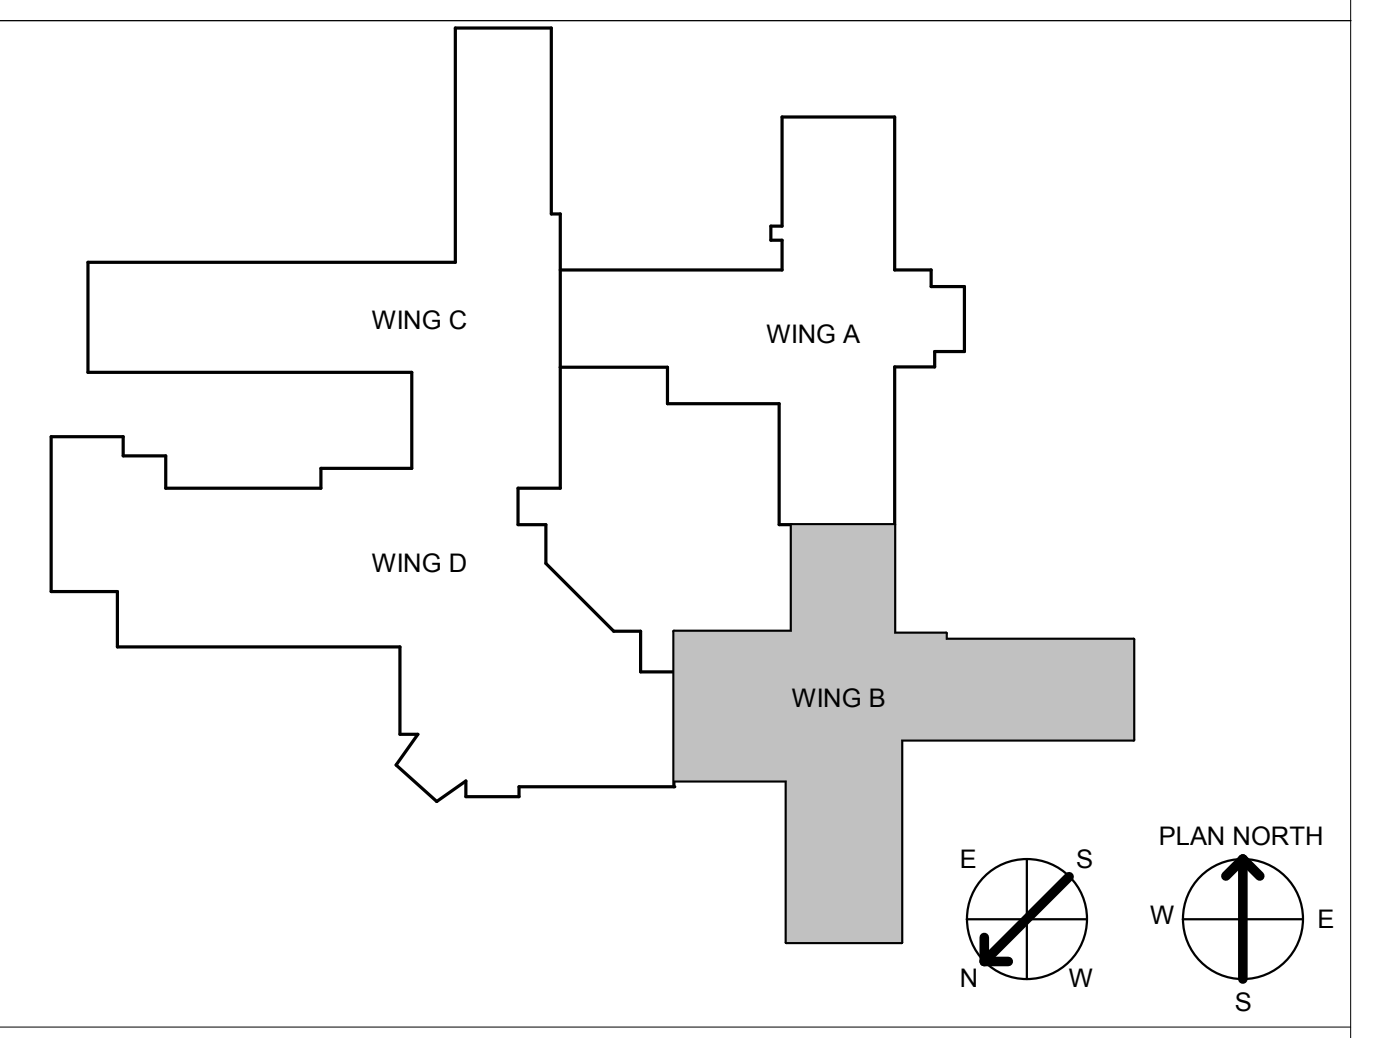


CONSULTANT INFORMATION			ARCHITECT		Office of Construction and Facilities Management		SHEET TITLE WING B - DEMO FLOOR PLAN		PROJECT PHASE BID DOCUMENTS		PROJECT TITLE RENOVATE A & B WING BUILDING 6		VA PROJECT NUMBER 589A5-19-116			
STRUCTURAL / CIVIL ENGINEER STAND STRUCTURAL ENGINEERING 11227 W. 112TH STREET, SUITE 200 OVERLAND PARK, KS 66210 (913) 214-2169			MECHANICAL / ELECTRICAL / PLUMBING / TECHNICAL ENGINEER SPUR DESIGN 11020 KING STREET, SUITE 350 OVERLAND PARK, KS 66210 (405) 842-6100		FIRE PROTECTION ENGINEER PEOPLE FIRE PROTECTION, INC. 19910 W. 161ST STREET OLATH, KS 66062 (913) 829-8650		 513 SW 23th Street Overland Park, KS 66209 913-214-2169 www.spur-design.com 10000 Ring Street, Suite 300 Overland Park, KS 66209 913-214-2169 www.spur-design.com		APPROVED: PROJECT DIRECTOR 6728 JULY 10, 2019 KANSAS ARCHITECT		FULLY SPRINKLERED		PROJECT LOCATION 2200 SW GAGE BLVD. TOPEKA, KS 66622		BUILDING NUMBER 6	
Revision #			Date			VA U.S. Department of Veteran Affairs		DATE 07/10/2019		CHECKED BY AWM		DRAWN BY JET		DRAWING NUMBER 6-AD-100B		
														Dwg. 12 OF 160		

A
B
C
D
E
F

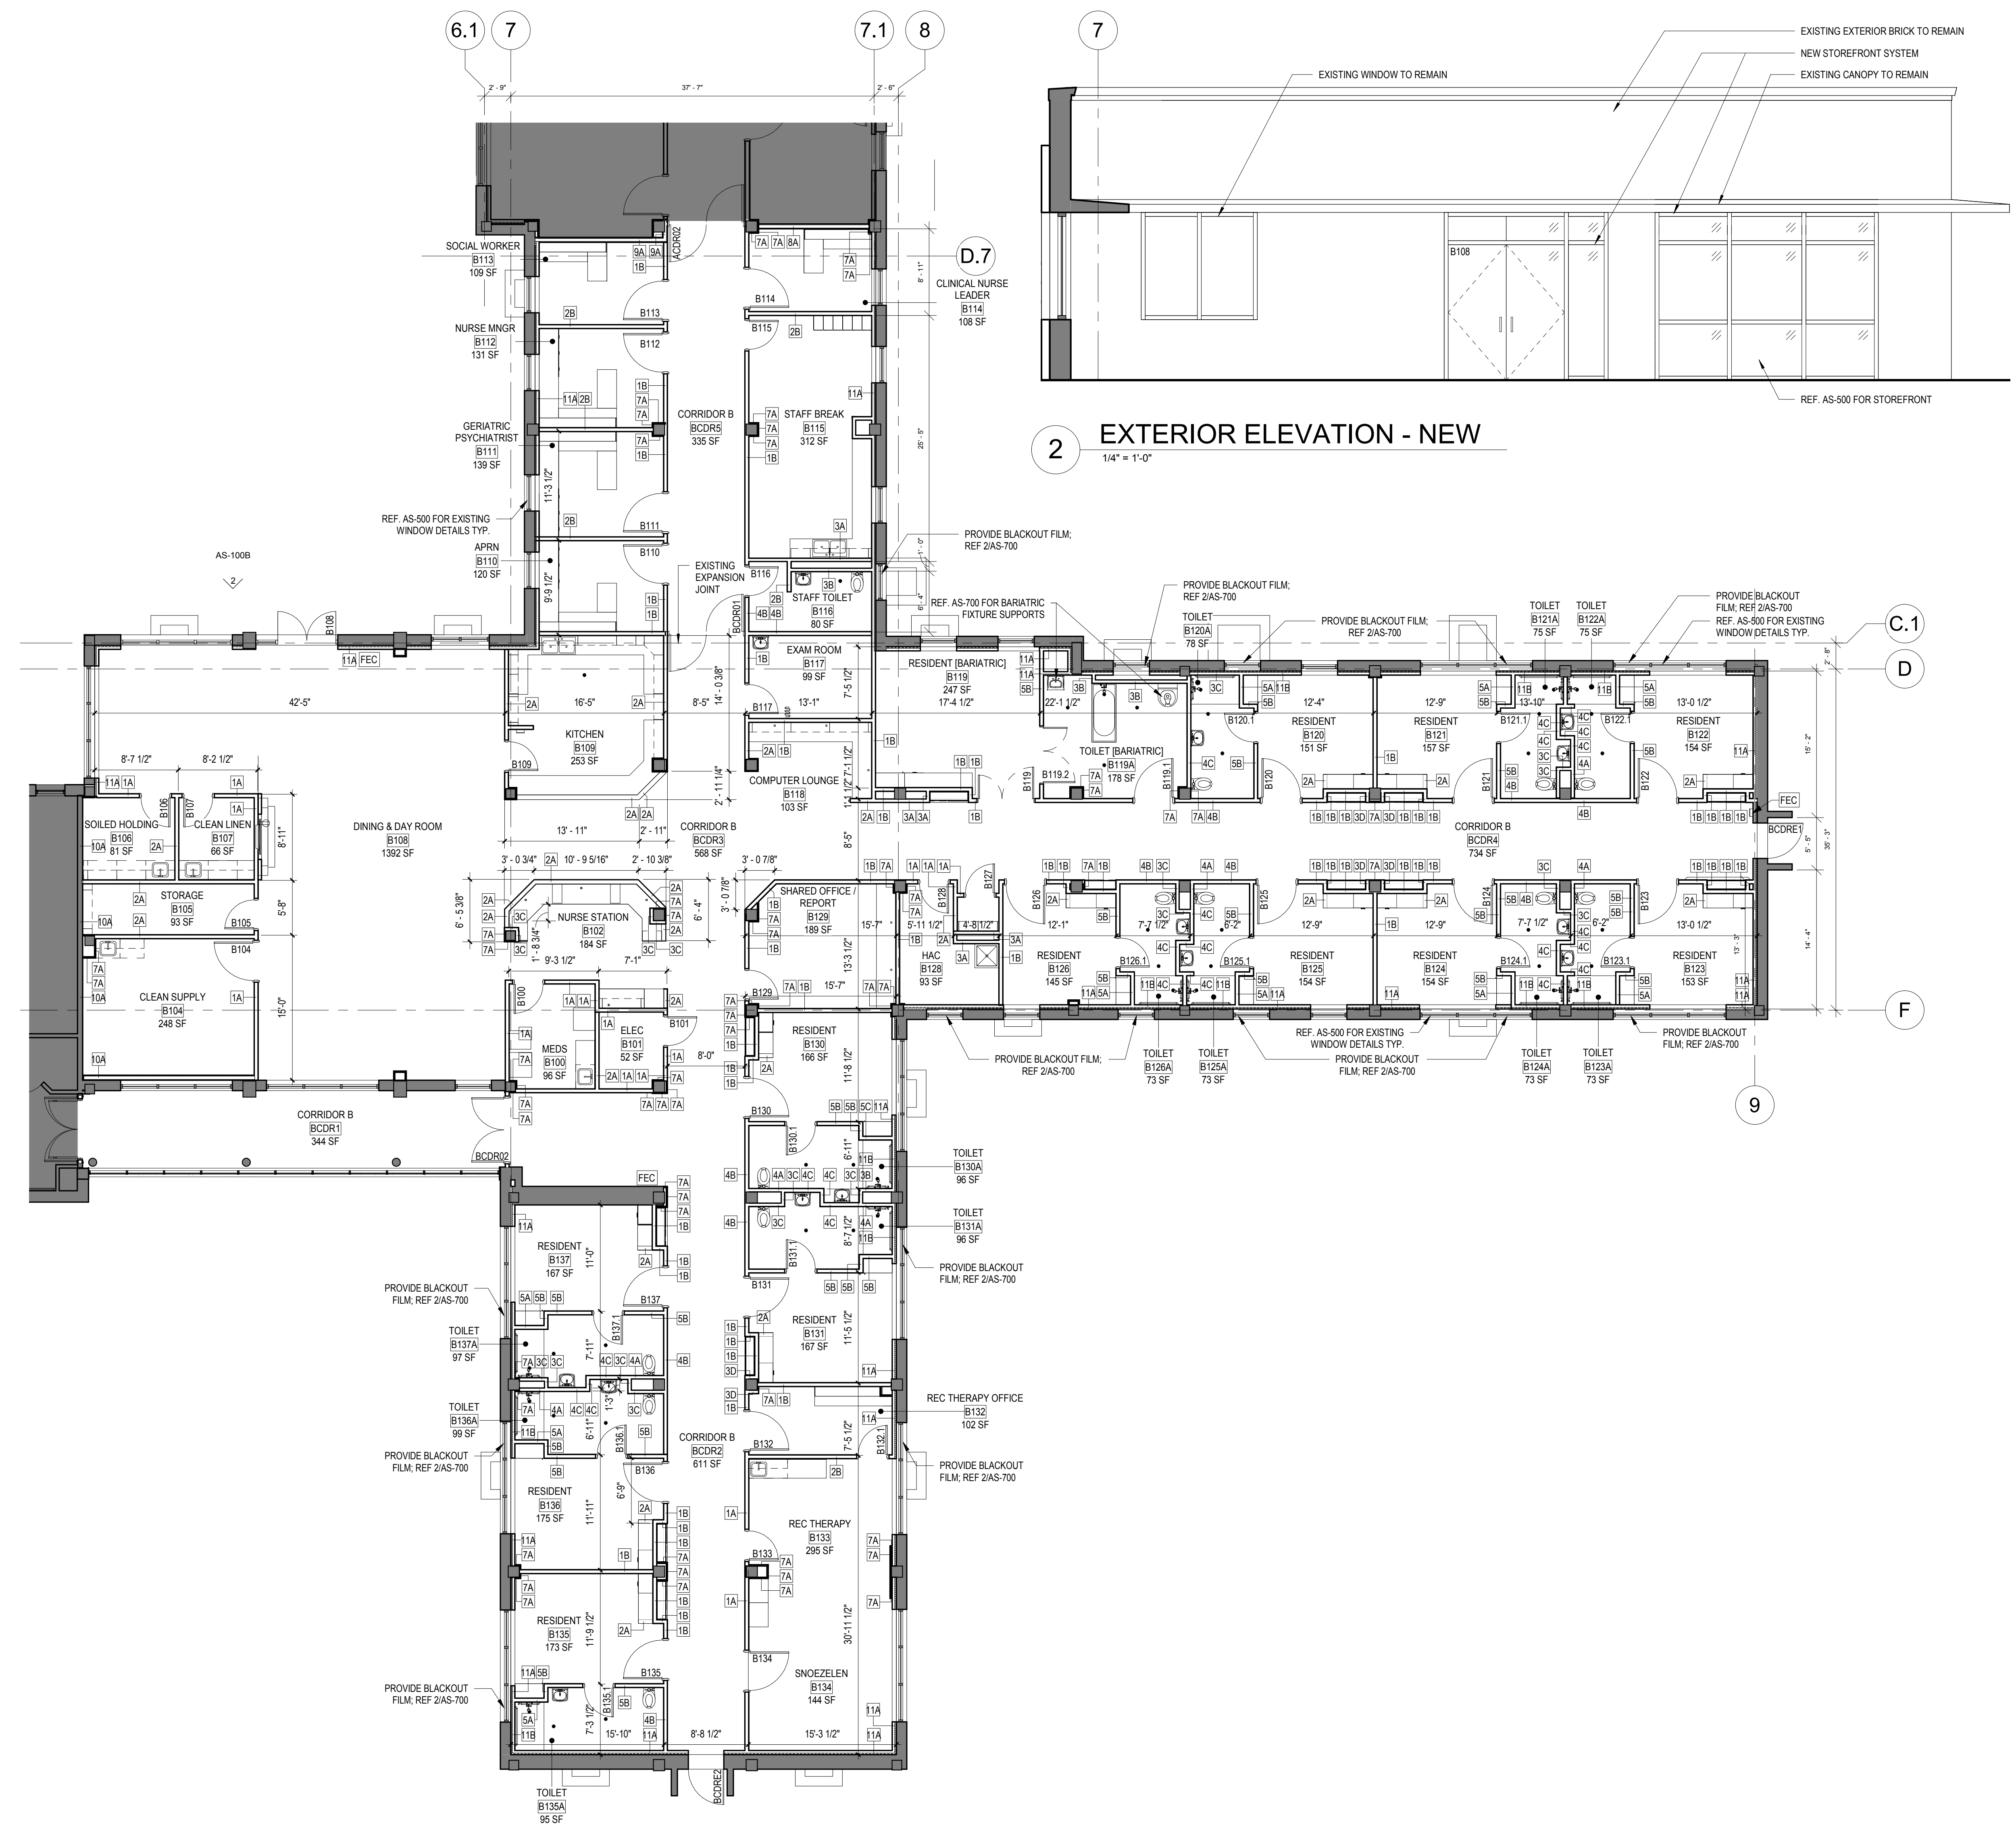

1 WING B - ARCHITECTURAL FLOOR PLAN
1/8" = 1'-0"

2 EXTERIOR ELEVATION - NEW
1/4" = 1'-0"

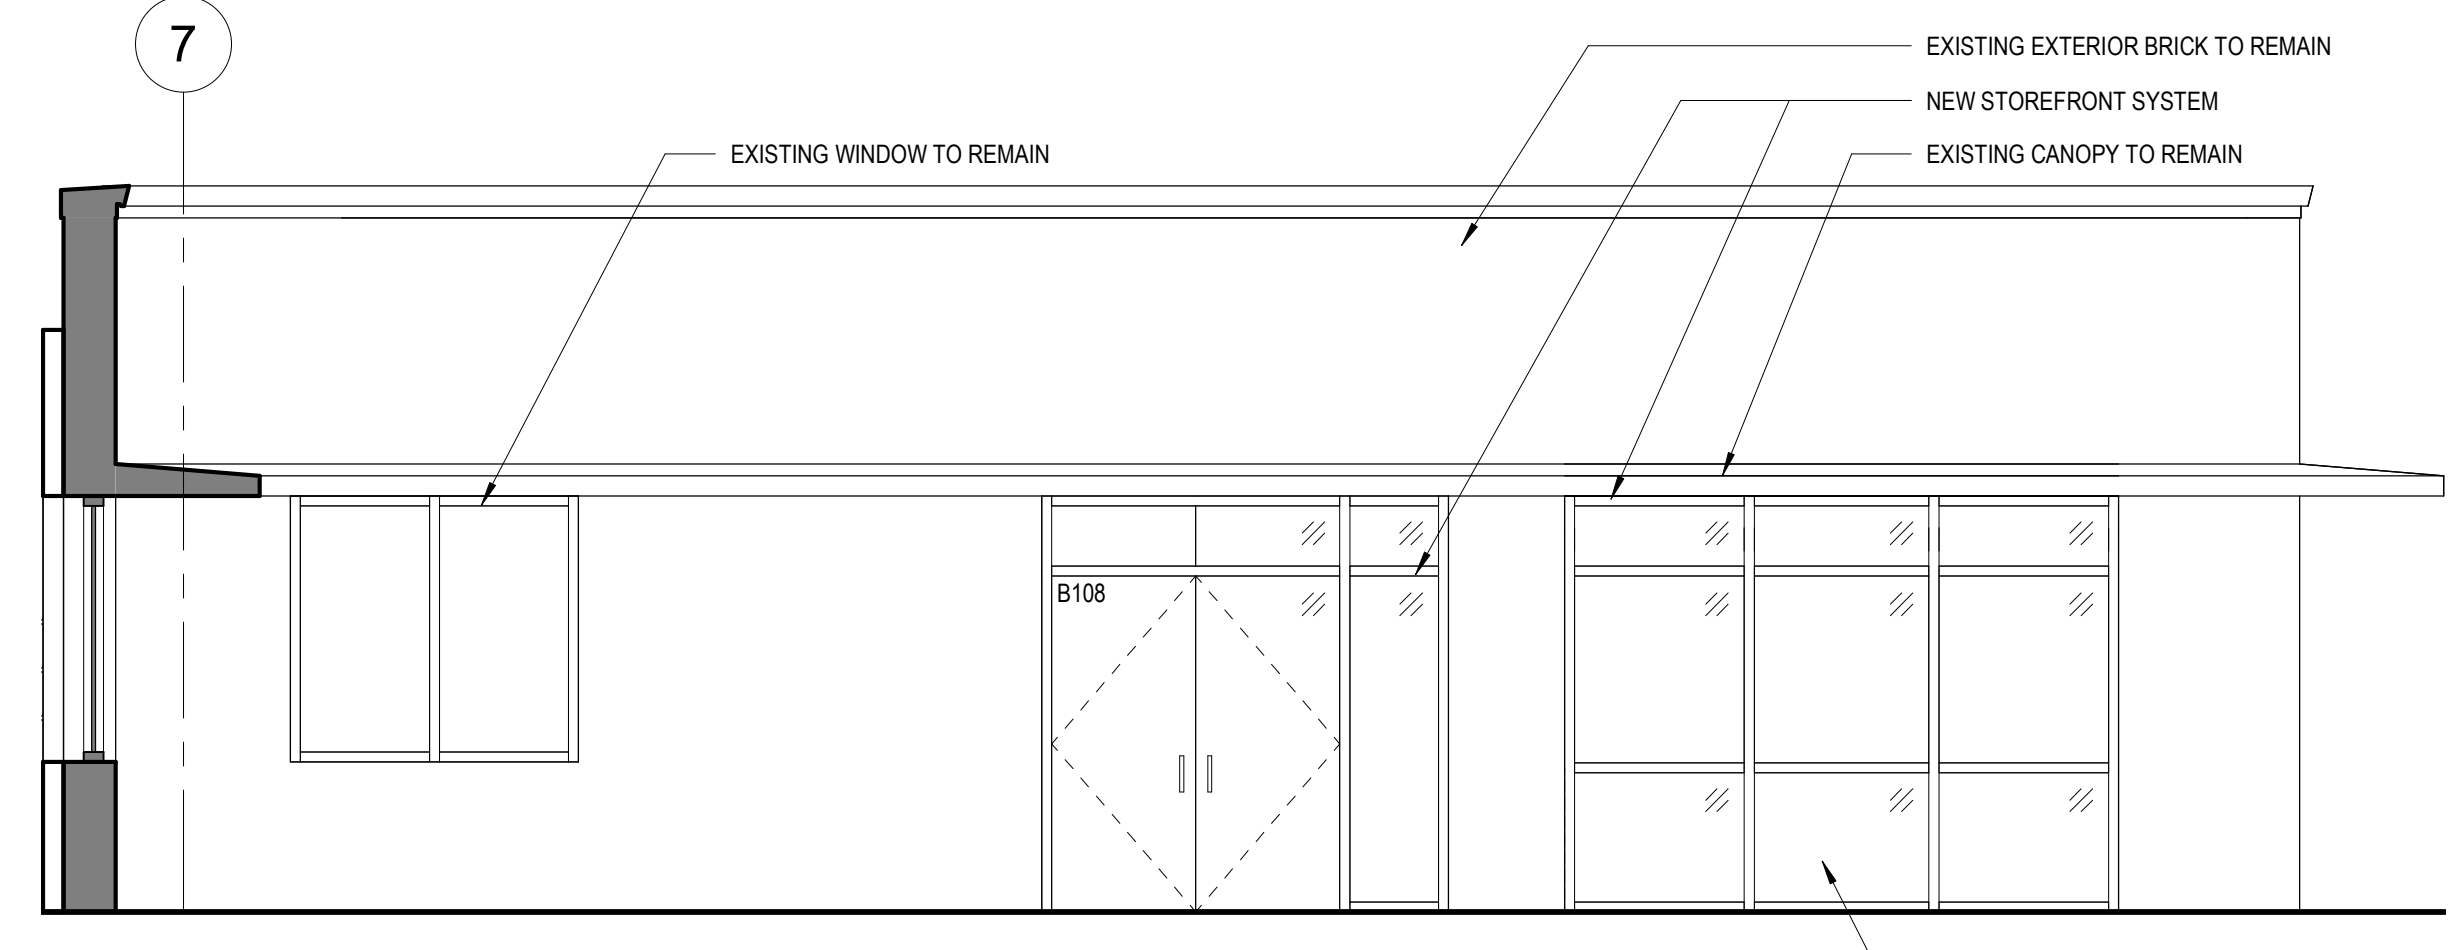


- GENERAL FLOOR PLAN NOTES**
- ALL DOOR FRAMES TO BE LOCATED 2" FROM OUTSIDE OF FRAME TO FINISH FACE OF ADJACENT WALL UNLESS NOTED OTHERWISE.
 - ALL WALLS ARE DIMENSIONED TO FACE OF METAL STUD, UNLESS NOTED OTHERWISE.
 - ALL WINDOWS ARE DIMENSIONED TO OUTSIDE OF WINDOW FRAME, UNLESS NOTED OTHERWISE.
 - REFER TO DOOR SCHEDULE & DETAILS SHEET FOR DOOR INFORMATION.
 - REFER TO GLAZING ELEVATIONS & DETAILS SHEET FOR WINDOW INFORMATION.
 - CORRIDOR WIDTH (FACE TO FACE) TO BE 8'-0".
 - REFER TO FF&E SHEET FOR ENLARGED PLAN CALLOUTS.

- DEDUCT ALTERNATE**
- DEDUCT ALTERNATE 01:** PT/OT DEMOLITION/RENOVATION ONLY; NO WORK AT ALL OTHER WING A AREAS. REFERENCE G1-105 DEDUCT ALTERNATE PLAN FOR ADDITIONAL DETAILS. REFERENCE MECHANICAL, ELECTRICAL, AND PLUMBING DRAWINGS FOR DEDUCT COORDINATION BETWEEN DIVISIONS.

- GENERAL FLOOR PLAN LEGEND**
- DOOR & DOOR NUMBER, RE: DOOR SCHEDULE & DETAIL SHEET AS-601 FOR MORE INFORMATION
 - WALL PARTITION, RE: PARTITION TYPES ON SHEET G1-10
 - PARTITION TAG, RE: PARTITION TYPES ON SHEET G1-10
 - WINDOW TAG, RE: GLAZING & DETAILS ON SHEET AS-602

- KEYED NOTES**
- PROVIDE NEW SMOOTH WALL FINISH AT EXISTING MASONRY WALL ALIGN WITH NEW WALL FINISH
 - PROVIDE EXPANSION JOINT AT CONNECTION BETWEEN EXISTING AND NEW WALL ASSEMBLY
 - REFER DETAIL FOR TYPICAL COLUMN FINISHES

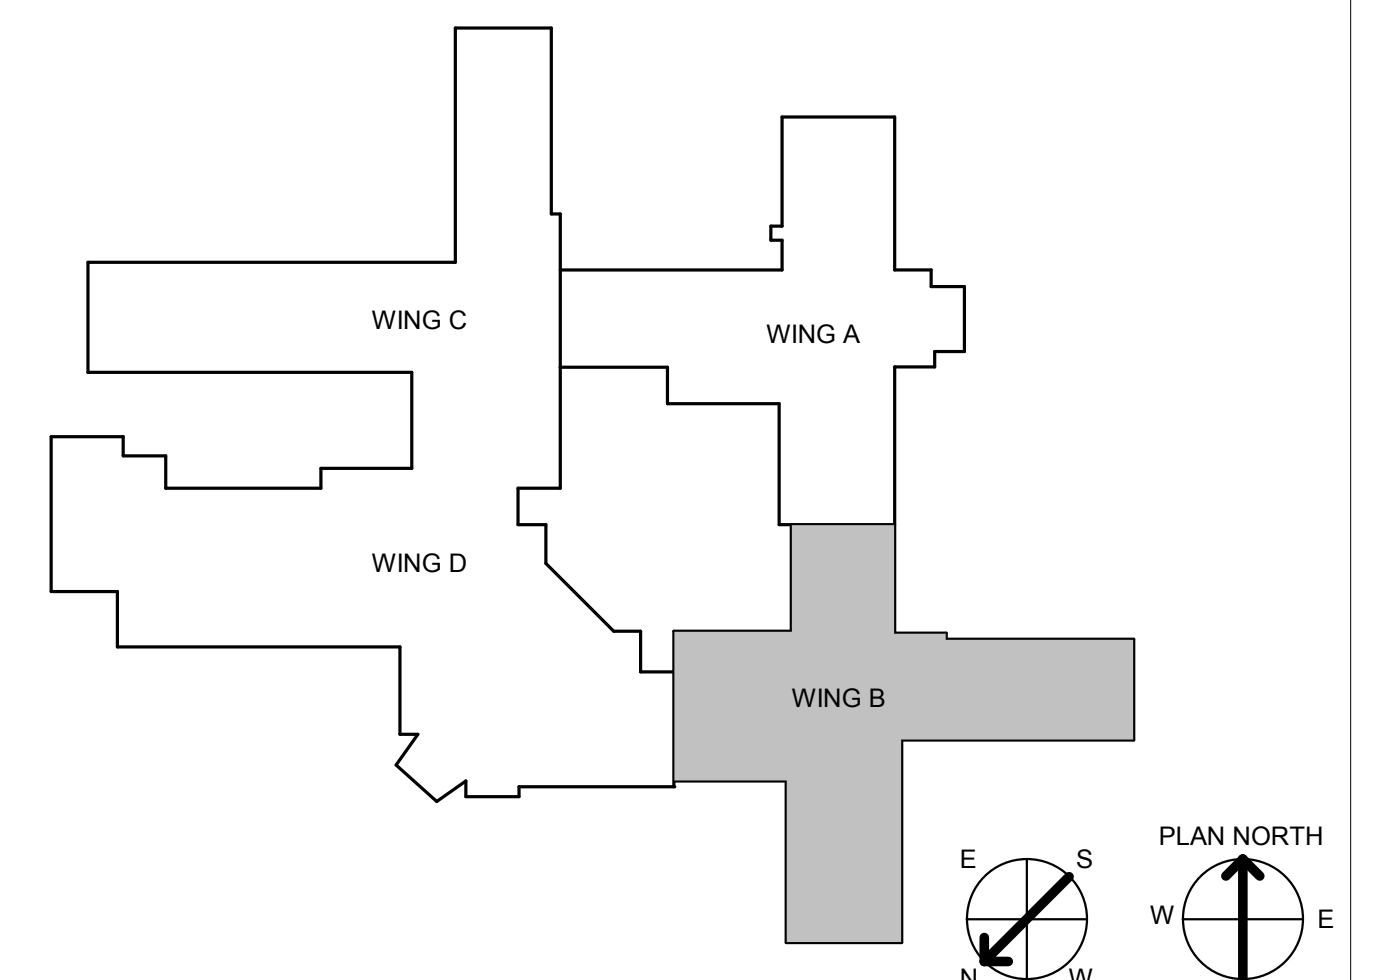


<p>CONSULTANT INFORMATION</p> <p>STRUCTURAL / CIVIL ENGINEER: STAND STRUCTURAL ENGINEERING, 11227 W. 112TH STREET, SUITE 200, OVERLAND PARK, KS 66210 (913) 214-2169</p> <p>MECHANICAL / ELECTRICAL / PLUMBING / TECHNICAL ENGINEER: SPUR DESIGN, 11020 KING STREET, SUITE 350, OVERLAND PARK, KS 66210 (405) 842-6100</p> <p>FIRE PROTECTION ENGINEER: POOLE FIRE PROTECTION, INC., 19910 W. 161ST STREET, OLATH, KS 66062 (913) 829-8650</p>		<p>ARCHITECT</p> <p>SPUR DESIGN</p> <p>312 SW 23rd Street, Overland Park, KS 66209 spur-design.com</p> <p>10020 King Street, Suite 300, Overland Park, KS 66210 spur-design.com</p> <p>KS ARCH REG. NO. A-1139, EXP. 12/31/2019 KS ENGR REG. NO. E-2586, EXP. 12/31/2019</p>		<p>Office of Construction and Facilities Management</p> <p>VA U.S. Department of Veteran Affairs</p>		<p>SHEET TITLE WING B - FLOOR PLAN</p> <p>APPROVED: PROJECT DIRECTOR</p>		<p>PROJECT PHASE BID DOCUMENTS</p> <p>FULLY SPRINKLERED</p>		<p>PROJECT TITLE RENOVATE A & B WING BUILDING 6</p> <p>PROJECT LOCATION 2200 SW GAGE BLVD. TOPEKA, KS 66622</p>		<p>VA PROJECT NUMBER 589A5-19-116</p> <p>BUILDING NUMBER 6</p> <p>DRAWING NUMBER 6-AS-100B</p> <p>Dwg. 14 OF 160</p>	
<p>Revision # Date</p>								<p>DATE: 07/10/2019</p>		<p>CHECKED BY: AWM</p>		<p>DRAWN BY: JET</p>	

GENERAL FURNITURE, FIXTURE & EQUIPMENT NOTES

1. ALL FURNITURE, FIXTURES, AND EQUIPMENT SHOWN OR REFERENCED IN THE CONSTRUCTION DOCUMENTS ARE PROVIDED AS BASIS OF DESIGN INFORMATION. THE CONTRACTOR IS RESPONSIBLE FOR FIELD VERIFICATION, COORDINATION, AND ANY OTHER MANUFACTURER REQUIREMENTS FOR INSTALLATION OR ASSEMBLY OF INDICATED FURNITURE, FIXTURES AND EQUIPMENT.

FURNITURE, FIXTURE, & EQUIPMENT LEGEND

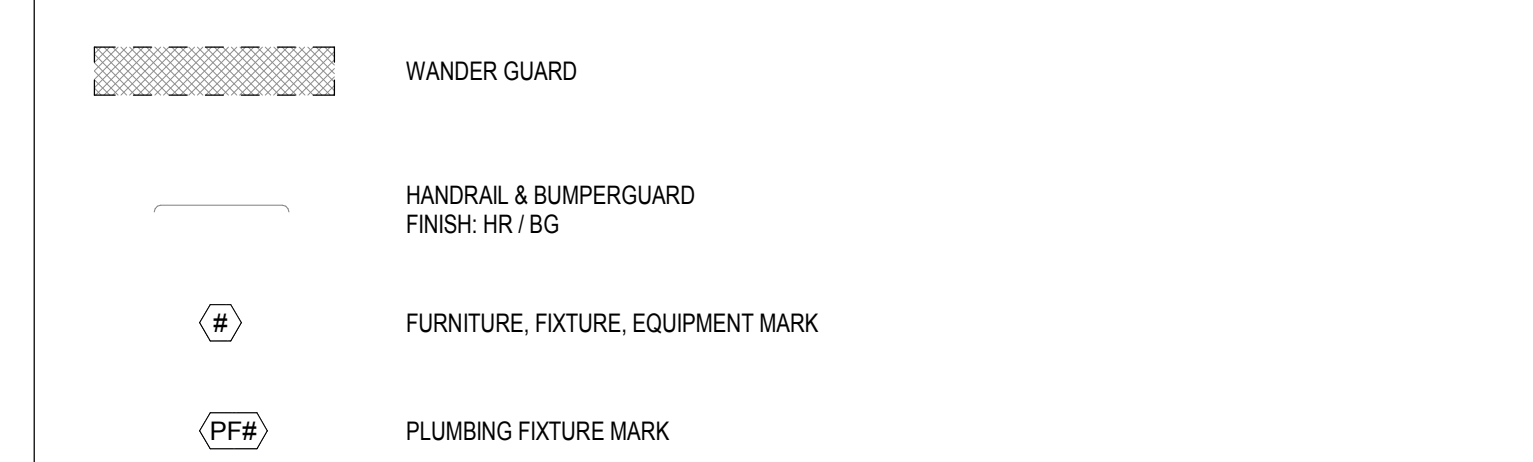



FURNITURE, FIXTURE, & EQUIPMENT SCHEDULES

MARK	FURNITURE/FIXTURE/EQUIPMENT	ACQ / INS	MARK	FURNITURE/FIXTURE/EQUIPMENT	ACQ / INS
1	BABY CHANGING STATION	C / C	86	PHYSIOLOGICAL BIKE SYSTEM	V / V
2	BARIATRIC SHOWER SEAT	C / C	89	PREP TABLE	V / V
3	BARIATRIC HLO MAT	V / V	70	PRINTER/COPIER/FAX COMBO	V / V
4	BASKET, WASTE/PAPER	V / V	71	PULLEY SYSTEM	V / V
5	BOARD, BULLETIN	V / V	72	RACK, MAGAZINE, WALL MOUNTED	V / V
6	BRACKET, TELEVISION, WALL-MNTD, TILT ANGLE	V / V	73	RAIL, ACCESSORY	V / C
7	BREWER, COFFEE	V / V	74	REFRIGERATOR, 48"	C / C
9	CABINET, BEDSIDE	V / V	75	REFRIGERATOR, U.C OR F.S	C / C
10	CART, STORAGE	V / V	76	REFRIGERATOR-FREEZER	C / C
11	CHAIR, DINING	V / V	77	RESIDENT BED	V / V
11	COFFEE TABLE, 52" x 52"	V / V	79	SHELVING, STORAGE	V / V
12	CHAIR, RECLINER	V / V	80	SIDE CHAIR, WITH ARMS	V / V
13	CHAIR, SIDE, BARIATRIC, WITH ARMS	V / V	81	SOFA	V / V
14	CHAIR, SWIVEL, HIGH BACK	V / V	82	SPHYGMOMANOMETER, ANEROID	V / V
15	CHAIR, SWIVEL, LOW BACK	V / V	83	STAIRS, EXISTING VA EQUIP	V / V
16	CLIMBING BOARD AND BAR	V / V	86	STOOL, SELF-ADJUSTING	V / V
17	CLOCK, BATTERY, 12"	V / V	88	TABLE, SELF-ADJUSTING	V / V
18	COLD PACK UNIT, EXISTING VA EQUIP	V / V	89	TABLE LAMP	V / V
19	COMPUTER	V / V	90	TABLE, COFFEE	V / V
20	COMPUTER WITH FLAT PANEL MONITOR	V / V	91	TABLE, COFFEE, 24" x 48"	V / V
21	CONFERENCE CHAIR	V / V	92	TABLE, COMPUTER	V / V
22	CREDENZA	V / V	93	TABLE, EXAM/TREATMENT	V / V
24	CUBICAL TRACK, W/ CURTAIN	C / C	94	TABLE, SIDE	V / V
25	DINING TABLE AND CHAIRS	V / V	95	TELECOMMUNICATION OUTLET	C / C
26	DISHWASHER	C / C	96	TELEPHONE, CONFERENCEING SYSTEM	V / V
27	DISPENSER, GLOVE, SURGICAL-EXAMINATION	V / V	98	TELEPHONE, WALL MOUNTED, 1 LINE	V / V
29	DISPENSER, PAPER CUP, SS	V / V	99	TELEVISION BACKING	C / C
30	DISPENSER, PAPER TOWEL, SENSOR, HANDS FREE	C / C	101	TELEVISION, HDTV, 60"	V / V
31	DISPENSER, SOAP, DISPOSABLE	V / V	102	TRACK, CUBICLE, WITH CURTAIN	C / C
32	DISPENSER, TOILET ROLL	C / C	103	URINAL, SCREEN	C / C
33	DOUBLE BED, BARIATRIC	V / V	104	VIDEO TELECONFERENCEING SYSTEM	V / V
34	DVD PLAYER	V / V	105	WALL HOOK	C / C
35	FIRE EXTINGUISHER CABINET, RECESSED	C / C	106	WASHER / DRYER	V / V
36	FIRE EXTINGUISHER CABINET, SURFACE MOUNT	C / C	107	WASTE DISPOSAL UNIT, SHARPS	V / V
38	FOLD-DOWN GRAB BAR	C / C	108	WHITE BOARD, BULLETIN BOARD COMBINATION	V / V
40	FOLD-DOWN SHOWER SEAT	C / C	109	WINDOW SHADE ROLLER	C / C
43	GRAB BAR	C / C	110	WORKSTATION	V / V
45	HANDRAIL	V / C	111	WORKSTATION, COMPUTER, WALL MOUNTED	V / V
47	HLO TREATMENT TABLE, EXISTING VA EQUIP	V / V	115	HOOD, EXHAUST, NON-COMMERCIAL	C / C
48	HYDRO-CULATOR UNIT, EXISTING VA EQUIP	V / V	116	POPCORN MACHINE	V / V
49	ICE MAKER	C / C	117	ACCORDION WALL	C / C
53	LIGHT, EXAM, MOBILE	V / V	119	METAL LOCKERS	C / C
54	WALL MOUNTED TELEVISION, 32"	V / C	120	RANGE	C / C
59	LOUNGE CHAIR	V / V	121	SUPPORT BRACKET	C / C
57	MEDICAL DISTRIBUTION SYSTEM	V / V	122	WINGBACK CHAIR	V / V
58	MEDICINE BALL RACK	V / V	123	RECESSED CURTAIN TRACK	C / C
59	MEETING TABLE	V / V	124	LOVESEAT	V / V
60	MIRROR, FLOAT GLASS, ADA	C / C	125	ELECTRIC FIREPLACE	C / C
61	MOBILE WEIGHT RACK STORAGE	V / V	126	SOFA TABLE	V / V
62	MUSTER, EXISTING VA EQUIP	V / V	127	PYXIS AUXILIARY CABINET	V / V
63	OTOSCOPE, OPHTHALMOSCOPE	V / V	128	PYXIS CONTROL CABINET	V / V
64	OVEN, MICROWAVE	V / V	129	MED. REFRIGERATOR	V / V
65	PARALLEL BARS, EXISTING VA EQUIP	V / V	130	VIRTUAL AQUARIUM DISPLAY SYSTEM	C / C

MARK	PLUMBING FIXTURE	COMMENTS
PF1	SHOW DRAIN, 3" DIAMETER	
PF2	TOILET, FLOOR-MOUNTED	
PF3	TOILET, FLOOR-MOUNTED, BARIATRIC	REFERENCE AS-700 FOR BARIATRIC FIXTURE SUPPORTS
PF4	DRINKING FOUNTAIN, WITH BOTTLE FILLER	
PF5	SHOWER TRIM	
PF6	OVERFLOW DRAIN, 3" DIAMETER	
PF8	SINK, DROP-IN, 20" x 18"	
PF9	SHOW DRAIN, 3" DIAMETER	
PF10	SINK, DROP-IN, DOUBLE	
PF11	SINK, MOP	
PF12	BATHTUB, WALK-IN	
PF13	LAVATORY, BARIATRIC	REFERENCE AS-700 FOR BARIATRIC FIXTURE SUPPORTS
PF14	TRAP PRIMER	



1 WING A - FURNITURE, FIXTURES, & EQUIPMENT FLOOR PLAN
1/8" = 1'-0"

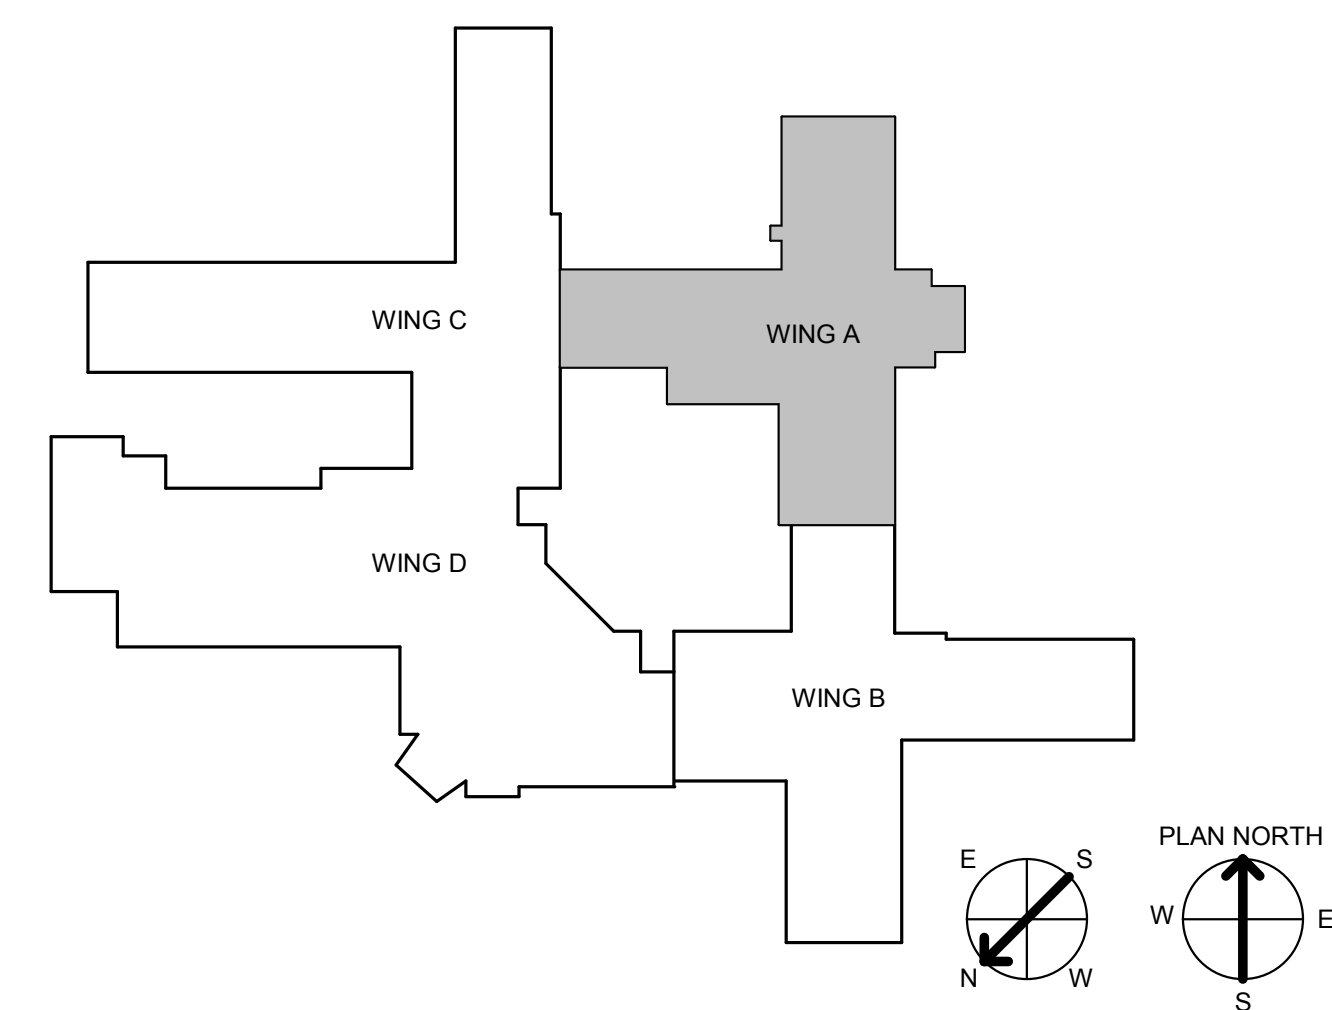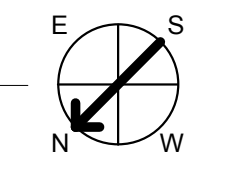


CONSULTANT INFORMATION STRUCTURAL / CIVIL ENGINEER: STAND STRUCTURAL ENGINEERING, 11927 W. 112TH STREET, SUITE 200, OVERLAND PARK, KS 66210 (913) 214-2169 MECHANICAL / ELECTRICAL / PLUMBING / TECHNICAL ENGINEER: SPUR DESIGN, 11020 KING STREET, SUITE 350, OVERLAND PARK, KS 66210 (405) 842-6100 FIRE PROTECTION ENGINEER: POOLE FIRE PROTECTION, INC., 19910 W. 161ST STREET, OLATH, KS 66062 (913) 829-8650		ARCHITECT Office of Construction and Facilities Management VA U.S. Department of Veteran Affairs 		SHEET TITLE: WING A - FF&E FLOOR PLAN APPROVED: PROJECT DIRECTOR		PROJECT PHASE: BID DOCUMENTS FULLY SPRINKLERED		PROJECT TITLE: RENOVATE A & B WING BUILDING 6 PROJECT LOCATION: 2200 SW GAGE BLVD. TOPEKA, KS 66622 DATE: 07/10/2019 CHECKED BY: AWM DRAWN BY: JET		VA PROJECT NUMBER: 589A5-19-116 BUILDING NUMBER: 6 DRAWING NUMBER: 6-AS-101A Dwg. 15 OF 160	
--	--	---	--	---	--	---	--	--	--	--	--

A
B
C
D
E
F



A
B
C
D
E
F

ROOF PLAN KEYNOTE LEGEND

- ① EXISTING ROOF DRAIN
- ② EXISTING VENT THROUGH ROOF
- ③ FLASH NEW ROOF PENETRATION. REPAIR ADJACENT ROOFING AS REQUIRED.
- ④ REPAIR ROOF AT VENT REMOVAL
- ⑤ NEW EXHAUST FAN / PROVIDE FLASHING FOR NEW CURB / REPAIR ADJACENT ROOFING AS REQUIRED.
- ⑥ NEW RTU - REMOVE FLASHING FOR NEW CURB / REPAIR ADJACENT ROOFING AS REQUIRED.
- ⑦ EXISTING CHILLER TO BE REMOVED / PATCH & REPAIR ALL ROOF PENETRATIONS / PATCH & REPAIR ALL ROOF DAMAGE ASSOCIATED WITH CHILLER REMOVAL.

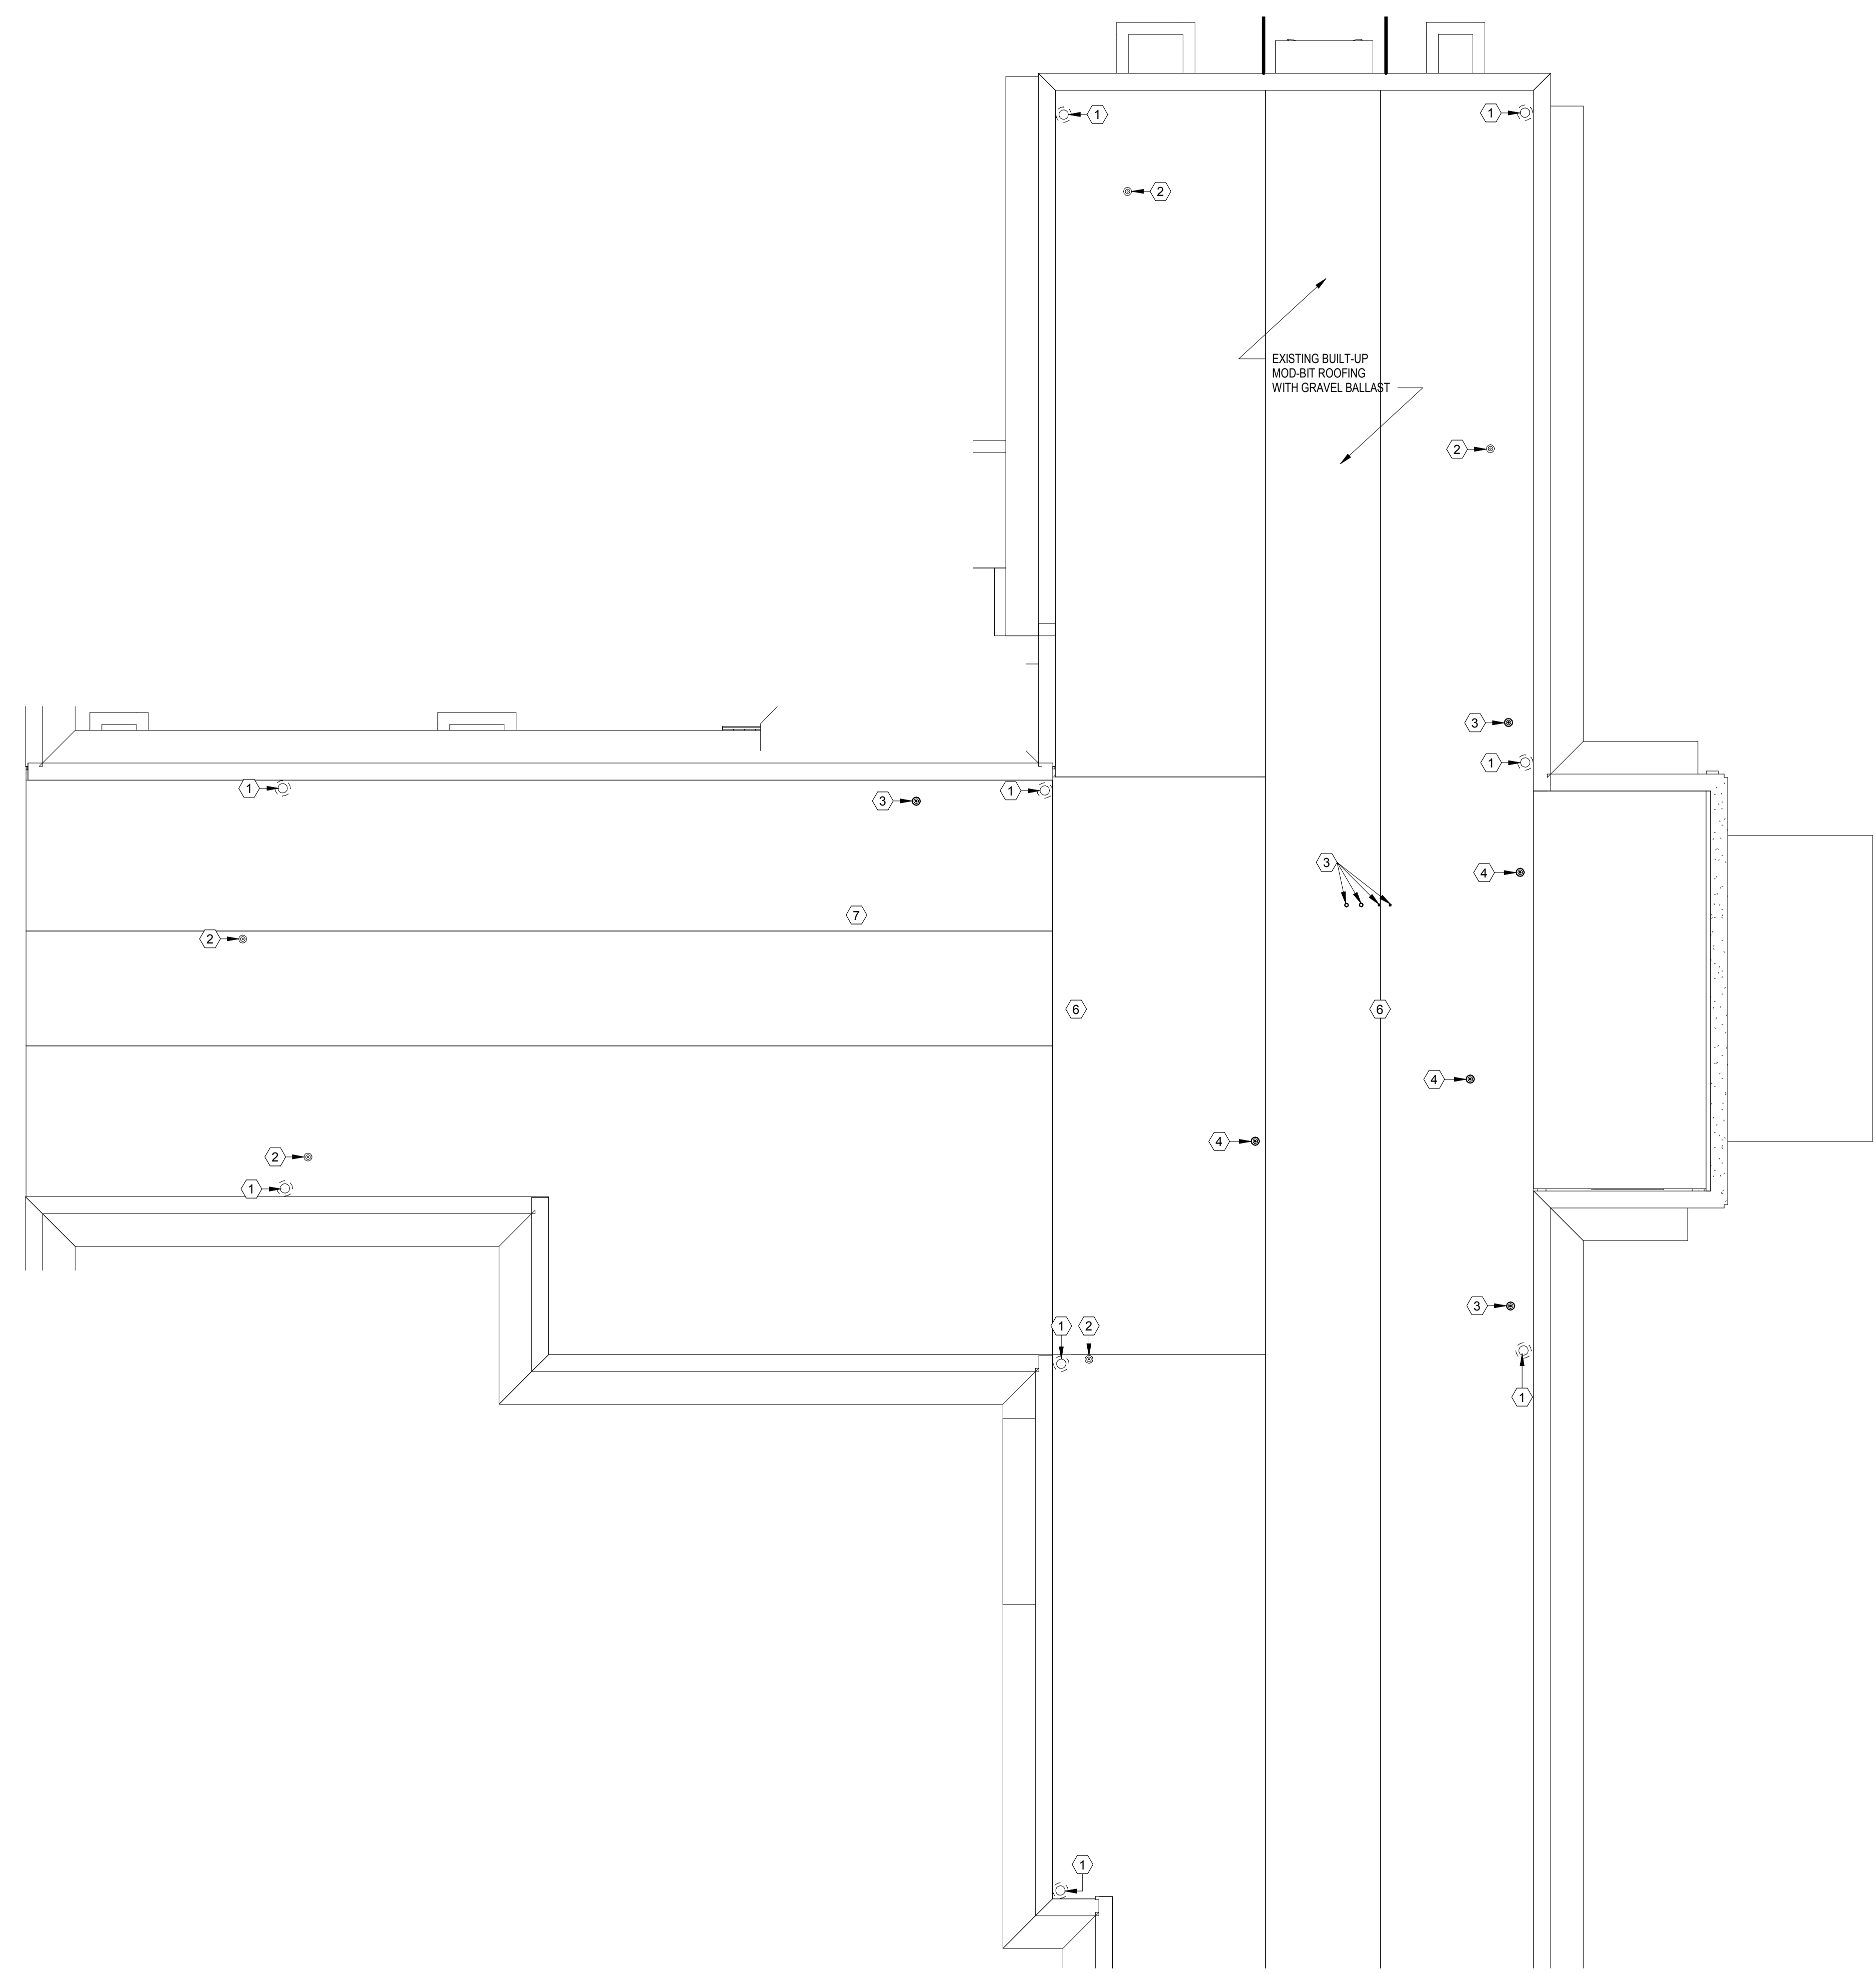

1 WING A - DEMOLITION ROOF PLAN
1/8" = 1'-0"

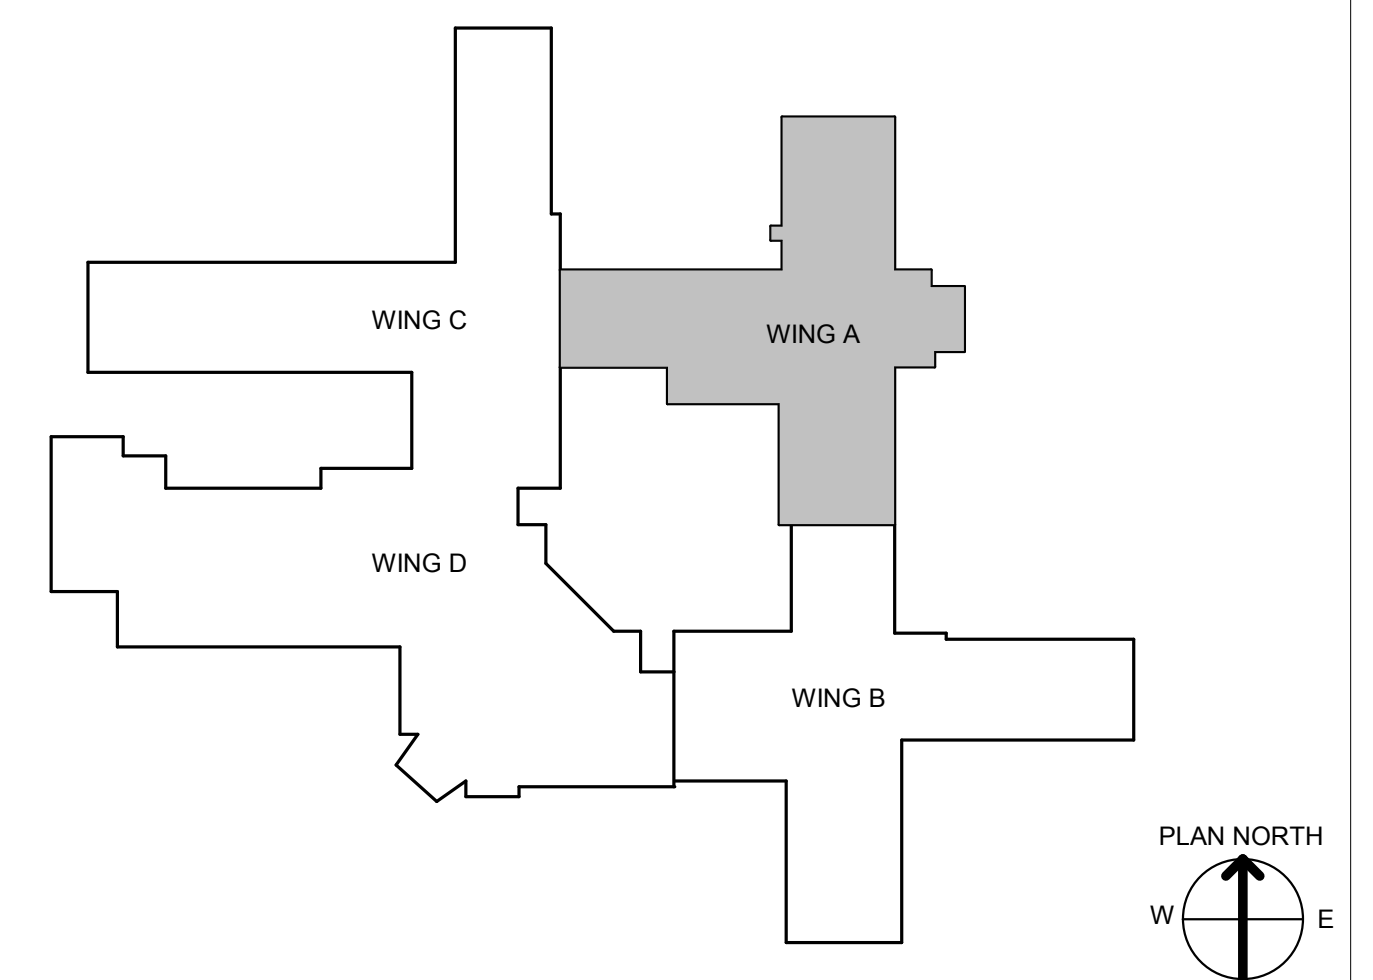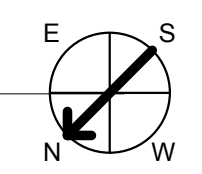


	CONSULTANT INFORMATION	ARCHITECT	Office of Construction and Facilities Management	SHEET TITLE WING A - ROOF PLAN	PROJECT PHASE BID DOCUMENTS	PROJECT TITLE RENOVATE A & B WING BUILDING 6	VA PROJECT NUMBER 589A5-19-116	
	STRUCTURAL / CIVIL ENGINEER STAND STRUCTURAL ENGINEERING 11927 W. 112TH STREET, SUITE 200 OVERLAND PARK, KS 66210 (913) 214-2169	MECHANICAL / ELECTRICAL / PLUMBING / TECHNICAL ENGINEER SPUR DESIGN 11020 KING STREET, SUITE 350 OVERLAND PARK, KS 66210 (405) 842-6100	FIRE PROTECTION ENGINEER POOLE FIRE PROTECTION, INC. 19910 W. 161ST STREET OLATH, KS 66062 (913) 829-8650	APPROVED: PROJECT DIRECTOR 		PROJECT LOCATION 2200 SW GAGE BLVD. TOPEKA, KS 66622	BUILDING NUMBER 6 DRAWING NUMBER 6-AS-110A Dwg. 17 OF 160	
Revision #	Date		VA U.S. Department of Veteran Affairs 		FULLY SPRINKLERED	DATE 07/10/2019	CHECKED BY AWM	DRAWN BY JET



A
B
C
D
E
F

A
B
C
D
E
F


- ROOF PLAN KEYNOTE LEGEND**
- ① EXISTING ROOF DRAIN
 - ② EXISTING VENT THROUGH ROOF
 - ③ FLASH NEW ROOF PENETRATION. REPAIR ADJACENT ROOFING AS REQUIRED.
 - ④ REPAIR ROOF AT VENT REMOVAL
 - ⑤ NEW EXHAUST FAN / PROVIDE FLASHING FOR NEW CURB / REPAIR ADJACENT ROOFING AS REQUIRED.
 - ⑥ NEW RTU - REMOVE FLASHING FOR NEW CURB / REPAIR ADJACENT ROOFING AS REQUIRED.
 - ⑦ EXISTING CHILLER TO BE REMOVED / PATCH & REPAIR ALL ROOF PENETRATIONS / PATCH & REPAIR ALL ROOF DAMAGE ASSOCIATED WITH CHILLER REMOVAL.

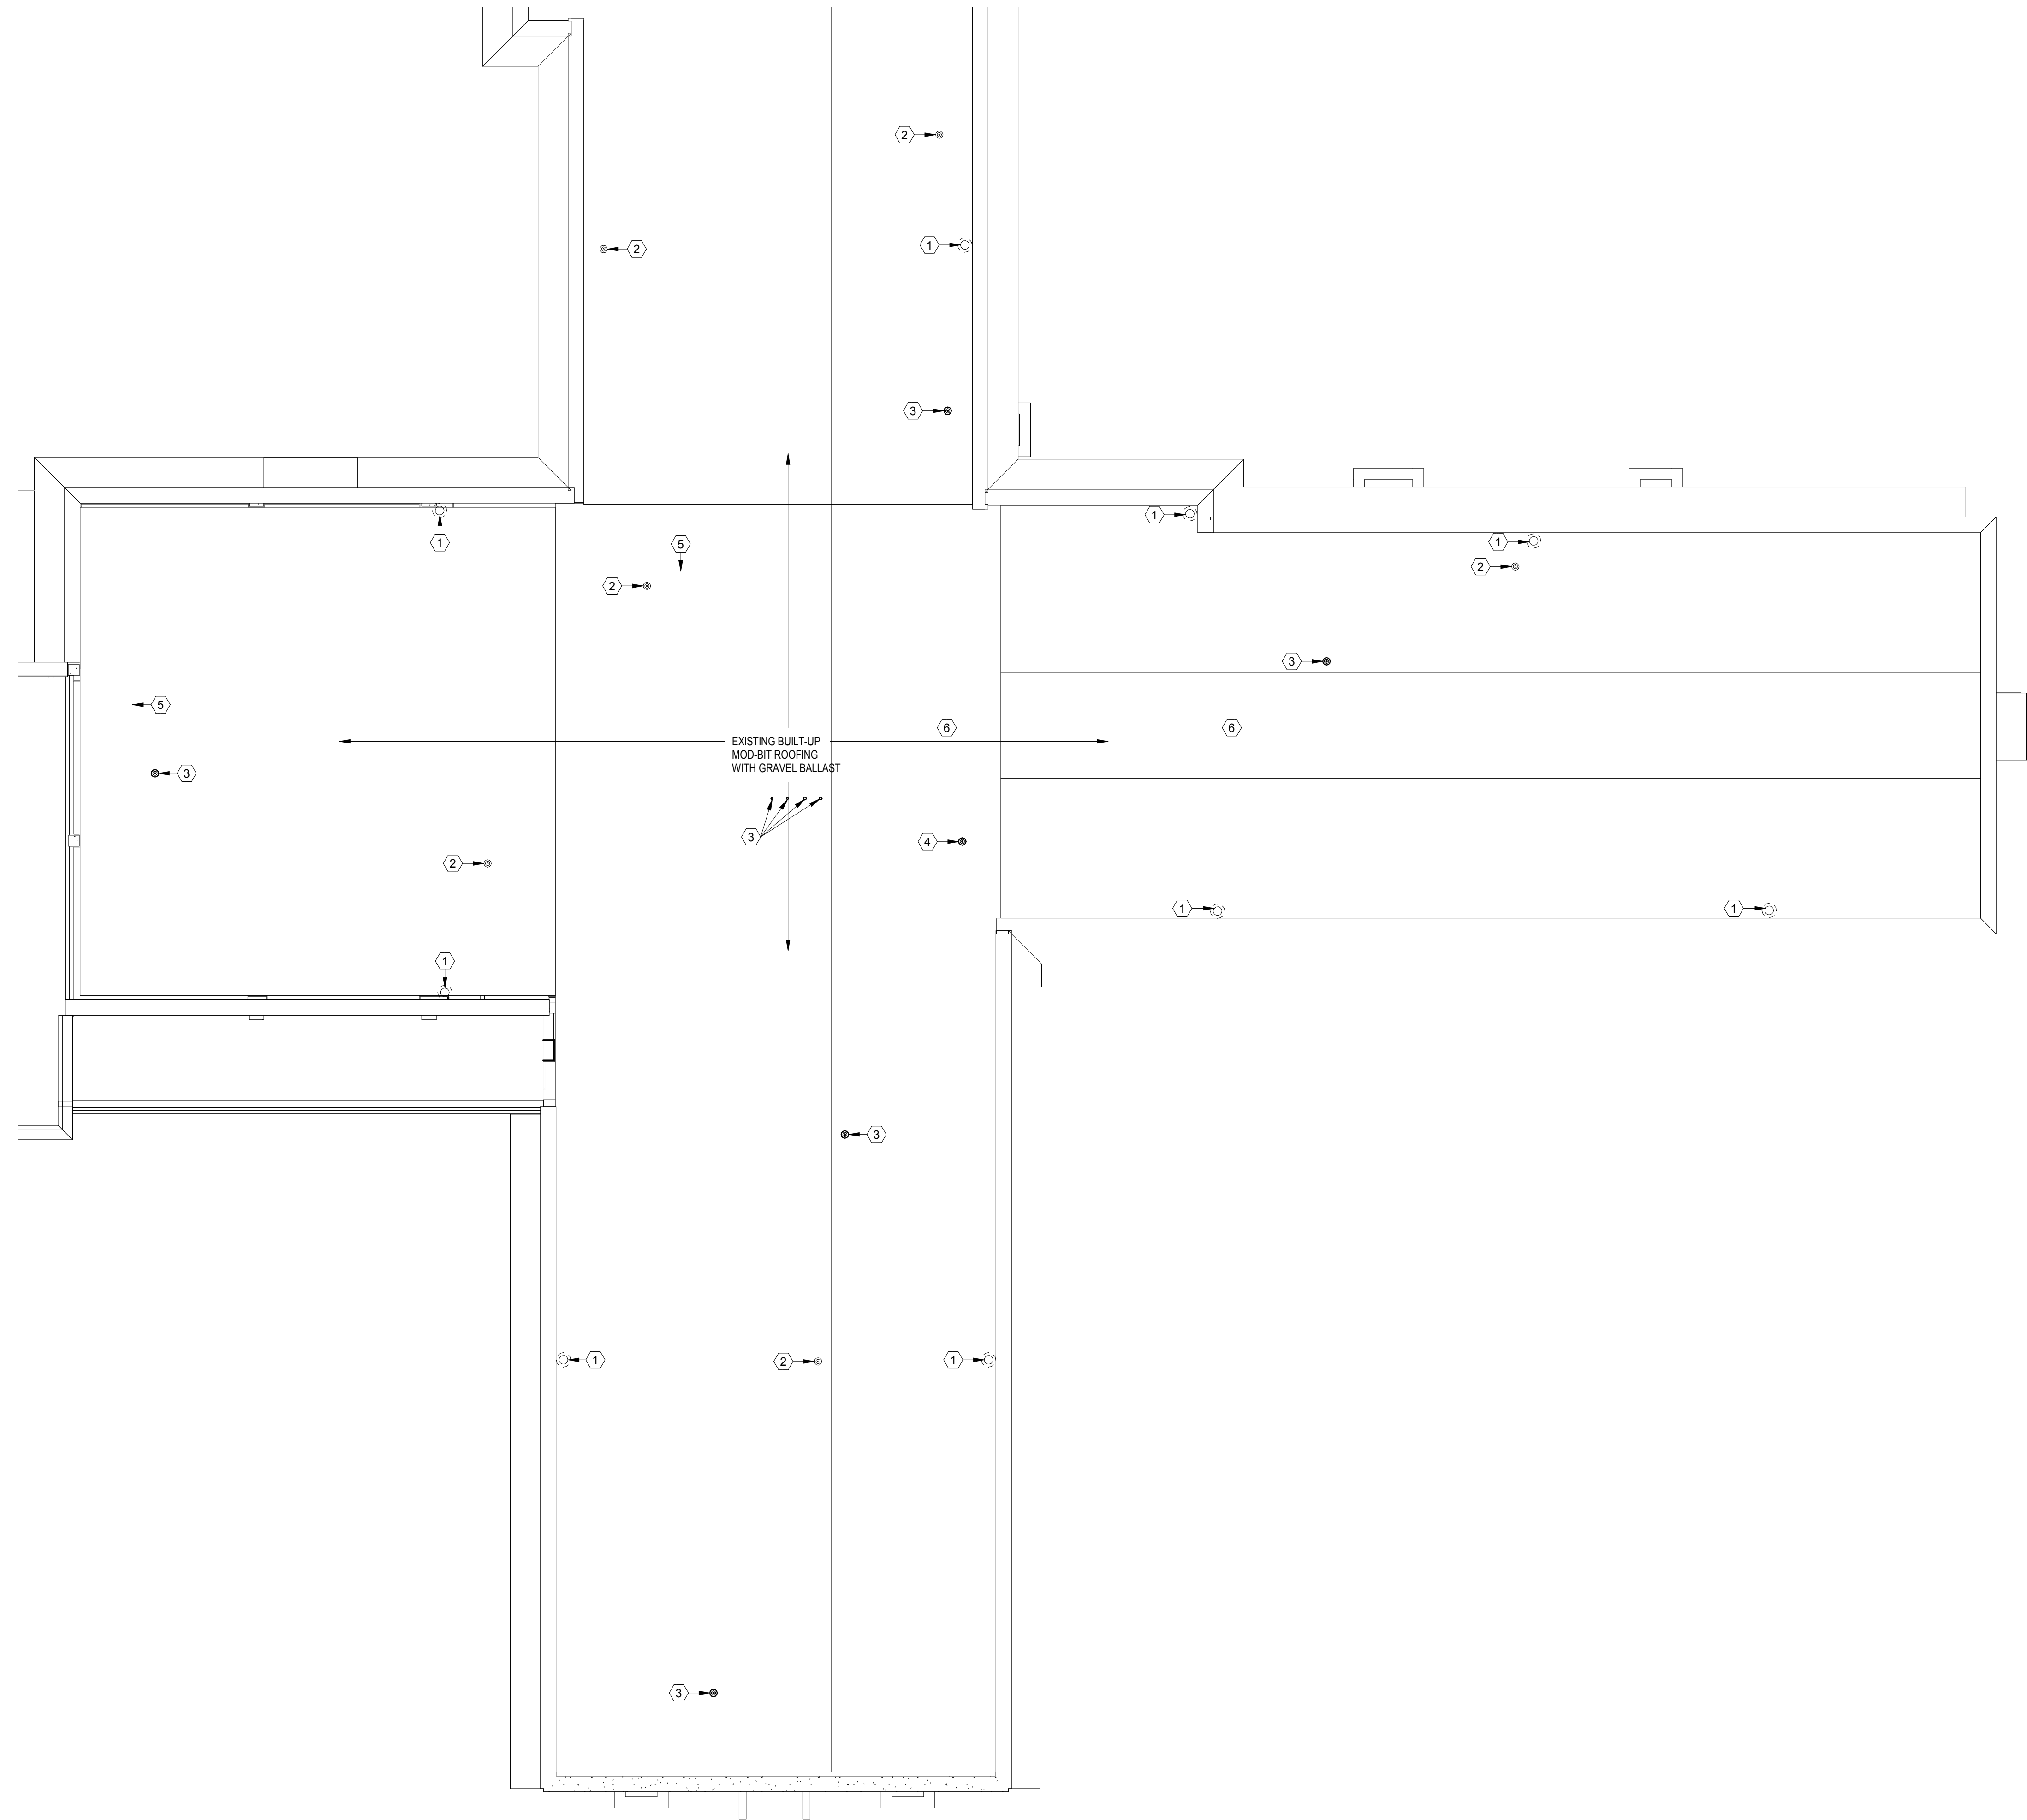


1 WING B - DEMOLITION ROOF PLAN
1/8" = 1'-0"

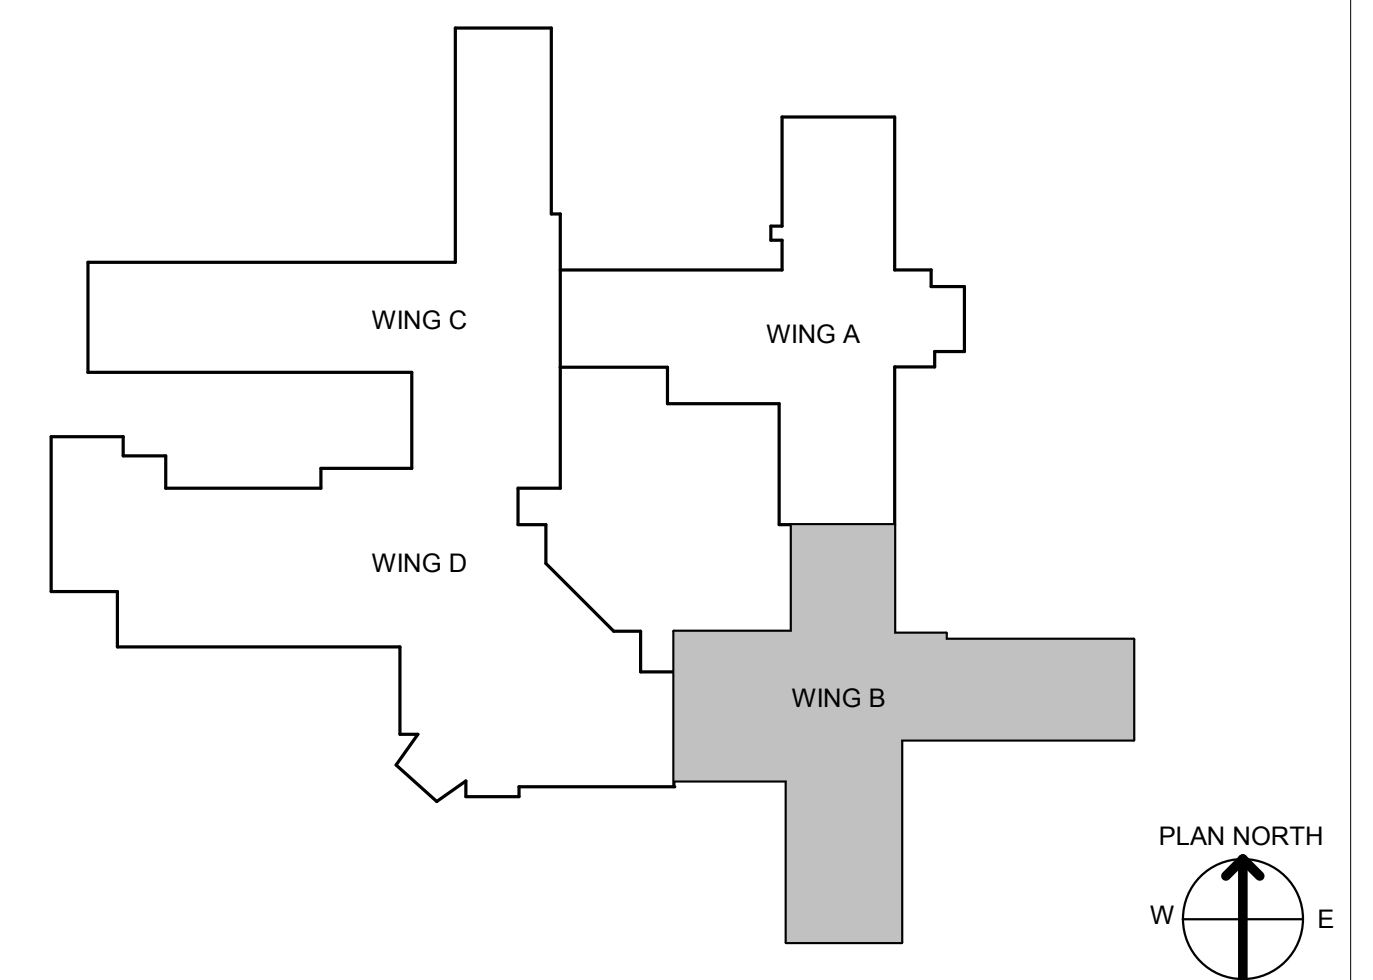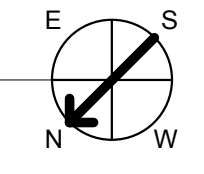


<p>Revision # Date</p>		<p>CONSULTANT INFORMATION</p> <p>STRUCTURAL / CIVIL ENGINEER MECHANICAL / ELECTRICAL / PLUMBING / TECHNICAL ENGINEER FIRE PROTECTION ENGINEER</p> <p>STAND STRUCTURAL ENGINEERING 11827 W. 112TH STREET, SUITE 200 OVERLAND PARK, KS 66210 (913) 214-2169 SPUR DESIGN 11020 KING STREET, SUITE 350 OVERLAND PARK, KS 66210 (405) 842-6100 POOLE FIRE PROTECTION, INC. 19910 W. 161ST STREET OLATH, KS 66062 (913) 829-8650</p>			<p>ARCHITECT</p> <p>SPUR DESIGN</p> <p>512 5th Street Overland Park, KS 66109 spur-design.com 11020 King Street, Suite 300 Overland Park, KS 66210 spur-design.com</p> <p>KS ARCH REG. NO. A-1139, EXP. 12/31/2019 KS ENGR REG. NO. E-2586, EXP. 12/31/2019</p>		<p>Office of Construction and Facilities Management</p> <p>VA U.S. Department of Veteran Affairs</p>		<p>SHEET TITLE WING B - ROOF PLAN</p> <p>APPROVED: PROJECT DIRECTOR</p>		<p>PROJECT PHASE BID DOCUMENTS</p> <p>FULLY SPRINKLERED</p>		<p>PROJECT TITLE RENOVATE A & B WING BUILDING 6</p> <p>PROJECT LOCATION 2200 SW GAGE BLVD. TOPEKA, KS 66622</p> <p>DATE 07/10/2019</p>		<p>VA PROJECT NUMBER 589A5-19-116</p> <p>BUILDING NUMBER 6</p> <p>DRAWING NUMBER 6-AS-110B</p> <p>Dwg. 18 OF 160</p>	
									<p>CHECKED BY AWM</p>		<p>DRAWN BY JET</p>					

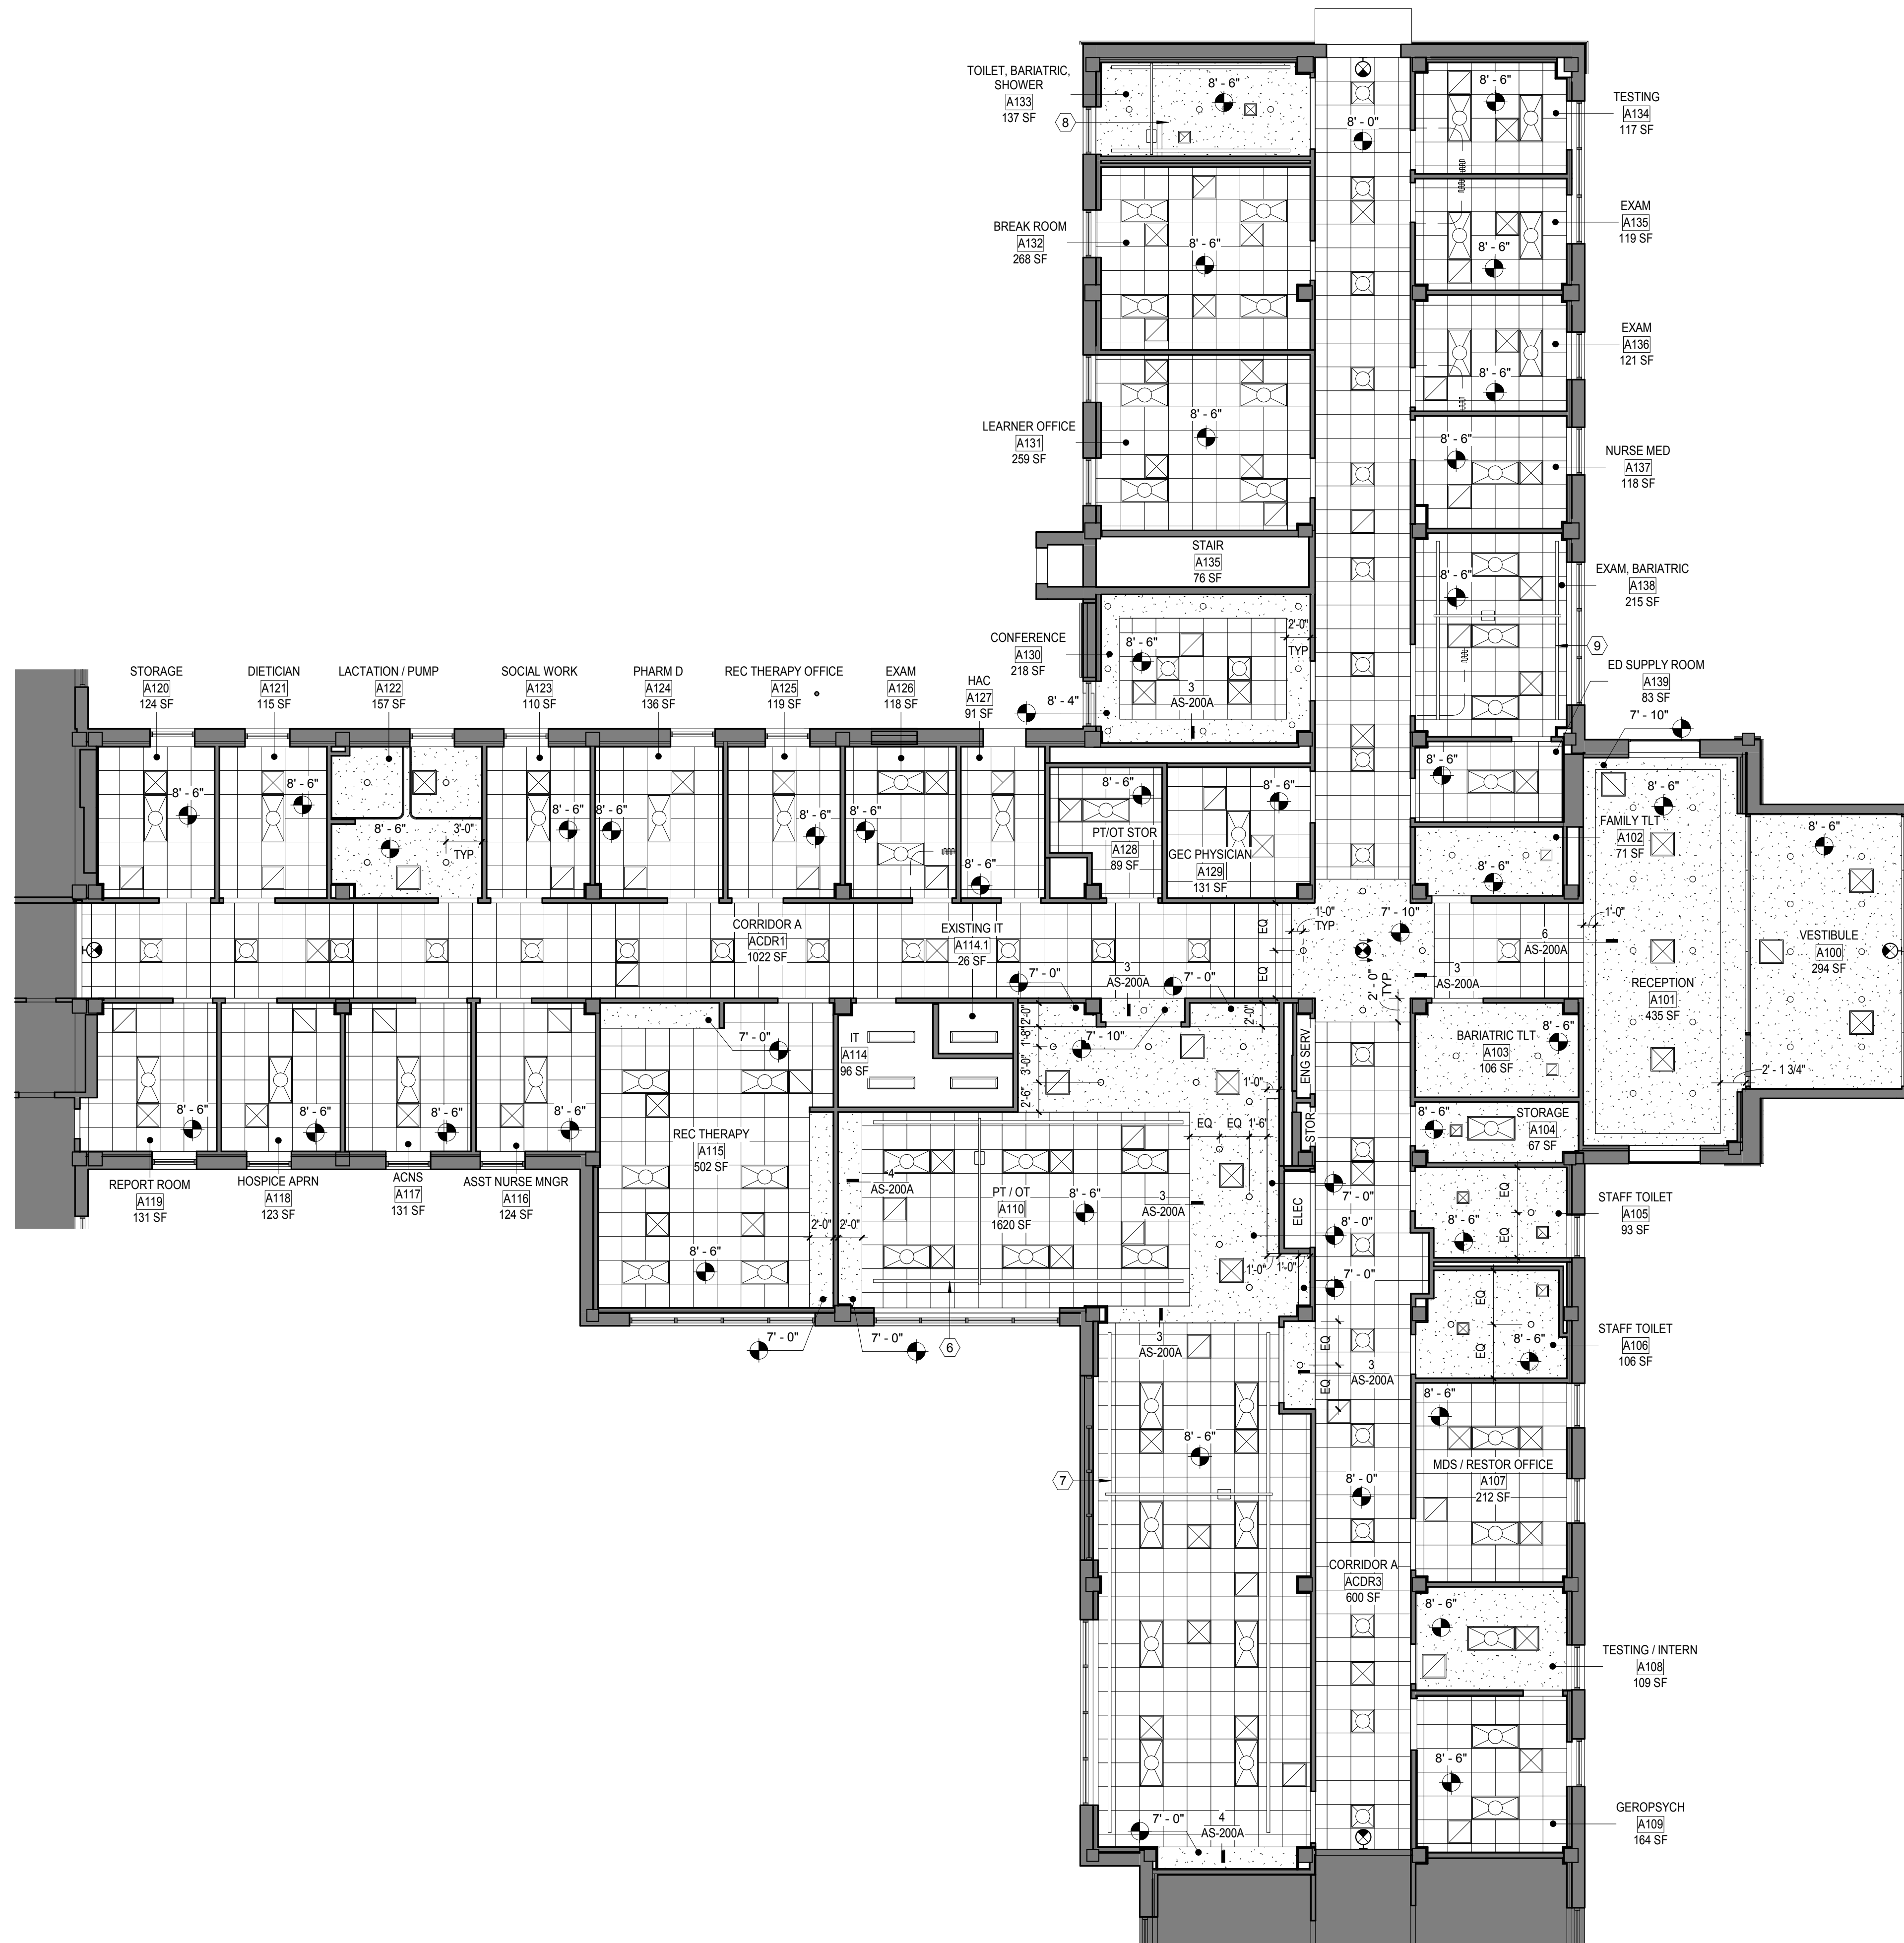


1 WING A - REFLECTED CEILING PLAN
1/8" = 1'-0"

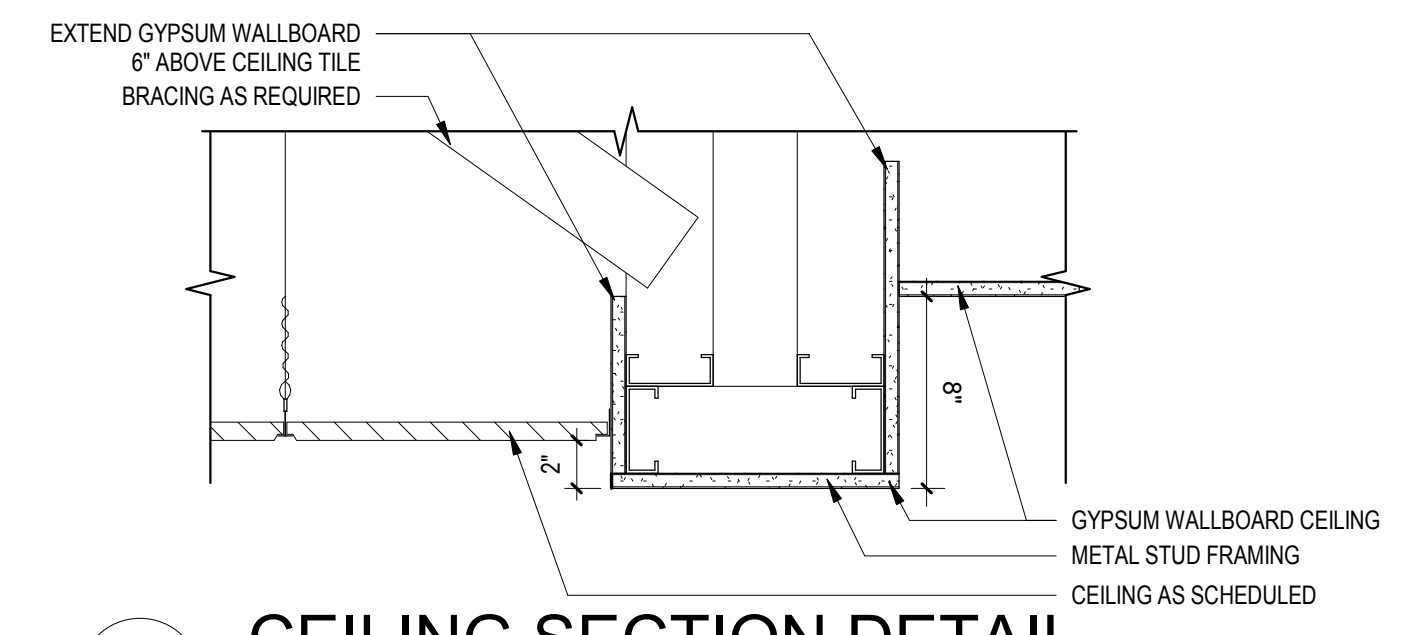


6 CEILING SECTION DETAIL
1 1/2" = 1'-0"

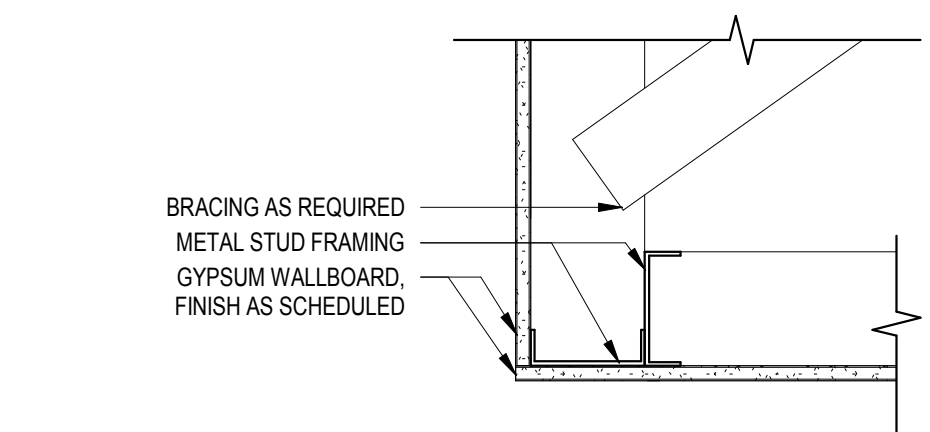


5 CEILING SECTION DETAIL
1 1/2" = 1'-0"

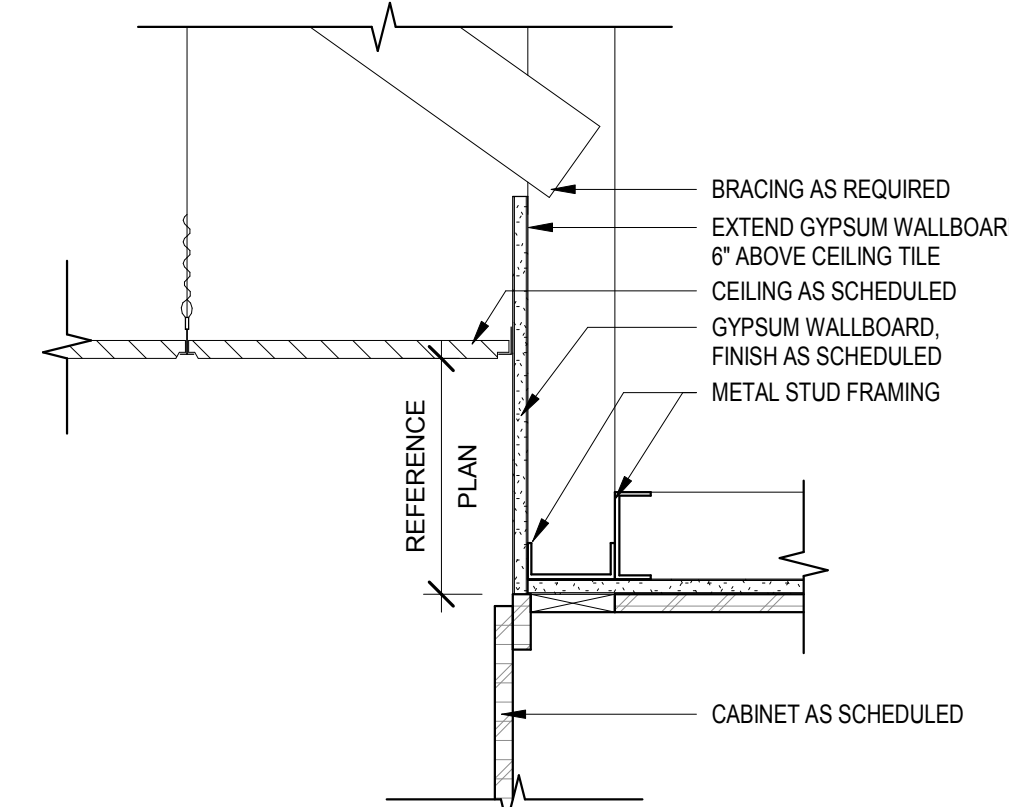

4 CEILING SECTION DETAIL
1 1/2" = 1'-0"

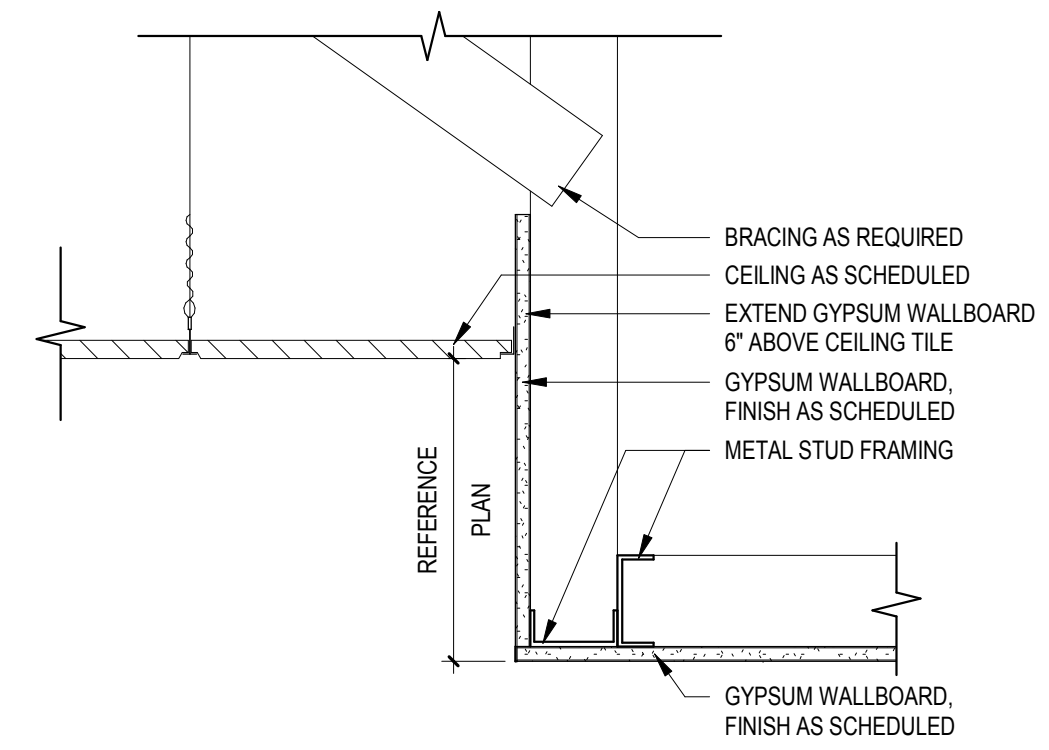

3 CEILING SECTION DETAIL
1 1/2" = 1'-0"

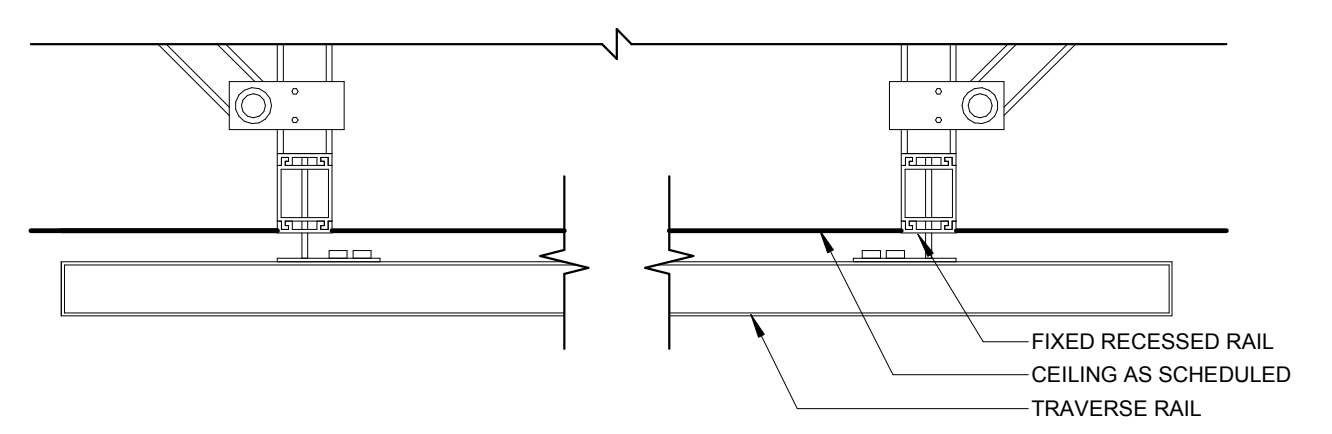


2 RECESSED CEILING LIFT DETAIL
1 1/2" = 1'-0"


REFLECTED CEILING PLAN NOTES

- COORDINATE CEILING LIFT RAIL SYSTEMS WITH ALL CEILING MOUNTED FIXTURES AND SPRINKLER SYSTEMS

REFLECTED CEILING PLAN LEGEND

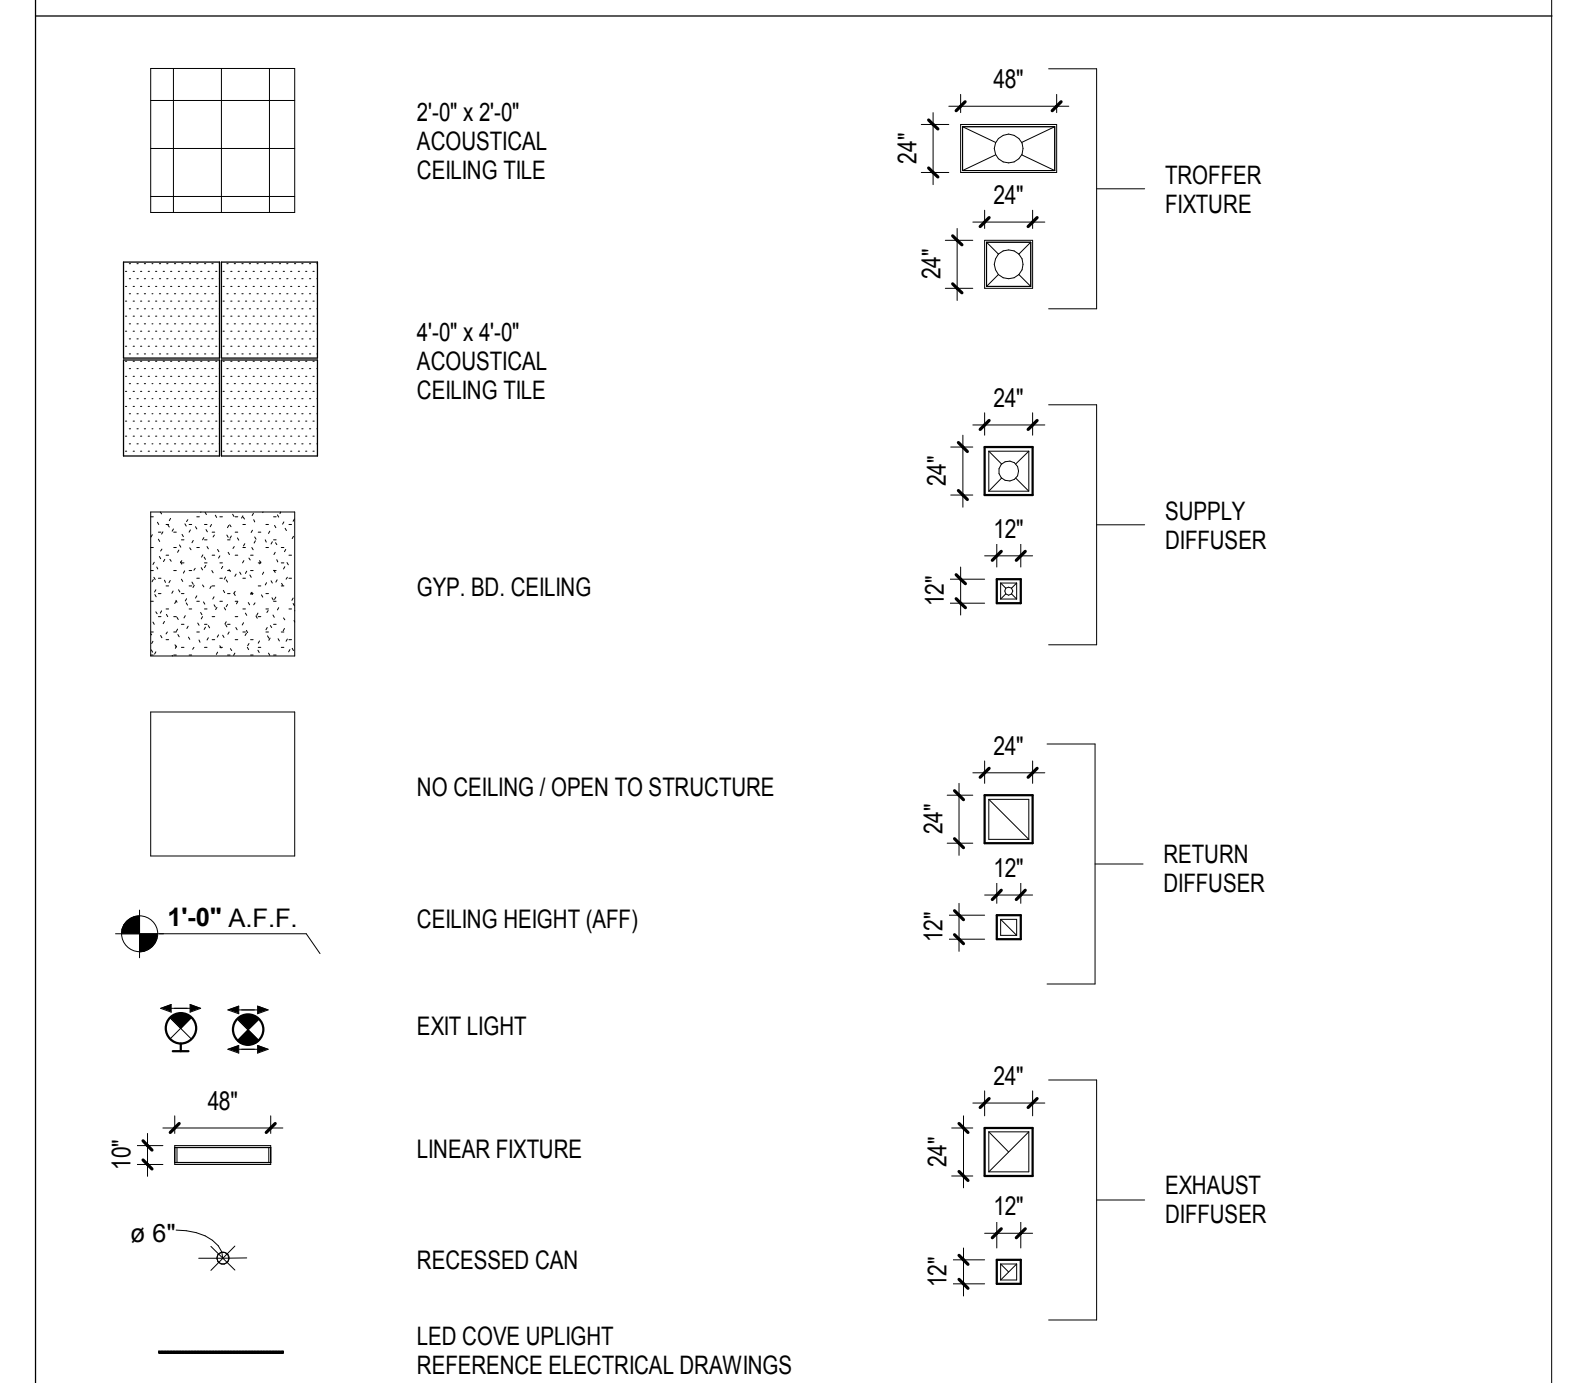

ARCH - SCHEDULE LIFT SYSTEM					
MARK	TYPE	TRAVERSE RAIL LENGTH	STATIONARY RAIL LENGTH	COUNT	COMMENTS
1	LIFT SYSTEM	3'-4"	12'-0"	8	
2	LIFT SYSTEM	3'-4"	14'-0"	2	
3	LIFT SYSTEM	3'-4"	15'-0"	2	
4	LIFT SYSTEM	10'-0"	10'-0"	7	
5	LIFT SYSTEM	10'-0"	13'-6"	5	
6	LIFT SYSTEM	13'-4"	26'-0"	1	
7	LIFT SYSTEM	13'-4"	42'-0"	1	
8	LIFT SYSTEM, BARIATRIC	7'-0"	15'-0"	1	
9	LIFT SYSTEM, BARIATRIC	10'-0"	15'-0"	1	
10	LIFT SYSTEM, BARIATRIC	12'-10"	10'-0"	1	
11	LIFT SYSTEM, BARIATRIC	16'-0"	13'-0"	1	
12	LIFT MOTOR TRANSFER RAIL	-	-	13	FIELD VERIFY LENGTH

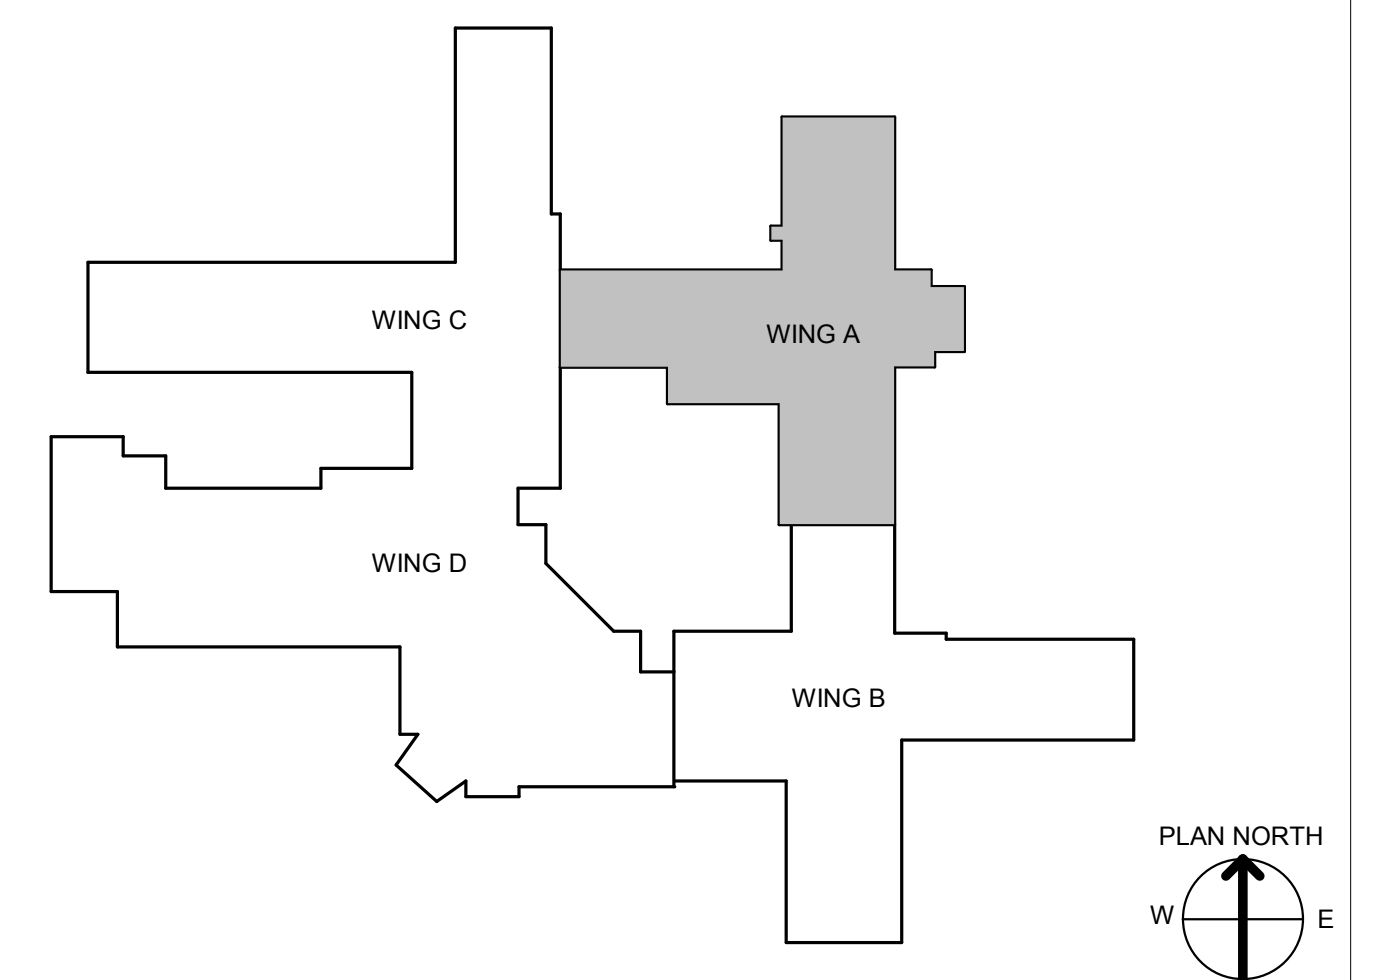

Revision #	Date

CONSULTANT INFORMATION		
STRUCTURAL / CIVIL ENGINEER STAND STRUCTURAL ENGINEERING 11927 W. 112TH STREET, SUITE 200 OVERLAND PARK, KS 66210 (913) 214-2169	MECHANICAL / ELECTRICAL / PLUMBING / TECHNICAL ENGINEER SPUR DESIGN 11020 KING STREET, SUITE 350 OVERLAND PARK, KS 66210 (405) 842-6100	FIRE PROTECTION ENGINEER POOLE FIRE PROTECTION, INC. 19910 W. 161ST STREET OLATH, KS 66062 (913) 829-8650

ARCHITECT

312 SW 23th Street
Overland Park, KS 66209
spur-design.com

6728
JULY 10, 2017
KANSAS ARCHITECT

KS ARCH REG. NO. A-1139, EXP. 12/31/2019
KS ENGR REG. NO. E-2586, EXP. 12/31/2019

Office of Construction and Facilities Management

VA U.S. Department of Veteran Affairs

SHEET TITLE
WING A - REFLECTED CEILING PLAN

APPROVED: PROJECT DIRECTOR

PROJECT PHASE
BID DOCUMENTS

FULLY SPRINKLERED

PROJECT TITLE
RENOVATE A & B WING BUILDING 6

PROJECT LOCATION
2200 SW GAGE BLVD.
TOPEKA, KS 66622

DATE
07/10/2019

CHECKED BY
AWM

DRAWN BY
JET

VA PROJECT NUMBER
589A5-19-116

BUILDING NUMBER
6


DRAWING NUMBER
6-AS-200A

Dwg. 19 OF 160

REFLECTED CEILING PLAN NOTES





- COORDINATE CEILING LIFT RAIL SYSTEMS WITH ALL CEILING MOUNTED FIXTURES AND SPRINKLER SYSTEMS

REFLECTED CEILING PLAN LEGEND

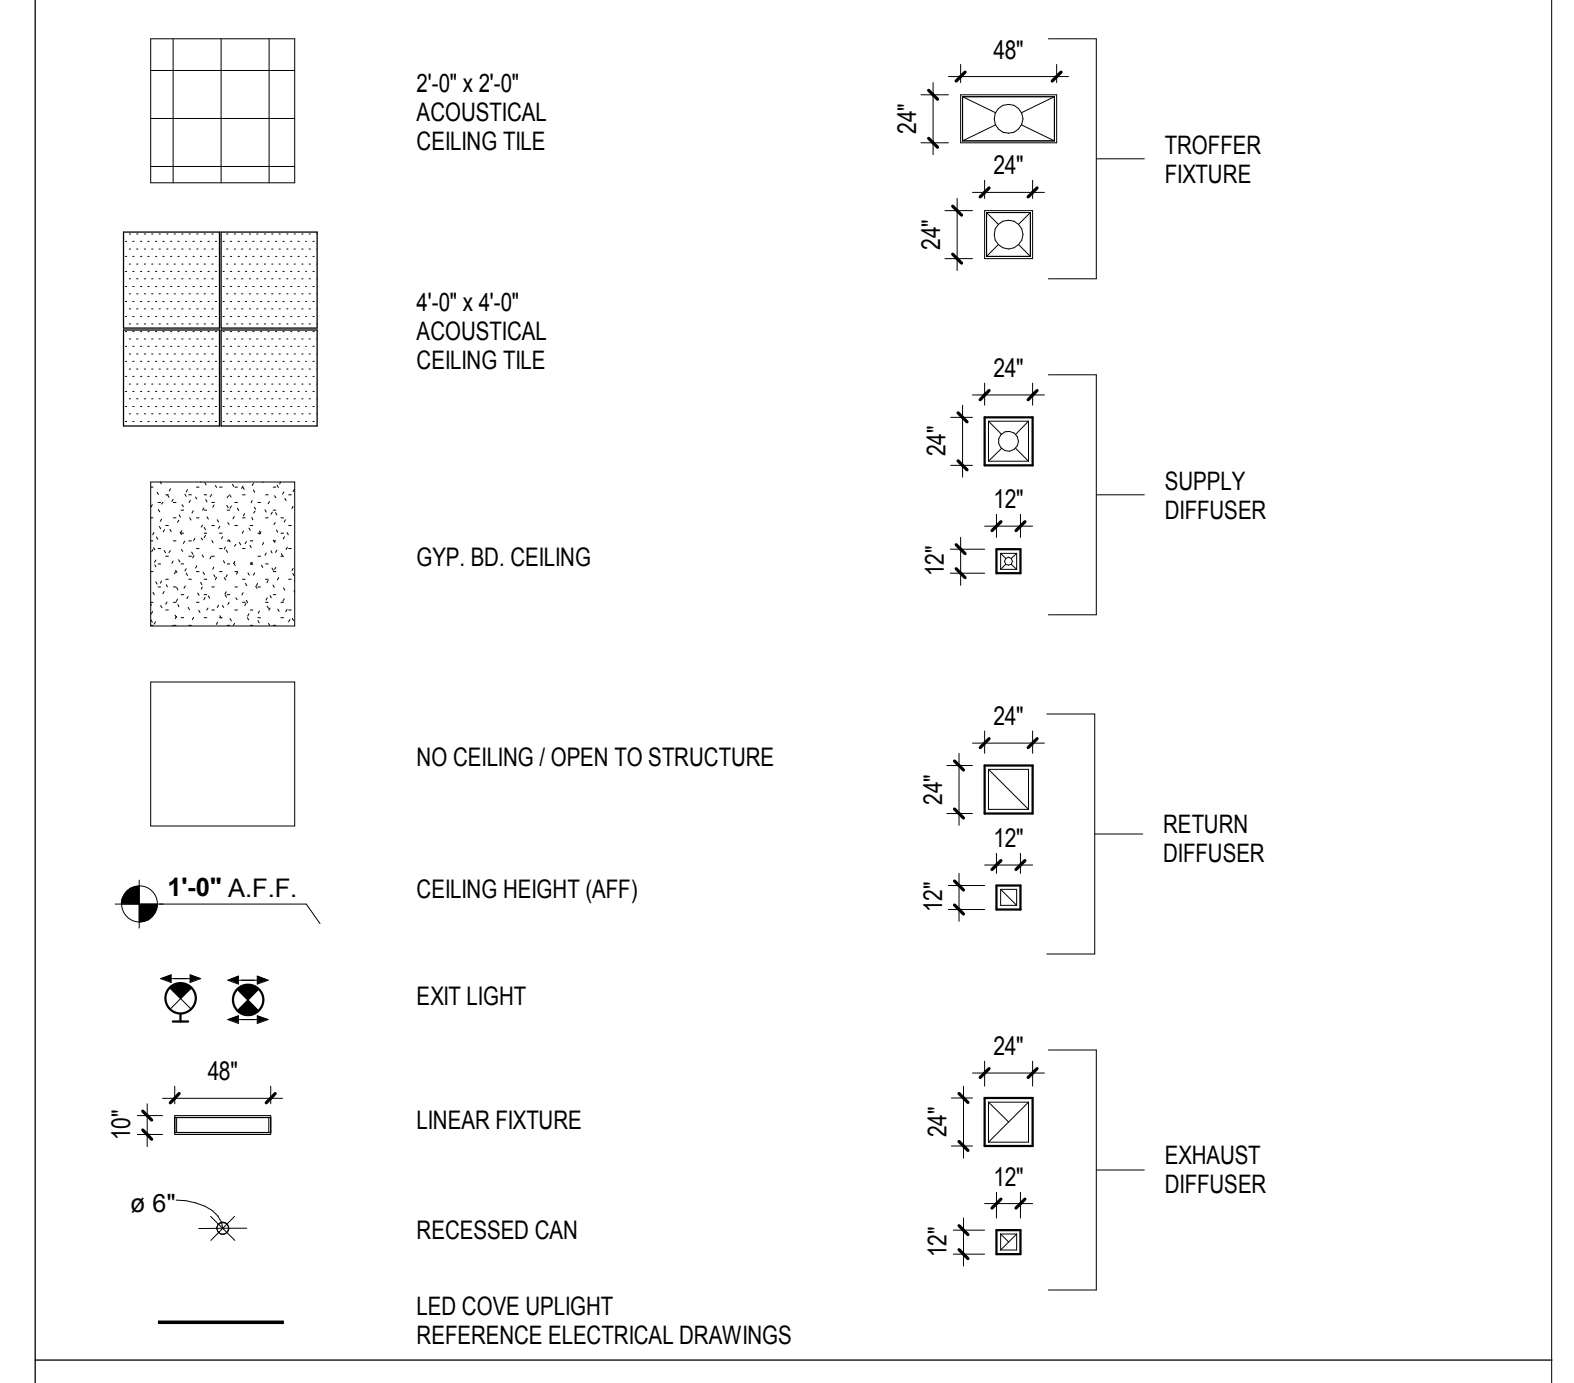

ARCH - SCHEDULE, LIFT SYSTEM

MARK	TYPE	TRAVERSE RAIL LENGTH	STATIONARY RAIL LENGTH	COUNT	COMMENTS
1	LIFT SYSTEM	3'-4"	12'-0"	8	
2	LIFT SYSTEM	3'-4"	14'-0"	2	
3	LIFT SYSTEM	3'-4"	19'-0"	2	
4	LIFT SYSTEM	10'-0"	10'-6"	7	
5	LIFT SYSTEM	10'-0"	13'-6"	5	
6	LIFT SYSTEM	13'-4"	26'-0"	1	
7	LIFT SYSTEM	13'-4"	42'-0"	1	
8	LIFT SYSTEM, BARIATRIC	7'-0"	19'-0"	1	
9	LIFT SYSTEM, BARIATRIC	10'-0"	19'-0"	1	
10	LIFT SYSTEM, BARIATRIC	12'-10"	10'-0"	1	
11	LIFT SYSTEM, BARIATRIC	16'-0"	13'-0"	1	
12	LIFT MOTOR, TRANSFER RAIL	-	-	13	FIELD VERIFY LENGTH

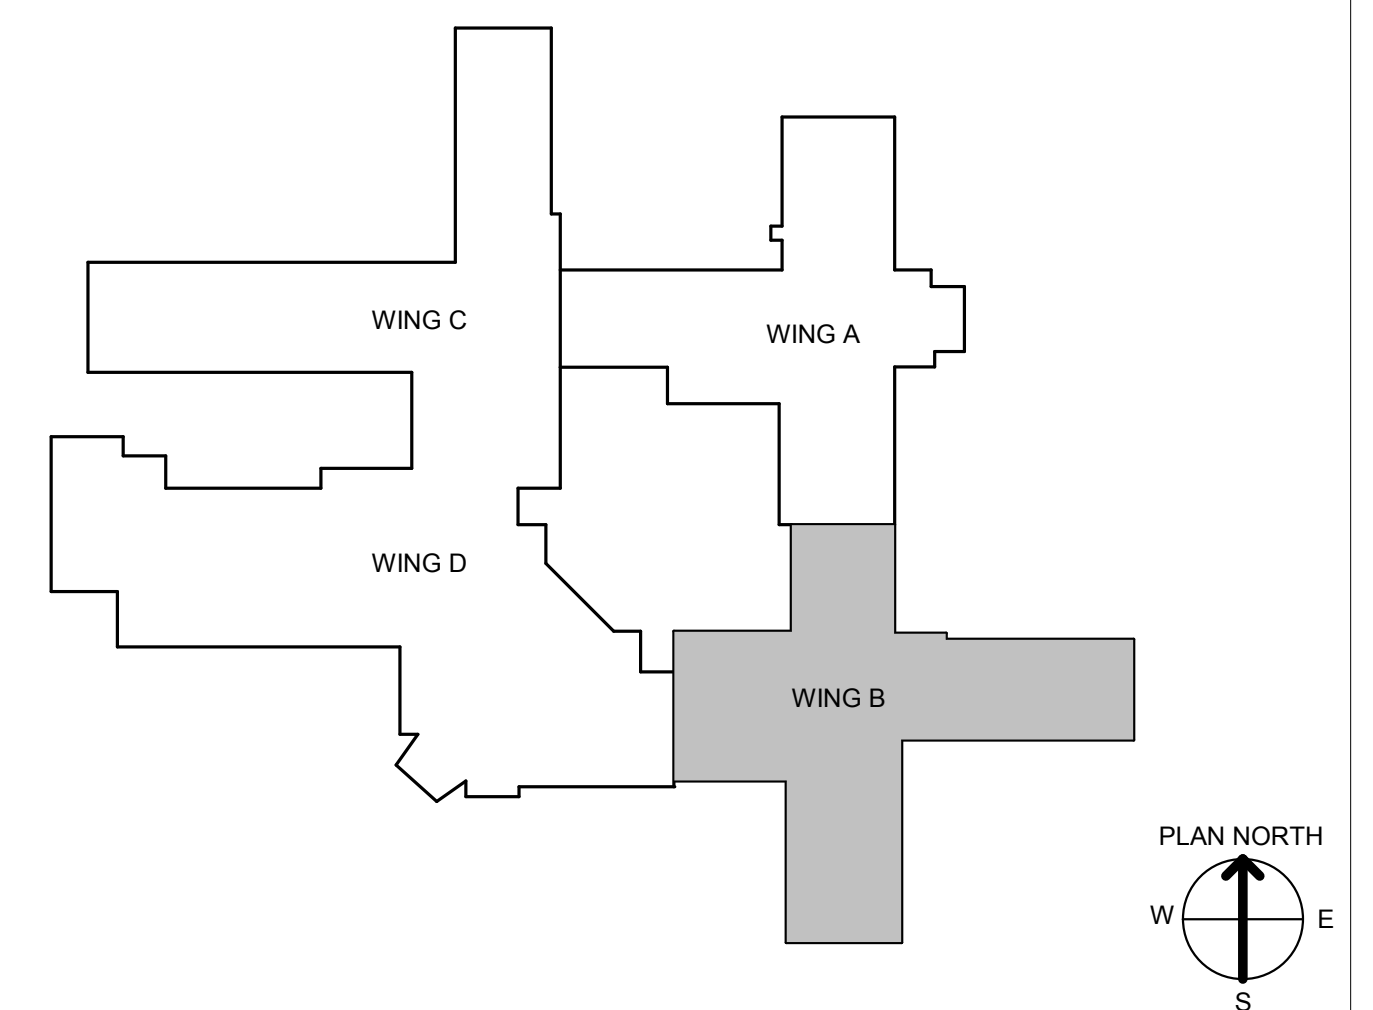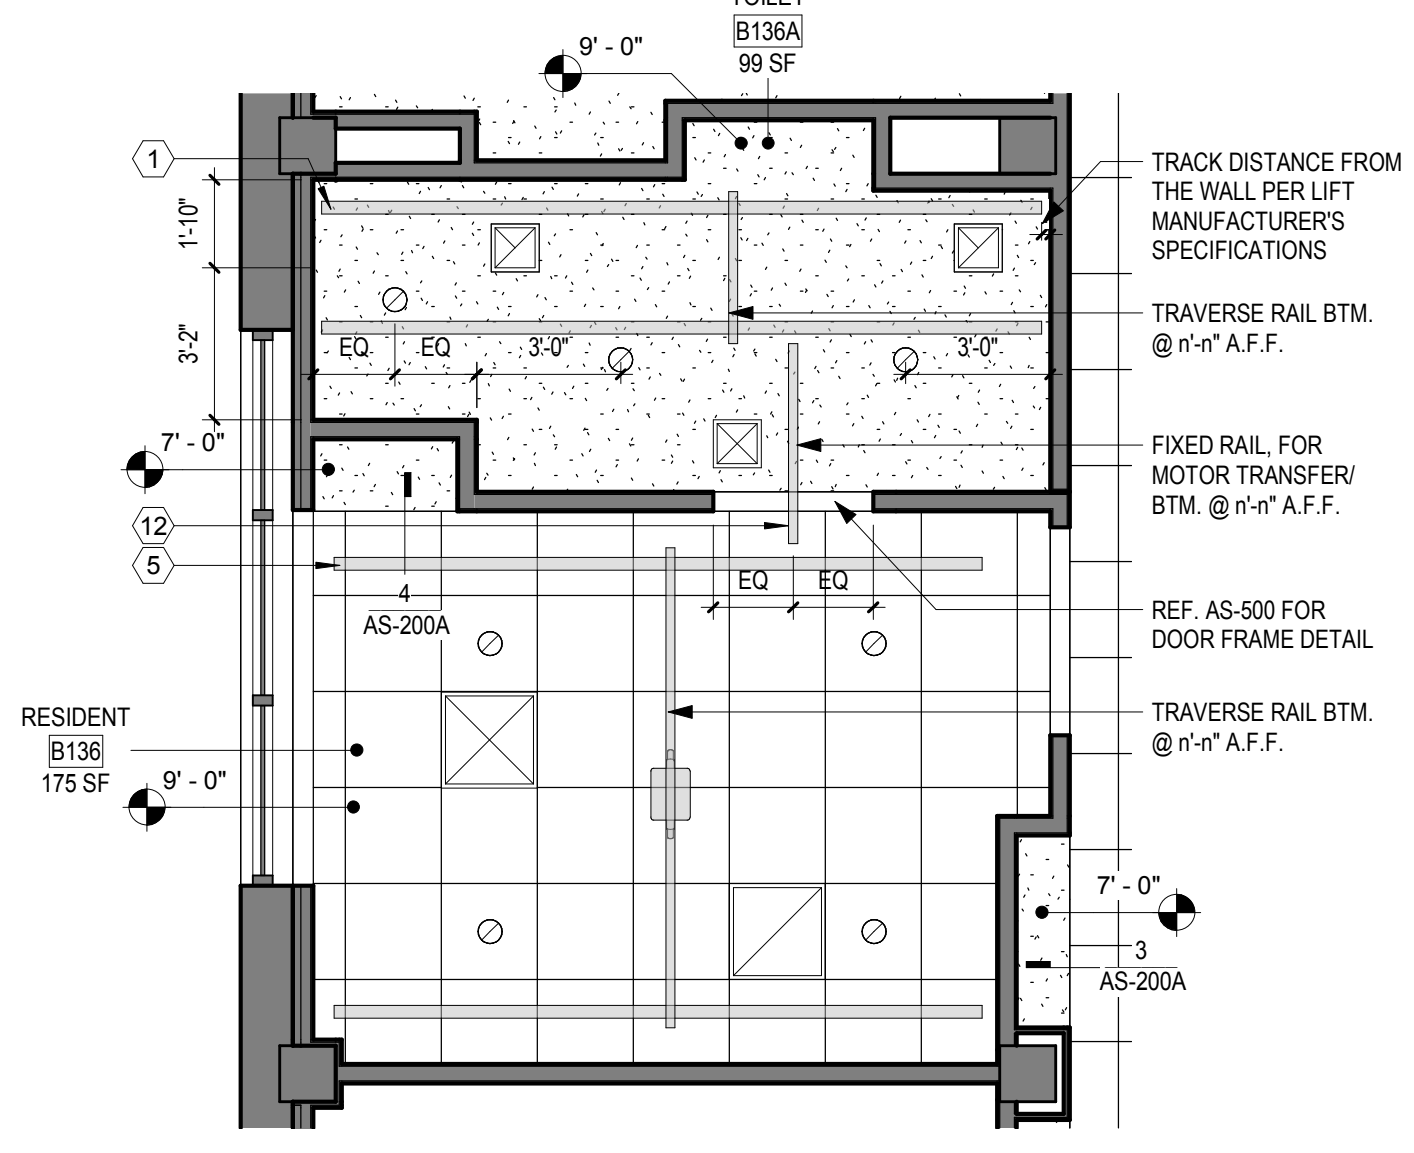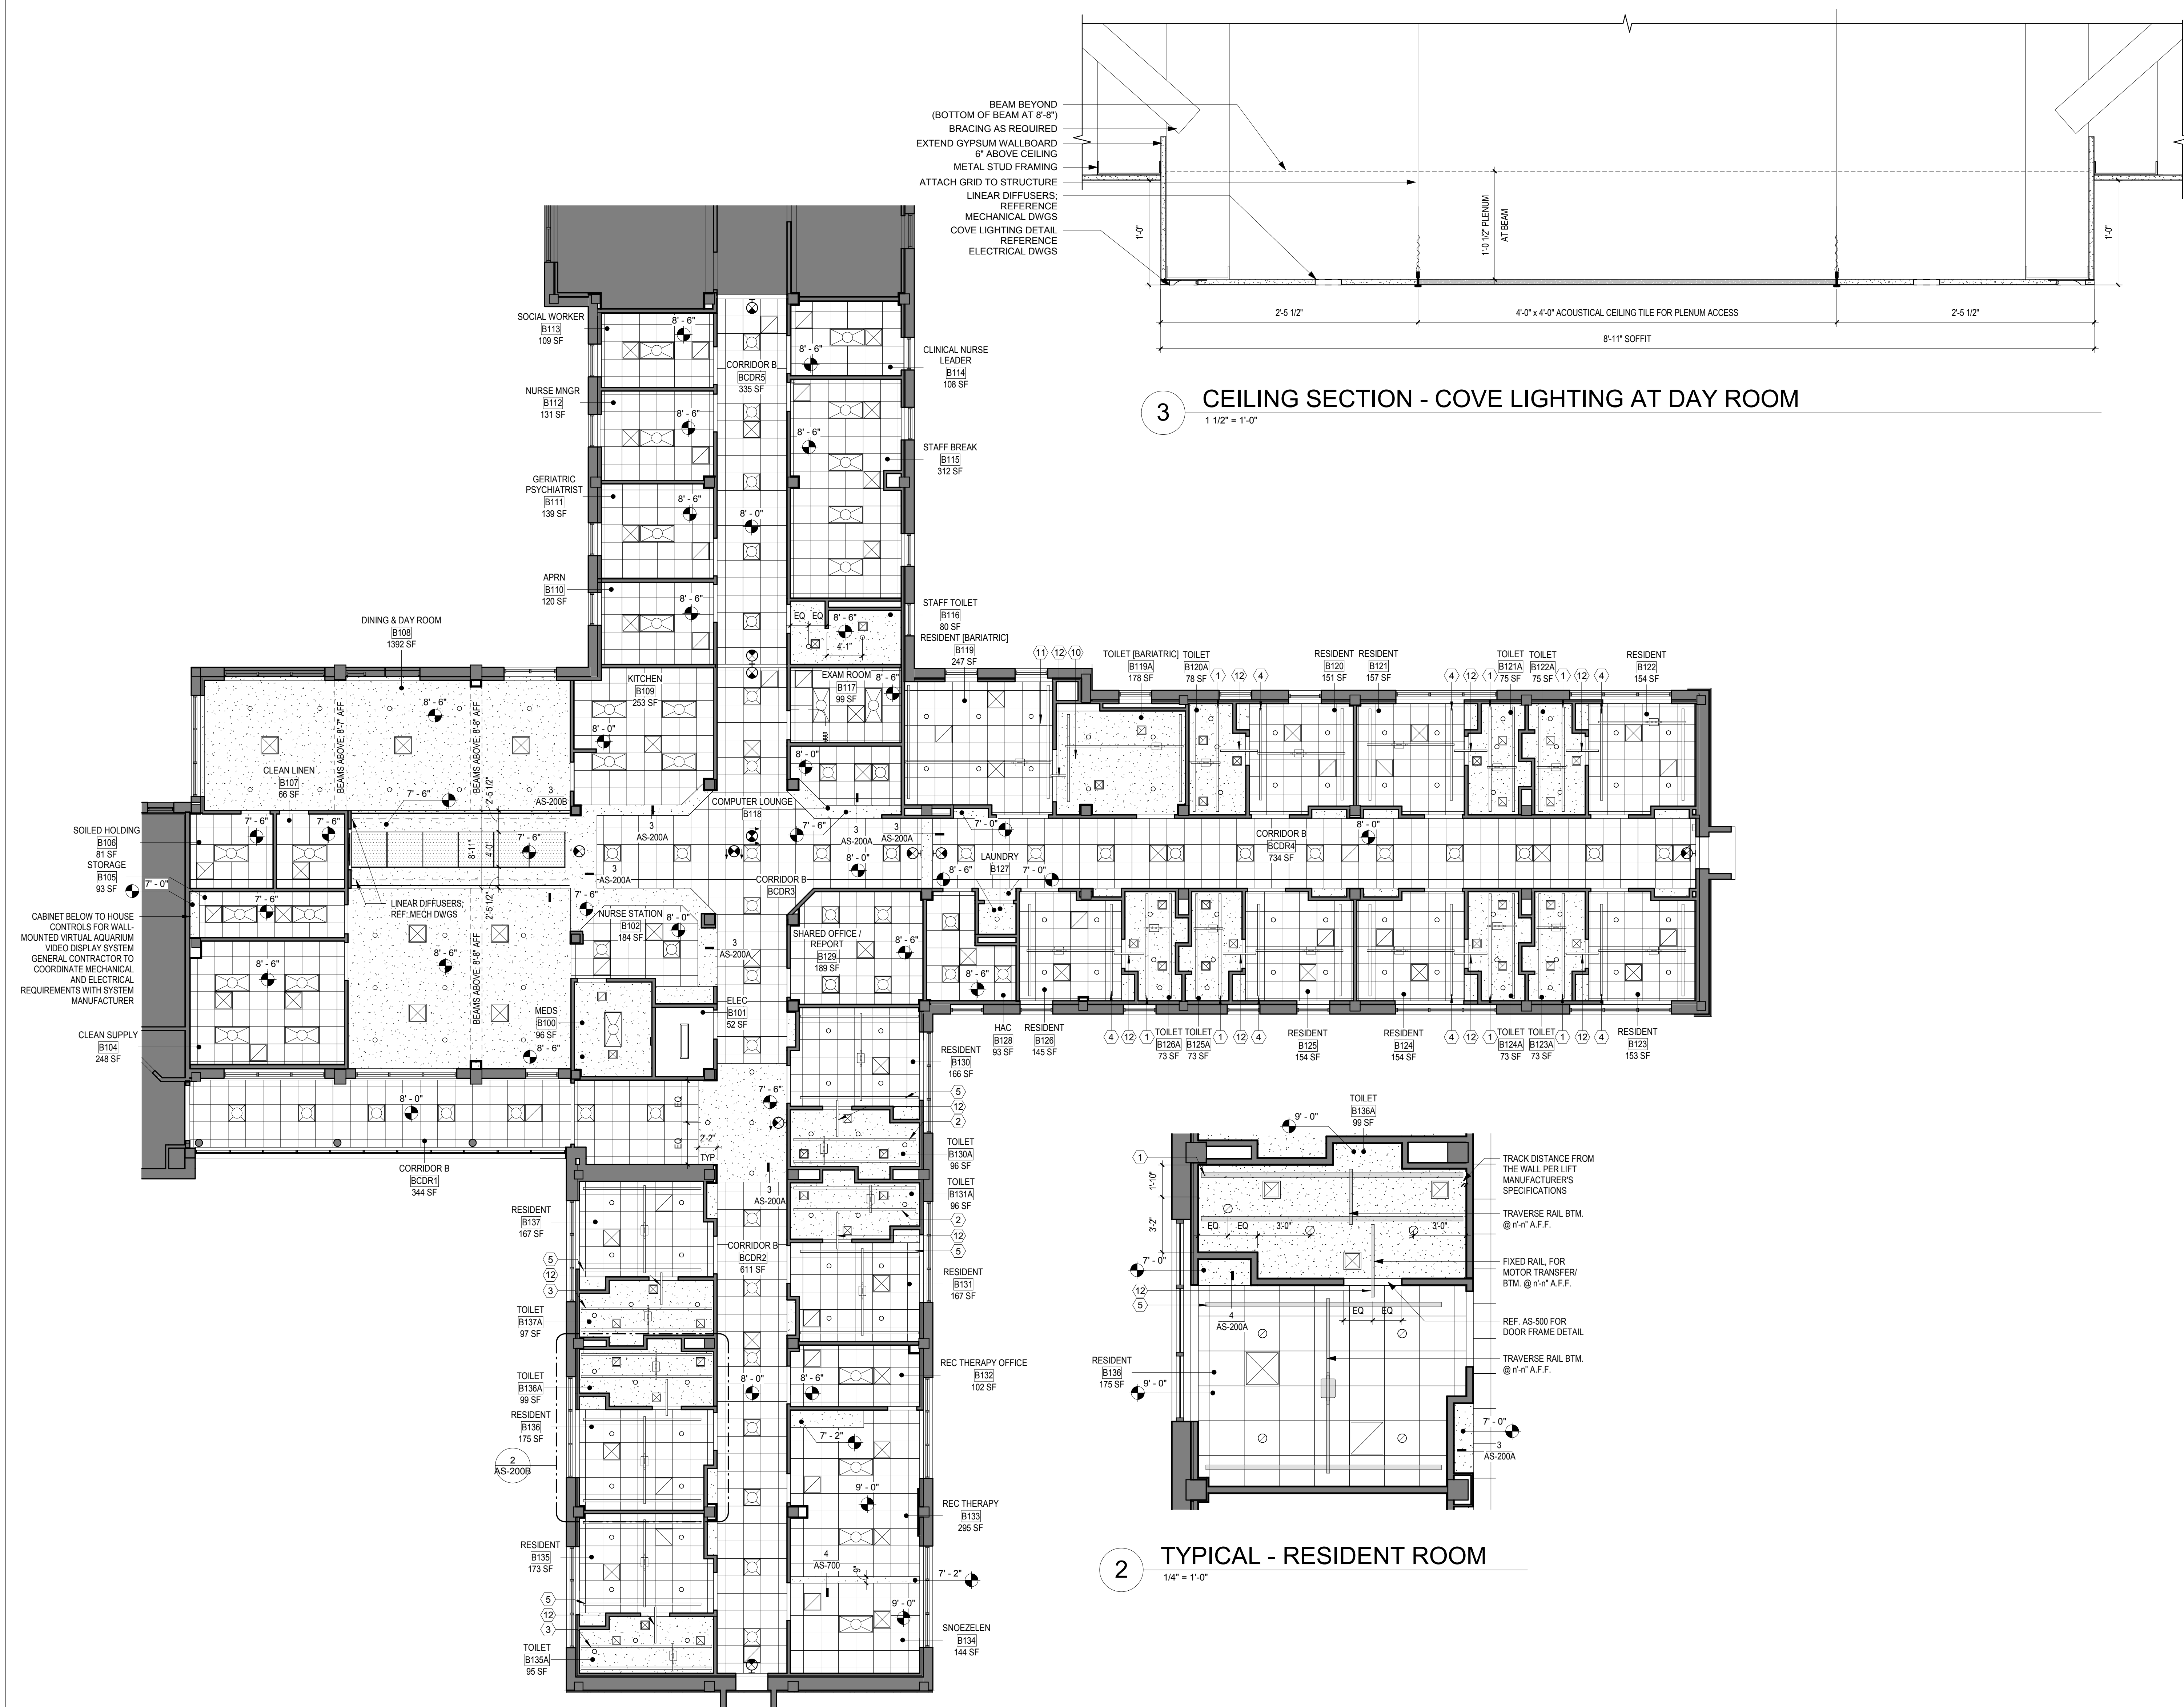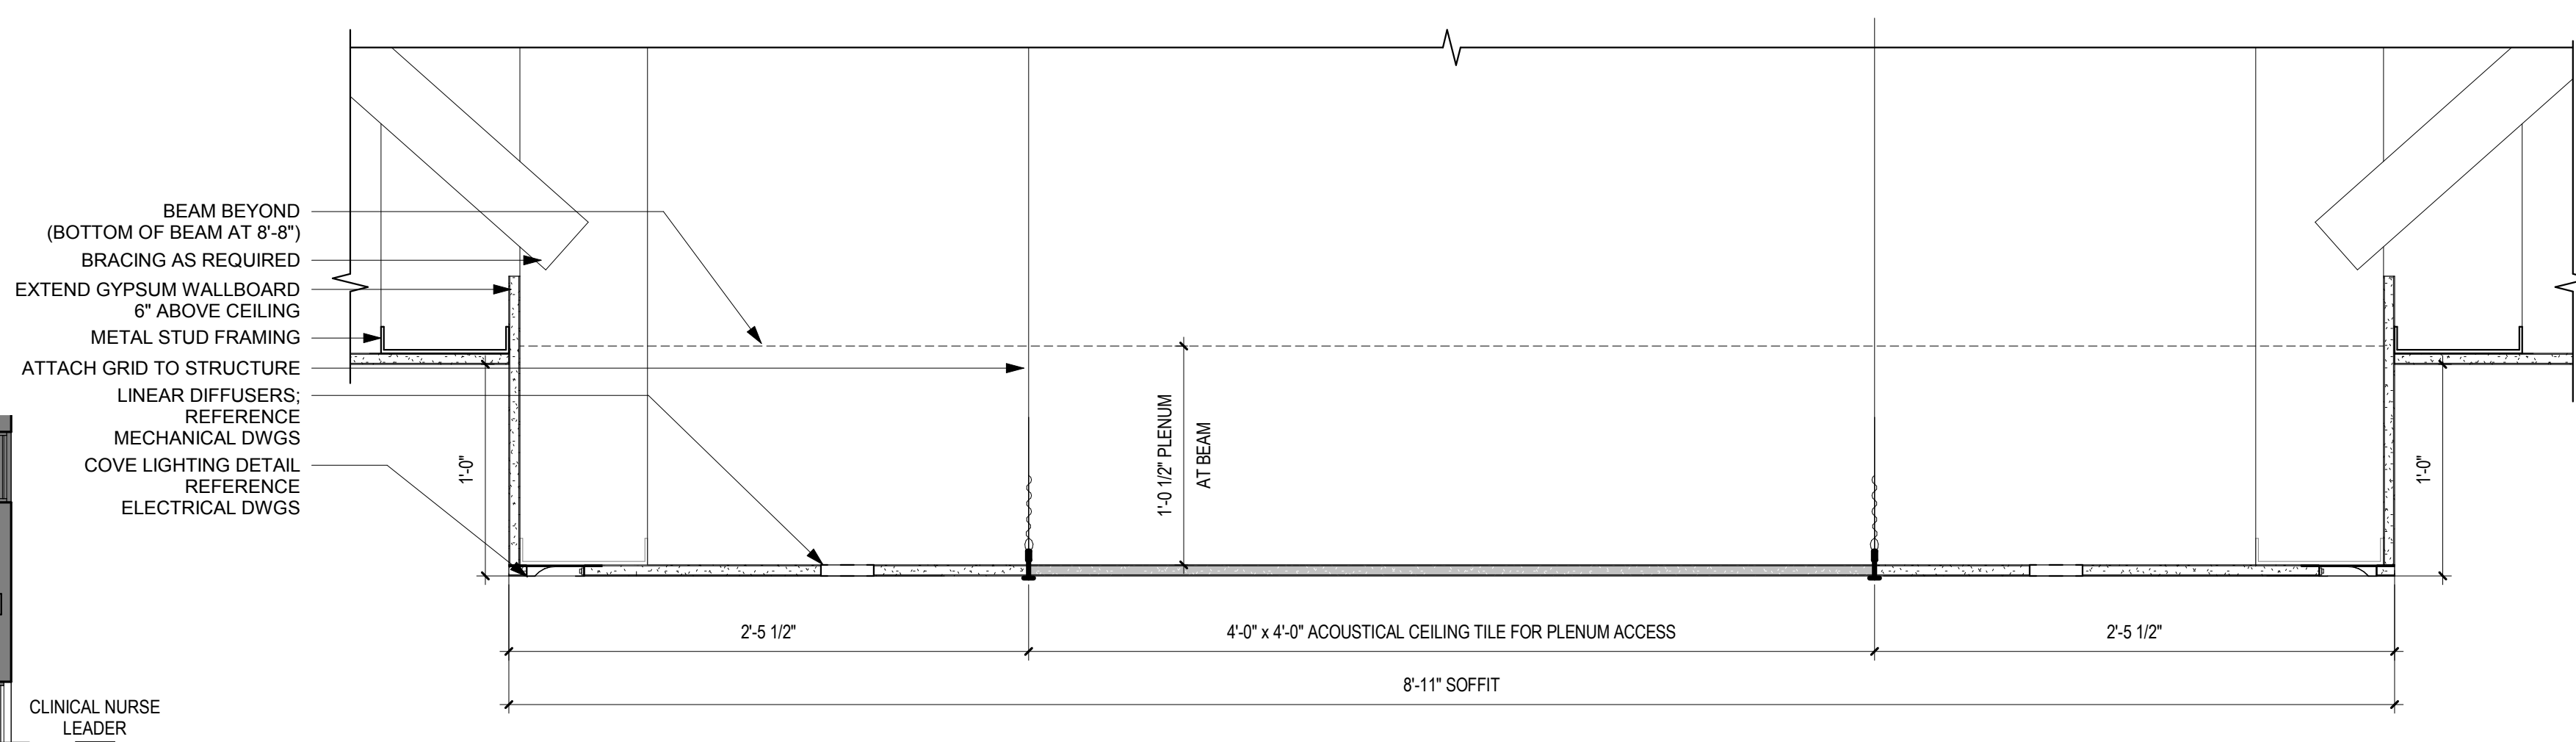

1 WING B - REFLECTED CEILING PLAN
1/8" = 1'-0"

CONSULTANT INFORMATION STRUCTURAL / CIVIL ENGINEER: STAND STRUCTURAL ENGINEERING MECHANICAL / ELECTRICAL / PLUMBING / TECHNICAL ENGINEER: SPUR DESIGN FIRE PROTECTION ENGINEER: POOLE FIRE PROTECTION, INC.		ARCHITECT Office of Construction and Facilities Management U.S. Department of Veteran Affairs		SHEET TITLE: WING B - REFLECTED CEILING PLAN PROJECT PHASE: BID DOCUMENTS FULLY SPRINKLERED		PROJECT TITLE: RENOVATE A & B WING BUILDING 6 PROJECT LOCATION: 2200 SW GAGE BLVD. TOPEKA, KS 66622 DATE: 07/10/2019 CHECKED BY: AWM DRAWN BY: JET		VA PROJECT NUMBER: 589A5-19-116 BUILDING NUMBER: 6 DRAWING NUMBER: 6-AS-200B Dwg. 20 OF 160	
---	--	--	--	---	--	--	--	--	--


FURNITURE, FIXTURE, & EQUIPMENT NOTES

1. ALL FURNITURE, FIXTURES, AND EQUIPMENT ARE SHOWN AS BASIS OF DESIGN.
2. GENERAL CONTRACTOR TO PROVIDE METAL SUPPORT BLOCKING AS REQUIRED.
3. REFERENCE AS-400 - INTERIOR FINISH SCHEDULES AND DETAILS FOR TYPICAL CORRIDOR AND TOILET ROOM WALL FINISH ELEVATIONS
4. ALL PLUMBING FIXTURES ARE CONTRACTOR PROVIDED, CONTRACTOR INSTALLED


FURNITURE, FIXTURE, & EQUIPMENT SCHEDULE

MARK	FURNITURE/FIXTURE/EQUIPMENT	ACQ/INS	MARK	FURNITURE/FIXTURE/EQUIPMENT	ACQ/INS
1	BARATRIC SHOWER SEAT	C/C	66	PHYSIOMAX UE BIKE SYSTEM	V/V
2	BARATRIC HILO MAT	V/V	69	PREP TABLE	V/V
3	BARATRIC HILO MAT	V/V	70	PRINTER/COPIER/FAX COMBO	V/V
4	BASKET, WASTE/PAPER	V/V	71	PULLEY SYSTEM	V/V
5	BOARD, BULLETIN	V/V	72	RACK, MAGAZINE, WALL MOUNTED	V/V
6	BRACKET, TELEVISION, WALL MNTD, TILT ANGLE	V/V	73	RAIL, ACCESSORY	V/C
7	BREWER, COFFEE	V/V	74	REFRIGERATOR, 48"	C/C
9	CABINET, BEDSIDE	V/V	75	REFRIGERATOR, U-C OR F-S	C/C
10	CART, STORAGE	V/V	76	REFRIGERATOR/FREEZER	C/C
11	CHAIR, DINING	V/V	77	RESIDENT BED	V/V
11	COFFEE TABLE, 52" x 52"	V/V	79	SHELVING, STORAGE	V/V
12	CHAIR, RECLINER	V/V	80	SIDE CHAIR, WITH ARMS	V/V
13	CHAIR, SIDE, BARATRIC, WITH ARMS	V/V	81	SOFA	V/V
14	CHAIR, SWIVEL, HIGH BACK	V/V	82	SPHYGMOMANOMETER, ANEROID	V/V
15	CHAIR, SWIVEL, LOW BACK	V/V	83	STAIRS, EXISTING VA EQUIP	V/V
16	CLIMBING BOARD AND BAR	V/V	86	STOOL, SELF-ADJUSTING	V/V
17	CLOCK, BATTERY, 12"	V/V	88	TABLE	V/V
18	COLD PACK UNIT, EXISTING VA EQUIP	V/V	89	TABLE LAMP	V/V
19	COMPUTER	V/V	90	TABLE, COFFEE	V/V
20	COMPUTER WITH FLAT PANEL MONITOR	V/V	91	TABLE, COFFEE, 24" x 48"	V/V
21	CONFERENCE CHAIR	V/V	92	TABLE, COMPUTER	V/V
22	CREENZA	V/V	93	TABLE, EXAM/TREATMENT	V/V
24	CUBICAL TRACK, W/ CURTAIN	C/C	94	TABLE, SIDE	V/V
25	DINING TABLE AND CHAIRS	V/V	95	TELECOMMUNICATION OUTLET	V/V
26	DISHWASHER	C/C	96	TELEPHONE, CONFERENCING SYSTEM	V/V
27	DISPENSER, GLOVE, SURGICAL-EXAMINATION	V/V	98	TELEPHONE, WALL MOUNTED, 1 LINE	V/V
29	DISPENSER, PAPER CUP, SS	V/V	99	TELEVISION, BACKING	C/C
30	DISPENSER, PAPER TOWEL, SENSOR, HANDS FREE	C/C	101	TELEVISION, HDTV, 50"	V/V
31	DISPENSER, SOAP, DISPENSABLE	V/V	102	TRACK, CUBICLE, WITH CURTAIN	C/C
32	DISPENSER, TOILET ROLL	C/C	103	URNAL, SCREEN	C/C
33	DOUBLE BED, BARATRIC	V/V	104	VIDEO TELECONFERENCING SYSTEM	V/V
34	DVD PLAYER	V/V	105	WALL HOOK	C/C
35	FIRE EXTINGUISHER CABINET, RECESSED	C/C	106	WASHER, DRYER	V/V
36	FIRE EXTINGUISHER CABINET, SURFACE MOUNT	C/C	107	WASTE DISPOSAL UNIT, SHARPS	V/V
38	FOLD-DOWN GRAB BAR	C/C	108	WHITE BOARD, BULLETIN BOARD COMBINATION	V/V
40	FOLD-DOWN SHOWER SEAT	C/C	109	WINDOW SHADE ROLLER	C/C
43	GRAB BAR	C/C	110	WORKSTATION	V/V
45	HANDRAIL	V/C	111	WORKSTATION, COMPUTER, WALL MOUNTED	V/V
47	HLO TREATMENT TABLE, EXISTING VA EQUIP	V/V	115	HOOD, EXHAUST, NON-COMMERCIAL	C/C
48	HYDROCOLATOR UNIT, EXISTING VA EQUIP	V/V	116	POPCORN MACHINE	V/V
49	ICE MAKER	C/C	117	ACCORDION WALL	C/C
53	LIGHT, EXAM, MOBILE	V/V	119	METAL LOCKERS	C/C
54	WALL MOUNTED TELEVISION, 32"	V/V	120	RANGE	C/C
56	LOUNGE CHAIR	V/V	121	SUPPORT BRACKET	C/C
57	MEDICAL DISTRIBUTION SYSTEM	V/V	122	WINGBACK CHAIR	V/V
58	MEDICINE BALL RACK	V/V	123	RECESSED CURTAIN TRACK	C/C
59	MEETING TABLE	V/V	124	LOVESEAT	V/V
60	MIRROR, FLAT GLASS, ADA	C/C	125	ELECTRIC FIREPLACE	V/V
61	MOBILE WEIGHT RACK STORAGE	V/V	126	SOFA TABLE	V/V
62	MUSTER, EXISTING VA EQUIP	V/V	127	PYXIS AUXILIARY CABINET	V/V
63	OTOSCOPE OPHTHALMOSCOPE	V/V	128	PYXIS CONTROL CABINET	V/V
64	OVEN, MICROWAVE	V/V	129	MED REFRIGERATOR	V/V
65	PARALLEL BARS, EXISTING VA EQUIP	V/V	130	VIRTUAL AQUARIUM DISPLAY SYSTEM	C/C


MARK	PLUMBING FIXTURE	COMMENTS
PF1	SHOWE DRAIN, 3" DIAMETER	
PF1	TOILET, FLOOR-MOUNTED	
PF2	LAVATORY, WALL-MOUNTED	
PF3	TOILET, FLOOR-MOUNTED, BARATRIC	REFERENCE AS-700 FOR BARATRIC FIXTURE SUPPORTS
PF4	DRINKING FOUNTAIN, WITH BOTTLE FILLER	
PF5	SHOWER TRIM	
PF5	OVERFLOW DRAIN, 3" DIAMETER	
PF8	SINK, DROP-IN, 20" x 18"	
PF9	SHOWE DRAIN, 3" DIAMETER	
PF10	SINK, DROP-IN, DOUBLE	
PF11	SINK, MOP	
PF12	BATHTUB, WALK-IN	
PF13	LAVATORY, BARATRIC	REFERENCE AS-700 FOR BARATRIC FIXTURE SUPPORTS
PF14	TRAP PRIMER	

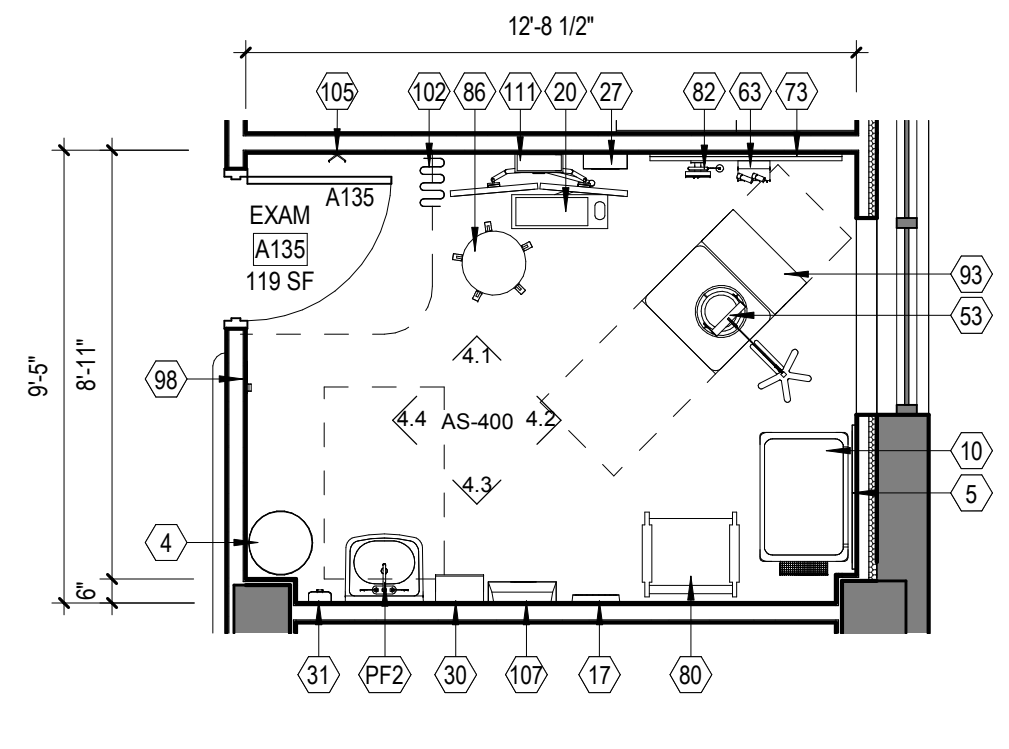


4 WING A - TYPICAL - EXAM ROOM
1/4" = 1'-0"

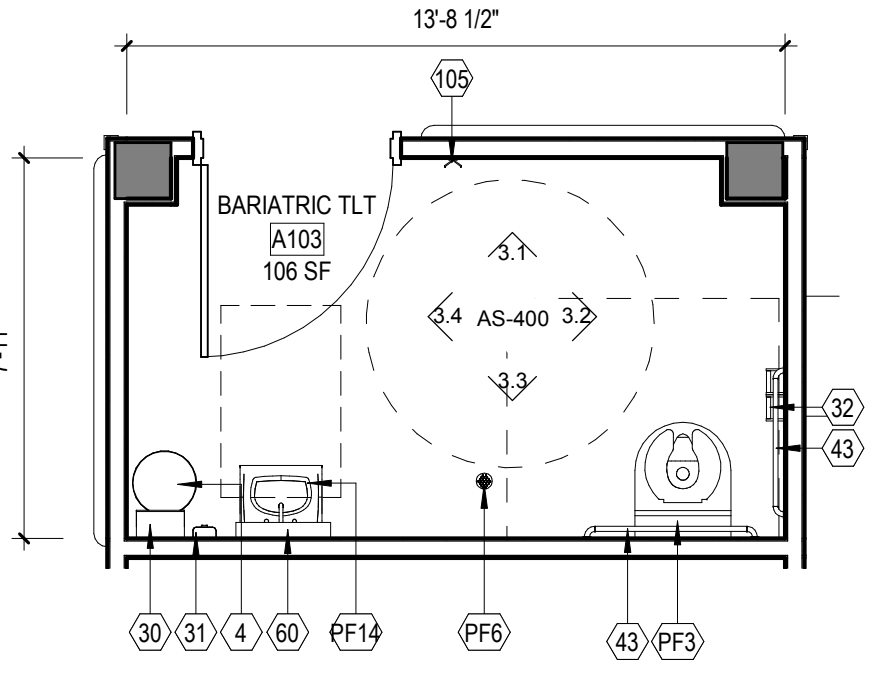



3 WING A - TOILET, BARIATRIC
1/4" = 1'-0"

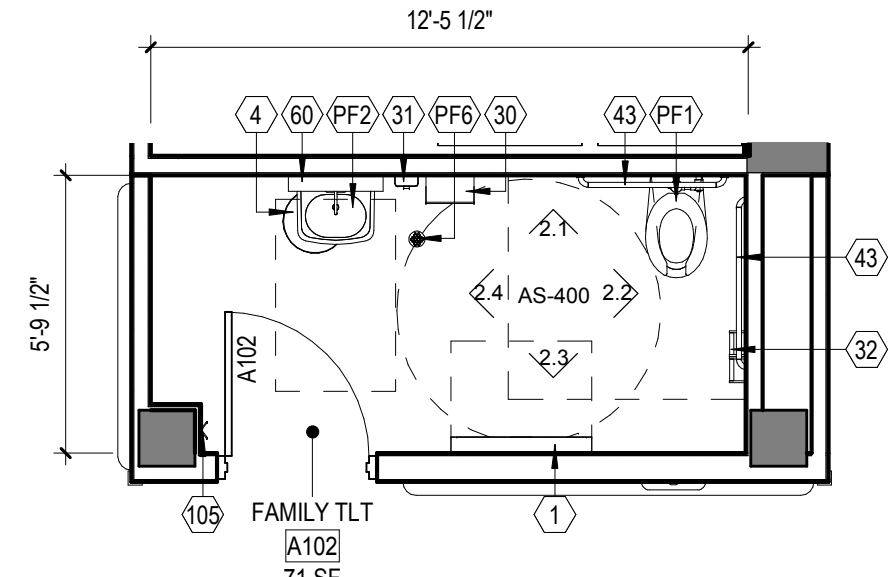


2 WING A - TOILET, FAMILY
1/4" = 1'-0"

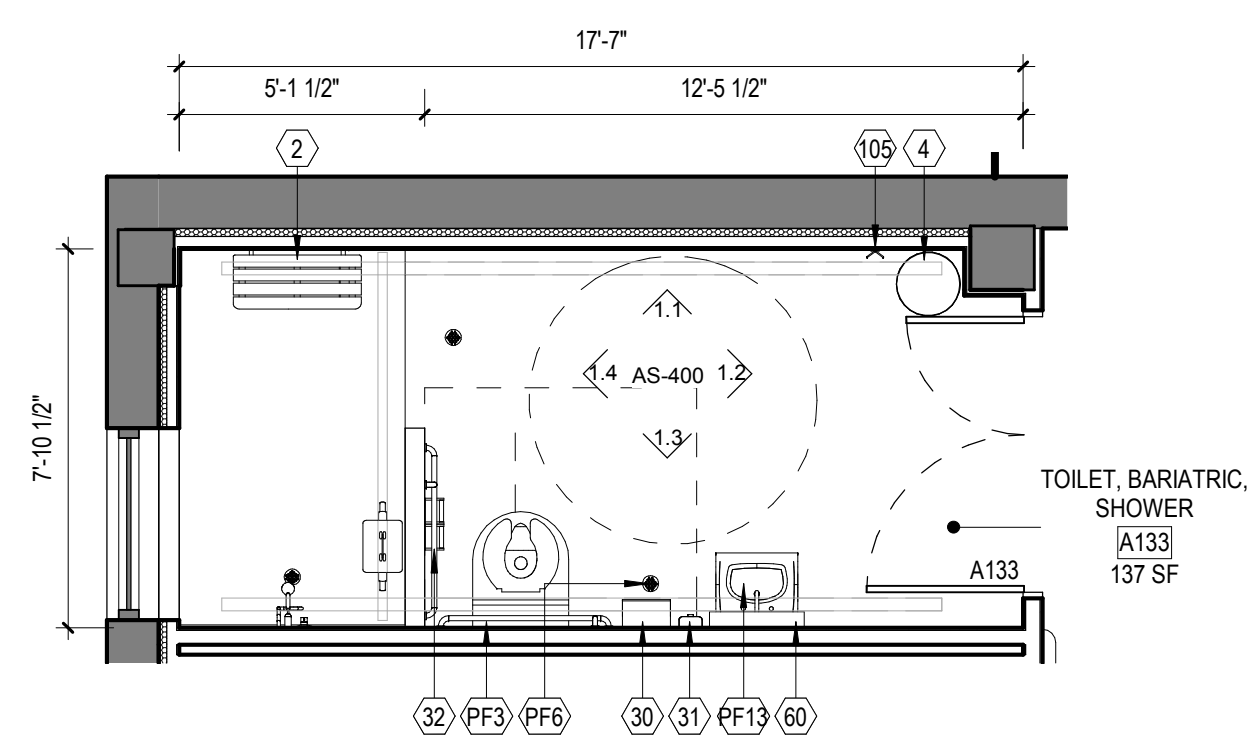


1 WING A - TOILET, BARIATRIC, SHOWER
1/4" = 1'-0"

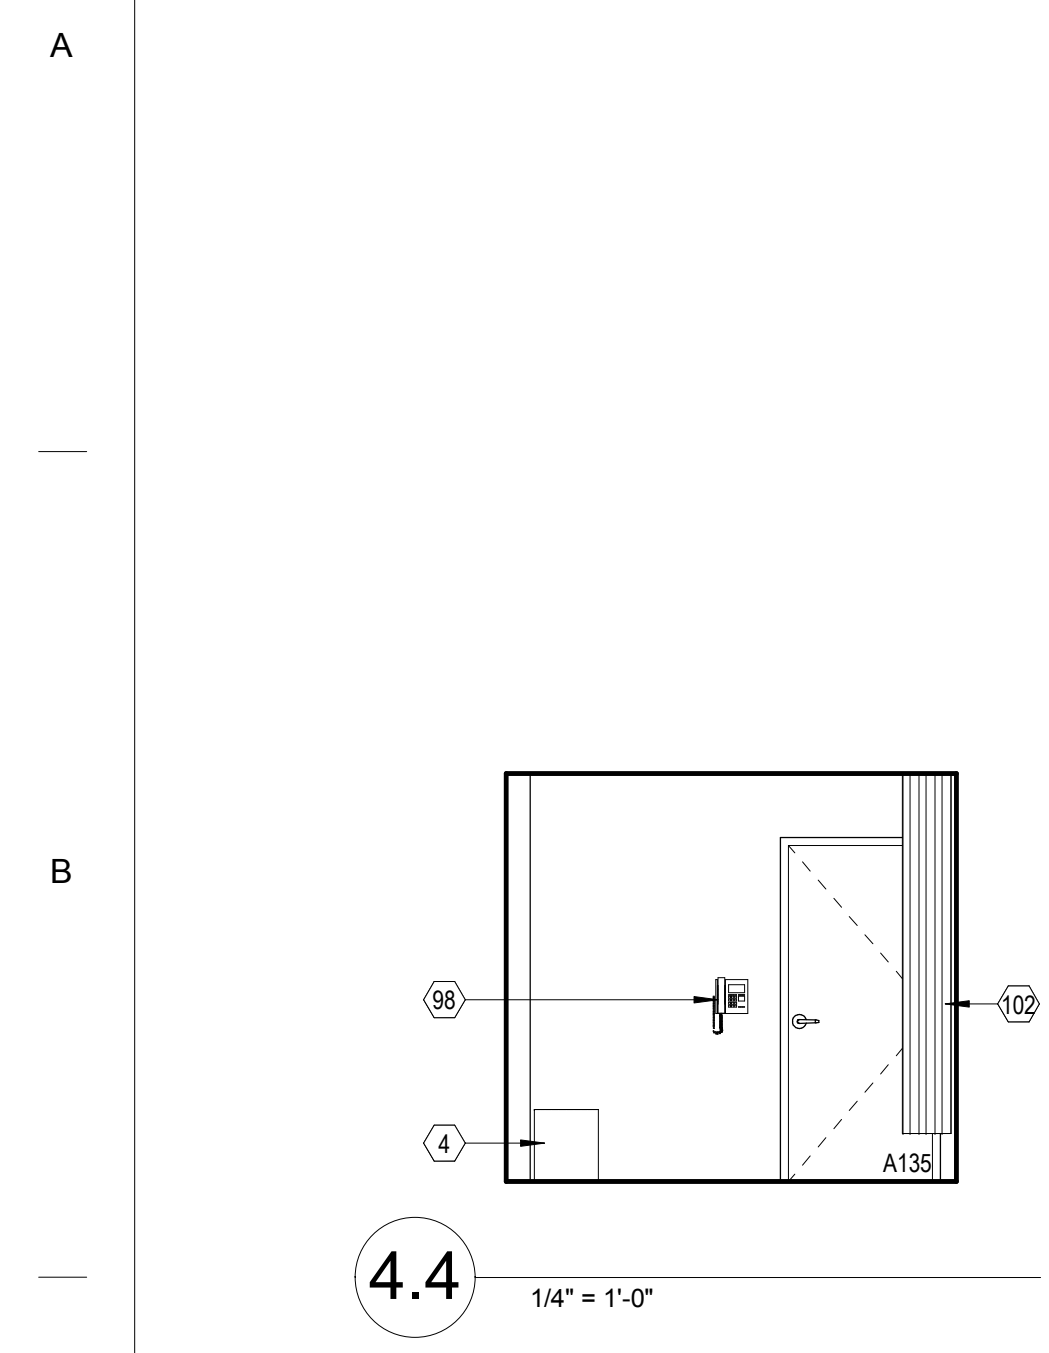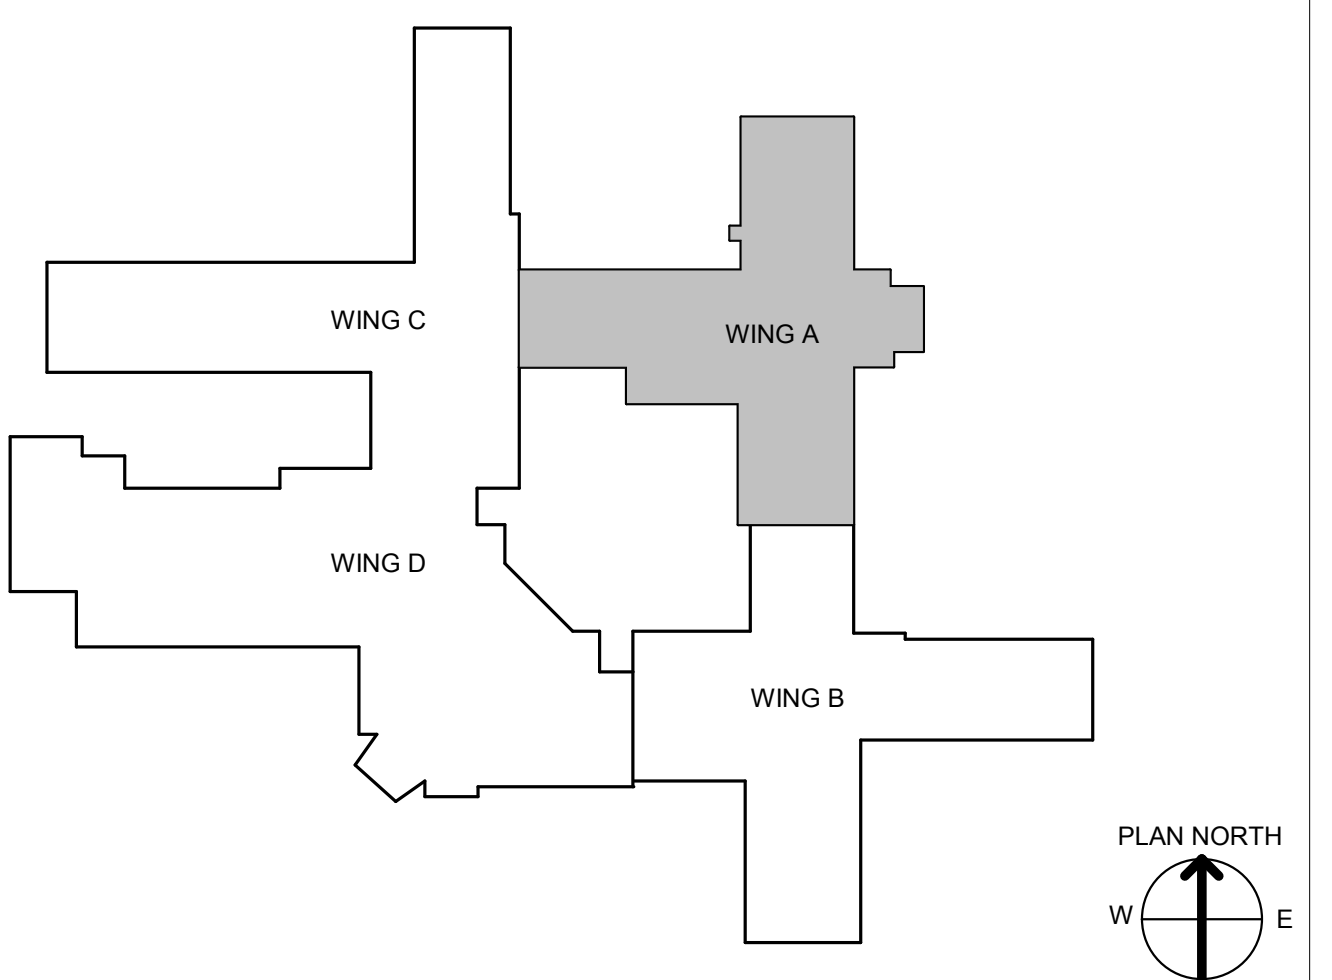


4.4 1/4" = 1'-0"

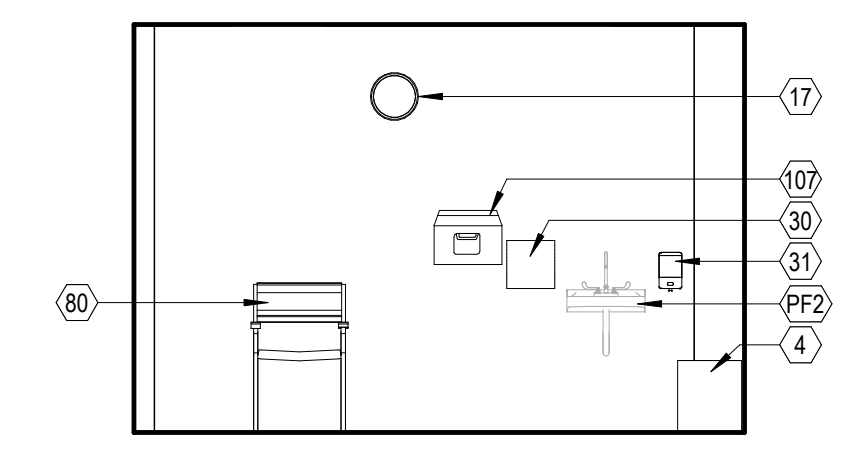


4.3 1/4" = 1'-0"

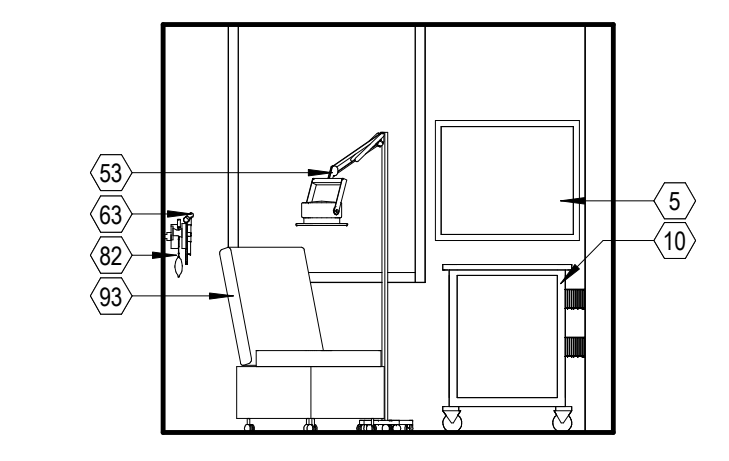


4.2 1/4" = 1'-0"

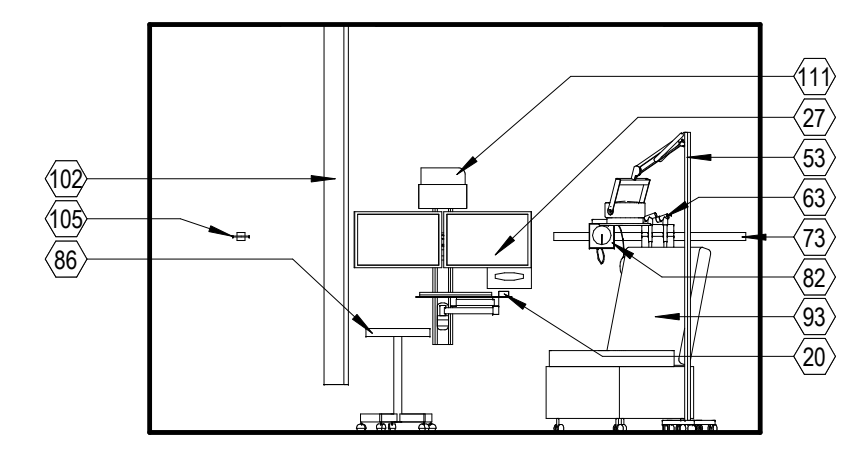


4.1 1/4" = 1'-0"

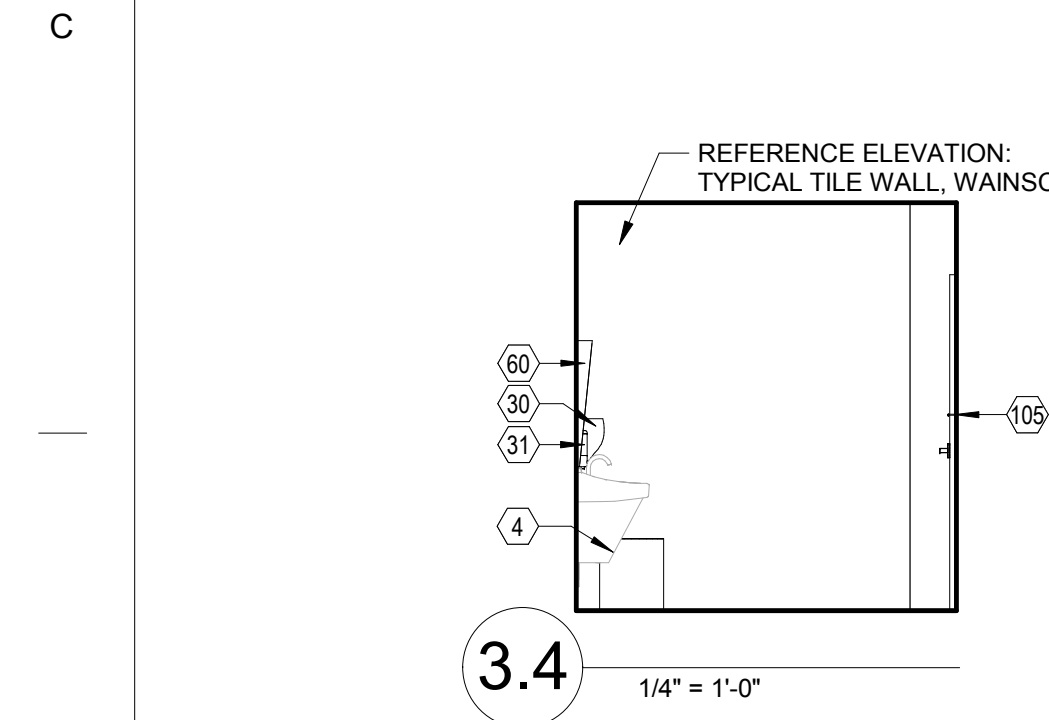


3.4 1/4" = 1'-0"

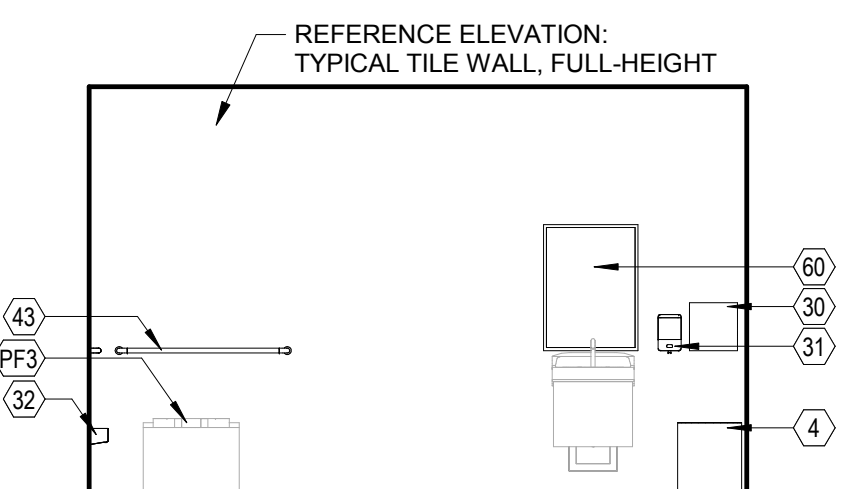


3.3 1/4" = 1'-0"

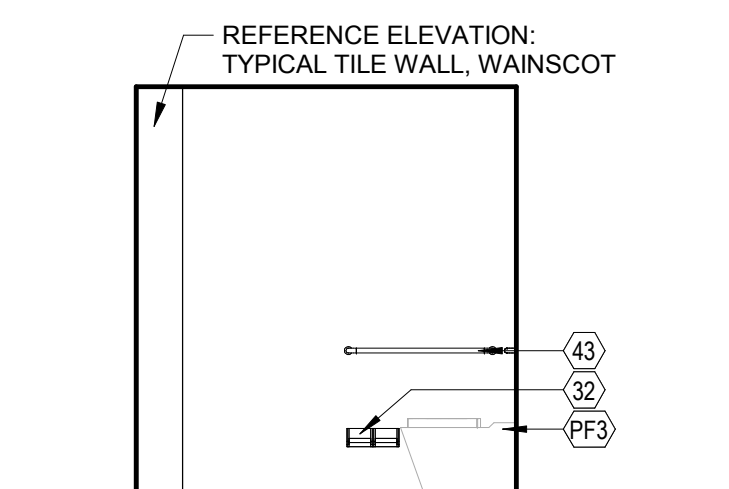


3.2 1/4" = 1'-0"

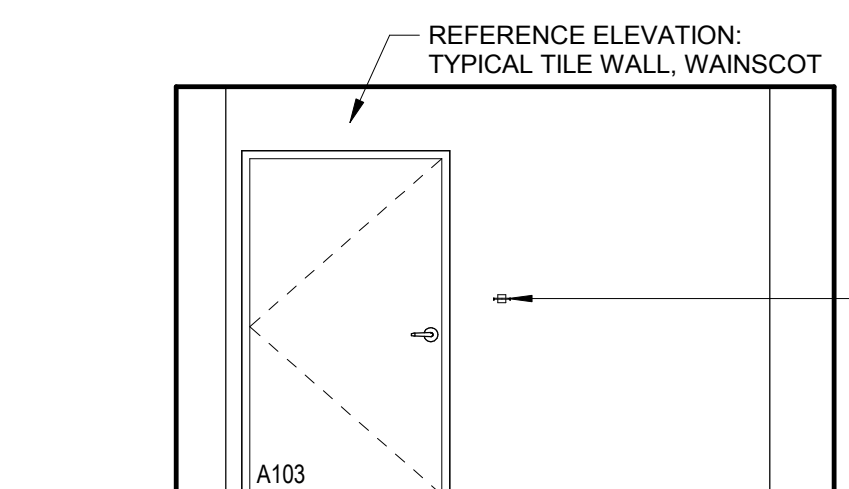


3.1 1/4" = 1'-0"

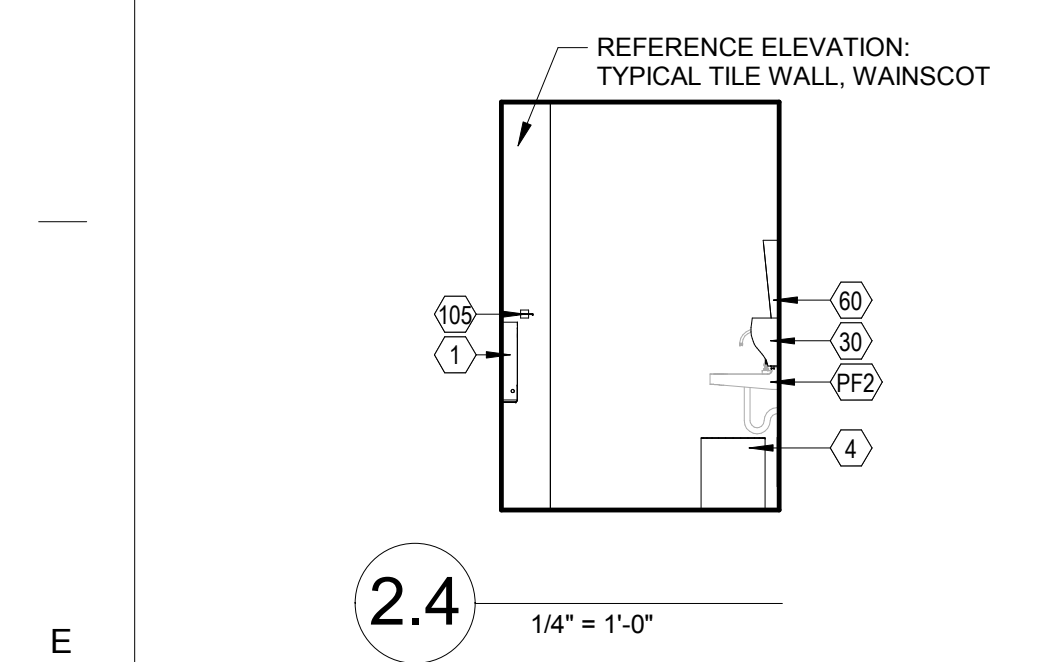


2.4 1/4" = 1'-0"

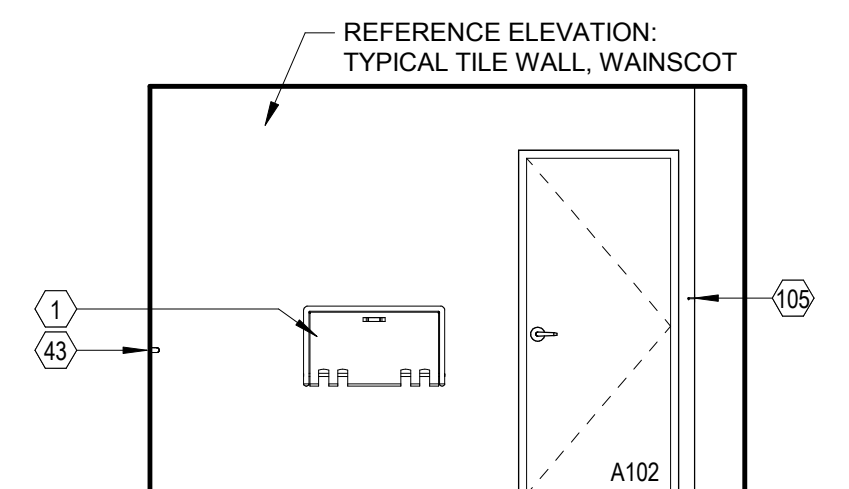


2.3 1/4" = 1'-0"

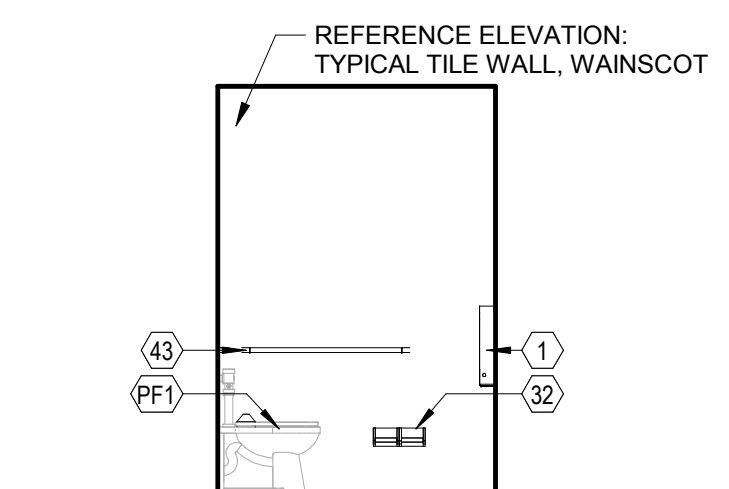


2.2 1/4" = 1'-0"

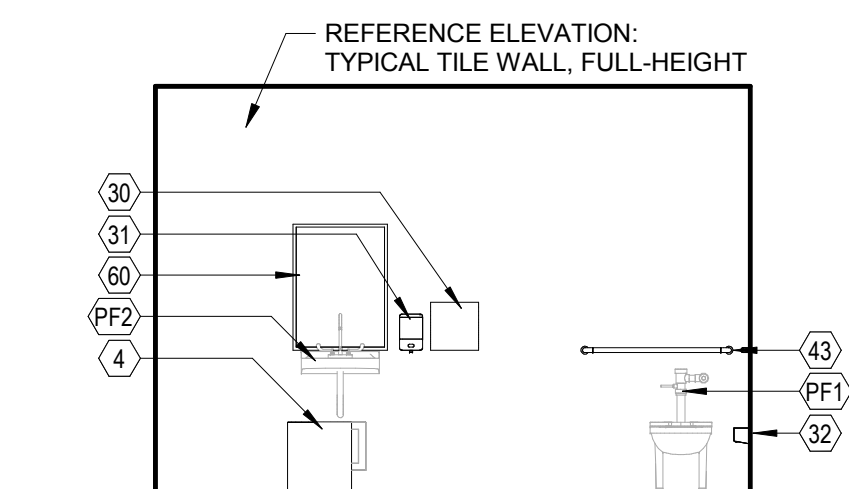


2.1 1/4" = 1'-0"

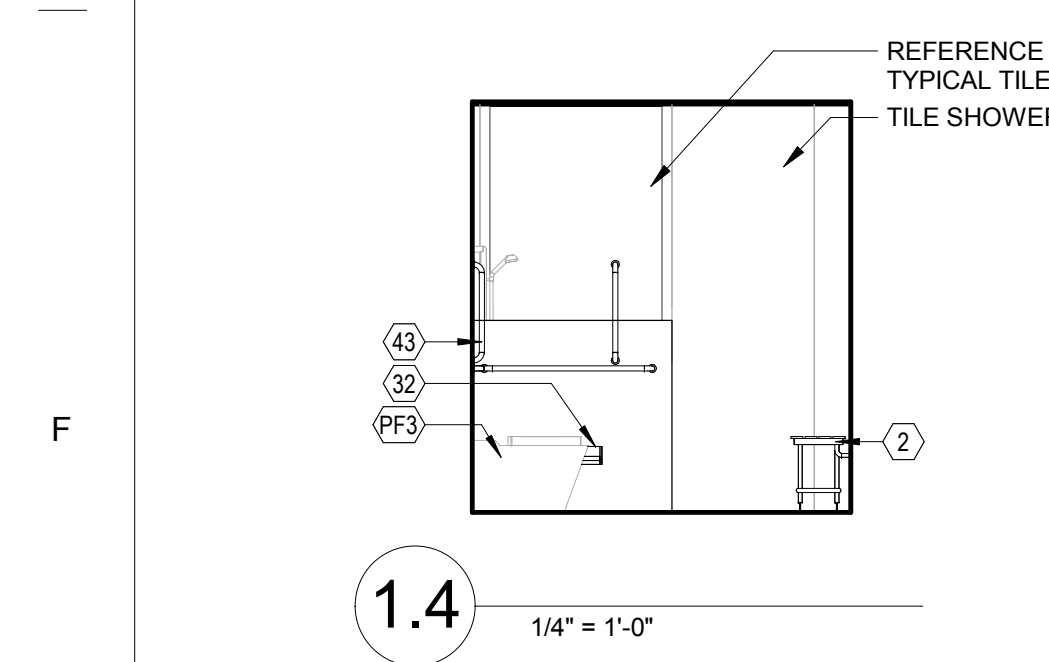


1.4 1/4" = 1'-0"

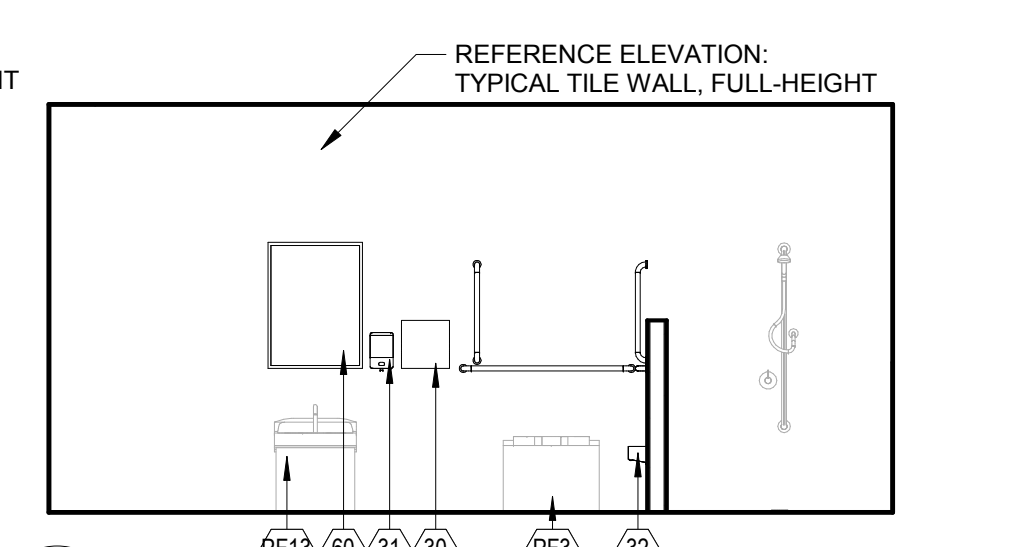

1.3 1/4" = 1'-0"

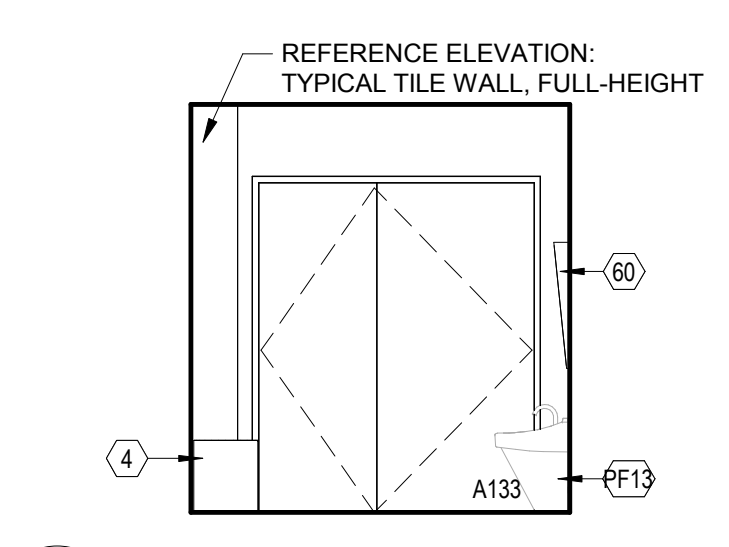

1.2 1/4" = 1'-0"

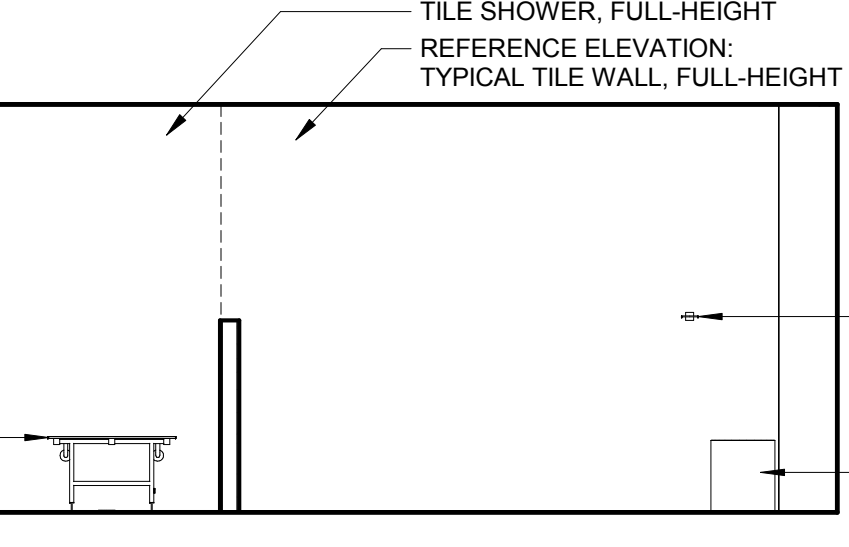

1.1 1/4" = 1'-0"

CONSULTANT INFORMATION

STRUCTURAL / CIVIL ENGINEER	MECHANICAL / ELECTRICAL / PLUMBING / TECHNICAL ENGINEER	FIRE PROTECTION ENGINEER
STAND STRUCTURAL ENGINEERING 11927 W. 112TH STREET, SUITE 200 OVERLAND PARK, KS 66210 (913) 214-2169	SPUR DESIGN 11020 KING STREET, SUITE 350 OVERLAND PARK, KS 66210 (405) 842-6100	POOLE FIRE PROTECTION, INC. 19910 W. 161ST STREET OLATH, KS 66062 (913) 829-8650

ARCHITECT

Office of Construction and Facilities Management

VA U.S. Department of Veteran Affairs

SPUR DESIGN

312 5th Street
Overland Park, KS 66209
spur-design.com

10000 Ring Road, Suite 300
Overland Park, KS 66209
spur-design.com

6728
MAY 10, 2017
KANSAS ARCHITECT

KS ARCH REG. NO. A-1139, EXP. 12/31/2019
KS ENGR REG. NO. E-2586, EXP. 12/31/2019

SHEET TITLE
WING A - FF&E - ENLARGED PLANS & ELEVATIONS

PROJECT PHASE
BID DOCUMENTS

FULLY SPRINKLERED

APPROVED: PROJECT DIRECTOR

PROJECT TITLE
RENOVATE A & B WING BUILDING 6

PROJECT LOCATION
2200 SW GAGE BLVD.
TOPEKA, KS 66622

DATE
07/10/2019

CHECKED BY
AWM

DRAWN BY
JET

VA PROJECT NUMBER
589A5-19-116

BUILDING NUMBER
6

DRAWING NUMBER
6-AS-400

Dwg. 21 OF 160





FURNITURE, FIXTURE, & EQUIPMENT NOTES

1. ALL FURNITURE, FIXTURES, AND EQUIPMENT ARE SHOWN AS BASIS OF DESIGN.
2. GENERAL CONTRACTOR TO PROVIDE METAL SUPPORT BLOCKING AS REQUIRED.
3. REFERENCE AS-600 - INTERIOR FINISH SCHEDULES AND DETAILS FOR TYPICAL CORRIDOR AND TOILET ROOM WALL FINISH ELEVATIONS.
4. ALL PLUMBING FIXTURES ARE CONTRACTOR PROVIDED, CONTRACTOR INSTALLED.

FURNITURE, FIXTURE, & EQUIPMENT SCHEDULE

MARK	FURNITURE/FIXTURE/EQUIPMENT	ACQ/INS	MARK	FURNITURE/FIXTURE/EQUIPMENT	ACQ/INS
1	BARATRIC SHOWER SEAT	C/C	66	PHYSIOMAX UE BKE SYSTEM	V/V
2	BARATRIC SHOWER SEAT	C/C	69	PREP TABLE	V/V
3	BARATRIC HILO MAT	V/V	70	PRINTER/COPPER/FAX COMBO	V/V
4	BAKNET, WASTE/PAPER	V/V	71	PULLEY SYSTEM	V/V
5	BOARD, BULLETIN	V/V	72	RACK, MAGAZINE, WALL-MOUNTED	V/V
6	BRACKET, TELEVISION, WALL-MNTD, TILT ANGLE	V/V	73	RAIL, ACCESSORY	V/C
7	BREWER, COFFEE	V/V	74	REFRIGERATOR, 4P	C/C
8	CABINET, BEDSIDE	V/V	75	REFRIGERATOR, U-C OR F-S	C/C
9	CART, STORAGE	V/V	76	REFRIGERATOR-FREEZER	C/C
10	CHAIR, DINING	V/V	77	RESIDENT BED	V/V
11	COFFEE TABLE, 52" x 52"	V/V	79	SHELVING, STORAGE	V/V
12	CHAIR, RECLINER	V/V	80	SIDE CHAIR, WITH ARMS	V/V
13	CHAIR, SIDE, BARATRIC, WITH ARMS	V/V	81	SOFA	V/V
14	CHAIR, SWIVEL, HIGH BACK	V/V	82	SPRIG/MONITOR/METER, AERIOD	V/V
15	CHAIR, SWIVEL, LOW BACK	V/V	83	STAIRS, EXISTING VA EQUIP	V/V
16	CLIMBING BOARD AND BAR	V/V	86	STOOL, SELF-ADJUSTING	V/V
17	CLOCK, BATTERY, 12"	V/V	88	TABLE	V/V
18	COLD PACK UNIT, EXISTING VA EQUIP	V/V	89	TABLE, LAMP	V/V
19	COMPUTER	V/V	90	TABLE, COFFEE	V/V
20	COMPUTER WITH FLAT PANEL MONITOR	V/V	91	TABLE, COFFEE, 24" x 48"	V/V
21	CONFERENCE CHAIR	V/V	92	TABLE, COMPUTER	V/V
22	CREDENZA	V/V	93	TABLE, EXAM/TREATMENT	V/V
24	CUBICAL TRACK, W/ CURTAIN	V/V	94	TABLE, SIDE	V/V
25	DINING TABLE AND CHAIRS	V/V	95	TELECOMMUNICATION OUTLET	C/C
26	DISHWASHER	C/C	96	TELEPHONE, CONFERENCE SYSTEM	V/V
27	DISPENSER, GLOVE, SURGICAL-EXAMINATION	V/V	98	TELEPHONE, WALL-MOUNTED, 1 LINE	V/V
29	DISPENSER, PAPER CLIP, SS	V/V	99	TELEVISION BACKING	C/C
30	DISPENSER, PAPER TOWEL, SENSOR, HANDS FREE	C/C	101	TELEVISION, HDTV, 60"	V/V
31	DISPENSER, SOAP, DISPOSABLE	V/V	102	TRACK, CUBICLE, WITH CURTAIN	C/C
32	DISPENSER, TOILET ROLL	C/C	103	URINAL, SCREEN	C/C
33	DOUBLE BED, BARATRIC	V/V	104	VIDEO TELECONFERENCE SYSTEM	V/V
34	DVD PLAYER	V/V	105	WALL HOOK	C/C
35	FIRE EXTINGUISHER CABINET, RECESSED	C/C	106	WASHER DRYER	V/V
36	FIRE EXTINGUISHER CABINET, SURFACE MOUNT	C/C	107	WASTE DISPOSAL UNIT, SHARPS	V/V
38	FOLD-DOWN GRAB BAR	C/C	108	WHITE BOARD, BULLETIN BOARD COMBINATION	V/V
40	FOLD-DOWN SHOWER SEAT	C/C	109	WINDOW SHADE ROLLER	C/C
43	GRAB BAR	C/C	110	WORKSTATION	V/V
45	HANDRAIL	V/C	111	WORKSTATION, COMPUTER, WALL MOUNTED	V/V
47	HILO TREATMENT TABLE, EXISTING VA EQUIP	V/V	115	HOOD, EXHAUST, NON-COMMERCIAL	C/C
48	HYDROCLULATOR UNIT, EXISTING VA EQUIP	V/V	116	POPCORN MACHINE	V/V
49	ICE MAKER	C/C	117	ACCORDION WALL	C/C
53	LIGHT, EXAM, MOBILE	V/V	119	METAL LOCKERS	C/C
54	WALL-MOUNTED TELEVISION, 32"	V/C	120	RANGE	C/C
56	LOUNGE CHAIR	V/V	121	SUPPORT BRACKET	C/C
57	MEDICAL DISTRIBUTION SYSTEM	V/V	122	WINGBACK CHAIR	V/V
58	MEDICINE BALL RACK	V/V	123	RECESSED CURTAIN TRACK	C/C
59	MEETING TABLE	V/V	124	LOVESEAT	V/V
60	MIRROR, FLOAT GLASS, ADA	C/C	125	ELECTRIC FIREPLACE	C/C
61	MOBILE WEIGHT RACK STORAGE	V/V	126	SOFA TABLE	V/V
62	MUSTER, EXISTING VA EQUIP	V/V	127	PYXIS AUXILIARY CABINET	V/V
63	OTOSCOPE ORPHALMOSCOPE	V/V	128	PYXIS CONTROL CABINET	V/V
64	OVEN, MICRO/WAVE	V/V	129	MED. REFRIGERATOR	V/V
65	PARALLEL BARS, EXISTING VA EQUIP	V/V	130	VIRTUAL AQUARIUM DISPLAY SYSTEM	C/C

MARK	PLUMBING FIXTURE	COMMENTS
PF1	SHOWE DRAIN, 3" DIAMETER	
PF2	TOILET, FLOOR-MOUNTED	
PF3	LAVATORY, WALL-MOUNTED	
PF4	TOILET, FLOOR-MOUNTED, BARATRIC	REFERENCE AS-700 FOR BARATRIC FIXTURE SUPPORTS
PF5	DRINKING FOUNTAIN, WITH BOTTLE FILLER	
PF6	SHOWER TRIM	
PF7	OVERFLOW DRAIN, 3" DIAMETER	
PF8	SINK, DROP-IN, 20" x 18"	
PF9	SHOWE DRAIN, 3" DIAMETER	
PF10	SINK, DROP-IN, DOUBLE	
PF11	SINK, MOP	
PF12	BATHTUB, WALK-IN	
PF13	LAVATORY, BARATRIC	REFERENCE AS-700 FOR BARATRIC FIXTURE SUPPORTS
PF14	TRAP PRIMER	

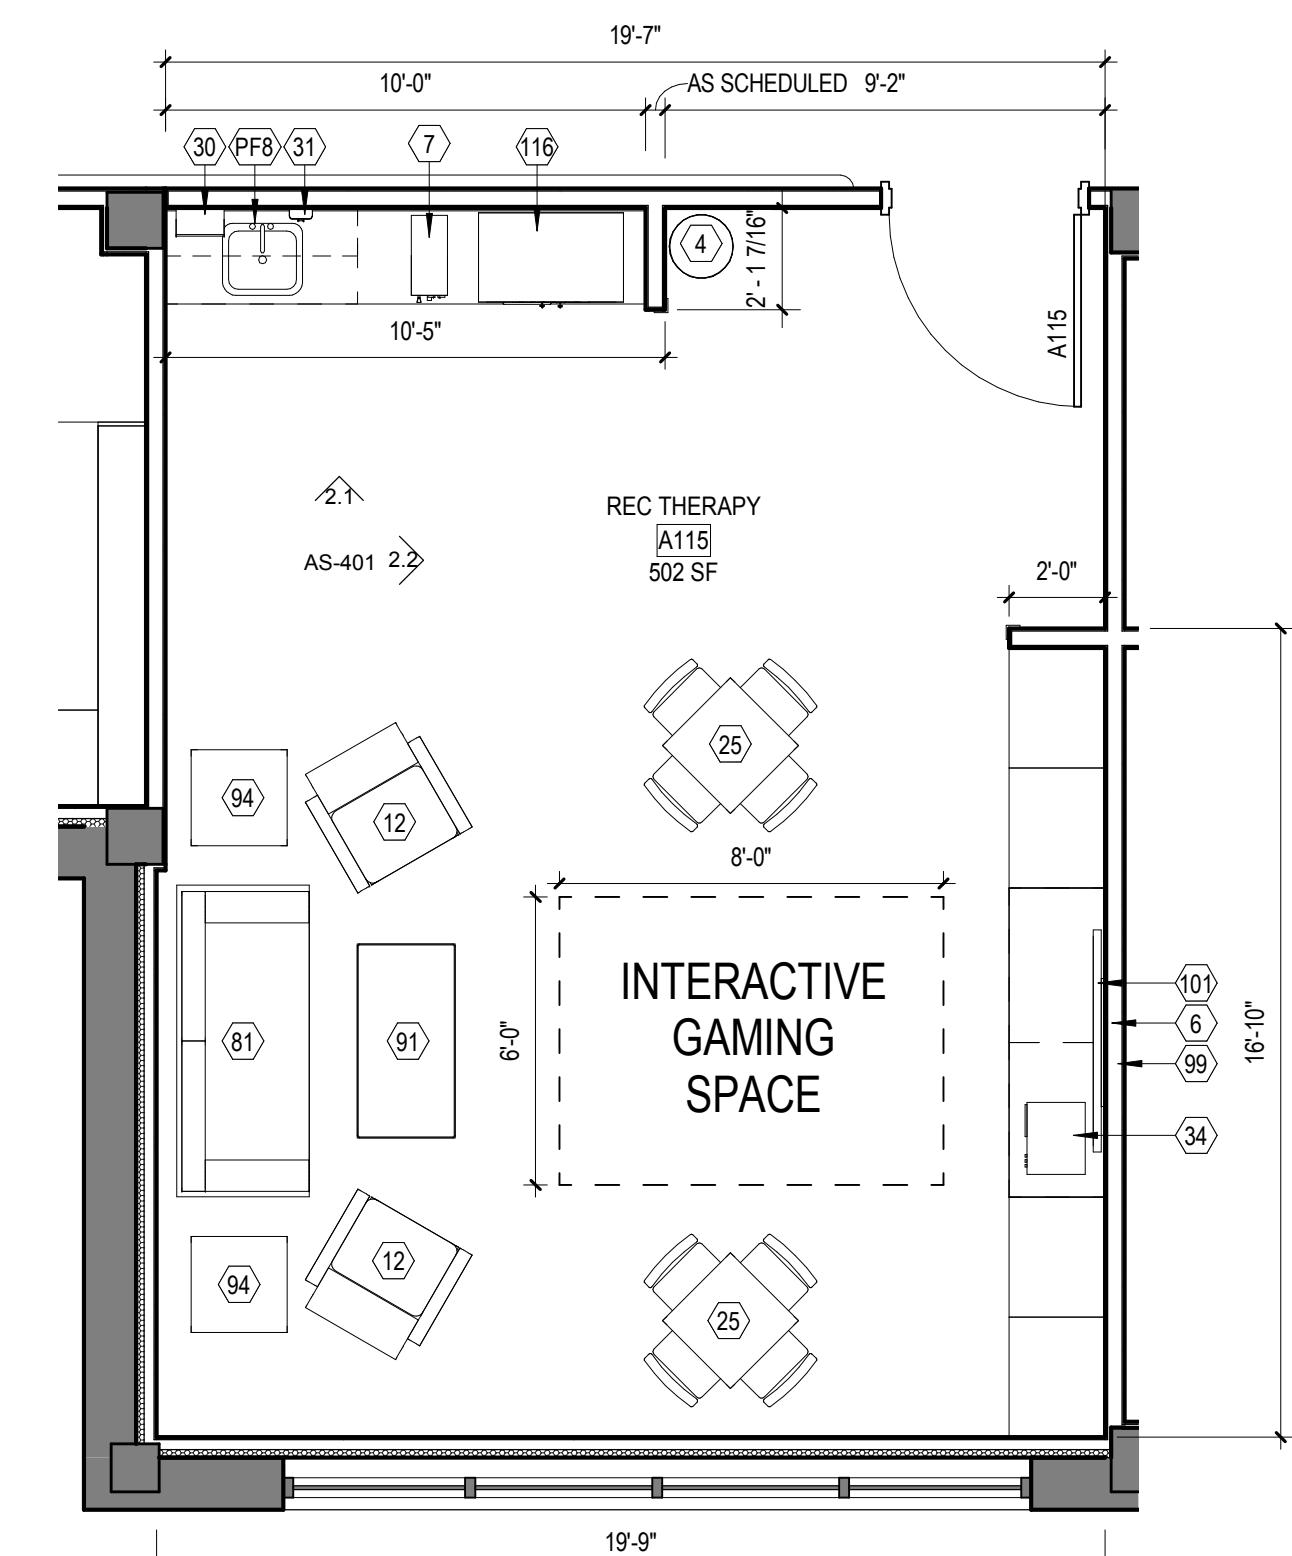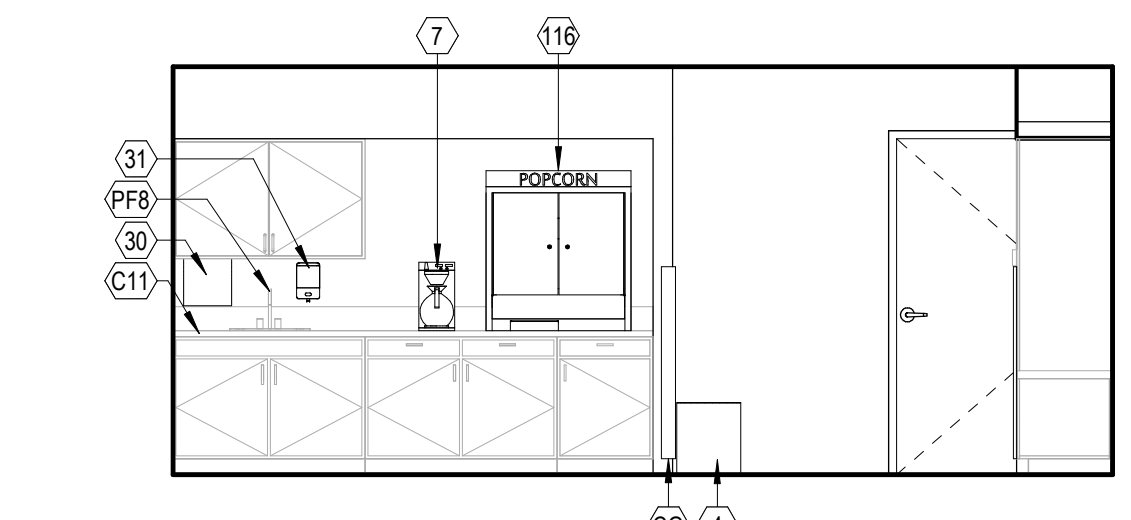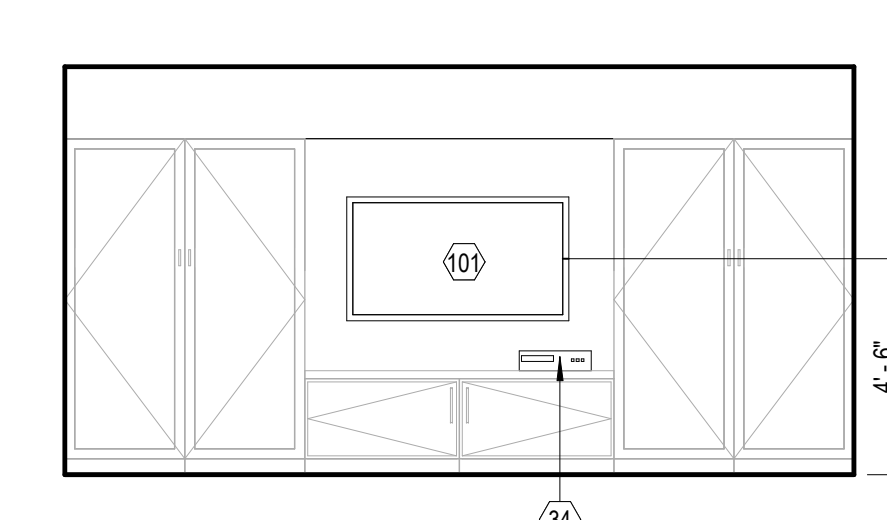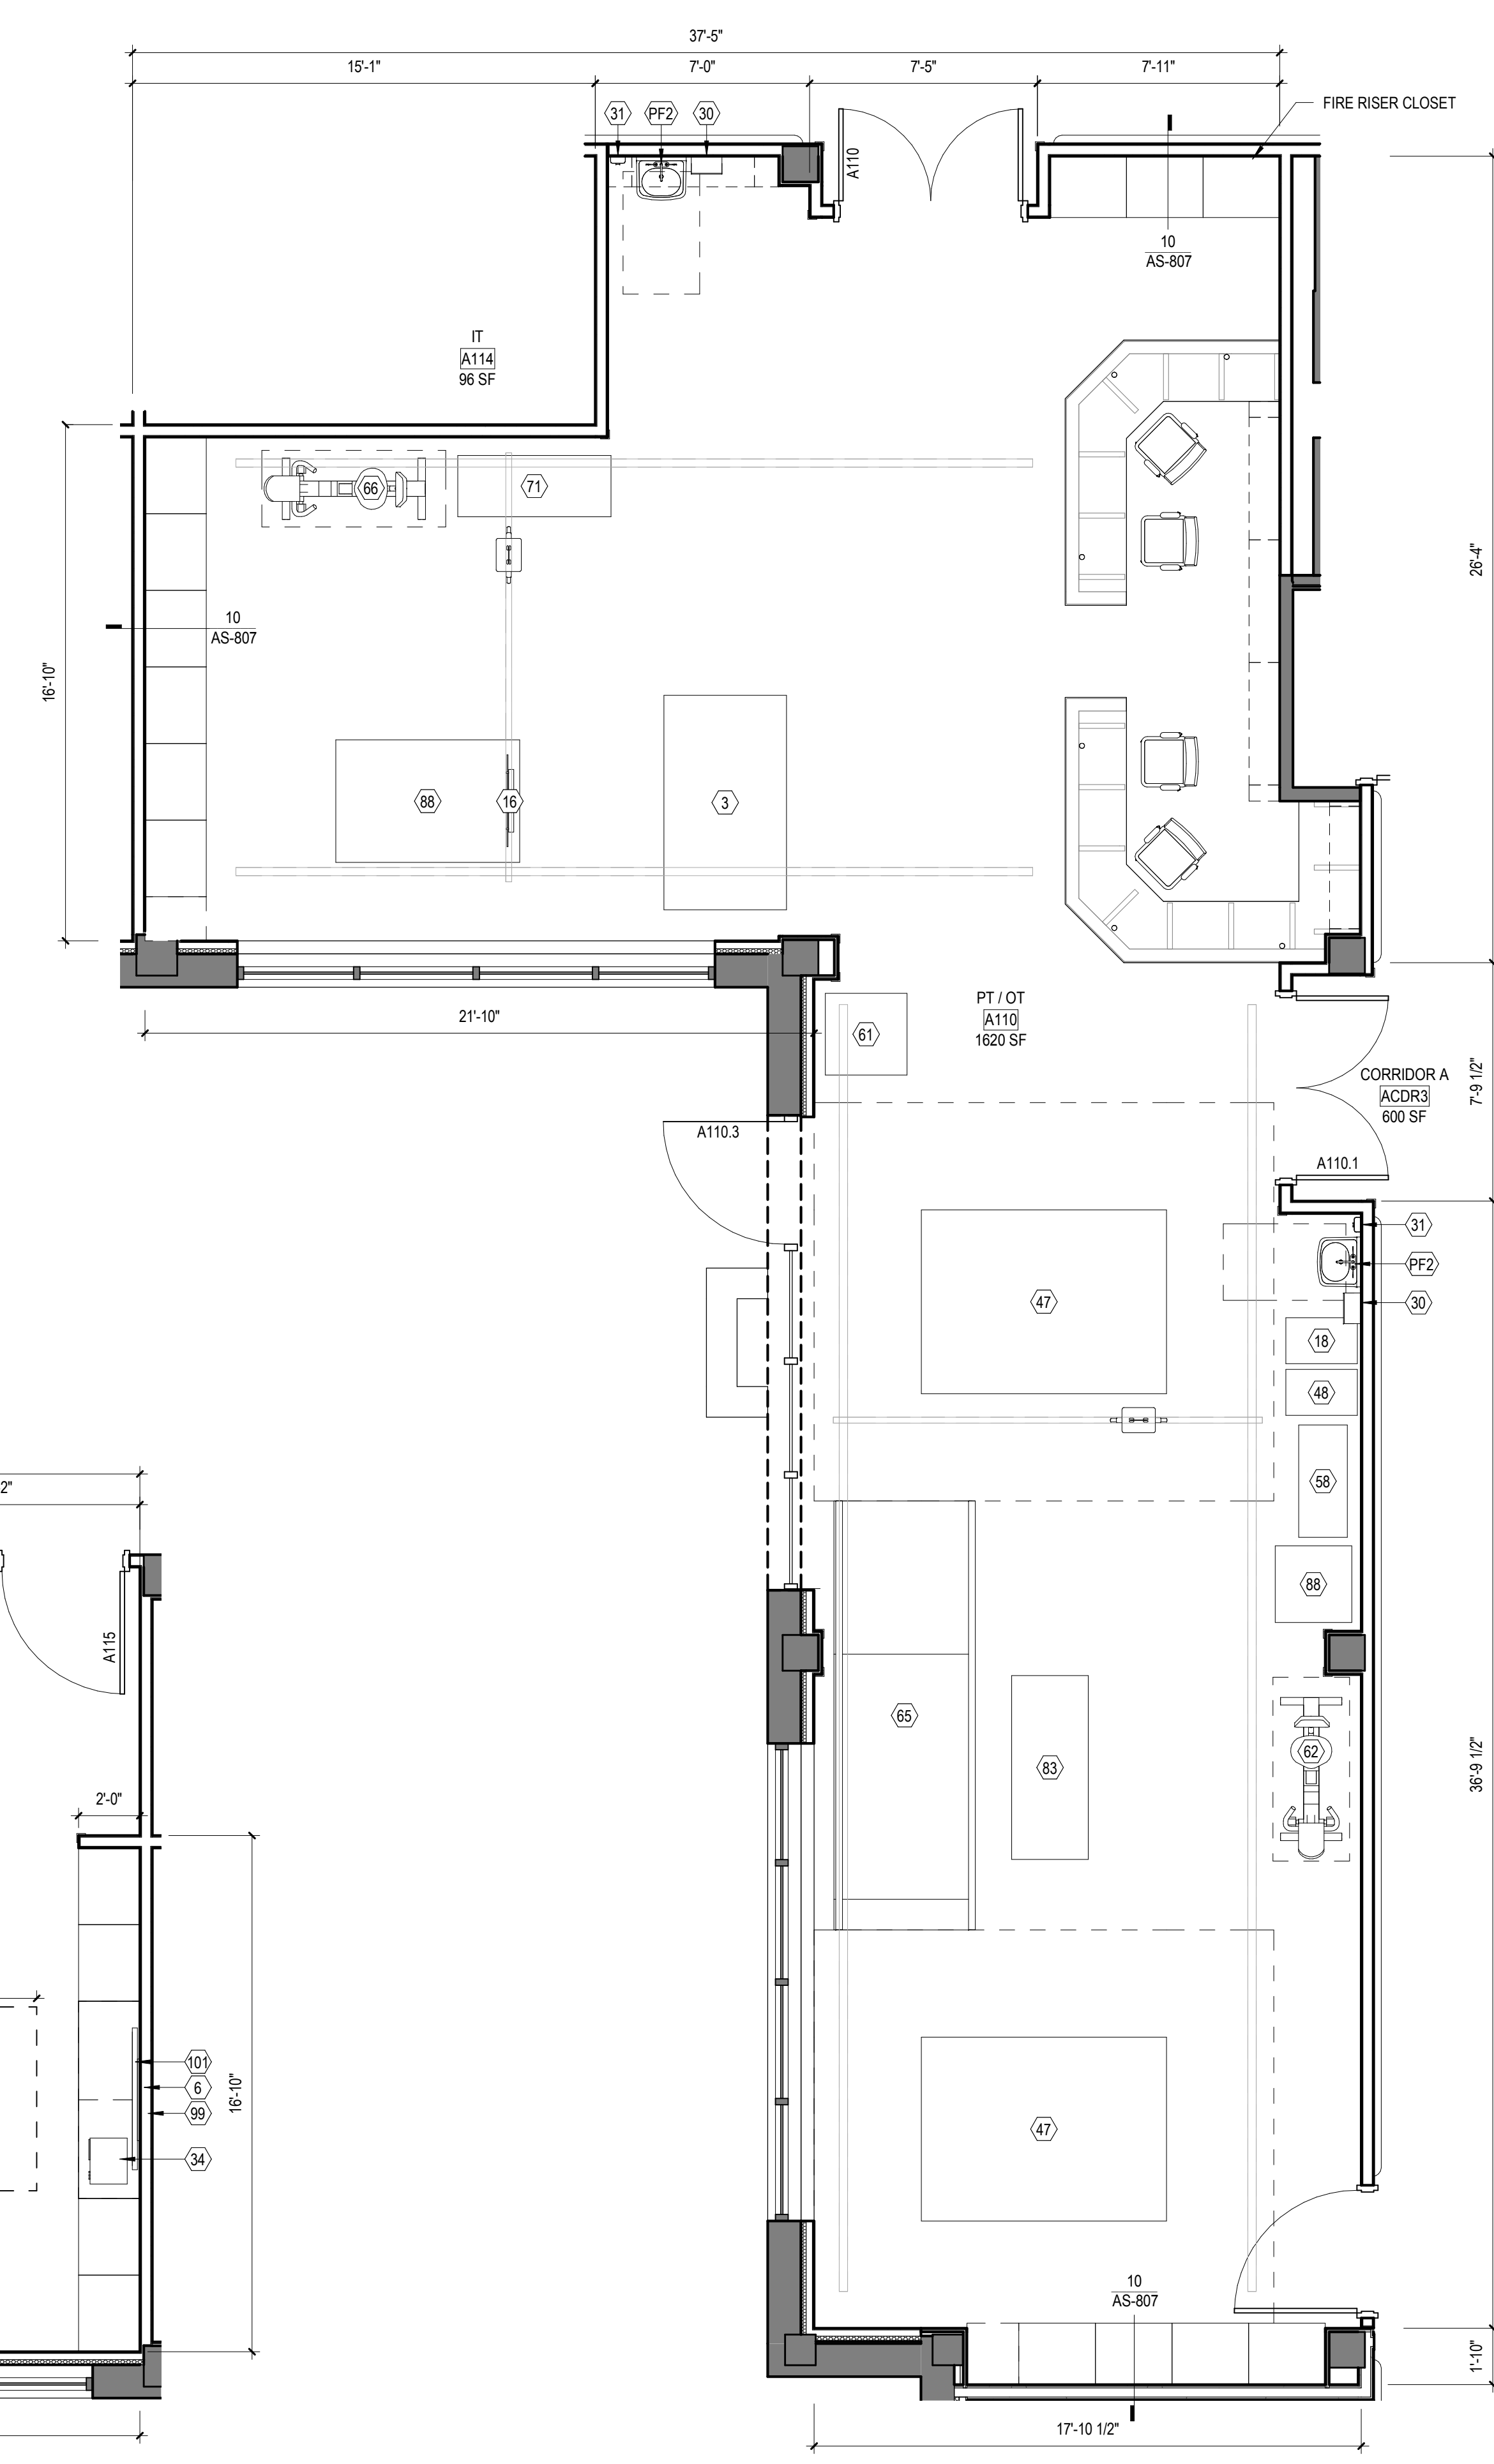


2.2 1/4" = 1'-0"

2.1 1/4" = 1'-0"

2 1/4" = 1'-0"

1 WING A - PT/OT
1/4" = 1'-0"

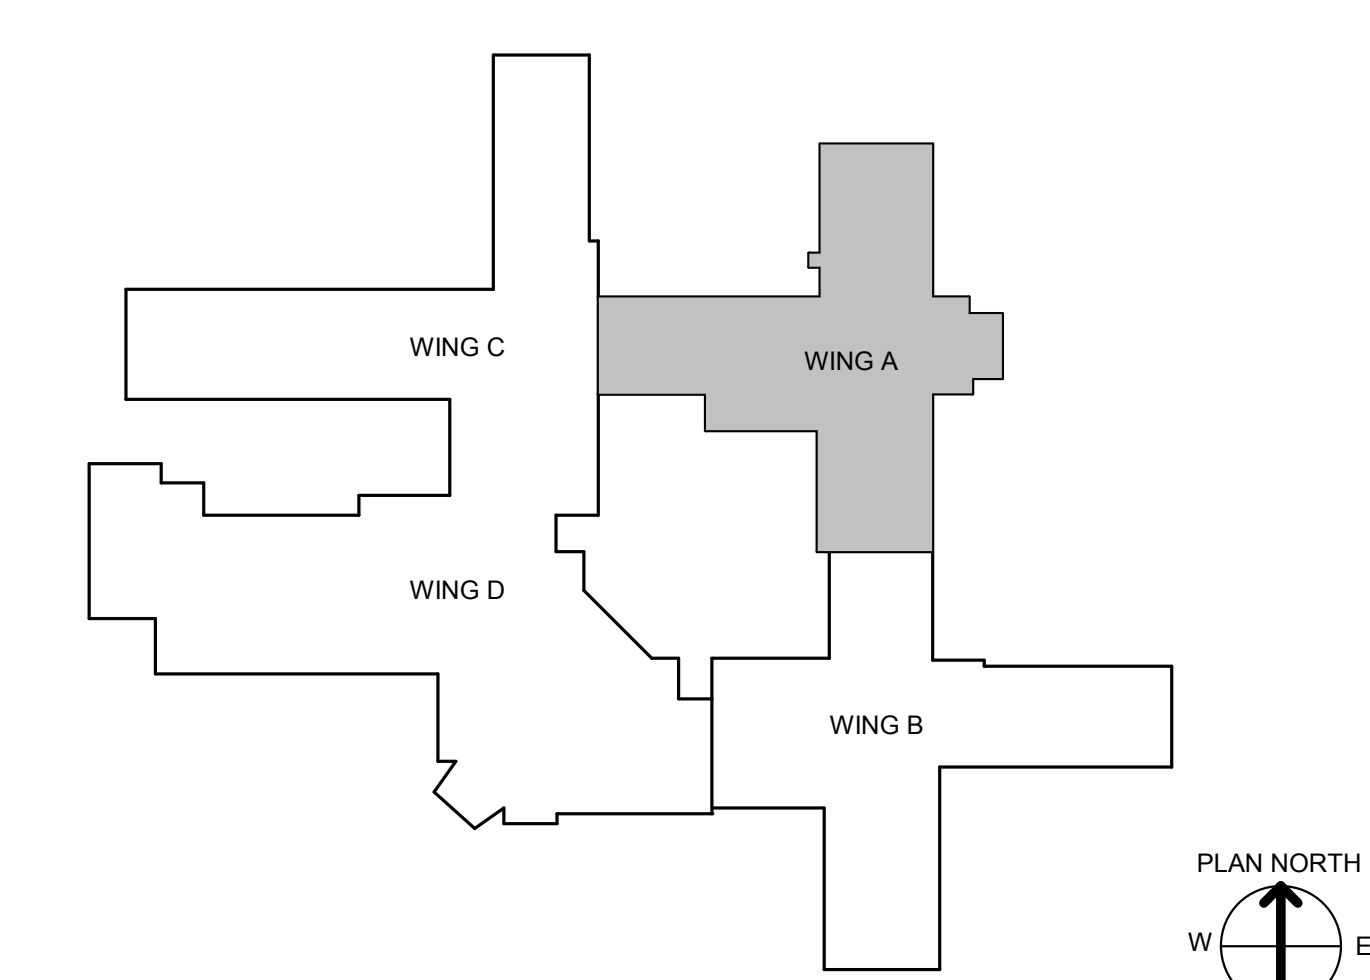

CONSULTANT INFORMATION		
STRUCTURAL / CIVIL ENGINEER	MECHANICAL / ELECTRICAL / PLUMBING / TECHNICAL ENGINEER	FIRE PROTECTION ENGINEER
STAND STRUCTURAL ENGINEERING 11927 W. 112TH STREET, SUITE 200 OVERLAND PARK, KS 66210 (913) 214-2169	SPUR DESIGN 11020 KING STREET, SUITE 350 OVERLAND PARK, KS 66210 (405) 829-6100	POOLE FIRE PROTECTION, INC. 19910 W. 161ST STREET OLATH, KS 66062 (913) 829-8650

ARCHITECT

Office of Construction and Facilities Management

VA U.S. Department of Veteran Affairs

SPUR DESIGN

313 5th Street, Overland Park, KS 66204
11020 King Street, Suite 350, Overland Park, KS 66210
spur-design.com

6728
JULY 10, 2019
KANSAS ARCHITECT

KS ARCH REG. NO. A-1139, EXP. 12/31/2019
KS ENGR REG. NO. E-2586, EXP. 12/31/2019

SHEET TITLE
WING A - FF&E - ENLARGED PLANS & ELEVATIONS

APPROVED: PROJECT DIRECTOR

PROJECT PHASE
BID DOCUMENTS

FULLY SPRINKLERED

PROJECT TITLE RENOVATE A & B WING BUILDING 6	VA PROJECT NUMBER 589A5-19-116
PROJECT LOCATION 2200 SW GAGE BLVD. TOPEKA, KS 66622	BUILDING NUMBER 6
DATE 07/10/2019	DRAWN BY JET
CHECKED BY AWM	Dwg. 22 OF 160

A

B

C

D

E

F


FURNITURE, FIXTURE, & EQUIPMENT NOTES

1. ALL FURNITURE, FIXTURES, AND EQUIPMENT ARE SHOWN AS BASIS OF DESIGN.
2. GENERAL CONTRACTOR TO PROVIDE METAL SUPPORT BLOCKING AS REQUIRED.
3. REFERENCE AS-400 - INTERIOR FINISH SCHEDULES AND DETAILS FOR TYPICAL CORRIDOR AND TOILET ROOM WALL FINISH ELEVATIONS
4. ALL PLUMBING FIXTURES ARE CONTRACTOR PROVIDED, CONTRACTOR INSTALLED.


FURNITURE, FIXTURE, & EQUIPMENT SCHEDULE

MARK	FURNITURE/FIXTURE/EQUIPMENT	ACQ/INS	MARK	FURNITURE/FIXTURE/EQUIPMENT	ACQ/INS
1	BARBARIC SHOWER SEAT	C/C	66	PHYSIOMAX UE BIKE SYSTEM	V/V
2	BARBARIC HLO MAT	V/V	69	PREP TABLE	V/V
3	BASKET, WASTE/PAPER	V/V	70	PRINTER/COPIER/FAX COMBO	V/V
4	BOARD BULLETIN	V/V	71	PULLEY SYSTEM	V/V
5	BRACKET, TELEVISION, WALL-MNTD, TILT ANGLE	V/V	72	RACK, MAGAZINE, WALL-MOUNTED	V/V
6	BREWER, COFFEE	V/V	73	RAIL, ACCESSORY	V/C
7	CABINET, BEDSIDE	V/V	74	REFRIGERATOR, 48"	C/C
8	CART, STORAGE	V/V	75	REFRIGERATOR, U-C OR F-S	C/C
9	CHAIR, SWIVEL, HIGH BACK	V/V	76	REFRIGERATOR-FREEZER	C/C
10	CHAIR, SWIVEL, LOW BACK	V/V	77	RESIDENT BED	V/V
11	CHAIR, DINING	V/V	78	RESIDENT BED	V/V
12	CHAIR, RECLINER, BARIATRIC, WITH ARMS	V/V	79	SHELVING, STORAGE	V/V
13	CHAIR, SWIVEL, HIGH BACK	V/V	80	SIDE CHAIR, WITH ARMS	V/V
14	CHAIR, SWIVEL, LOW BACK	V/V	81	SOFA	V/V
15	CHAIR, SWIVEL, LOW BACK	V/V	82	SPHYGMOMANOMETER, ANEROID	V/V
16	CLIMBING BOARD AND BAR	V/V	83	STAIRS, EXISTING VA EQUIP	V/V
17	CLOCK, BATTERY, 12"	V/V	86	STOOL, SELF-ADJUSTING	V/V
18	COLD PACK UNIT, EXISTING VA EQUIP	V/V	88	TABLE	V/V
19	COMPUTER	V/V	89	TABLE LAMP	V/V
20	COMPUTER WITH FLAT PANEL MONITOR	V/V	90	TABLE, COFFEE	V/V
21	CONFERENCE CHAIR	V/V	91	TABLE, COFFEE, 24" X 48"	V/V
22	CREDENZA	V/V	92	TABLE, COMPUTER	V/V
23	CUBICAL TRACK, W/ CURTAIN	C/C	93	TABLE, EXAM/TREATMENT	V/V
24	DINING TABLE AND CHAIRS	C/C	94	TABLE, SIDE	V/V
25	DISHWASHER	C/C	95	TELECOMMUNICATION OUTLET	C/C
26	DISPENSER, GLOVE, SURGICAL-EXAMINATION	V/V	96	TELEPHONE, CONFERENCEING SYSTEM	V/V
27	DISPENSER, PAPER CUP, SS	V/V	98	TELEPHONE, WALL-MOUNTED, 1 LINE	V/V
28	DISPENSER, PAPER TOWEL, SENSOR, HANDS FREE	C/C	99	TELEVISION BACKING	C/C
29	DISPENSER, SOAP DISPOSABLE	V/V	101	TELEVISION, HDTV, 60"	V/V
30	DISPENSER, TOILET ROLL	C/C	102	TRACK, CURTAIN, WITH CURTAIN	C/C
31	DOUBLE BED, BARIATRIC	V/V	103	URINAL SCREEN	C/C
32	DVD PLAYER	V/V	104	VIDEO TELECONFERENCEING SYSTEM	V/V
33	FIRE EXTINGUISHER CABINET, RECESSED	C/C	105	WALL HOOK	C/C
34	FIRE EXTINGUISHER CABINET, SURFACE MOUNT	C/C	106	WASHER DRYER	V/V
35	FIRE EXTINGUISHER CABINET, SURFACE MOUNT	C/C	107	WASTE DISPOSAL UNIT, SHARPS	V/V
36	FOLD-DOWN GRAB BAR	C/C	108	WHITE BOARD, BULLETIN BOARD COMBINATION	V/V
37	FOLD-DOWN SHOWER SEAT	C/C	109	WINDOW SHADE ROLLER	C/C
38	GRAB BAR	C/C	110	WORKSTATION	V/V
39	HANDRAIL	V/C	111	WORKSTATION, COMPUTER, WALL MOUNTED	V/V
40	HLO TREATMENT TABLE, EXISTING VA EQUIP	V/V	115	HOOD, EXHAUST, NON-COMMERCIAL	C/C
41	HYDROCLULATOR UNIT, EXISTING VA EQUIP	V/V	116	POPCORN MACHINE	V/V
42	ICE MAKER	C/C	117	ACCORDION WALL	C/C
43	LIGHT, EXAM, MOBILE	V/V	119	METAL LOCKERS	C/C
44	WALL-MOUNTED TELEVISION, 32"	V/C	120	RANGE	C/C
45	LOUNGE CHAIR	V/V	121	SUPPORT BRACKET	C/C
46	MEDICAL DISTRIBUTION SYSTEM	V/V	122	WINGBACK CHAIR	V/V
47	MEDICINE BALL RACK	V/V	123	RECESSED CURTAIN TRACK	C/C
48	MEETING TABLE	V/V	124	LOVESEAT	V/V
49	MIRROR, FLAT GLASS, ADA	C/C	125	ELECTRIC FIREPLACE	C/C
50	MOBILE WEIGHT RACK STORAGE	V/V	126	SOFA TABLE	V/V
51	MUSTEP, EXISTING VA EQUIP	V/V	127	PYXIS AUXILIARY CABINET	V/V
52	OTOSCOPE OPHTHALMOSCOPE	V/V	128	PYXIS CONTROL CABINET	V/V
53	OVEN, MIRCOWAVE	V/V	129	MED. REFRIGERATOR	V/V
54	PARALLEL BARS, EXISTING VA EQUIP	V/V	130	VIRTUAL AQUARIUM DISPLAY SYSTEM	C/C


MARK	PLUMBING FIXTURE	COMMENTS
PF1	TOILET, FLOOR-MOUNTED	
PF2	LAVATORY, WALL-MOUNTED	
PF3	TOILET, FLOOR-MOUNTED, BARIATRIC	REFERENCE AS-700 FOR BARIATRIC FIXTURE SUPPORTS
PF4	DRINKING FOUNTAIN, WITH BOTTLE FILLER	
PF5	SHOWER TRIM	
PF6	OVERFLOW DRAIN, 3" DIAMETER	
PF8	SINK, DROP-IN, 20" X 18"	
PF9	SHOWER DRAIN, 3" DIAMETER	
PF10	SINK, DROP-IN, DOUBLE	
PF11	SINK, MOP	
PF12	BATHTUB, WALK-IN	
PF13	LAVATORY, BARIATRIC	REFERENCE AS-700 FOR BARIATRIC FIXTURE SUPPORTS
PF14	TRAP PRIMER	

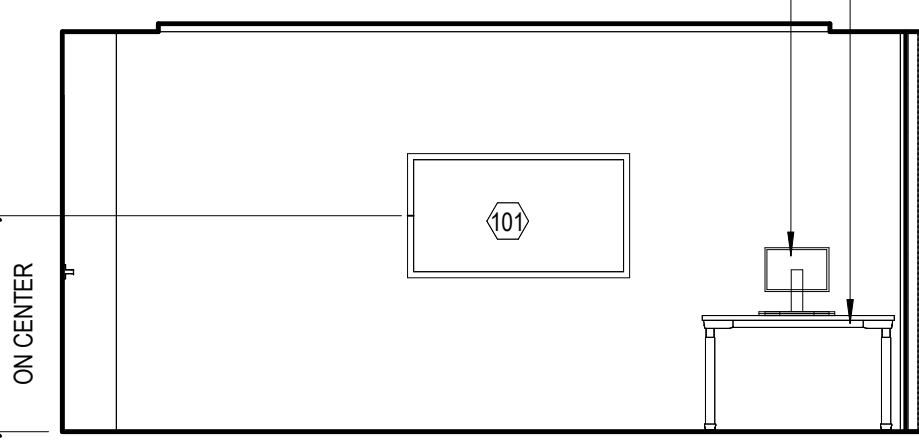


6.1 1/4" = 1'-0"

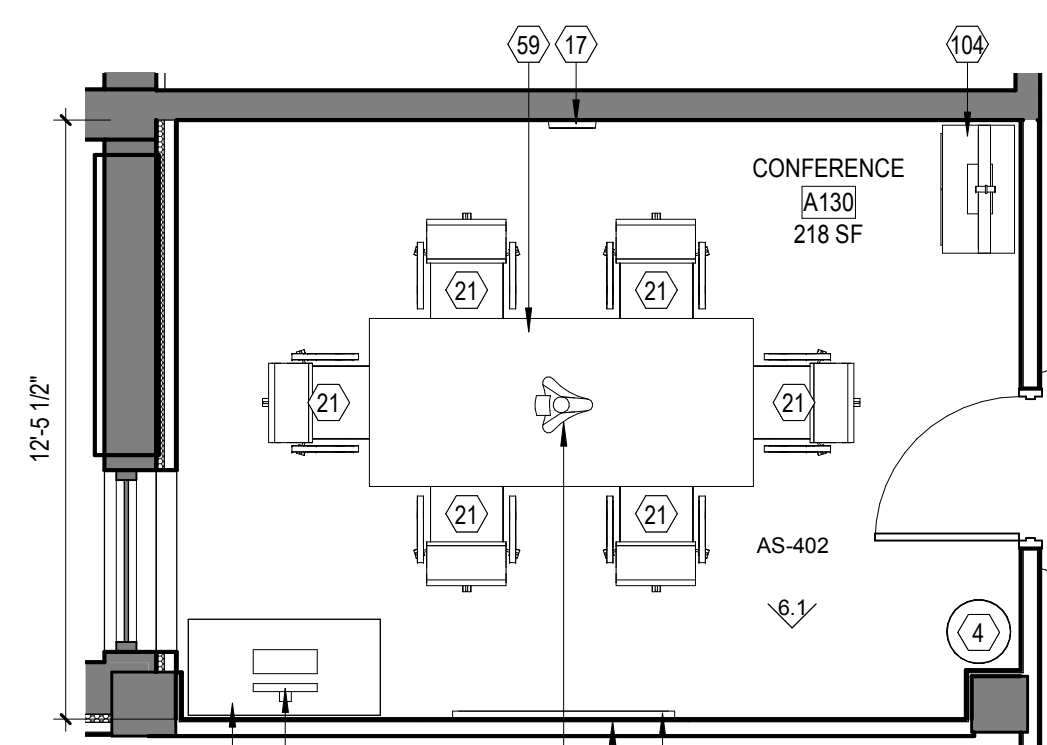


6 WING A - CONFERENCE 1/4" = 1'-0"

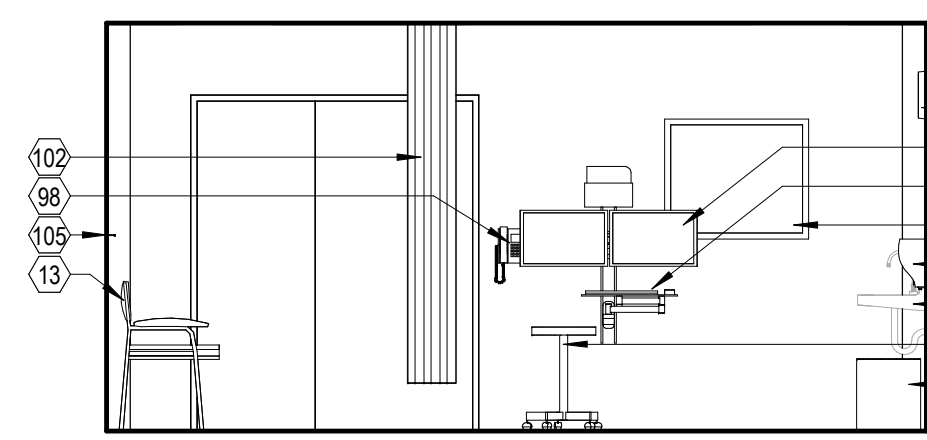


5.2 1/4" = 1'-0"

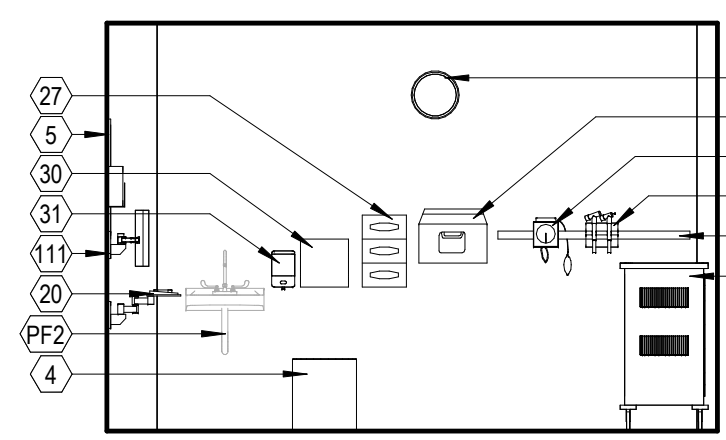


5.1 1/4" = 1'-0"

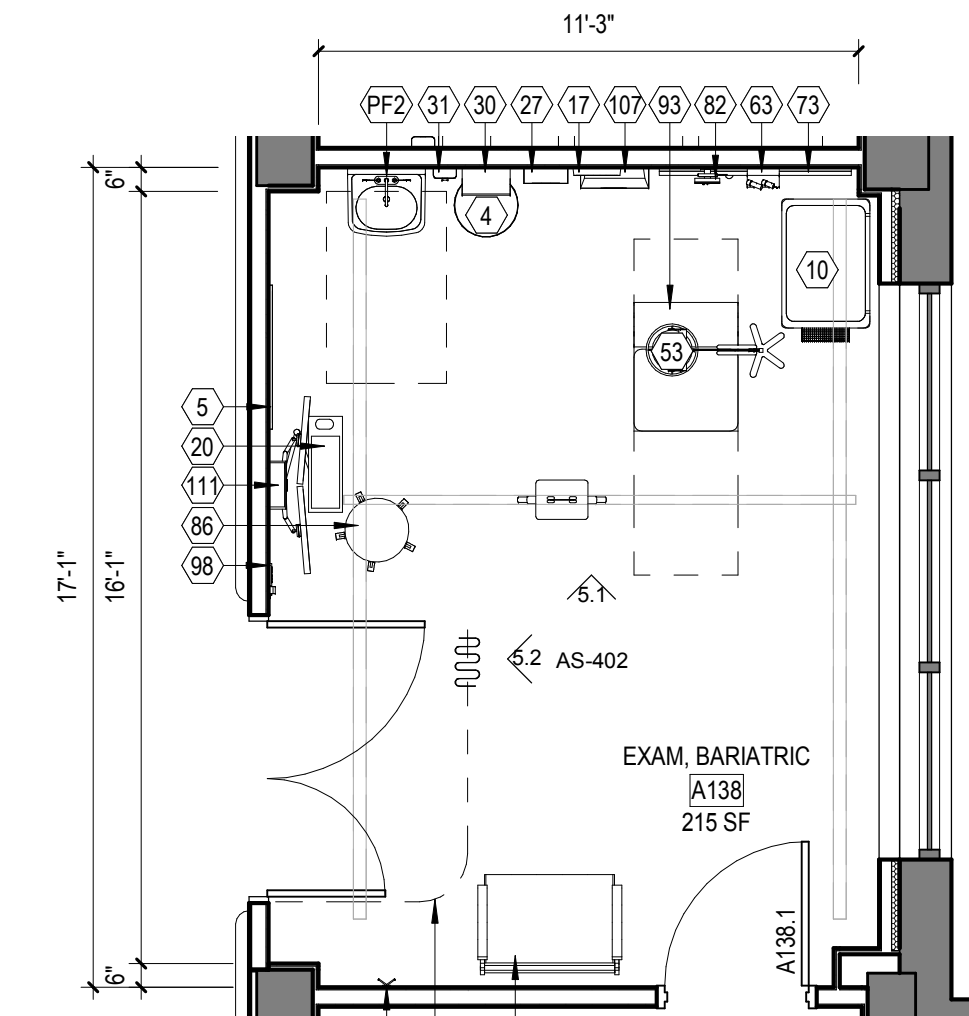


5 WING A - EXAM, BARIATRIC 1/4" = 1'-0"

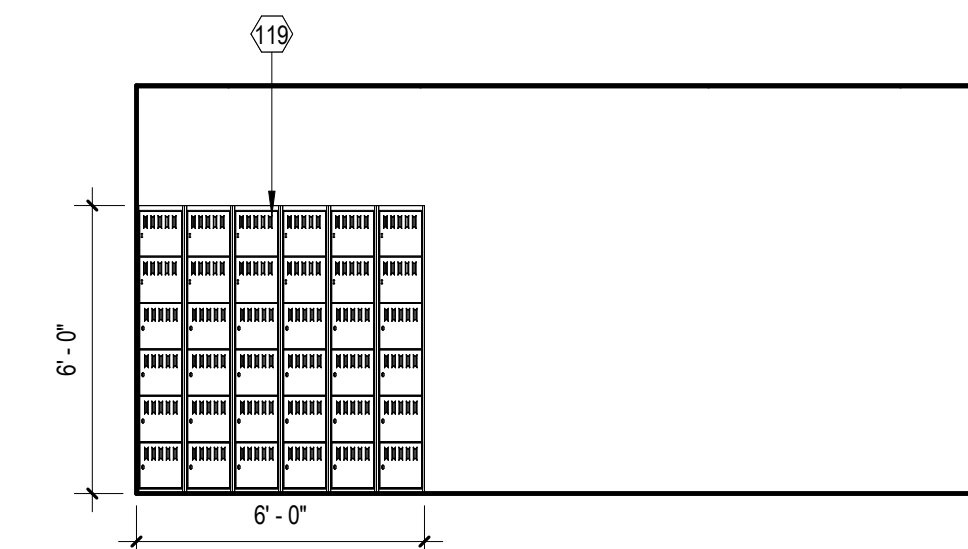


4.2 1/4" = 1'-0"

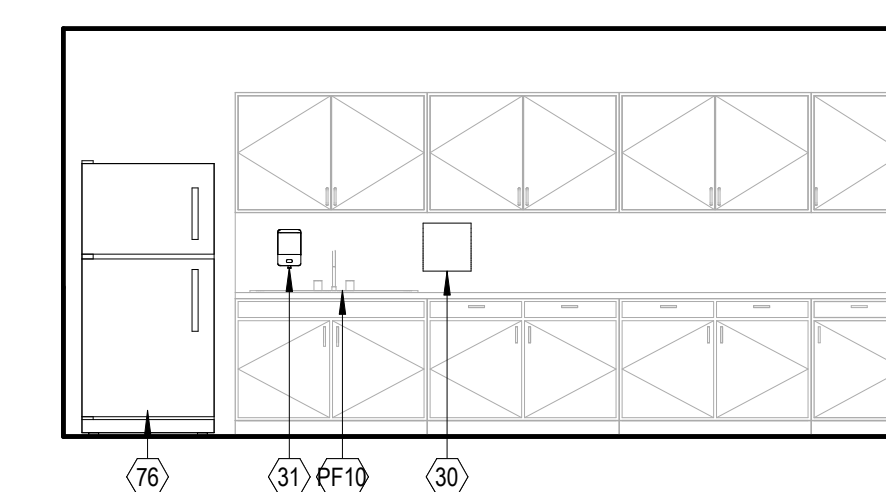


4.1 1/4" = 1'-0"

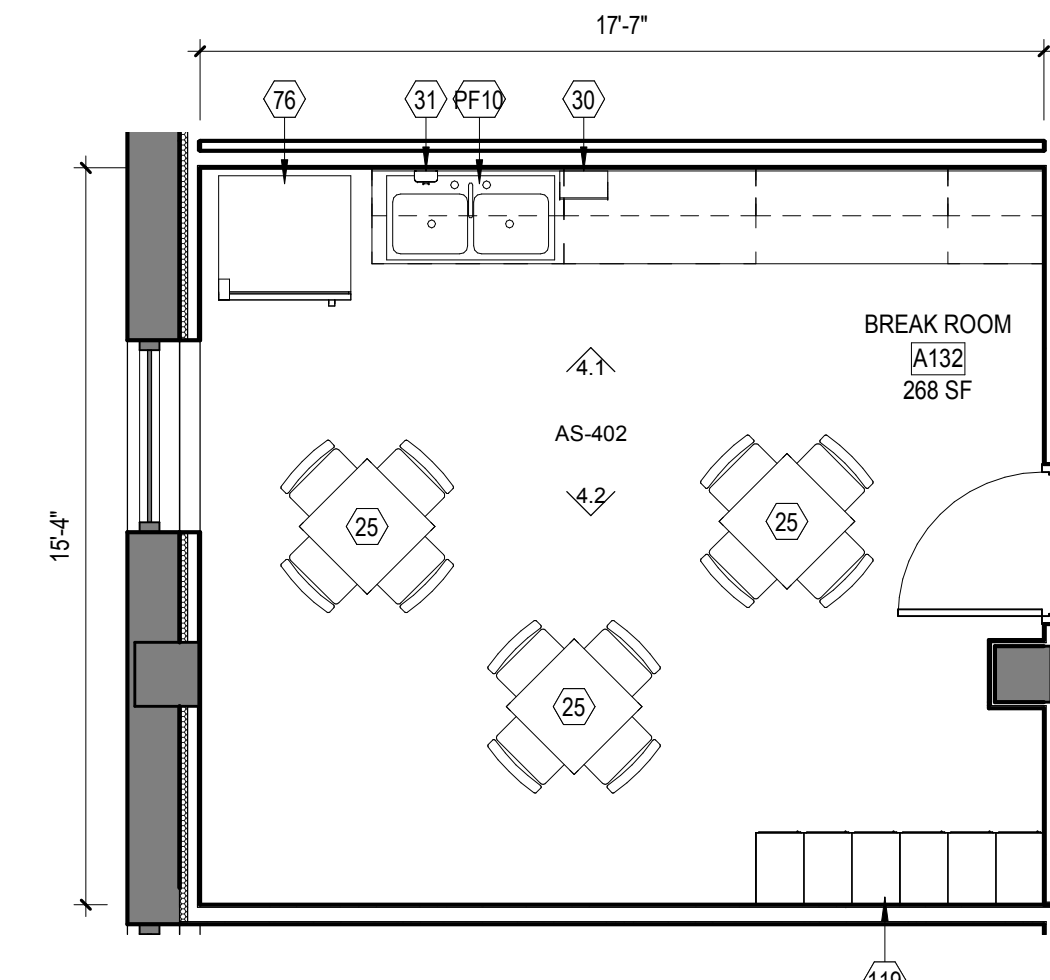


4 WING A - BREAK ROOM 1/4" = 1'-0"

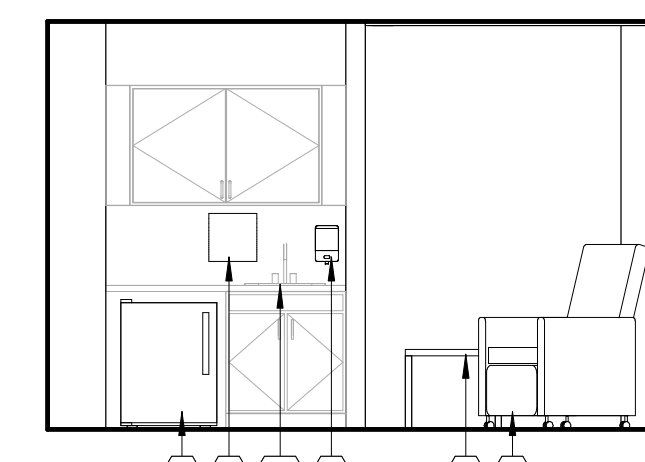


3.3 1/4" = 1'-0"

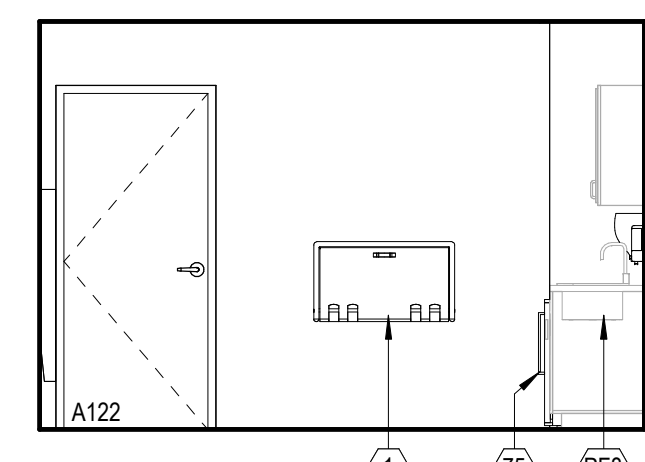


3.2 1/4" = 1'-0"

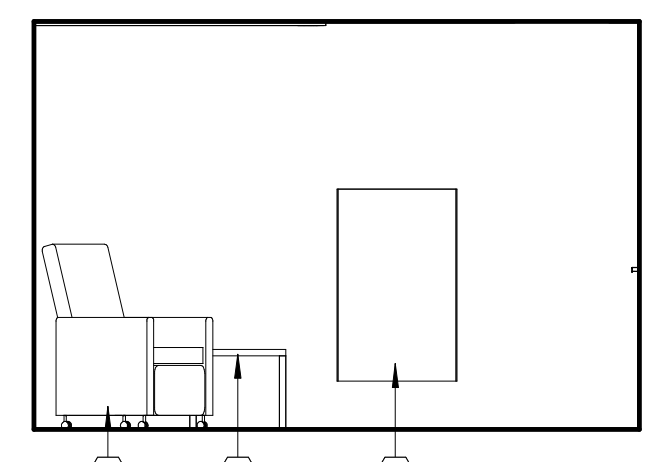


3.1 1/4" = 1'-0"

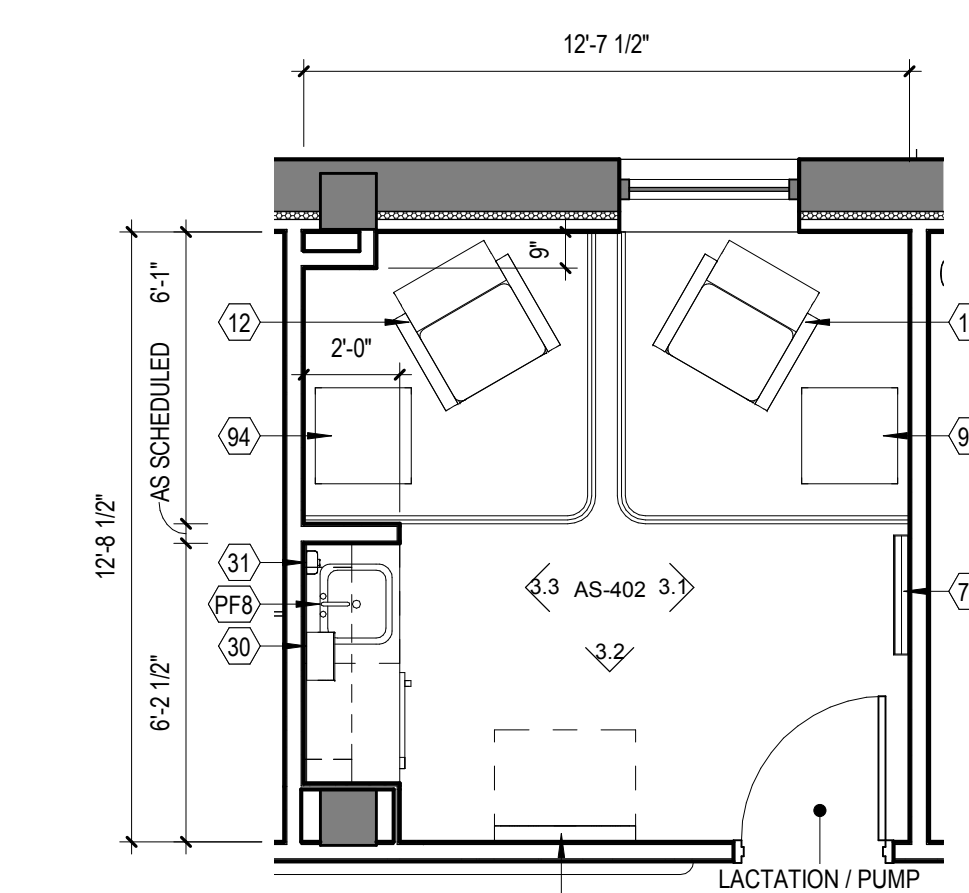


3 WING A - LACTATION / PUMP 1/4" = 1'-0"

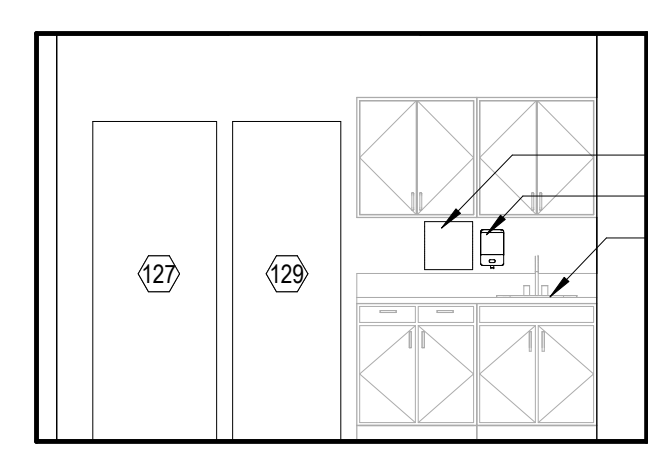


2.1 1/4" = 1'-0"

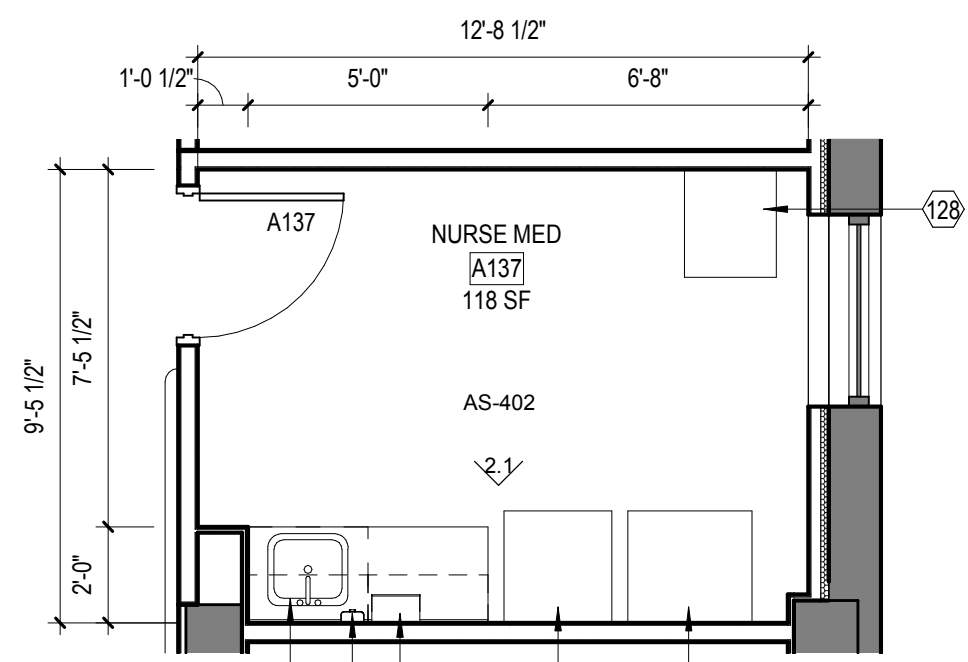


2 WING A - NURSE MED 1/4" = 1'-0"

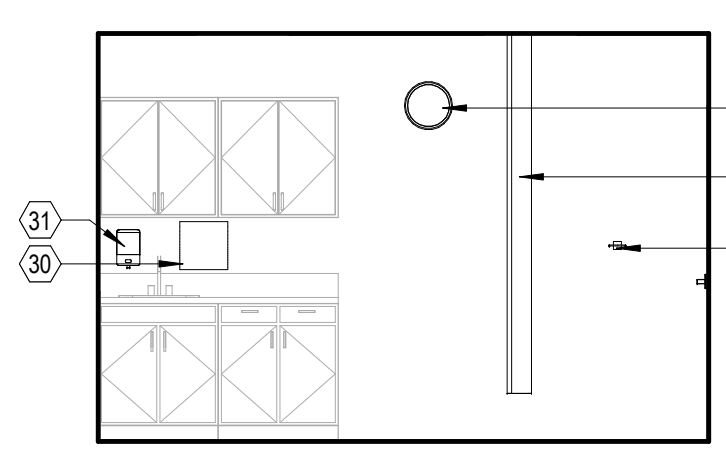

1.1 1/4" = 1'-0"

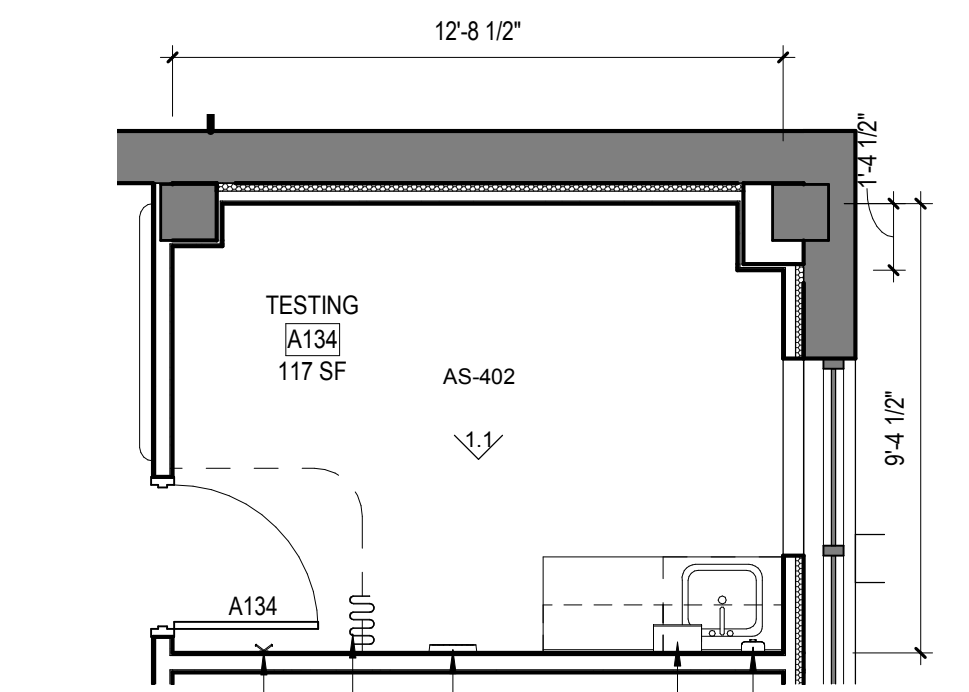

1 WING A - TESTING 1/4" = 1'-0"

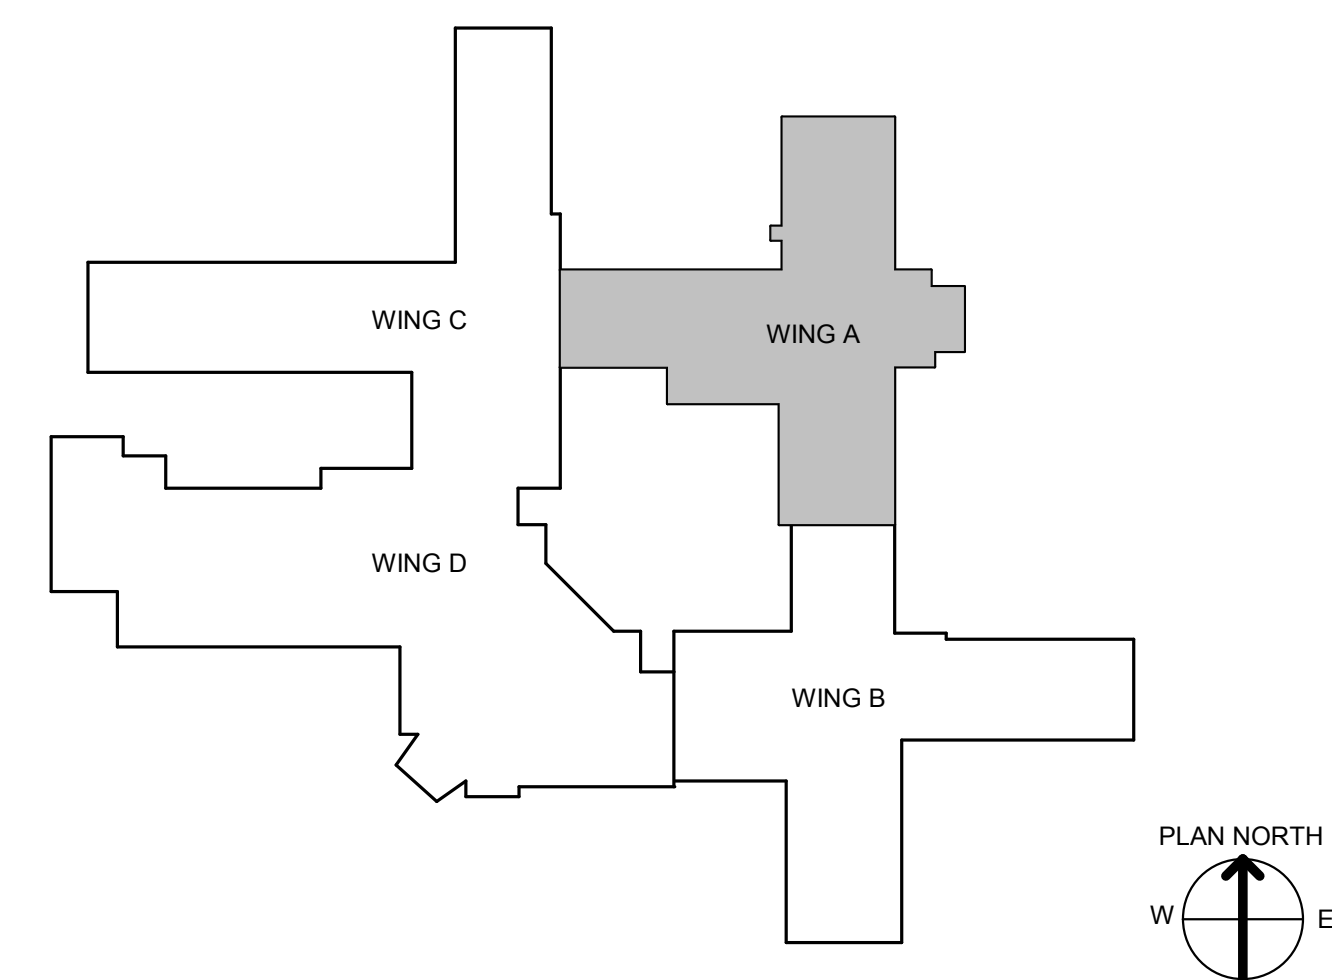

CONSULTANT INFORMATION

STRUCTURAL / CIVIL ENGINEER
 STAND STRUCTURAL ENGINEERING
 11227 W. 112TH STREET, SUITE 200
 OVERLAND PARK, KS 66210
 (913) 214-2169

MECHANICAL / ELECTRICAL / PLUMBING / TECHNICAL ENGINEER
 SPUR DESIGN
 11020 KING STREET, SUITE 350
 OVERLAND PARK, KS 66210
 (405) 842-6100

FIRE PROTECTION ENGINEER
 POOLE FIRE PROTECTION, INC.
 19910 W. 161ST STREET
 OLATH, KS 66062
 (913) 829-8650

ARCHITECT

SPUR DESIGN

313 SF 23th Street
 Overland Park, KS 66205
 spur-design.com

10020 King Street, Suite 300
 Overland Park, KS 66210
 spur-design.com

KS ARCH REG. NO. A-1139, EXP. 12/31/2019
 KS ENGR REG. NO. E-2586, EXP. 12/31/2019

6728
 JULY 10, 2017
 KANSAS ARCHITECT

Office of Construction and Facilities Management

VA U.S. Department of Veteran Affairs

SHEET TITLE
WING A - FF&E - ENLARGED PLANS & ELEVATIONS

APPROVED: PROJECT DIRECTOR

PROJECT PHASE
BID DOCUMENTS

FULLY SPRINKLERED

PROJECT TITLE
RENOVATE A & B WING BUILDING 6

PROJECT LOCATION
2200 SW GAGE BLVD.
TOPEKA, KS 66622

DATE
07/10/2019

CHECKED BY
AWM

DRAWN BY
JET

VA PROJECT NUMBER
589A5-19-116

BUILDING NUMBER
6

DRAWING NUMBER
6-AS-402

Dwg. 23 OF 160


FURNITURE, FIXTURE, & EQUIPMENT NOTES

1. ALL FURNITURE, FIXTURES, AND EQUIPMENT ARE SHOWN AS BASIS OF DESIGN.
2. GENERAL CONTRACTOR TO PROVIDE METAL SUPPORT BLOCKING AS REQUIRED.
3. REFERENCE AS-400 - INTERIOR FINISH SCHEDULES AND DETAILS FOR TYPICAL CORRIDOR AND TOILET ROOM WALL FINISH ELEVATIONS
4. ALL PLUMBING FIXTURES ARE CONTRACTOR PROVIDED, CONTRACTOR INSTALLED.


FURNITURE, FIXTURE, & EQUIPMENT SCHEDULE

MARK	FURNITURE/FIXTURE/EQUIPMENT	ACQ/INS	MARK	FURNITURE/FIXTURE/EQUIPMENT	ACQ/INS
1	BARBIER CHAIR	V/V	66	PHYSIOMAX UE BRK SYSTEM	V/V
2	BARBIER SHOWER SEAT	C/C	69	PREP TABLE	V/V
3	BARBIER HLO MAT	V/V	70	PRINTER/COPIER/FAX COMBO	V/V
4	BASKET, WASTE/PAPER	V/V	71	PULLEY SYSTEM	V/V
5	BOARD, BULLETIN	V/V	72	RACK, MAGAZINE, WALL-MOUNTED	V/V
6	BRACKET, TELEVISION, WALL-MNTD, TILT ANGLE	V/V	73	RAIL, ACCESSORY	V/C
7	BREWER, COFFEE	V/V	74	REFRIGERATOR, 48"	C/C
9	CABINET, BEDSIDE	V/V	75	REFRIGERATOR, L-C OR F-S	C/C
10	CART, STORAGE	V/V	76	REFRIGERATOR-FREEZER	C/C
11	CHAIR, DINING	V/V	77	RESIDENT BED	V/V
11	COFFEE TABLE, 52" x 52"	V/V	79	SHELVING, STORAGE	V/V
12	CHAIR, RECLINER	V/V	80	SIDE CHAIR, WITH ARMS	V/V
13	CHAIR, SIDE, BARIATRIC, WITH ARMS	V/V	81	SOFA	V/V
14	CHAIR, SWIVEL, HIGH BACK	V/V	82	SPHYGMOMANOMETER, ANEROID	V/V
15	CHAIR, SWIVEL, LOW BACK	V/V	83	STAIRS, EXISTING VA EQUIP	V/V
16	CLIMBING BOARD AND BAR	V/V	86	STOOL, SELF-ADJUSTING	V/V
17	CLOCK BATTERY, 12"	V/V	88	TABLE	V/V
18	COLD PACK UNIT, EXISTING VA EQUIP	V/V	89	TABLE LAMP	V/V
19	COMPUTER	V/V	90	TABLE, COFFEE	V/V
20	COMPUTER WITH FLAT PANEL MONITOR	V/V	91	TABLE, COFFEE, 24" x 48"	V/V
21	CONFERENCE CHAIR	V/V	92	TABLE, COMPUTER	V/V
22	CREDENZA	V/V	93	TABLE, EXAM/TREATMENT	V/V
24	CUBICAL TRACK, W/ CURTAIN	C/C	94	TABLE, SIDE	V/V
25	DINING TABLE AND CHAIRS	V/V	95	TELECOMMUNICATION OUTLET	C/C
26	DISHWASHER	C/C	96	TELEPHONE, CONFERENCE/SYSTEM	V/V
27	DISPENSER, GLOVE, SURGICAL-EXAMINATION	V/V	98	TELEPHONE, WALL-MOUNTED, 1 LINE	V/V
28	DISPENSER, PAPER CLIP, SS	V/V	99	TELEVISION BAKING	C/C
30	DISPENSER, PAPER TOWEL, SENSOR, HANDS FREE	C/C	101	TELEVISION, HDTV, 48"	V/V
31	DISPENSER, SOAP, DISPOSABLE	V/V	102	TRACK, CURTAIN, WITH CURTAIN	C/C
32	DISPENSER, TOILET ROLL	C/C	103	URINAL SCREEN	C/C
33	DOUBLE BED, BARIATRIC	V/V	104	VIDEO TELECONFERENCE SYSTEM	V/V
34	DVD PLAYER	V/V	105	WALL HOOK	C/C
35	FIRE EXTINGUISHER CABINET, RECESSED	C/C	106	WASHER DRYER	V/V
36	FIRE EXTINGUISHER CABINET, SURFACE MOUNT	C/C	107	WASTE DISPOSAL UNIT, SHARPS	V/V
38	FOLD-DOWN GRAB BAR	C/C	108	WHITE BOARD, BULLETIN BOARD COMBINATION	V/V
40	FOLD-DOWN SHOWER SEAT	C/C	109	WINDOW SHADE ROLLER	C/C
43	GRAB BAR	C/C	110	WORKSTATION	V/V
45	HANDRAIL	V/C	111	WORKSTATION, COMPUTER, WALL MOUNTED	V/V
47	HLO TREATMENT TABLE, EXISTING VA EQUIP	V/V	115	HOOD, EXHAUST, NON-COMMERCIAL	C/C
48	HYDROCOLATOR UNIT, EXISTING VA EQUIP	V/V	116	POPCORN MACHINE	V/V
49	ICE MAKER	C/C	117	ACCORDION WALL	C/C
53	LIGHT, EXAM, MOBILE	V/V	119	METAL LOCKERS	C/C
54	WALL-MOUNTED TELEVISION, 32"	V/C	120	RANGE	C/C
56	LOUNGE CHAIR	V/V	121	SUPPORT BRACKET	C/C
57	MEDICAL DISTRIBUTION SYSTEM	V/V	122	WINGBACK CHAIR	V/V
58	MEDICINE BALL RACK	V/V	123	RECESSED CURTAIN TRACK	C/C
59	MEETING TABLE	V/V	124	LOVESEAT	V/V
60	MIRROR, FLAT GLASS, ADA	C/C	125	ELECTRIC FIREPLACE	C/C
61	MOBILE WEIGHT RACK STORAGE	V/V	126	SOFA TABLE	V/V
62	MUSTER, EXISTING VA EQUIP	V/V	127	PYXIS AUXILIARY CABINET	V/V
63	OTOSCOPE OPHTHALMOSCOPE	V/V	128	PYXIS CONTROL CABINET	V/V
64	OVEN, MIRCOWAVE	V/V	129	MED. REFRIGERATOR	V/V
65	PARALLEL BARS, EXISTING VA EQUIP	V/V	130	VIRTUAL AQUARIUM DISPLAY SYSTEM	C/C


MARK	PLUMBING FIXTURE	COMMENTS
	SHOWE DRAIN, 3" DIAMETER	
PF1	TOILET, FLOOR-MOUNTED	
PF2	LAVATORY, WALL-MOUNTED	
PF3	TOILET, FLOOR-MOUNTED, BARIATRIC	REFERENCE AS-700 FOR BARIATRIC FIXTURE SUPPORTS
PF4	DRINKING FOUNTAIN, WITH BOTTLE FILLER	
PF5	SHOWER TRIM	
PF6	OVERFLOW DRAIN, 3" DIAMETER	
PF8	SINK, DROP-IN, 20" x 18"	
PF9	SHOWE DRAIN, 3" DIAMETER	
PF10	SINK, DROP-IN, DOUBLE	
PF11	SINK, HOP	
PF12	BATHUB, WALK-IN	
PF13	LAVATORY, BARIATRIC	REFERENCE AS-700 FOR BARIATRIC FIXTURE SUPPORTS
PF14	TRAP PRIMER	

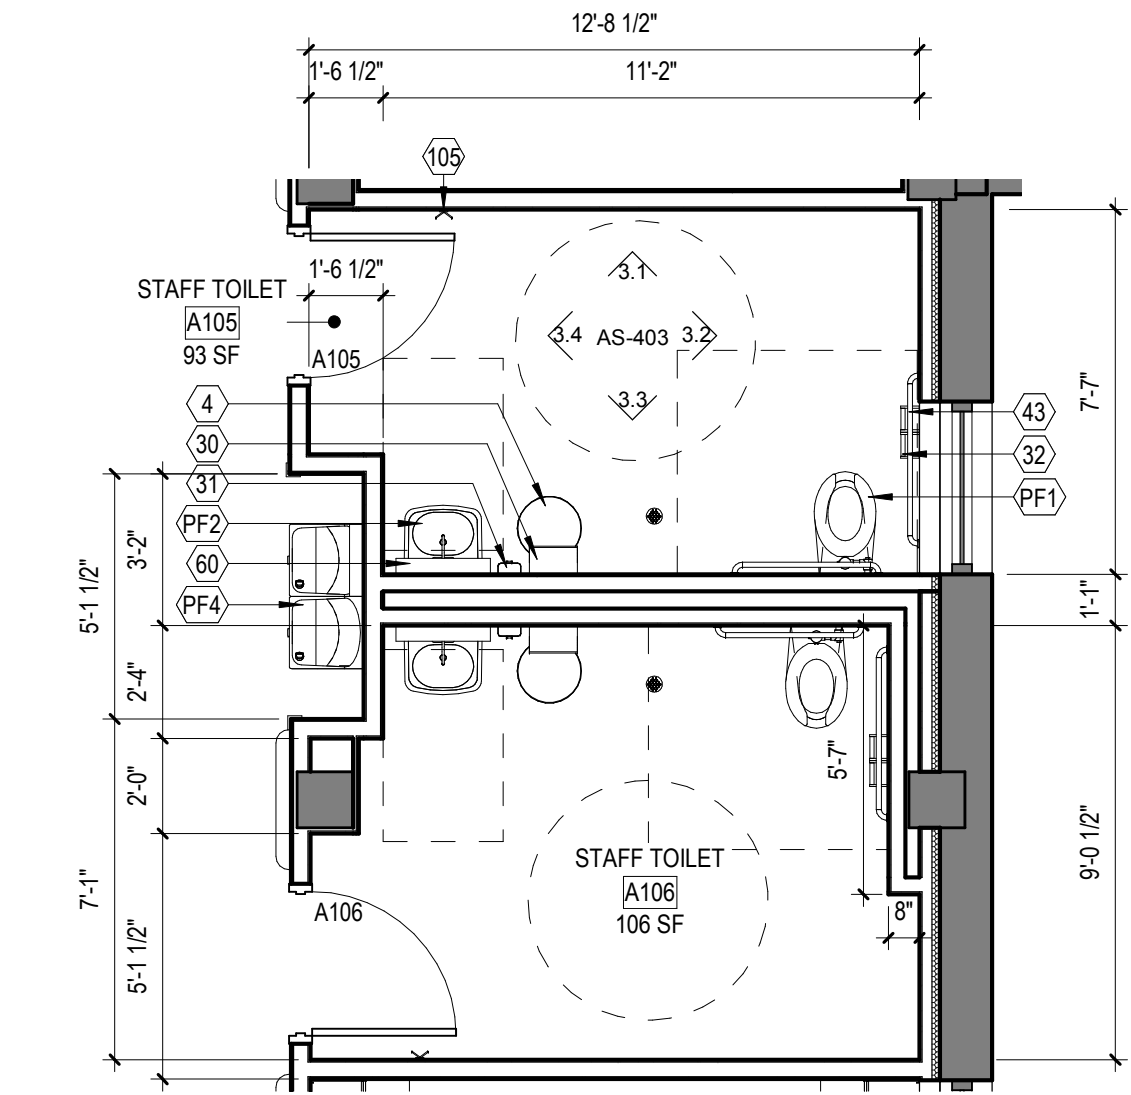





3 WING A - TOILETS, STAFF
1/4" = 1'-0"

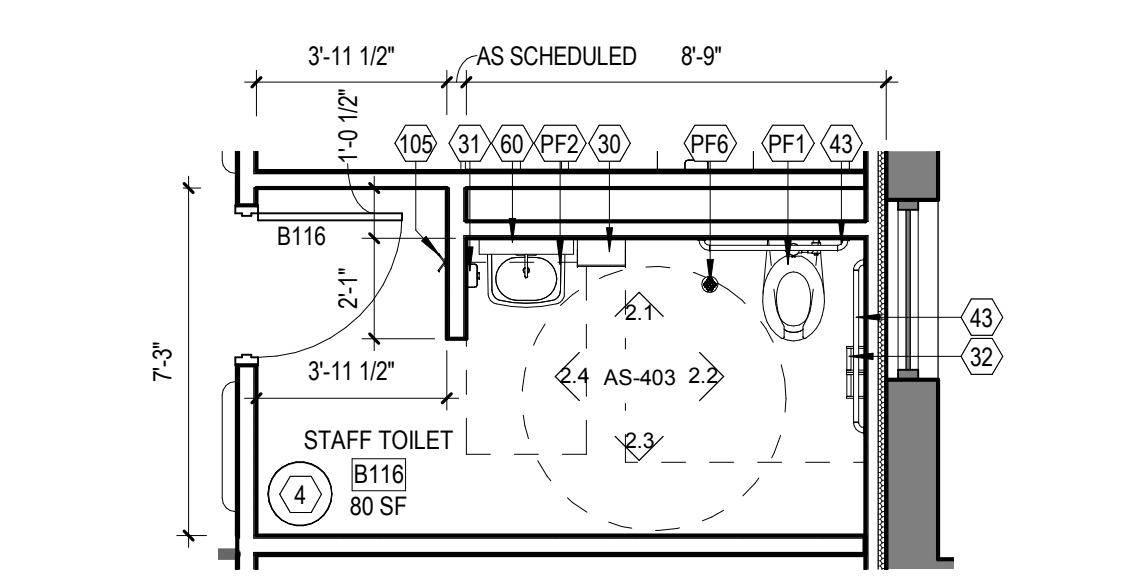

2 WING B - TOILET, STAFF
1/4" = 1'-0"

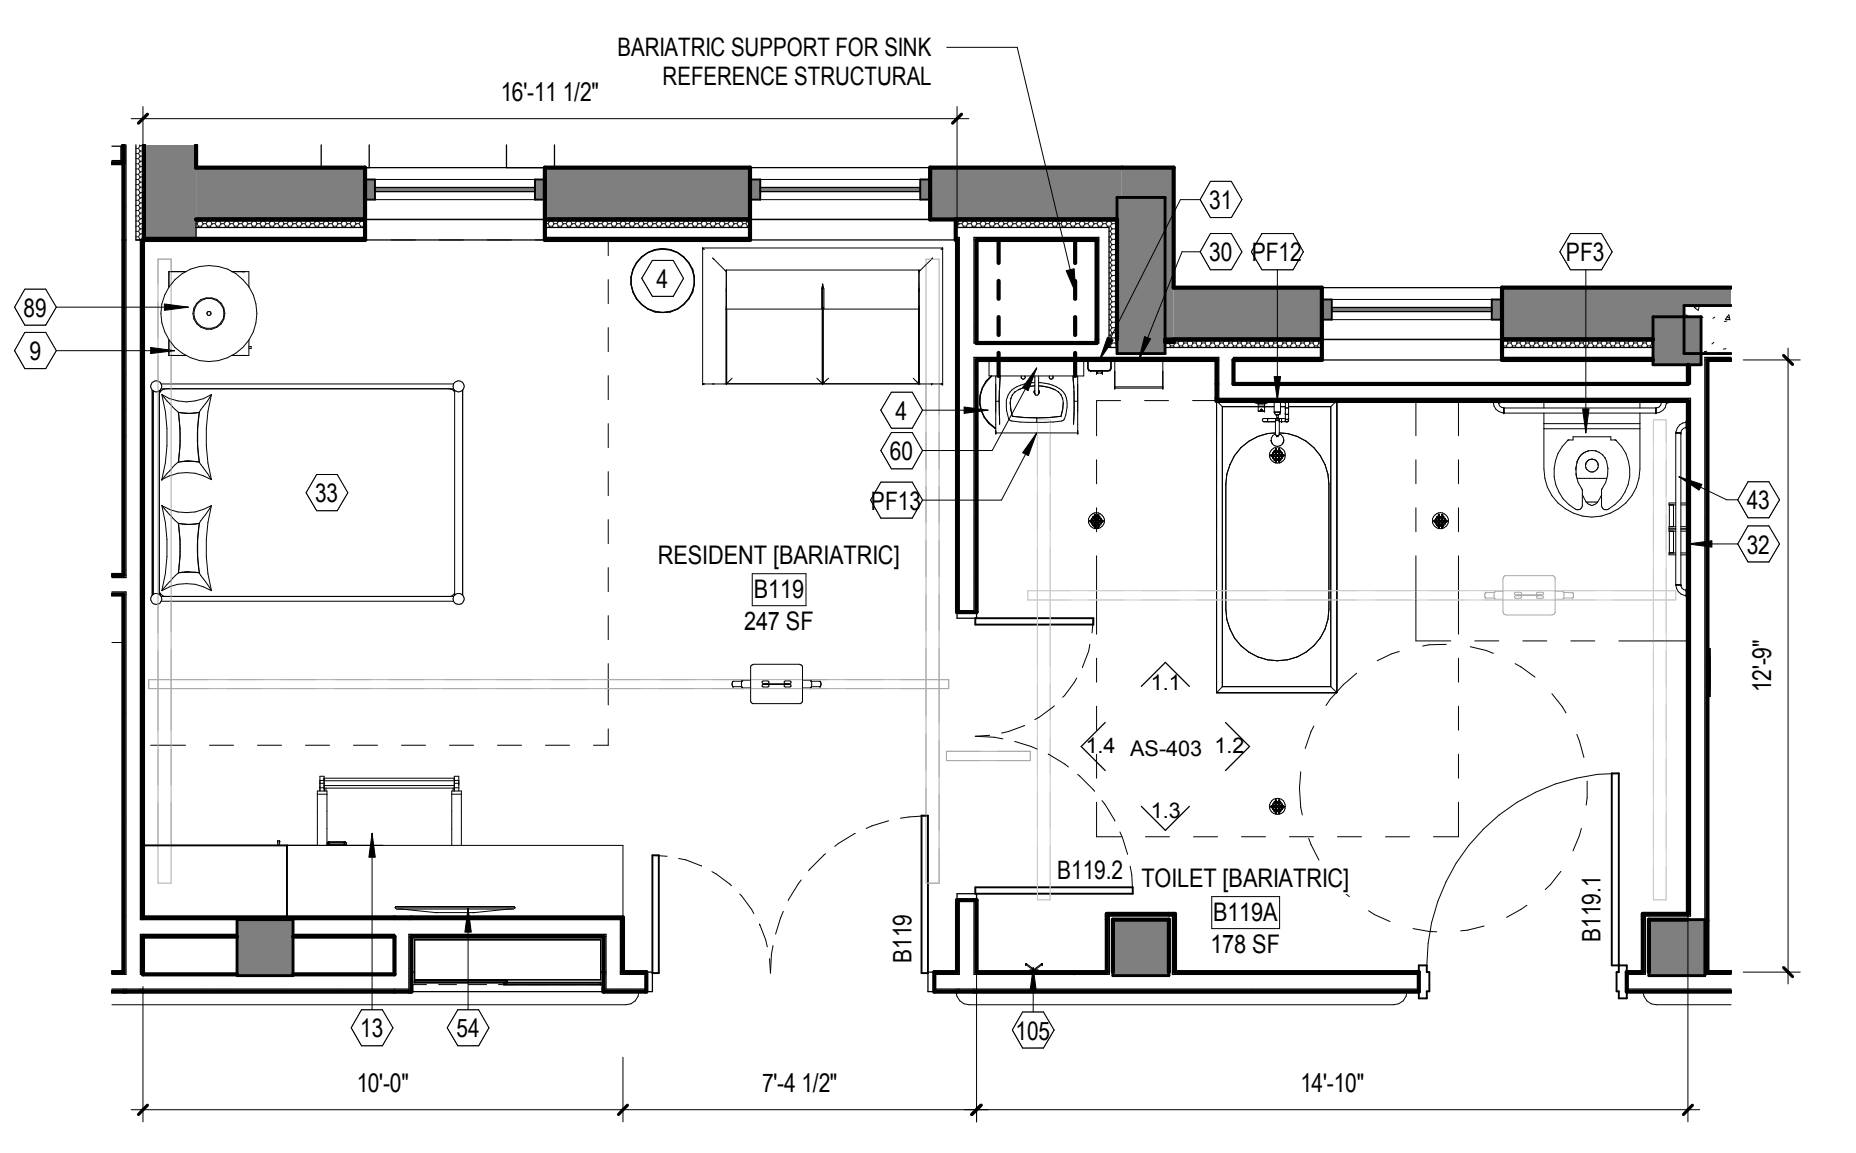

1 WING B - TOILET, BARIATRIC, RESIDENT, SHARED
1/4" = 1'-0"

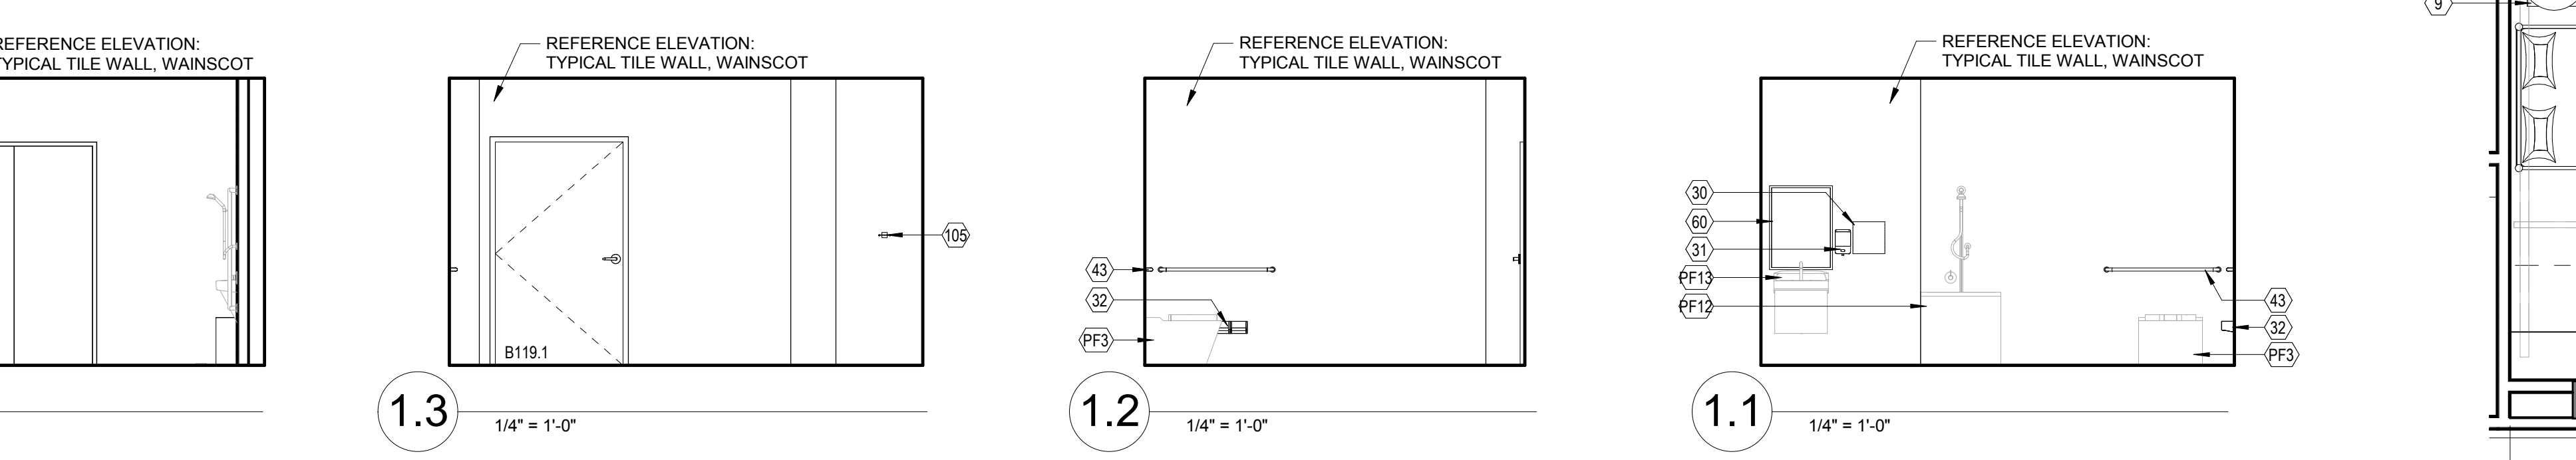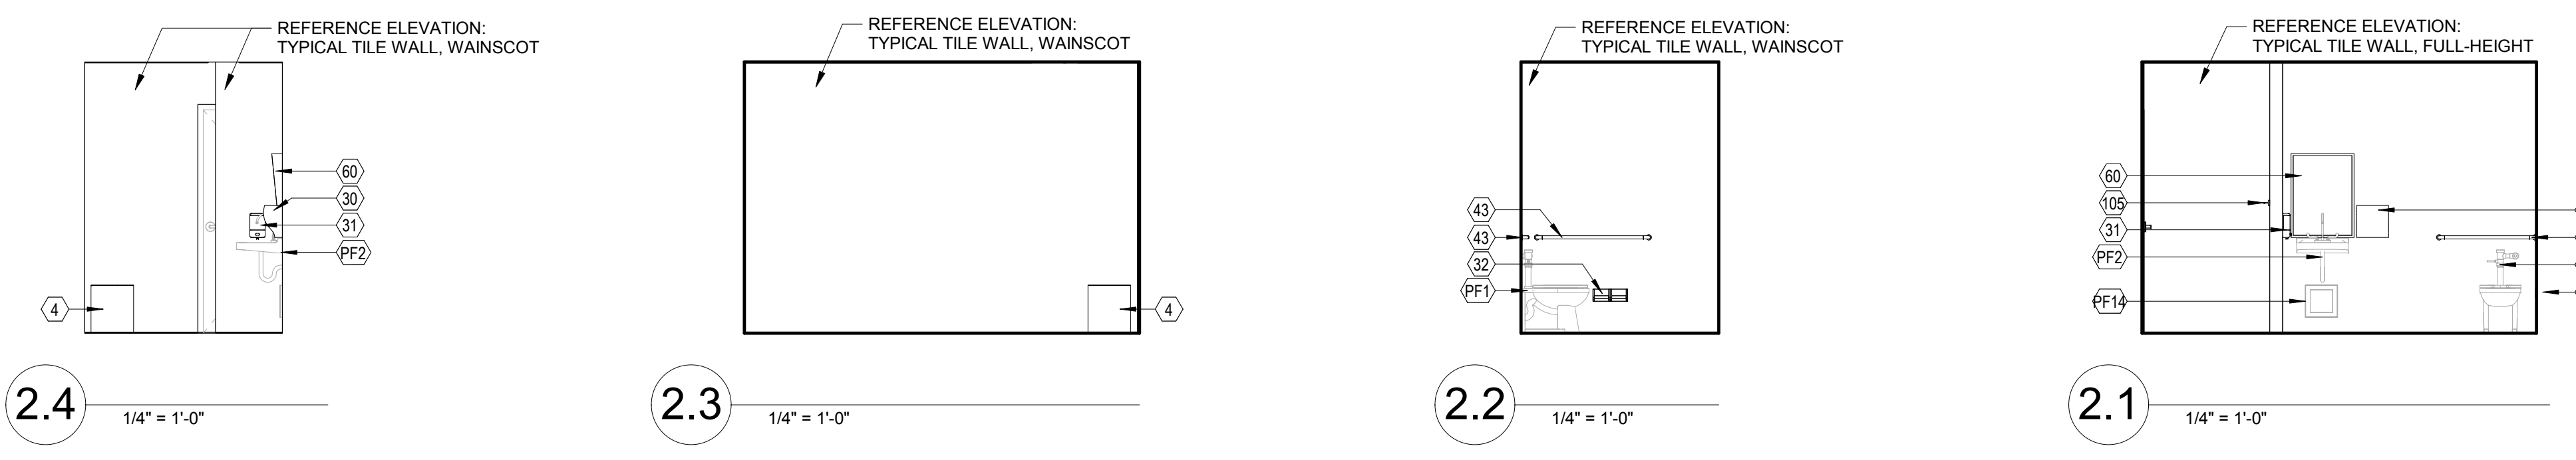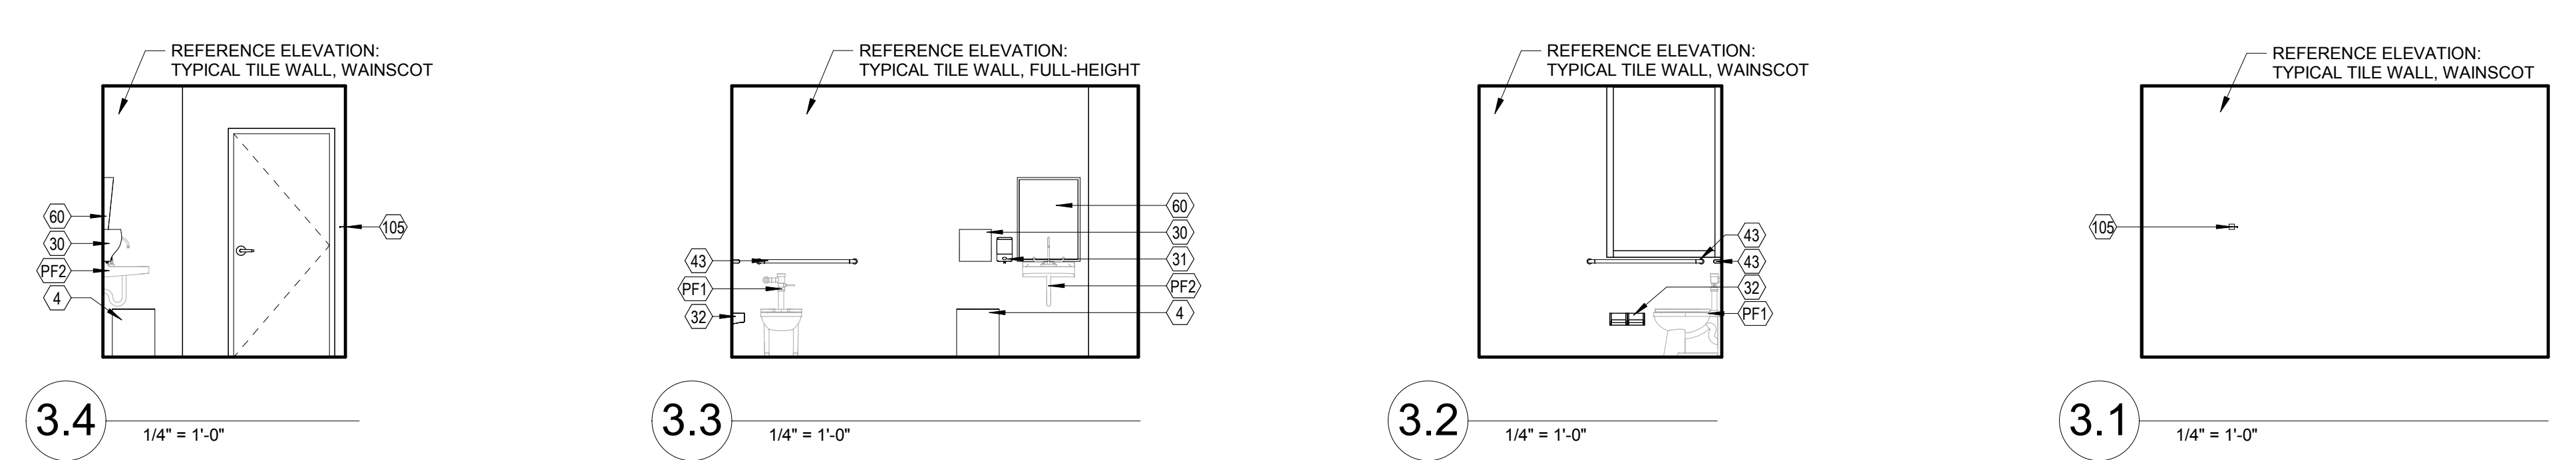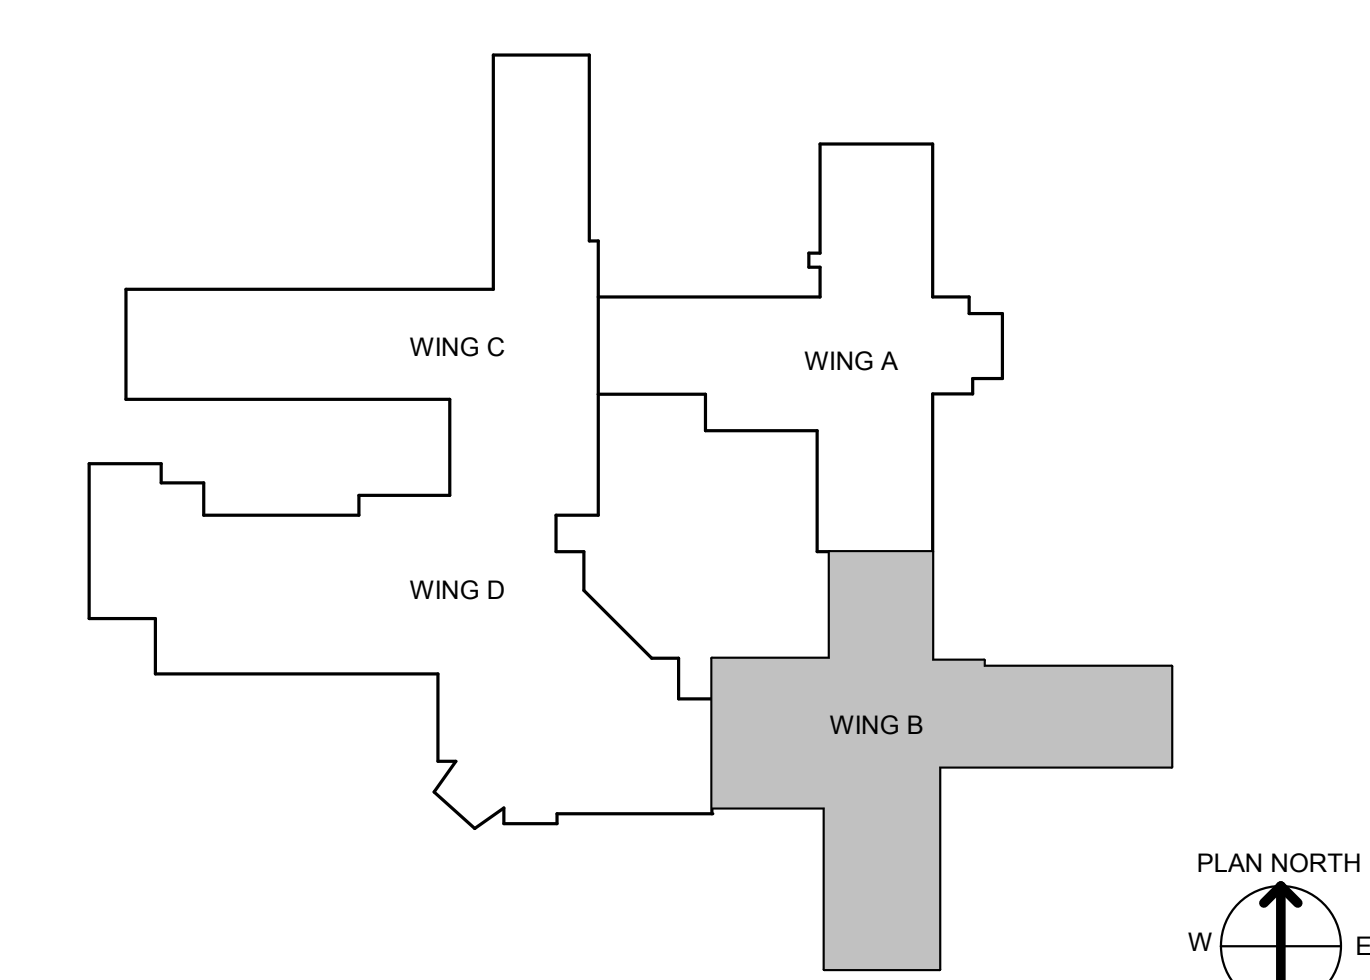

CONSULTANT INFORMATION STRUCTURAL / CIVIL ENGINEER: STAND STRUCTURAL ENGINEERING, 11927 W. 112TH STREET, SUITE 200, OVERLAND PARK, KS 66210 (913) 214-2169 MECHANICAL / ELECTRICAL / PLUMBING / TECHNICAL ENGINEER: SPUR DESIGN, 11020 KING STREET, SUITE 350, OVERLAND PARK, KS 66210 (405) 842-6100 FIRE PROTECTION ENGINEER: POOLE FIRE PROTECTION, INC., 19910 W. 161ST STREET, OLATH, KS 66062 (913) 829-8650		ARCHITECT Office of Construction and Facilities Management U.S. Department of Veteran Affairs VA ARCH REG. NO. A-1139, EXP. 12/31/2019 KS ENGR REG. NO. E-2586, EXP. 12/31/2019		SHEET TITLE: WING B - FF&E - ENLARGED PLANS & ELEVATIONS APPROVED: PROJECT DIRECTOR		PROJECT PHASE: BID DOCUMENTS FULLY SPRINKLERED		PROJECT TITLE: RENOVATE A & B WING BUILDING 6 PROJECT LOCATION: 2200 SW GAGE BLVD., TOPEKA, KS 66622 DATE: 07/10/2019 CHECKED BY: AWM DRAWN BY: JET		VA PROJECT NUMBER: 589A5-19-116 BUILDING NUMBER: 6 DRAWING NUMBER: 6-AS-403 Dwg. 24 OF 160	
--	--	--	--	--	--	---	--	---	--	---	--

FURNITURE, FIXTURE, & EQUIPMENT NOTES



1. ALL FURNITURE, FIXTURES, AND EQUIPMENT ARE SHOWN AS BASIS OF DESIGN.
2. GENERAL CONTRACTOR TO PROVIDE METAL SUPPORT BLOCKING AS REQUIRED.
3. REFERENCE AS-600 - INTERIOR FINISH SCHEDULES AND DETAILS FOR TYPICAL CORRIDOR AND TOILET ROOM WALL FINISH ELEVATIONS.
4. ALL PLUMBING FIXTURES ARE CONTRACTOR PROVIDED, CONTRACTOR INSTALLED.

FURNITURE, FIXTURE, & EQUIPMENT SCHEDULE


MARK	FURNITURE/FIXTURE/EQUIPMENT	ACC./INS.	MARK	FURNITURE/FIXTURE/EQUIPMENT	ACC./INS.
1	BARiatric SHOWER SEAT	C/C	66	PHYSIOMAX LIE BKKE SYSTEM	V/V
2	BARiatric HILO MAT	V/V	69	PREP TABLE	V/V
3	BASKET, WASTE/PAPER	V/V	70	PRINTER/COPIER/FAX COMBO	V/V
4	BOARD, BULLETIN	V/V	71	PULLEY SYSTEM	V/V
5	BRACKET, TELEVISION, WALL-MNTD, TILT ANGLE	V/V	72	RACK, MAGAZINE, WALL-MOUNTED	V/V
6	BREWER, COFFEE	V/V	73	RAIL, ACCESSORY	V/C
7	CABINET, BEDSIDE	V/V	74	REFRIGERATOR, 48"	C/C
8	CART, STORAGE	V/V	75	REFRIGERATOR, U-C OR F-S	C/C
9	CHAIR, DINING	V/V	76	REFRIGERATOR-FREEZER	C/C
10	CHAIR, RECLINER	V/V	77	RESIDENT BED	V/V
11	CHAIR, SIDE, BARiatric, WITH ARMS	V/V	78	SHELVING, STORAGE	V/V
12	CHAIR, SWIVEL, HIGH BACK	V/V	80	SIDE CHAIR, WITH ARMS	V/V
13	CHAIR, SWIVEL, LOW BACK	V/V	81	SOFA	V/V
14	CLIMBING BOARD AND BAR	V/V	82	SPHYGMOMANOMETER, ANEROID	V/V
15	CLOCK, BATTERY, 12"	V/V	83	STAIRS, EXISTING VA EQUIP	V/V
16	COLD PACK UNIT, EXISTING VA EQUIP	V/V	86	STOOL, SELF-ADJUSTING	V/V
17	COMPUTER	V/V	88	TABLE	V/V
18	COMPUTER WITH FLAT PANEL MONITOR	V/V	89	TABLE LAMP	V/V
19	CONFERENCE CHAIR	V/V	90	TABLE, COFFEE	V/V
20	CRENDENZA	V/V	91	TABLE, COFFEE, 24" x 48"	V/V
21	CUBICAL TRACK, W/ CURTAIN	C/C	92	TABLE, COMPUTER	V/V
22	DINING TABLE AND CHAIRS	V/V	93	TABLE, EXAM/TREATMENT	V/V
23	DISHWASHER	C/C	94	TABLE, SIDE	V/V
24	DISPENSER, GLOVE, SURGICAL-EXAMINATION	V/V	95	TELECOMMUNICATION OUTLET	C/C
25	DISPENSER, PAPER TOWEL, SENSOR, HANDS FREE	V/V	96	TELEPHONE, CONFERRING SYSTEM	V/V
26	DISPENSER, SOAP, DISPOSABLE	V/V	98	TELEPHONE, WALL-MOUNTED, 1 LINE	V/V
27	DISPENSER, TOILET ROLL	C/C	99	TELEVISION BACKING	C/C
28	DOUBLE BED, BARiatric	V/V	101	TELEVISION, HD/TV, 60"	V/V
29	DVD PLAYER	V/V	102	TRACK, CURTAIN, WITH CURTAIN	C/C
30	FIRE EXTINGUISHER CABINET, RECESSED	C/C	103	URINAL SCREEN	C/C
31	FIRE EXTINGUISHER CABINET, SURFACE MOUNT	C/C	104	VIDEO TELECONFERRING SYSTEM	V/V
32	FOLD-DOWN GRAB BAR	C/C	105	WALL HOOK	C/C
33	FOLD-DOWN SHOWER SEAT	C/C	106	WASHER / DRYER	V/V
34	GRAB BAR	C/C	107	WASTE DISPOSAL UNIT, SHARPS	V/V
35	HANDRAIL	V/V	108	WHITE BOARD, BULLETIN BOARD COMBINATION	V/V
36	HOLD TREATMENT TABLE, EXISTING VA EQUIP	V/V	109	WINDOW SHADE ROLLER	C/C
37	HYDROCLUTATOR UNIT, EXISTING VA EQUIP	V/V	110	WORKSTATION	V/V
38	ICE MAKER	C/C	111	WORKSTATION, COMPUTER, WALL MOUNTED	V/V
39	LIGHT, EXAM, MOBILE	V/V	115	HOOD, EXHAUST, NON-COMMERCIAL	C/C
40	LIGHT, WALL-MOUNTED TELEVISION, 32"	V/C	116	POPCORN MACHINE	V/V
41	LOUNGE CHAIR	V/V	117	ACCORDION WALL	C/C
42	MEDICAL DISTRIBUTION SYSTEM	V/V	119	METAL LOCKERS	C/C
43	MEDICINE BALL RACK	V/V	120	RANGING	C/C
44	MEETING TABLE	V/V	121	SUPPORT BRACKET	C/C
45	MIRROR, FLAT GLASS, ADA	C/C	122	WINGBACK CHAIR	V/V
46	MOBILE WEIGHT RACK STORAGE	V/V	123	RECESSED CURTAIN TRACK	C/C
47	MUSTEP, EXISTING VA EQUIP	V/V	124	LOVESEAT	V/V
48	OTOSCOPE OPHTHALMOSCOPE	V/V	125	ELECTRIC FIREPLACE	C/C
49	OVEN, MICROWAVE	V/V	126	SOFA TABLE	V/V
50	PARALLEL BARS, EXISTING VA EQUIP	V/V	127	PYXIS AUXILIARY CABINET	V/V
			128	PYXIS CONTROL CABINET	V/V
			129	MED. REFRIGERATOR	V/V
			130	VIRTUAL AQUARIUM DISPLAY SYSTEM	C/C

PLUMBING FIXTURE


MARK	PLUMBING FIXTURE	COMMENTS
PF1	SHOW DRAIN, 3" DIAMETER	
PF2	TOILET, FLOOR-MOUNTED	
PF3	TOILET, FLOOR-MOUNTED, BARiatric	REFERENCE AS-700 FOR BARiatric FIXTURE SUPPORTS
PF4	DRINKING FOUNTAIN, WITH BOTTLE FILLER	
PF5	SHOWER TRIM	
PF6	OVERFLOW DRAIN, 3" DIAMETER	
PF8	SINK, DROP-IN, 20" x 18"	
PF9	SHOW DRAIN, 3" DIAMETER	
PF10	SINK, DROP-IN, DOUBLE	
PF11	SINK, MOP	
PF12	BATHUB, WALK-IN	
PF13	LAVATORY, BARiatric	REFERENCE AS-700 FOR BARiatric FIXTURE SUPPORTS
PF14	TRAP PRIMER	

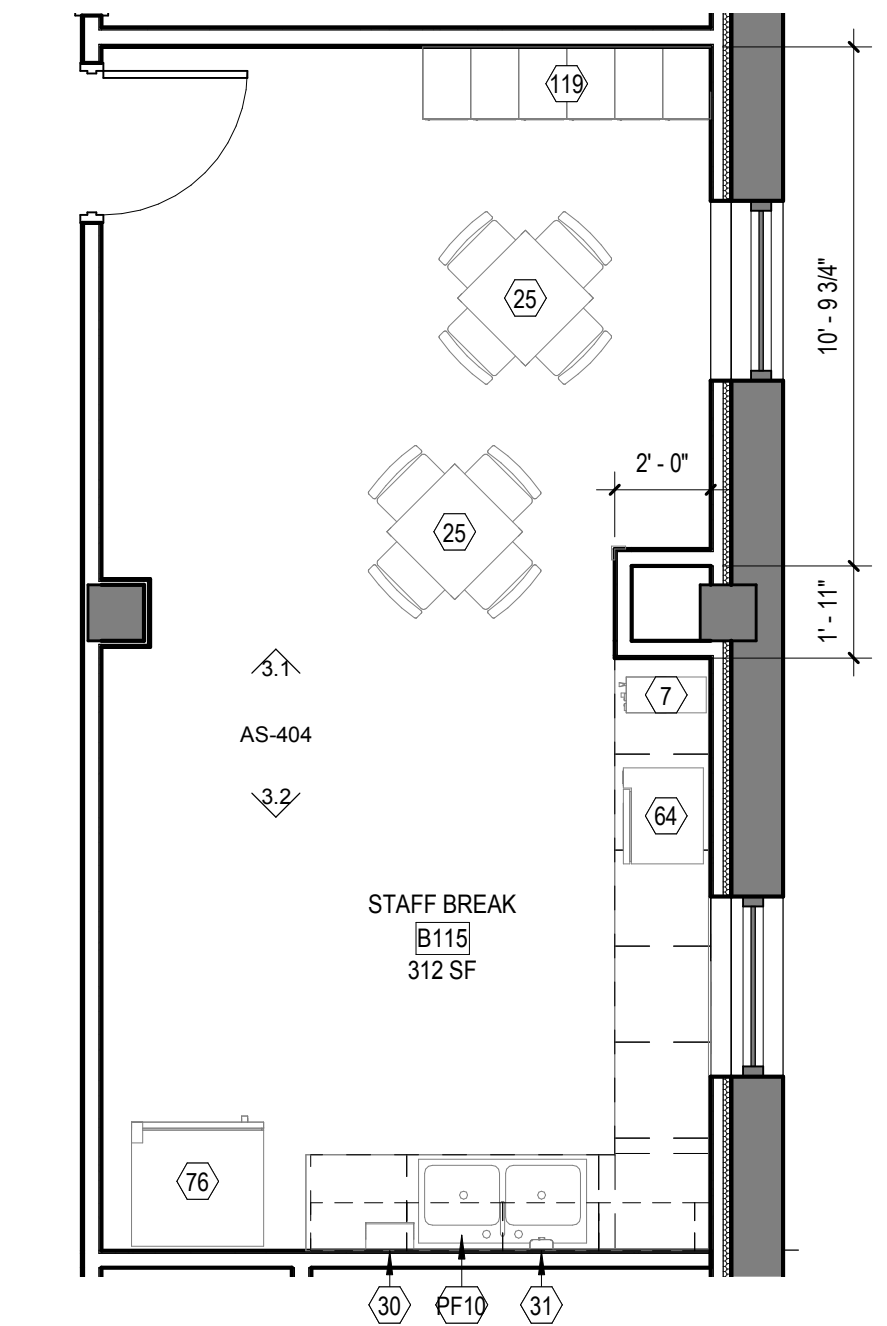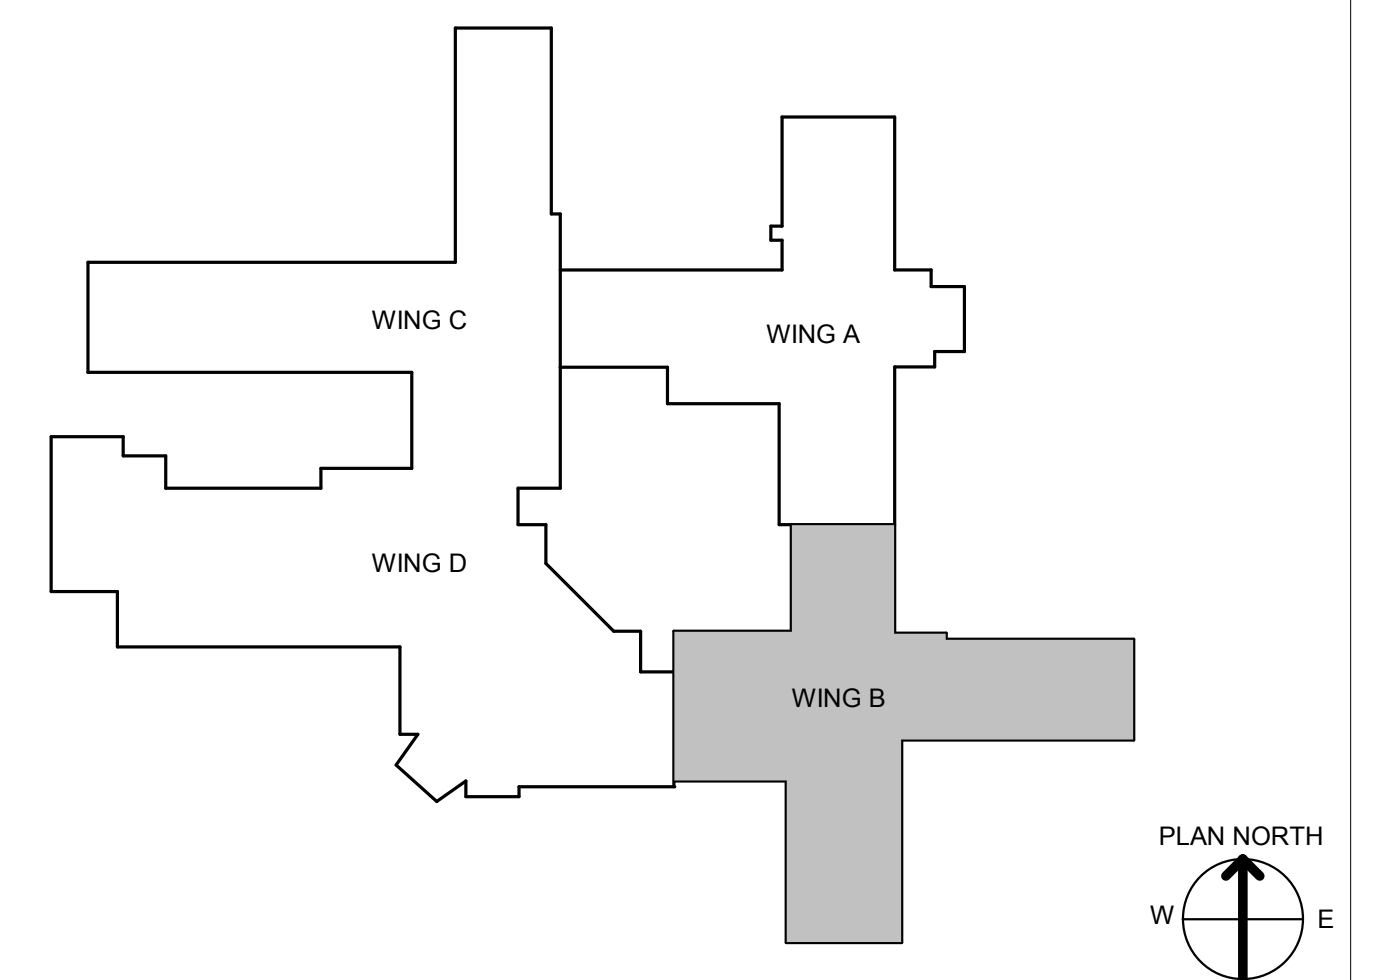


3 WING B - STAFF BREAK
1/4" = 1'-0"

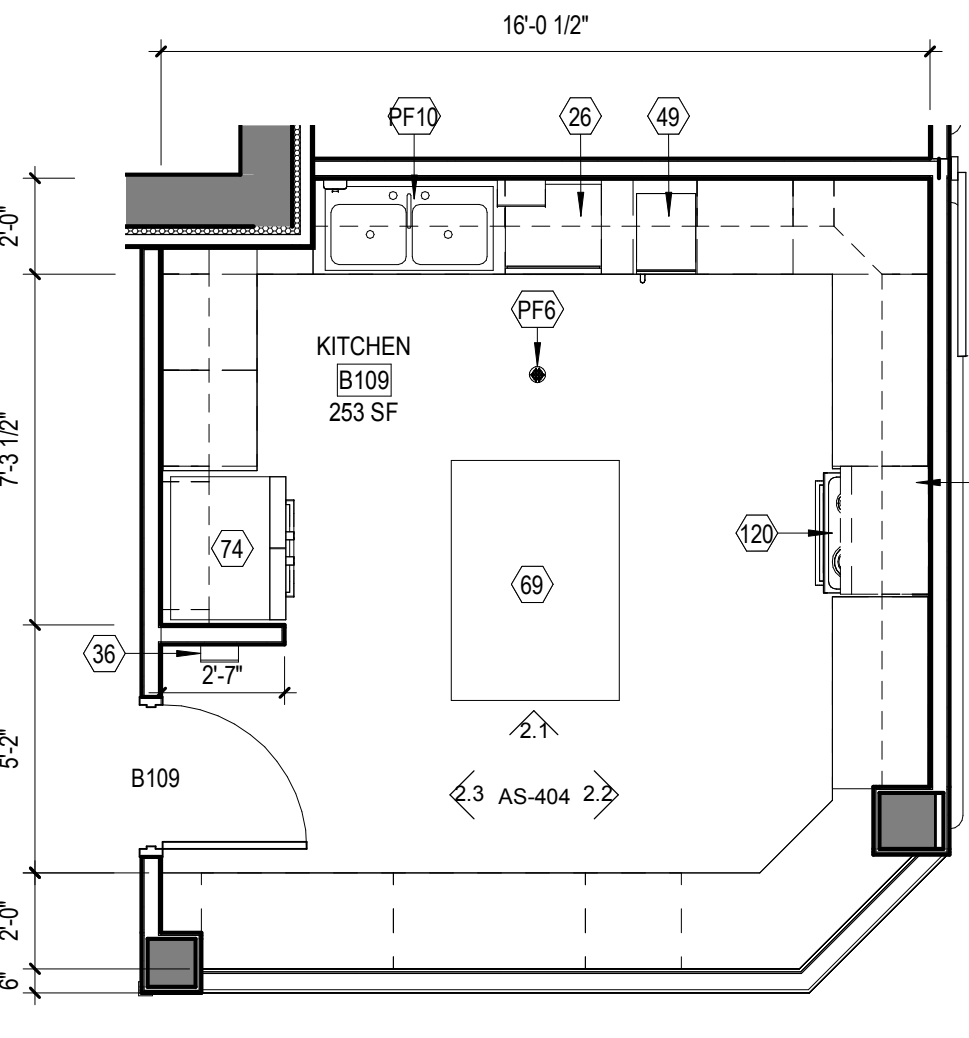


2 WING B - KITCHEN & PANTRY
1/4" = 1'-0"

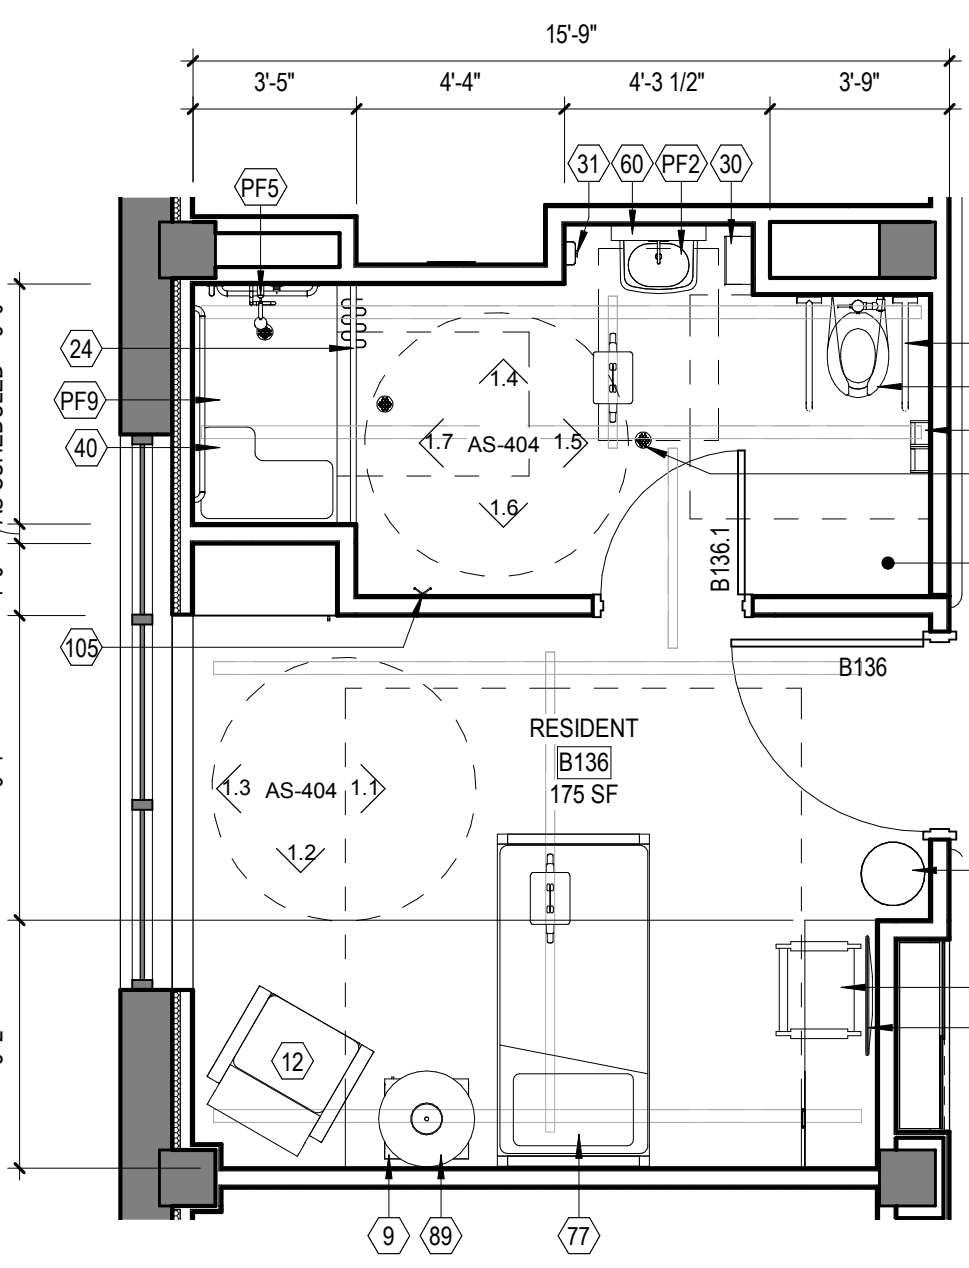


1 WING B - TYPICAL - RESIDENT ROOM
1/4" = 1'-0"

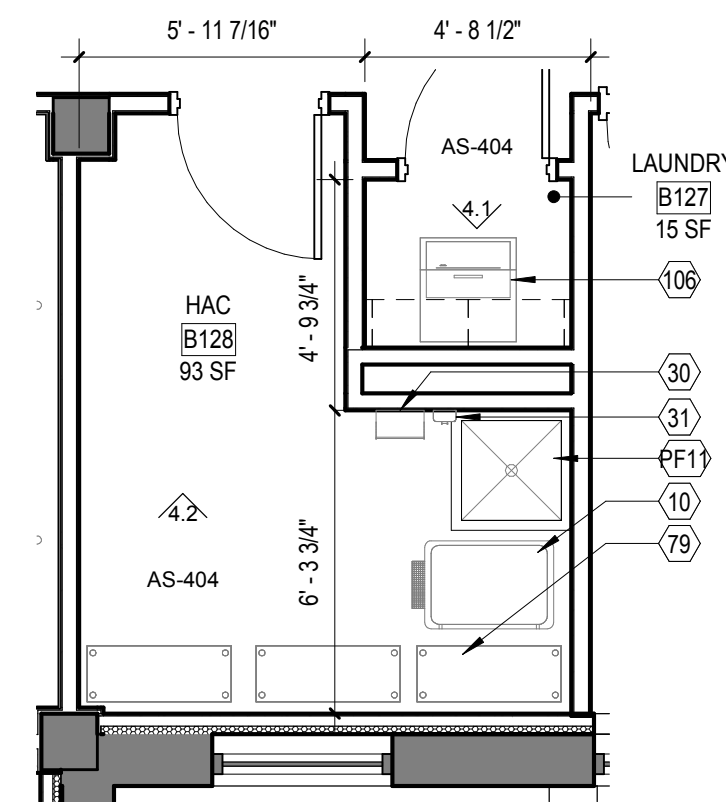


4 WING B - HAC
1/4" = 1'-0"

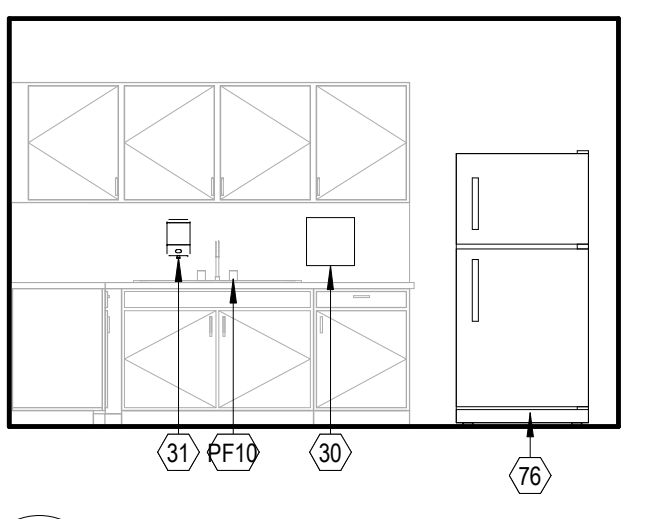


3.2 1/4" = 1'-0"

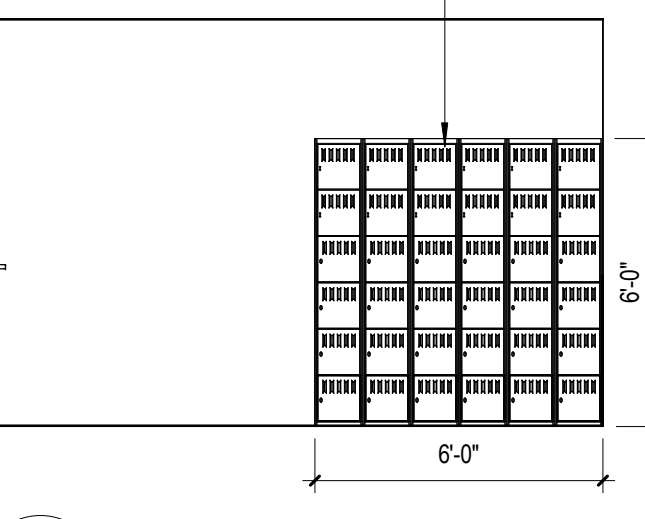


3.1 1/4" = 1'-0"

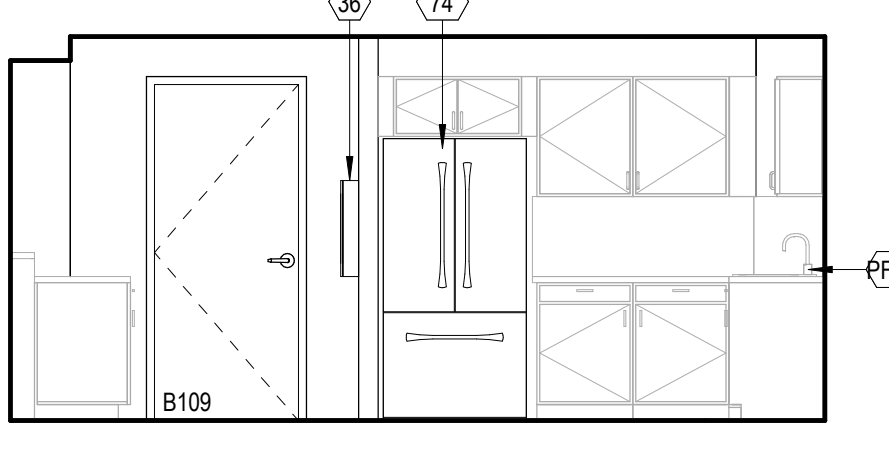


2.3 1/4" = 1'-0"

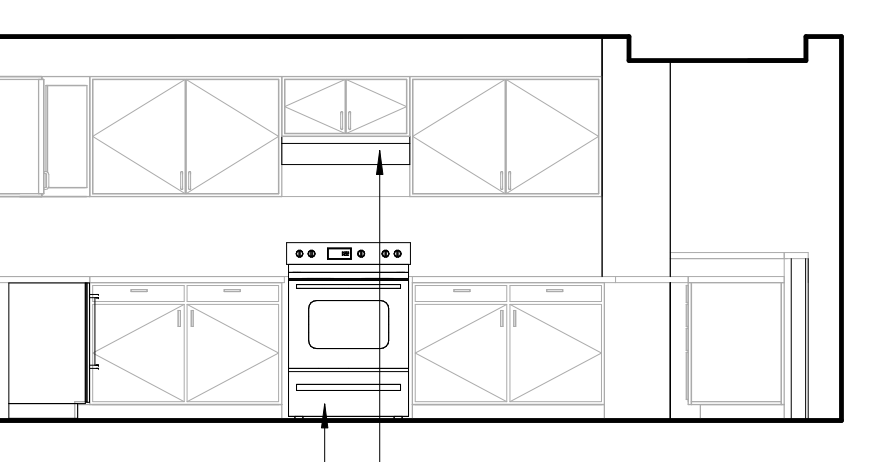


2.2 1/4" = 1'-0"

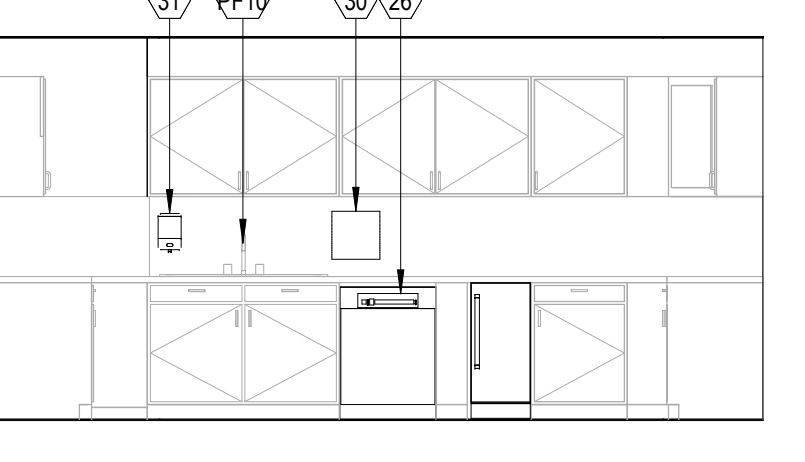


2.1 1/4" = 1'-0"

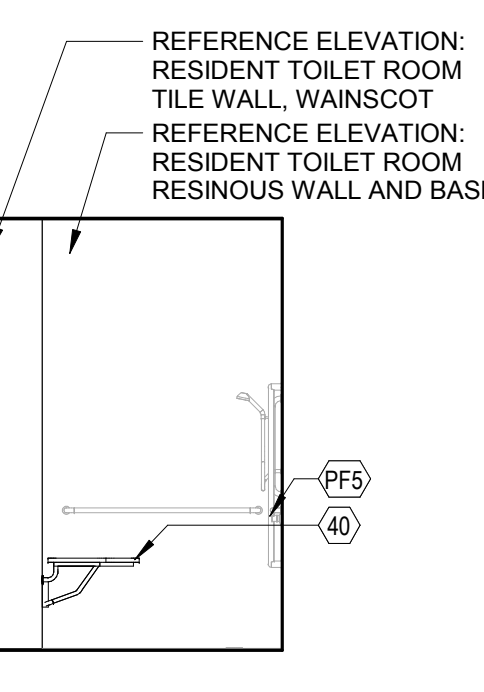


1.7 1/4" = 1'-0"

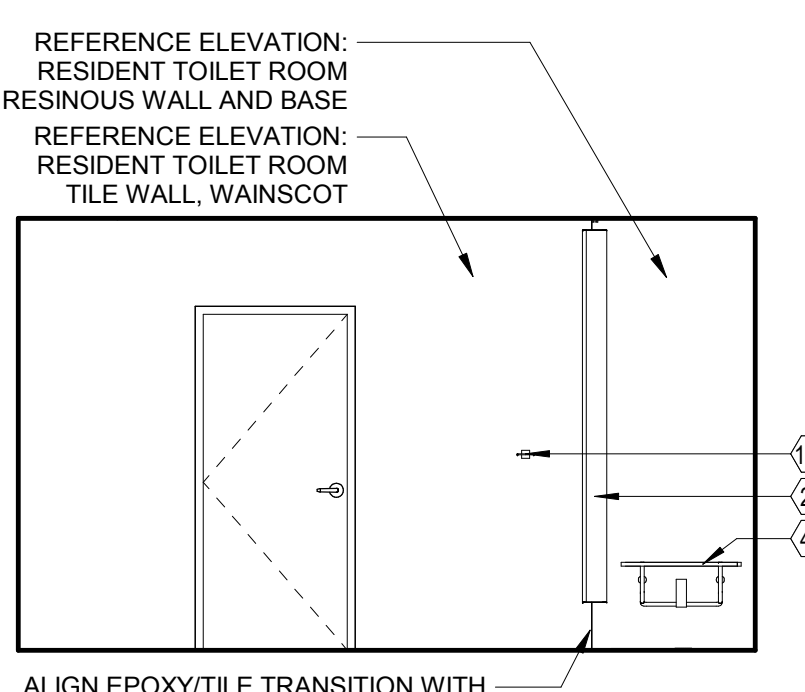


1.6 1/4" = 1'-0"

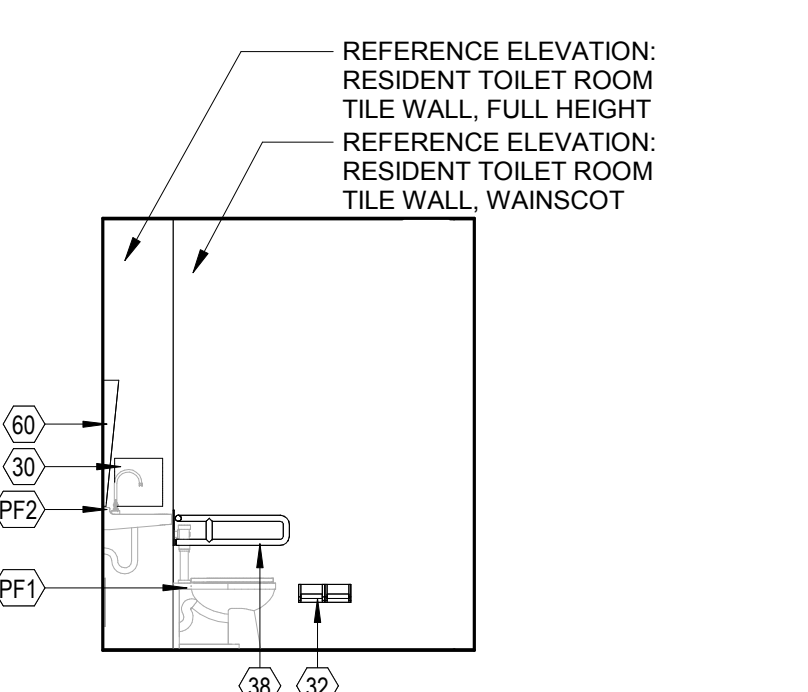


1.5 1/4" = 1'-0"

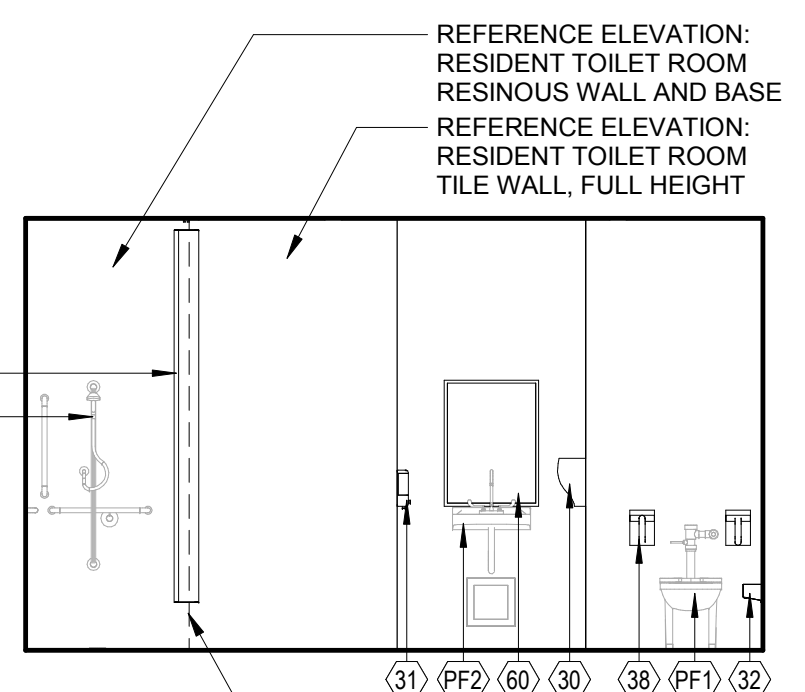


1.4 1/4" = 1'-0"

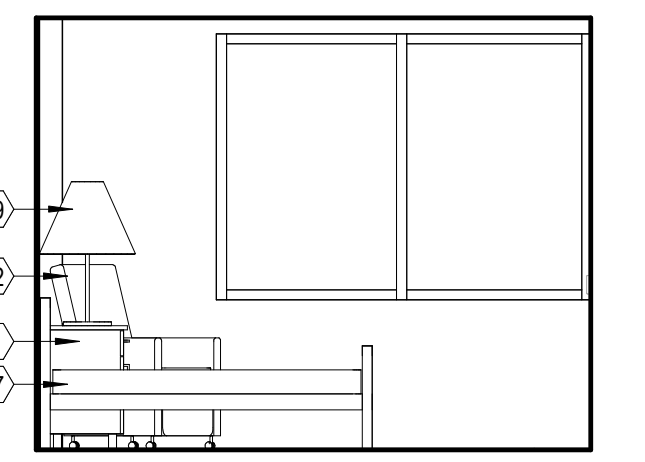

1.3 1/4" = 1'-0"

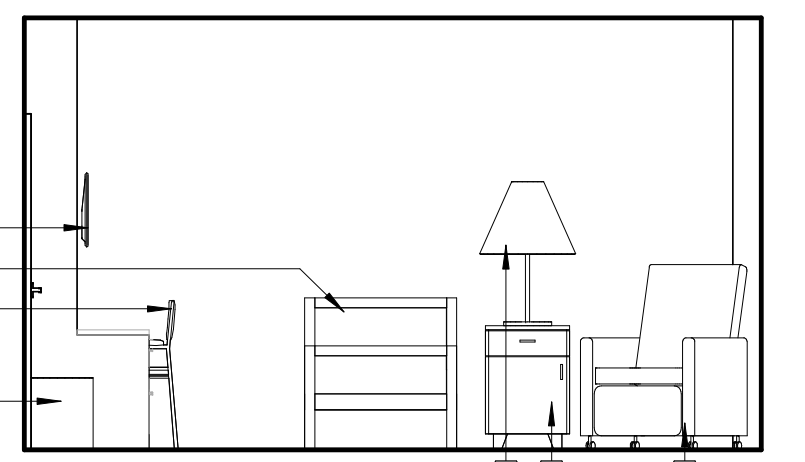

1.2 1/4" = 1'-0"

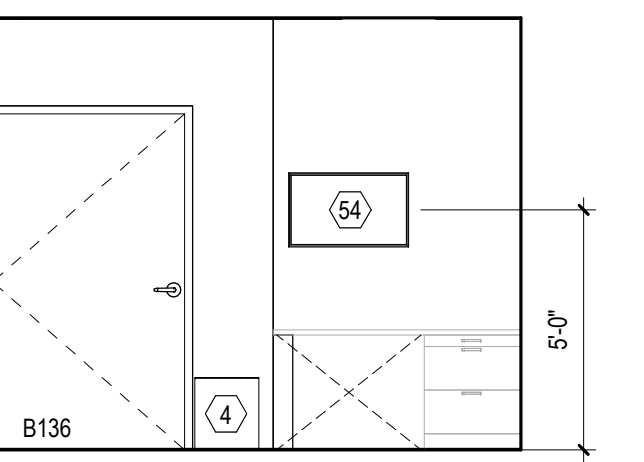

1.1 1/4" = 1'-0"

CONSULTANT INFORMATION

STRUCTURAL / CIVIL ENGINEER STAND STRUCTURAL ENGINEERING 11227 W. 112TH STREET, SUITE 200 OVERLAND PARK, KS 66210 (913) 214-2169	MECHANICAL / ELECTRICAL / PLUMBING / TECHNICAL ENGINEER SPUR DESIGN 11020 KING STREET, SUITE 350 OVERLAND PARK, KS 66210 (405) 842-6100	FIRE PROTECTION ENGINEER POOLE FIRE PROTECTION, INC. 19910 W. 161ST STREET OLATH, KS 66062 (913) 829-8650
--	---	---

ARCHITECT

Office of Construction and Facilities Management

VA U.S. Department of Veteran Affairs

SPUR DESIGN

313 5th Street
Overland Park, KS 66204
www.spur-design.com

11020 King Street, Suite 350
Overland Park, KS 66210
www.spur-design.com

6728
JULY 10, 2017
KANSAS ARCHITECT

KS ARCH REG. NO. A-1139, EXP. 12/31/2019
KS ENGR REG. NO. E-2586, EXP. 12/31/2019

SHEET TITLE
WING B - FF&E - ENLARGED PLANS & ELEVATIONS

PROJECT PHASE
BID DOCUMENTS

FULLY SPRINKLERED

APPROVED: PROJECT DIRECTOR

PROJECT TITLE
RENOVATE A & B WING BUILDING 6

PROJECT LOCATION
2200 SW GAGE BLVD.
TOPEKA, KS 66622

DATE
07/10/2019

CHECKED BY
AWM

DRAWN BY
JET

VA PROJECT NUMBER
589A5-19-116

BUILDING NUMBER
6

DRAWING NUMBER
6-AS-404


Dwg. 25 OF 160

- FURNITURE, FIXTURE, & EQUIPMENT NOTES**
1. ALL FURNITURE, FIXTURES, AND EQUIPMENT ARE SHOWN AS BASIS OF DESIGN.
 2. GENERAL CONTRACTOR TO PROVIDE METAL SUPPORT BLOCKING AS REQUIRED.
 3. REFERENCE AS-600 - INTERIOR FINISH SCHEDULES AND DETAILS FOR TYPICAL CORRIDOR AND TOILET ROOM WALL FINISH ELEVATIONS.
 4. ALL PLUMBING FIXTURES ARE CONTRACTOR PROVIDED, CONTRACTOR INSTALLED.


FURNITURE, FIXTURE, & EQUIPMENT SCHEDULE

MARK	FURNITURE/FIXTURE/EQUIPMENT	ACQ/INS	MARK	FURNITURE/FIXTURE/EQUIPMENT	ACQ/INS
1	1 BABY CHANGING STATION	C/C	66	PHYSIOMAX UE BIKE SYSTEM	V/V
2	BARATRIC SHOWER SEAT	C/C	69	PREP TABLE	V/V
3	BARATRIC HILO MAT	V/V	70	PRINTER/COPIER/FAX COMBO	V/V
4	BASKET, WASTEPAPER	V/V	71	PALLEY SYSTEM	V/V
5	BOARD, BULLETIN	V/V	72	RACK, MAGAZINE, WALL-MOUNTED	V/V
6	BRACKET, TELEVISION, WALL-MNTD, TILT ANGLE	V/V	73	RAIL, ACCESSORY	V/C
7	BREWER, COFFEE	V/V	74	REFRIGERATOR, 48"	C/C
9	CABINET, BEDSIDE	V/V	75	REFRIGERATOR, U/C OR F/S	C/C
10	CART, STORAGE	V/V	76	REFRIGERATOR-FREEZER	C/C
11	CHAIR, DINING	V/V	77	RESIDENT BED	V/V
11	COFFEE TABLE, 52" x 52"	V/V	79	SHELVING, STORAGE	V/V
12	CHAIR, RECLINER	V/V	80	SIDE CHAIR, WITH ARMS	V/V
13	CHAIR, SIDE, BARATRIC, WITH ARMS	V/V	81	SOFA	V/V
14	CHAIR, SWIVEL, HIGH BACK	V/V	82	SPHYGMOMANOMETER, ANEROID	V/V
15	CHAIR, SWIVEL, LOW BACK	V/V	83	STAIRS, EXISTING VA EQUIP	V/V
16	CLIMBING BOARD AND BAR	V/V	86	STOOL, SELF-ADJUSTING	V/V
17	CLOCK, BATTERY, 12"	V/V	88	TABLE	V/V
18	COLD PACK UNIT, EXISTING VA EQUIP	V/V	89	TABLE, LAMP	V/V
19	COMPUTER	V/V	90	TABLE, COFFEE	V/V
20	COMPUTER WITH FLAT PANEL MONITOR	V/V	91	TABLE, COFFEE, 24" x 48"	V/V
21	CONFERENCE CHAIR	V/V	92	TABLE, COMPUTER	V/V
22	CREDENZIA	V/V	93	TABLE, EXAM/TREATMENT	V/V
24	CLERICAL TRACK, W/ CURTAIN	C/C	94	TABLE, SIDE	V/V
25	DINING TABLE AND CHAIRS	V/V	95	TELECOMMUNICATION OUTLET	C/C
26	DISHWASHER	C/C	96	TELEPHONE, CONFERENCE SYSTEM	V/V
27	DISPENSER, GLOVE, SURGICAL-EXAMINATION	V/V	98	TELEPHONE, WALL-MOUNTED, 1 LINE	V/V
29	DISPENSER, PAPER CUP, SS	V/V	99	TELEVISION BACKING	C/C
30	DISPENSER, PAPER TOWEL, SENSOR, HANDS FREE	C/C	101	TELEVISION, HD TV, 60"	V/V
31	DISPENSER, SOAP, DISPOSABLE	V/V	102	TRACK, CUBICLE, WITH CURTAIN	C/C
32	DISPENSER, TOILET ROLL	C/C	103	URINAL SCREEN	C/C
33	DOUBLE BED, BARATRIC	V/V	104	VIDEO TELECONFERENCE SYSTEM	V/V
34	DVD PLAYER	V/V	105	WALL HOOK	C/C
35	FIRE EXTINGUISHER CABINET, RECESSED	C/C	106	WASHER, DRYER	V/V
36	FIRE EXTINGUISHER CABINET, SURFACE MOUNT	C/C	107	WASTE DISPOSAL UNIT, SHARPS	V/V
38	FOLD-DOWN GRAB BAR	C/C	108	WHITE BOARD, BULLETIN BOARD COMBINATION	V/V
40	FOLD-DOWN SHOWER SEAT	C/C	109	WINDOW SHADE ROLLER	C/C
43	GRAB BAR	C/C	110	WORKSTATION	V/V
45	HANDRAIL	V/C	111	WORKSTATION, COMPUTER, WALL MOUNTED	V/V
47	HILO TREATMENT TABLE, EXISTING VA EQUIP	V/V	115	HOOD, EXHAUST, NON-COMMERCIAL	C/C
48	HYDROCOLLATOR UNIT, EXISTING VA EQUIP	V/V	116	POPCORN MACHINE	V/V
49	ICE MAKER	C/C	117	ACCORDION WALL	C/C
53	LIGHT, EXAM, MOBILE	V/V	118	METAL LOCKERS	C/C
54	WALL MOUNTED TELEVISION, 32"	V/C	120	RANGE	C/C
56	LOUNGE CHAIR	V/V	121	SUPPORT BRACKET	C/C
57	MEDICAL DISTRIBUTION SYSTEM	V/V	122	WINGBACK CHAIR	V/V
58	MEDICINE BALL RACK	V/V	123	RECESSED CURTAIN TRACK	C/C
59	MEETING TABLE	V/V	124	LOVESEAT	V/V
60	MIRROR, FLOAT GLASS, ADA	C/C	125	ELECTRIC FIREPLACE	C/C
61	MOBILE WEIGHT RACK STORAGE	V/V	126	SOFA TABLE	V/V
62	MUSTEP, EXISTING VA EQUIP	V/V	127	PYXIS AUXILIARY CABINET	V/V
63	OTOSCOPE OPHTHALMOSCOPE	V/V	128	PYXIS CONTROL CABINET	V/V
64	OVEN, MICROWAVE	V/V	129	MED. REFRIGERATOR	V/V
65	PARALLEL BARS, EXISTING VA EQUIP	V/V	130	VIRTUAL AQUARIUM DISPLAY SYSTEM	C/C


MARK	PLUMBING FIXTURE	COMMENTS
PF1	SHOWER DRAIN, 3" DIAMETER	
PF1	TOILET, FLOOR-MOUNTED	
PF2	LAVATORY, WALL-MOUNTED	
PF3	TOILET, FLOOR-MOUNTED, BARATRIC	REFERENCE AS-700 FOR BARATRIC FIXTURE SUPPORTS
PF4	DRINKING FOUNTAIN, WITH BOTTLE FILLER	
PF5	SHOWER TRIM	
PF6	OVERFLOW DRAIN, 3" DIAMETER	
PF8	SINK, DROP-IN, 20" x 18"	
PF9	SHOWER DRAIN, 3" DIAMETER	
PF10	SINK, DROP-IN, DOUBLE	
PF11	SINK, W/DP	
PF12	BATH TUB, WALK-IN	
PF13	LAVATORY, BARATRIC	REFERENCE AS-700 FOR BARATRIC FIXTURE SUPPORTS
PF14	TRAP PRIMER	

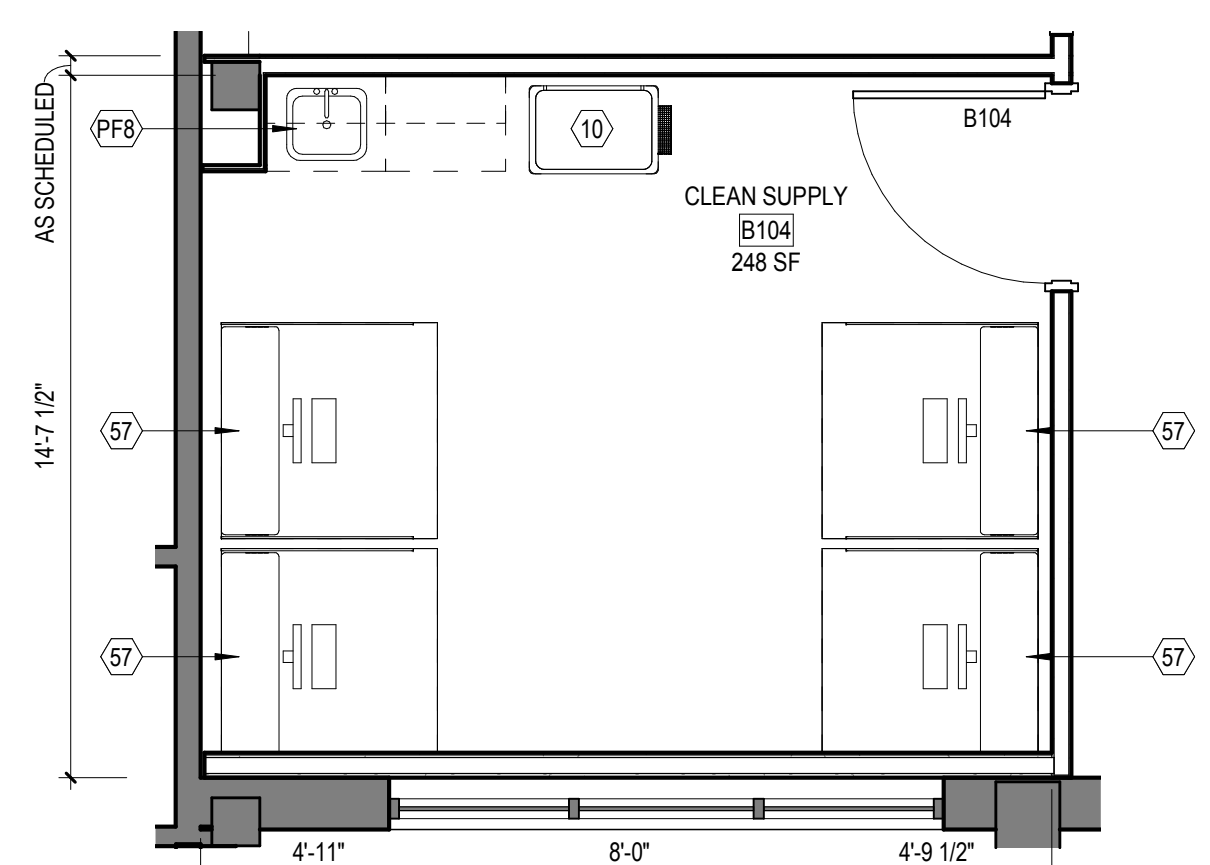



3 WING B - CLEAN SUPPLY
1/4" = 1'-0"

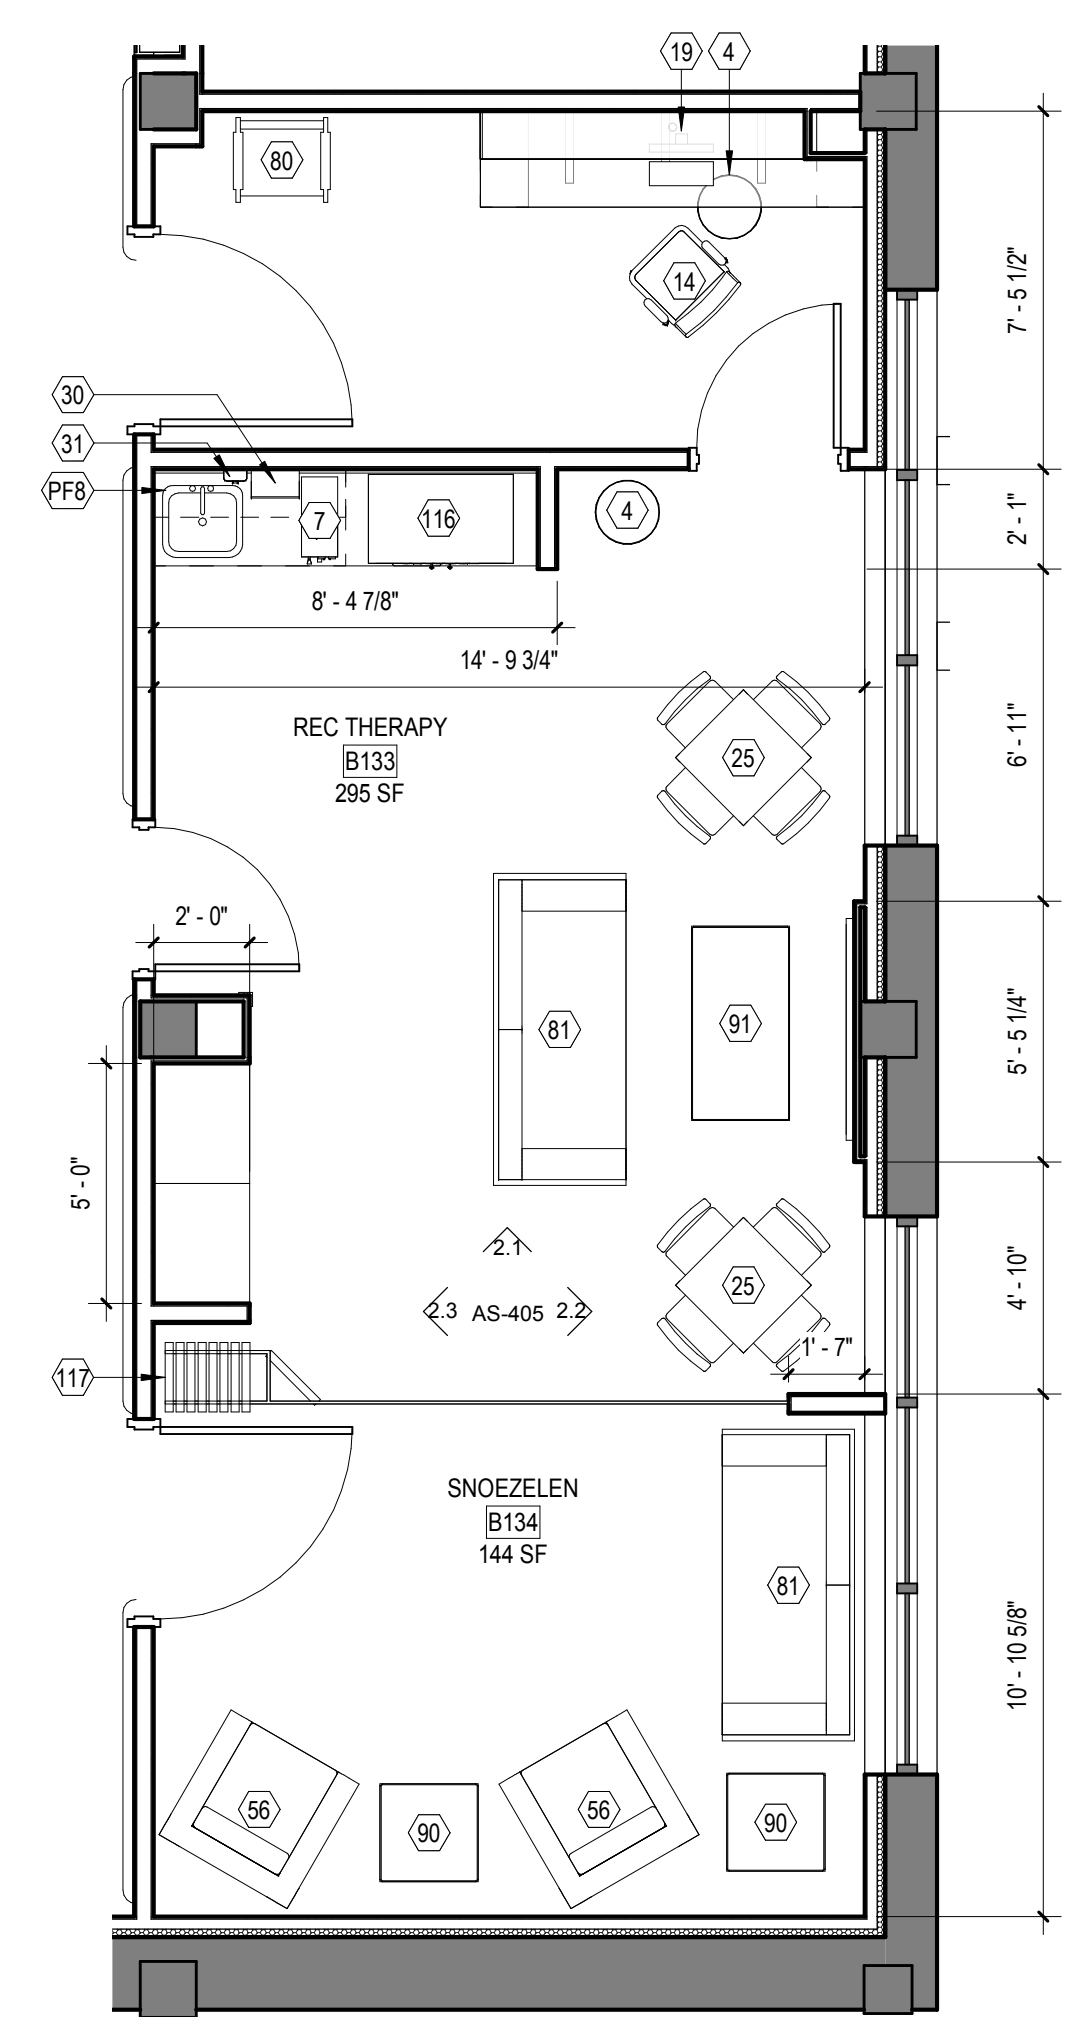


2 WING B - REC THERAPY
1/4" = 1'-0"

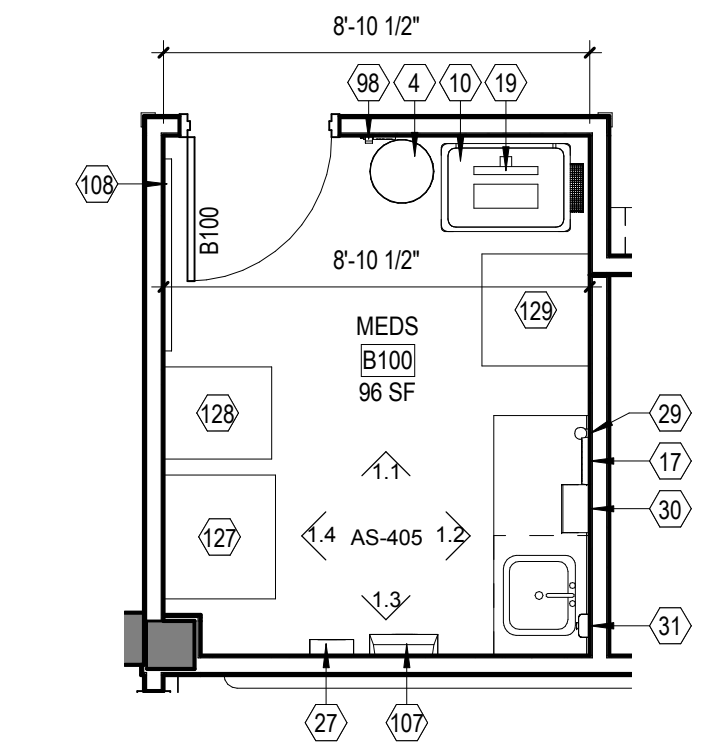


1 WING B - MEDS
1/4" = 1'-0"

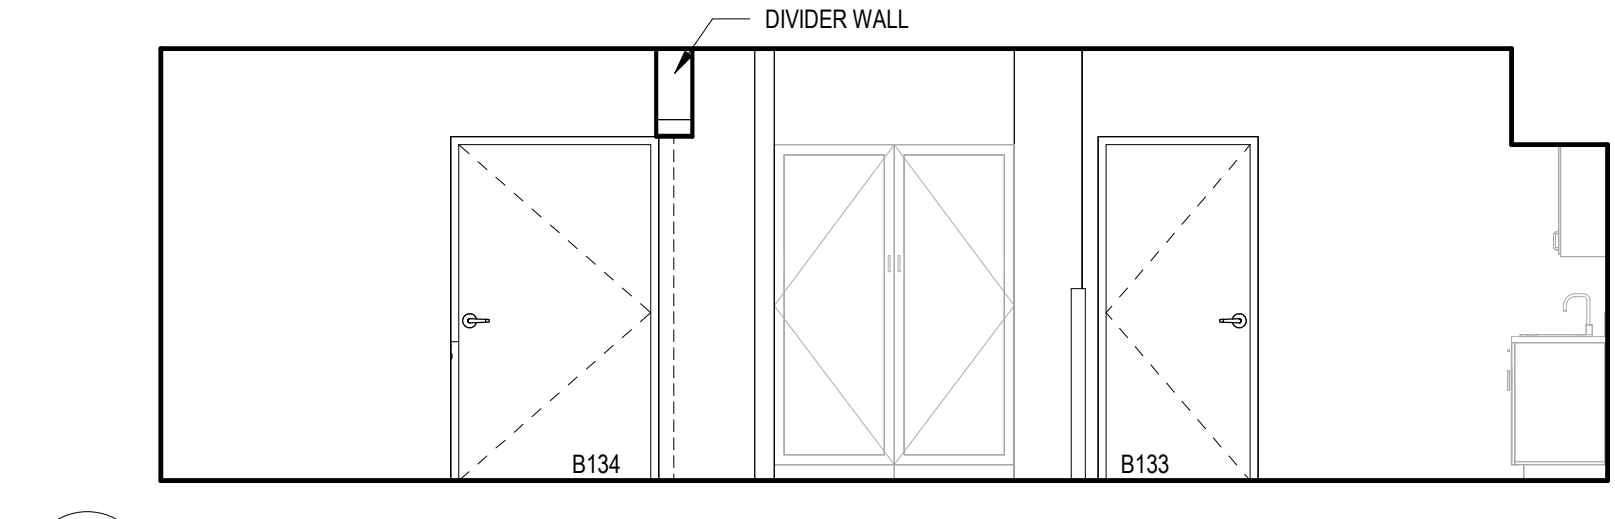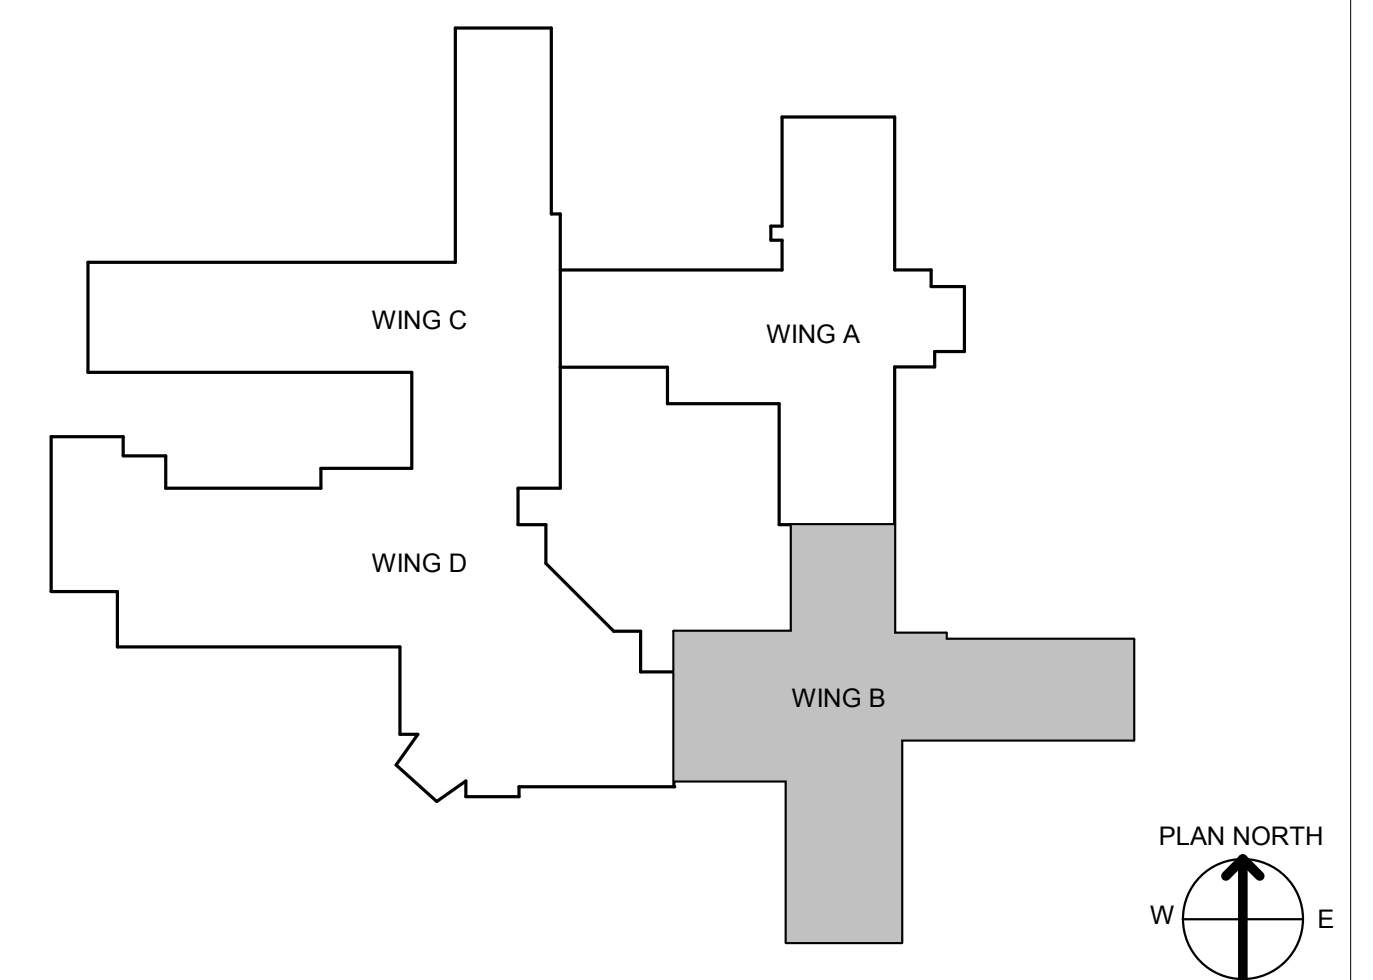


2.3
1/4" = 1'-0"

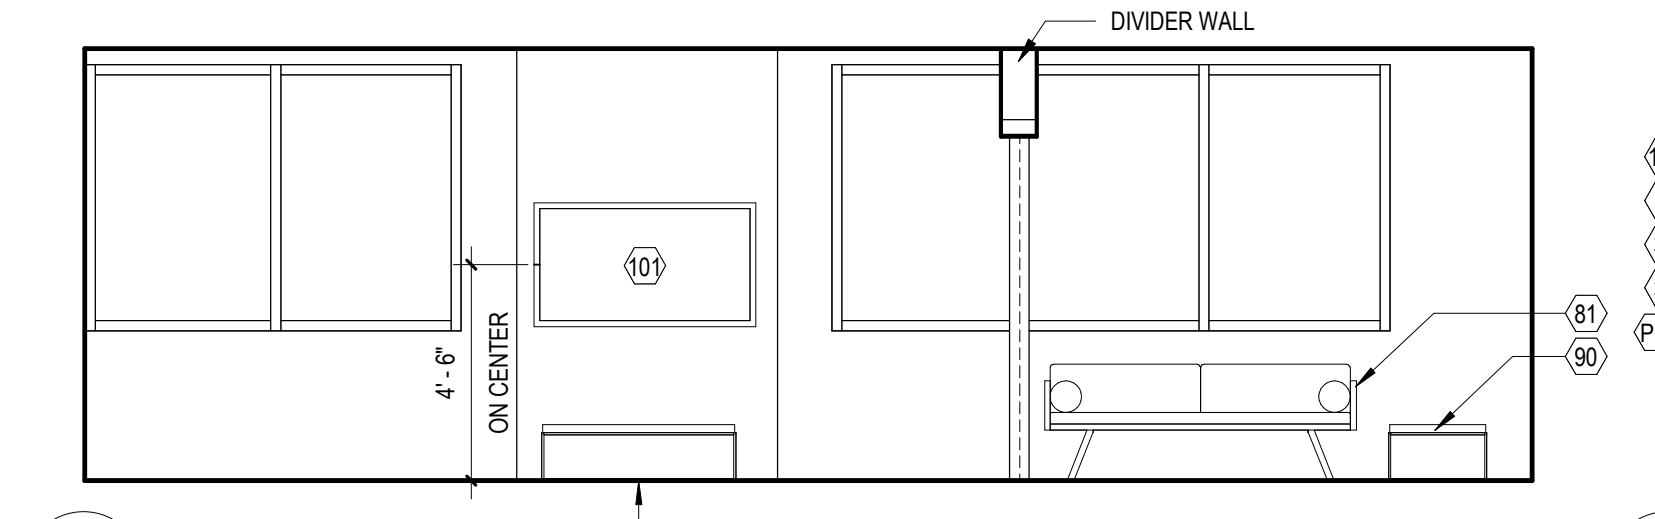


2.2
1/4" = 1'-0"

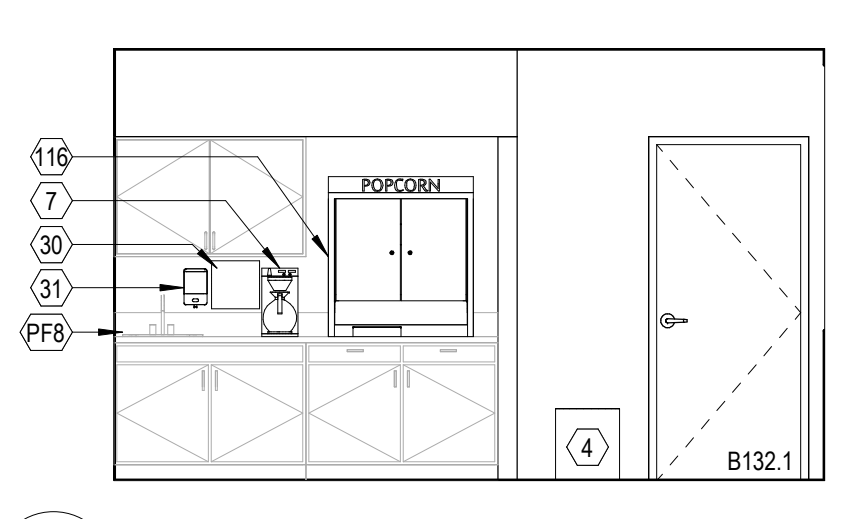


2.1
1/4" = 1'-0"

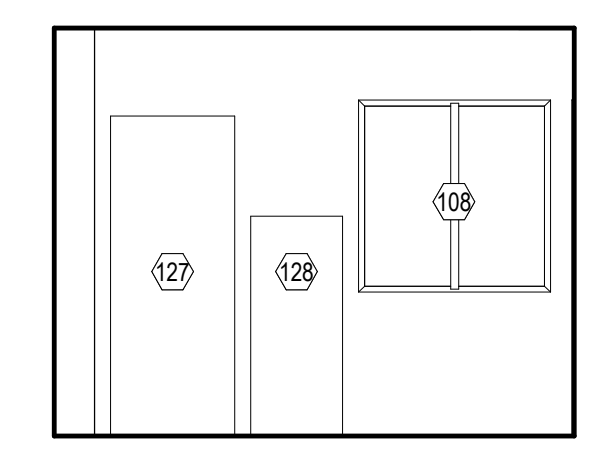


1.4
1/4" = 1'-0"

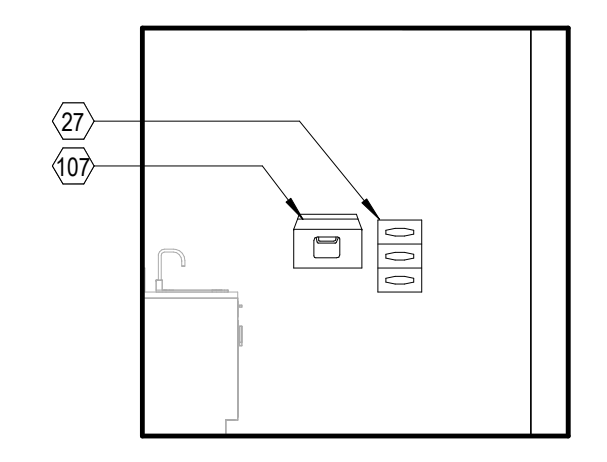

1.3
1/4" = 1'-0"

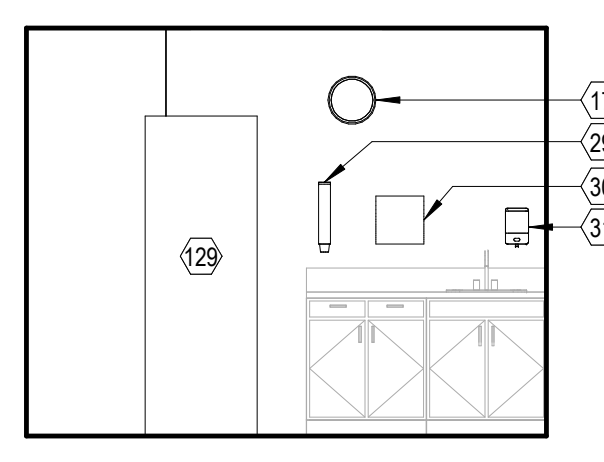

1.2
1/4" = 1'-0"

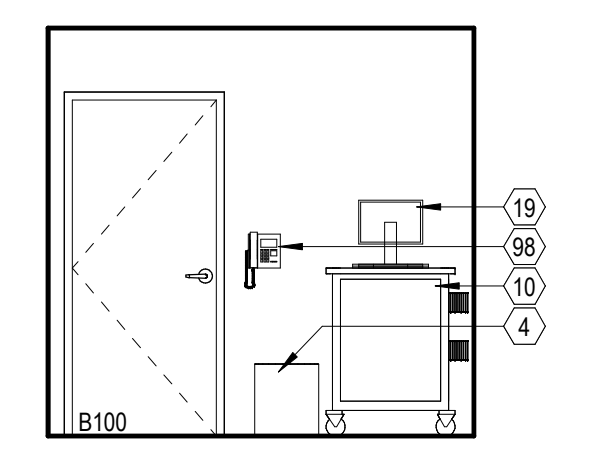

1.1
1/4" = 1'-0"

CONSULTANT INFORMATION

STRUCTURAL / CIVIL ENGINEER	MECHANICAL / ELECTRICAL / PLUMBING / TECHNICAL ENGINEER	FIRE PROTECTION ENGINEER
STAND STRUCTURAL ENGINEERING 11927 W. 112TH STREET, SUITE 200 OVERLAND PARK, KS 66210 (913) 214-2169	SPUR DESIGN 11020 KING STREET, SUITE 350 OVERLAND PARK, KS 66210 (405) 842-6100	POOLE FIRE PROTECTION, INC. 19910 W. 161ST STREET OLATH, KS 66062 (913) 829-8650

ARCHITECT

Office of Construction and Facilities Management

VA U.S. Department of Veteran Affairs

SPUR DESIGN

313 5th Street
Overland Park, KS 66209
spur-design.com

11020 King Street, Suite 350
Overland Park, KS 66210
spur-design.com

6728
JULY 10, 2019
KANSAS ARCHITECT

KS ARCH REG. NO. A-1139, EXP. 12/31/2019
KS ENGR REG. NO. E-2586, EXP. 12/31/2019

SHEET TITLE
WING B - FF&E - ENLARGED PLANS & ELEVATIONS

PROJECT PHASE
BID DOCUMENTS

FULLY SPRINKLERED

APPROVED: PROJECT DIRECTOR

PROJECT TITLE
RENOVATE A & B WING BUILDING 6

PROJECT LOCATION
2200 SW GAGE BLVD.
TOPEKA, KS 66622

DATE
07/10/2019

CHECKED BY
AWM

DRAWN BY
JET

VA PROJECT NUMBER
589A5-19-116

BUILDING NUMBER
6






DRAWING NUMBER
6-AS-405

Dwg. 26 OF 160

ARCH - SCHEDULE, DOOR, WING A												
MARK	DOOR					FRAME			DETAIL		COMMENTS	
	TYPE	WIDTH	HEIGHT	THICKNESS	MATERIAL	FIRE RATING	HARDWARE	TYPE	MATERIAL	FINISH		HEAD
A102	F	3'-0"	7'-0"	1 3/4"	WD.	-	X	1	H.M.	PAINT	2	1
A103	F	4'-0"	7'-0"	1 3/4"	WD.	-	X	1	H.M.	PAINT	2	1
A104	F	3'-0"	7'-0"	1 3/4"	WD.	45	X	1	H.M.	PAINT	2	1
A105	F	3'-0"	7'-0"	1 3/4"	WD.	-	X	1	H.M.	PAINT	2	1
A106	F	3'-0"	7'-0"	1 3/4"	WD.	-	X	1	H.M.	PAINT	2	1
A107	F	4'-0"	7'-0"	1 3/4"	WD.	-	X	1	H.M.	PAINT	2	1
A108	F	3'-0"	7'-0"	1 3/4"	WD.	-	X	1	H.M.	PAINT	2	1
A108.1	F	3'-0"	7'-0"	1 3/4"	WD.	-	X	1	H.M.	PAINT	2	1
A109	F	4'-0"	7'-0"	1 3/4"	WD.	-	X	1	H.M.	PAINT	2	1
A110	DF	6'-0"	7'-0"	1 3/4"	WD.	-	X	1	H.M.	PAINT	2	1
A110.1	DF	6'-0"	7'-0"	1 3/4"	WD.	-	X	1	H.M.	PAINT	2	1
A110.2	DF	6'-0"	7'-0"	1 3/4"	WD.	-	X	1	H.M.	PAINT	2	1
A110.3	WS	4'-0"	7'-0"	1 3/4"	ALUM.	-	X	1	ALUM.	ANOD. AF	AG	ALUM. STOREFRONT
A111	DF	6'-0"	7'-0"	1 3/4"	WD.	45	X	1	H.M.	PAINT	2	1
A112	F	3'-0"	7'-0"	1 3/4"	WD.	45	X	1	H.M.	PAINT	2	1
A113	DF	6'-0"	7'-0"	1 3/4"	WD.	45	X	1	H.M.	PAINT	2	1
A114	F	3'-0"	7'-0"	1 3/4"	WD.	45	X	1	H.M.	PAINT	2	1
A115	F	4'-0"	7'-0"	1 3/4"	WD.	-	X	1	H.M.	PAINT	2	1
A116	F	4'-0"	7'-0"	1 3/4"	WD.	-	X	1	H.M.	PAINT	2	1
A117	F	4'-0"	7'-0"	1 3/4"	WD.	-	X	1	H.M.	PAINT	2	1
A118	F	4'-0"	7'-0"	1 3/4"	WD.	-	X	1	H.M.	PAINT	2	1
A119	F	3'-0"	7'-0"	1 3/4"	WD.	-	X	1	H.M.	PAINT	2	1
A120	F	4'-0"	7'-0"	1 3/4"	WD.	45	X	1	H.M.	PAINT	2	1
A121	F	4'-0"	7'-0"	1 3/4"	WD.	-	X	1	H.M.	PAINT	2	1
A122	F	3'-0"	7'-0"	1 3/4"	WD.	-	X	1	H.M.	PAINT	2	1
A123	F	4'-0"	7'-0"	1 3/4"	WD.	-	X	1	H.M.	PAINT	2	1
A124	F	4'-0"	7'-0"	1 3/4"	WD.	-	X	1	H.M.	PAINT	2	1
A125	F	4'-0"	7'-0"	1 3/4"	WD.	-	X	1	H.M.	PAINT	2	1
A126	F	3'-0"	7'-0"	1 3/4"	WD.	-	X	1	H.M.	PAINT	2	1
A127	F	4'-0"	7'-0"	1 3/4"	WD.	45	X	1	H.M.	PAINT	2	1
A128	F	3'-0"	7'-0"	1 3/4"	WD.	45	X	1	H.M.	PAINT	2	1
A129	F	4'-0"	7'-0"	1 3/4"	WD.	-	X	1	H.M.	PAINT	2	1
A130	F	3'-0"	7'-0"	1 3/4"	WD.	-	X	1	H.M.	PAINT	2	1
A131	F	3'-0"	7'-0"	1 3/4"	WD.	-	X	1	H.M.	PAINT	2	1
A132	F	3'-0"	7'-0"	1 3/4"	WD.	-	X	1	H.M.	PAINT	2	1
A133	UF	6'-0"	7'-0"	1 3/4"	WD.	-	X	1	H.M.	PAINT	2	1
A134	F	3'-0"	7'-0"	1 3/4"	WD.	-	X	1	H.M.	PAINT	2	1
A135	F	3'-0"	7'-0"	1 3/4"	WD.	-	X	1	H.M.	PAINT	2	1
A136	F	3'-0"	7'-0"	1 3/4"	WD.	-	X	1	H.M.	PAINT	2	1
A137	F	3'-0"	7'-0"	1 3/4"	WD.	-	X	1	H.M.	PAINT	2	1
A138	UF	6'-0"	7'-0"	1 3/4"	WD.	-	X	1	H.M.	PAINT	2	1
A138.1	F	3'-0"	7'-0"	1 3/4"	WD.	-	X	1	H.M.	PAINT	2	1
A139	F	3'-0"	7'-0"	1 3/4"	WD.	45	X	1	H.M.	PAINT	2	1
ACDR02	DF	7'-8"	7'-0"	2"	WD.	90	X	1	H.M.	PAINT	2	1

ARCH - SCHEDULE, DOOR, WING B												
MARK	DOOR					FRAME			DETAIL		COMMENTS	
	TYPE	WIDTH	HEIGHT	THICKNESS	MATERIAL	FIRE RATING	HARDWARE	TYPE	MATERIAL	FINISH		HEAD
B100	F	3'-0"	7'-0"	1 3/4"	WD.	45	X	1	H.M.	PAINT	2	1
B104	F	4'-0"	7'-0"	1 3/4"	WD.	45	X	1	H.M.	PAINT	2	1
B105	F	3'-0"	7'-0"	1 3/4"	WD.	45	X	1	H.M.	PAINT	2	1
B106	F	3'-0"	7'-0"	1 3/4"	WD.	45	X	1	H.M.	PAINT	2	1
B107	F	3'-0"	7'-0"	1 3/4"	WD.	45	X	1	H.M.	PAINT	2	1
B108	DWS	3'-0"	7'-0"	1 3/4"	ALUM.	-	X	1	ALUM.	ANOD. AF	AG	WIND-GRD
B109	F	3'-0"	7'-0"	1 3/4"	WD.	-	X	1	H.M.	PAINT	2	1
B110	F	4'-0"	7'-0"	1 3/4"	WD.	-	X	1	H.M.	PAINT	2	1
B111	F	4'-0"	7'-0"	1 3/4"	WD.	-	X	1	H.M.	PAINT	2	1
B112	F	4'-0"	7'-0"	1 3/4"	WD.	-	X	1	H.M.	PAINT	2	1
B113	F	4'-0"	7'-0"	1 3/4"	WD.	-	X	1	H.M.	PAINT	2	1
B114	F	4'-0"	7'-0"	1 3/4"	WD.	-	X	1	H.M.	PAINT	2	1
B115	F	3'-0"	7'-0"	1 3/4"	WD.	-	X	1	H.M.	PAINT	2	1
B116	F	3'-0"	7'-0"	1 3/4"	WD.	-	X	1	H.M.	PAINT	2	1
B117	F	3'-0"	7'-0"	1 3/4"	WD.	-	X	1	H.M.	PAINT	2	1
B119	UF	6'-0"	7'-0"	1 3/4"	WD.	-	X	1	H.M.	PAINT	2	1
B119.1	F	4'-0"	7'-0"	1 3/4"	WD.	-	X	1	H.M.	PAINT	2	1
B119.2	UF	6'-0"	7'-0"	0"	WD.	-	X	2	H.M.	PAINT	2	1
B120	F	4'-0"	7'-0"	1 3/4"	WD.	-	X	1	H.M.	PAINT	2	1
B120.1	F	3'-0"	7'-0"	1 3/4"	WD.	-	X	2	H.M.	PAINT	2	1
B121	F	4'-0"	7'-0"	1 3/4"	WD.	-	X	1	H.M.	PAINT	2	1
B121.1	F	3'-0"	7'-0"	1 3/4"	WD.	-	X	2	H.M.	PAINT	2	1
B122	F	4'-0"	7'-0"	1 3/4"	WD.	-	X	1	H.M.	PAINT	2	1
B122.1	F	3'-0"	7'-0"	1 3/4"	WD.	-	X	2	H.M.	PAINT	2	1
B123	F	4'-0"	7'-0"	1 3/4"	WD.	-	X	1	H.M.	PAINT	2	1
B123.1	F	3'-0"	7'-0"	1 3/4"	WD.	-	X	2	H.M.	PAINT	2	1
B124	F	4'-0"	7'-0"	1 3/4"	WD.	-	X	1	H.M.	PAINT	2	1
B124.1	F	3'-0"	7'-0"	1 3/4"	WD.	-	X	2	H.M.	PAINT	2	1
B125	F	4'-0"	7'-0"	1 3/4"	WD.	-	X	1	H.M.	PAINT	2	1
B125.1	UF	6'-0"	7'-0"	1 3/4"	WD.	-	X	2	H.M.	PAINT	2	1
B126	F	4'-0"	7'-0"	1 3/4"	WD.	-	X	1	H.M.	PAINT	2	1
B126.1	F	3'-0"	7'-0"	1 3/4"	WD.	-	X	2	H.M.	PAINT	2	1
B127	F	3'-0"	7'-0"	1 3/4"	WD.	45	X	1	H.M.	PAINT	2	1
B128	F	3'-0"	7'-0"	1 3/4"	WD.	45	X	1	H.M.	PAINT	2	1
B129	F	3'-0"	7'-0"	1 3/4"	WD.	-	X	1	H.M.	PAINT	2	1
B130	F	4'-0"	7'-0"	1 3/4"	WD.	-	X	1	H.M.	PAINT	2	1
B130.1	F	3'-0"	7'-0"	1 3/4"	WD.	-	X	2	H.M.	PAINT	2	1
B131	F	4'-0"	7'-0"	1 3/4"	WD.	-	X	1	H.M.	PAINT	2	1
B131.1	F	3'-0"	7'-0"	1 3/4"	WD.	-	X	2	H.M.	PAINT	2	1
B132	F	4'-0"	7'-0"	1 3/4"	WD.	-	X	1	H.M.	PAINT	2	1
B132.1	F	3'-0"	7'-0"	1 3/4"	WD.	-	X	1	H.M.	PAINT	2	1
B133	F	3'-0"	7'-0"	1 3/4"	WD.	-	X	1	H.M.	PAINT	2	1
B134	F	4'-0"	7'-0"	1 3/4"	WD.	-	X	1	H.M.	PAINT	2	1
B135	F	4'-0"	7'-0"	1 3/4"	WD.	-	X	1	H.M.	PAINT	2	1
B135.1	F	3'-0"	7'-0"	1 3/4"	WD.	-	X	2	H.M.	PAINT	2	1
B136	F	4'-0"	7'-0"	1 3/4"	WD.	-	X	1	H.M.	PAINT	2	1
B136.1	F	3'-0"	7'-0"	1 3/4"	WD.	-	X	2	H.M.	PAINT	2	1
B137	F	4'-0"	7'-0"	1 3/4"	WD.	-	X	1	H.M.	PAINT	2	1
B137.1	F	3'-0"	7'-0"	1 3/4"	WD.	-	X	2	H.M.	PAINT	2	1
BCDR01	DF	7'-8"	7'-0"	2"	WD.	-	X	1	H.M.	PAINT	2	1
BCDR02	DF	6'-8"	7'-0"	1 3/4"	WD.	-	X	1	H.M.	PAINT	2	1
BCDR01	-	3'-8"	7'-0"	1 3/4"	WD.	-	X	-	H.M.	PAINT	2	1
BCDR02	-	3'-8"	7'-0"	1 3/4"	WD.	-	X	-	H.M.	PAINT	2	1

ACDR01	DF	7'-8"	7'-0"	2"	WD.	90	700R	1	H.M.	PAINT	2	1	2 HR FB, MAGNETIC HOLD-OPEN ON FUSIBLE LINK
--------	----	-------	-------	----	-----	----	------	---	------	-------	---	---	---

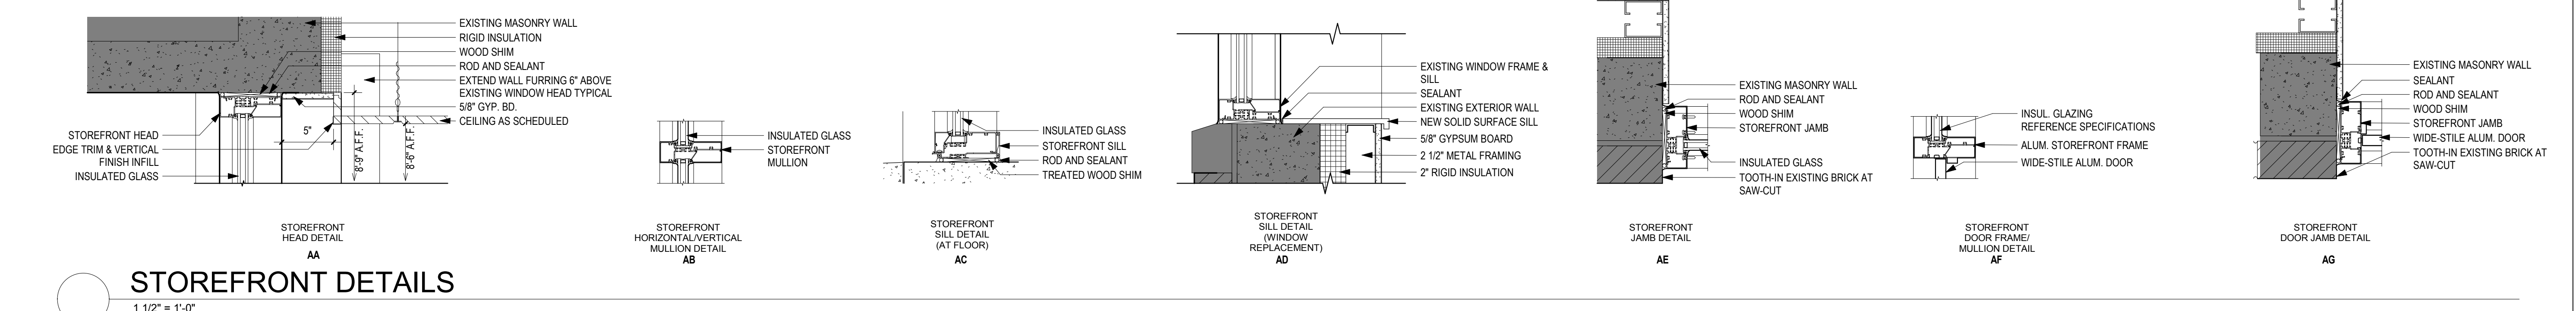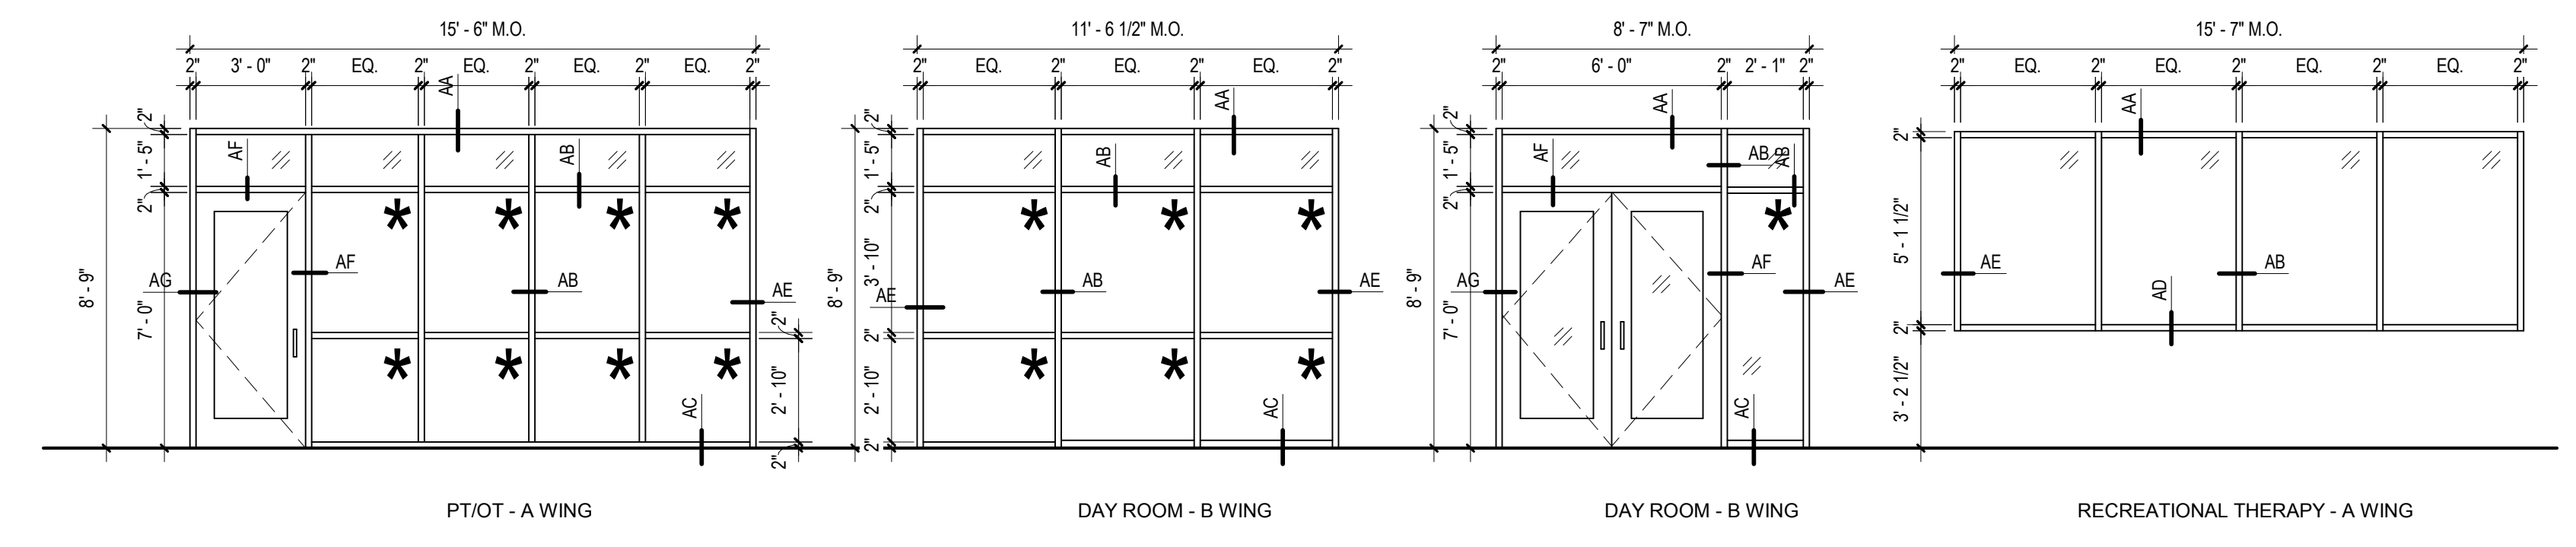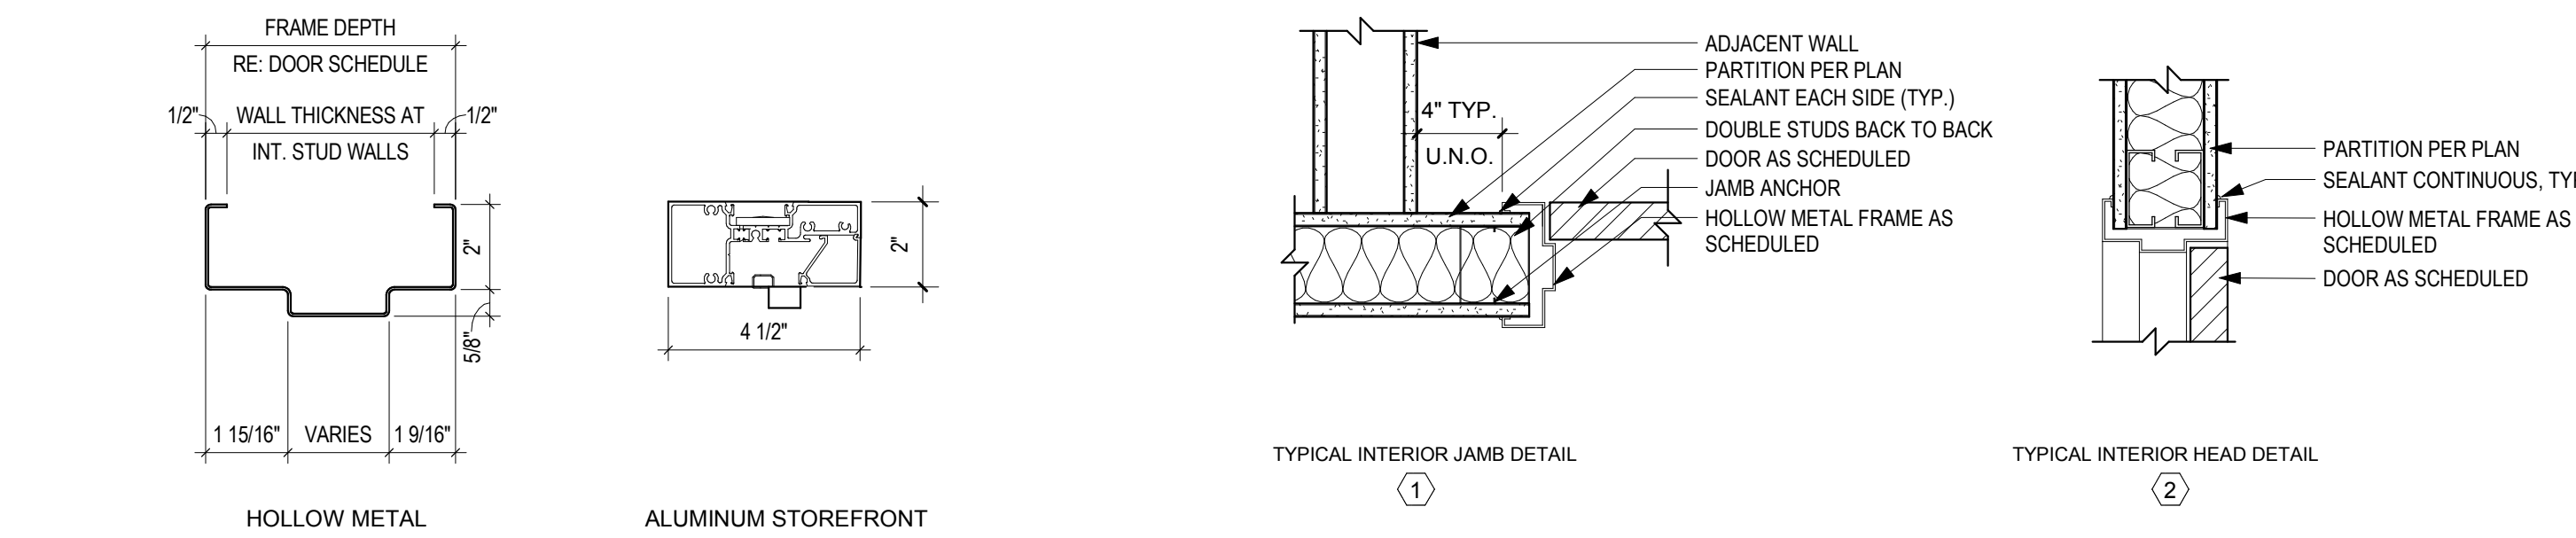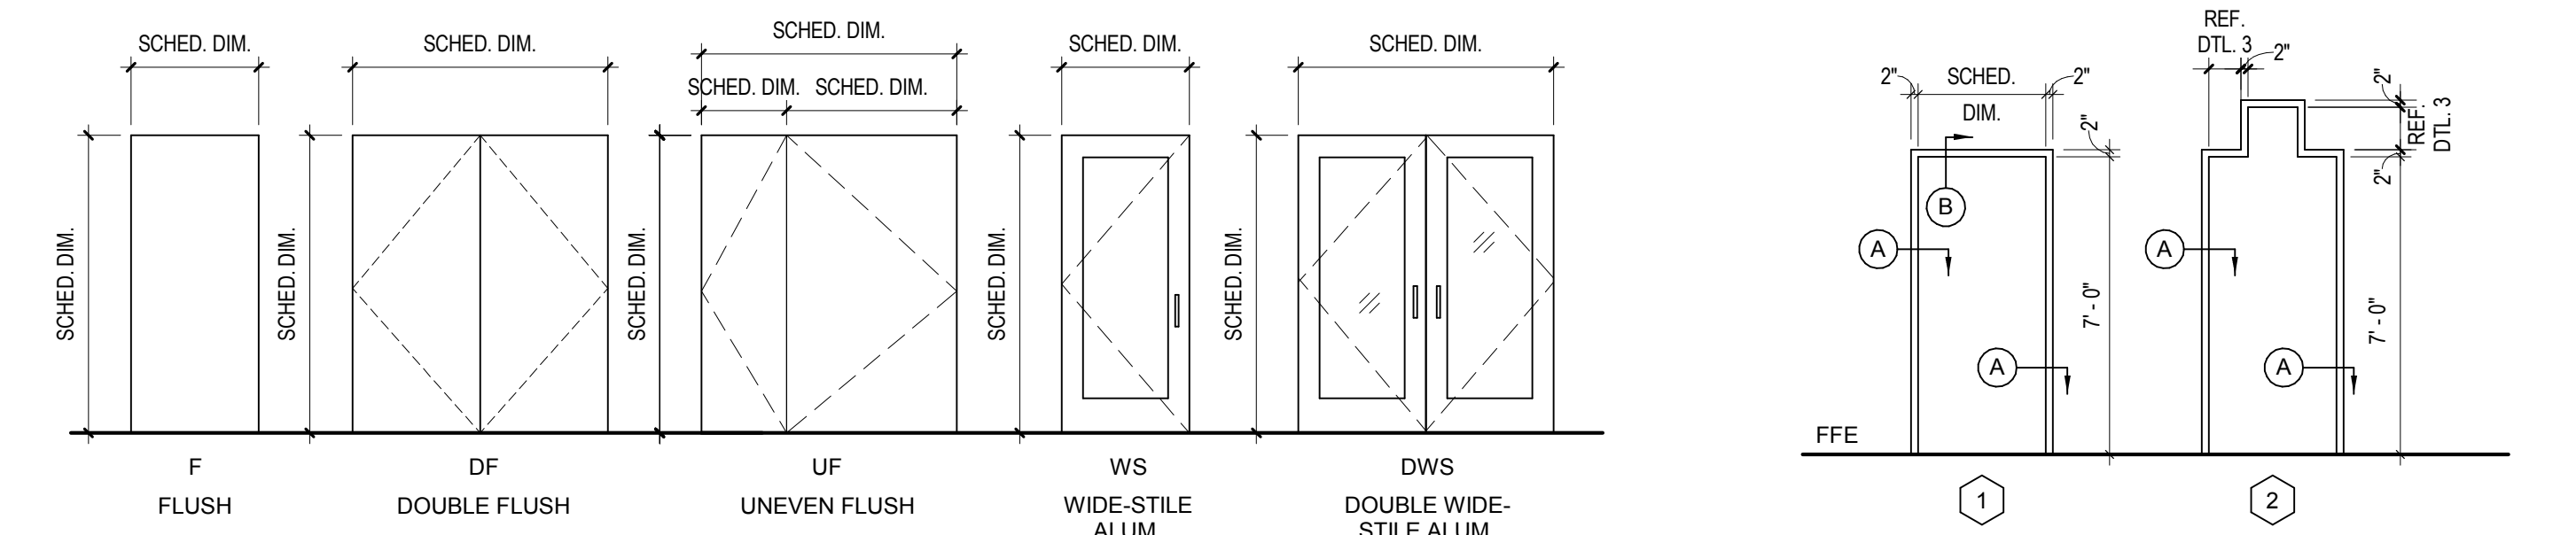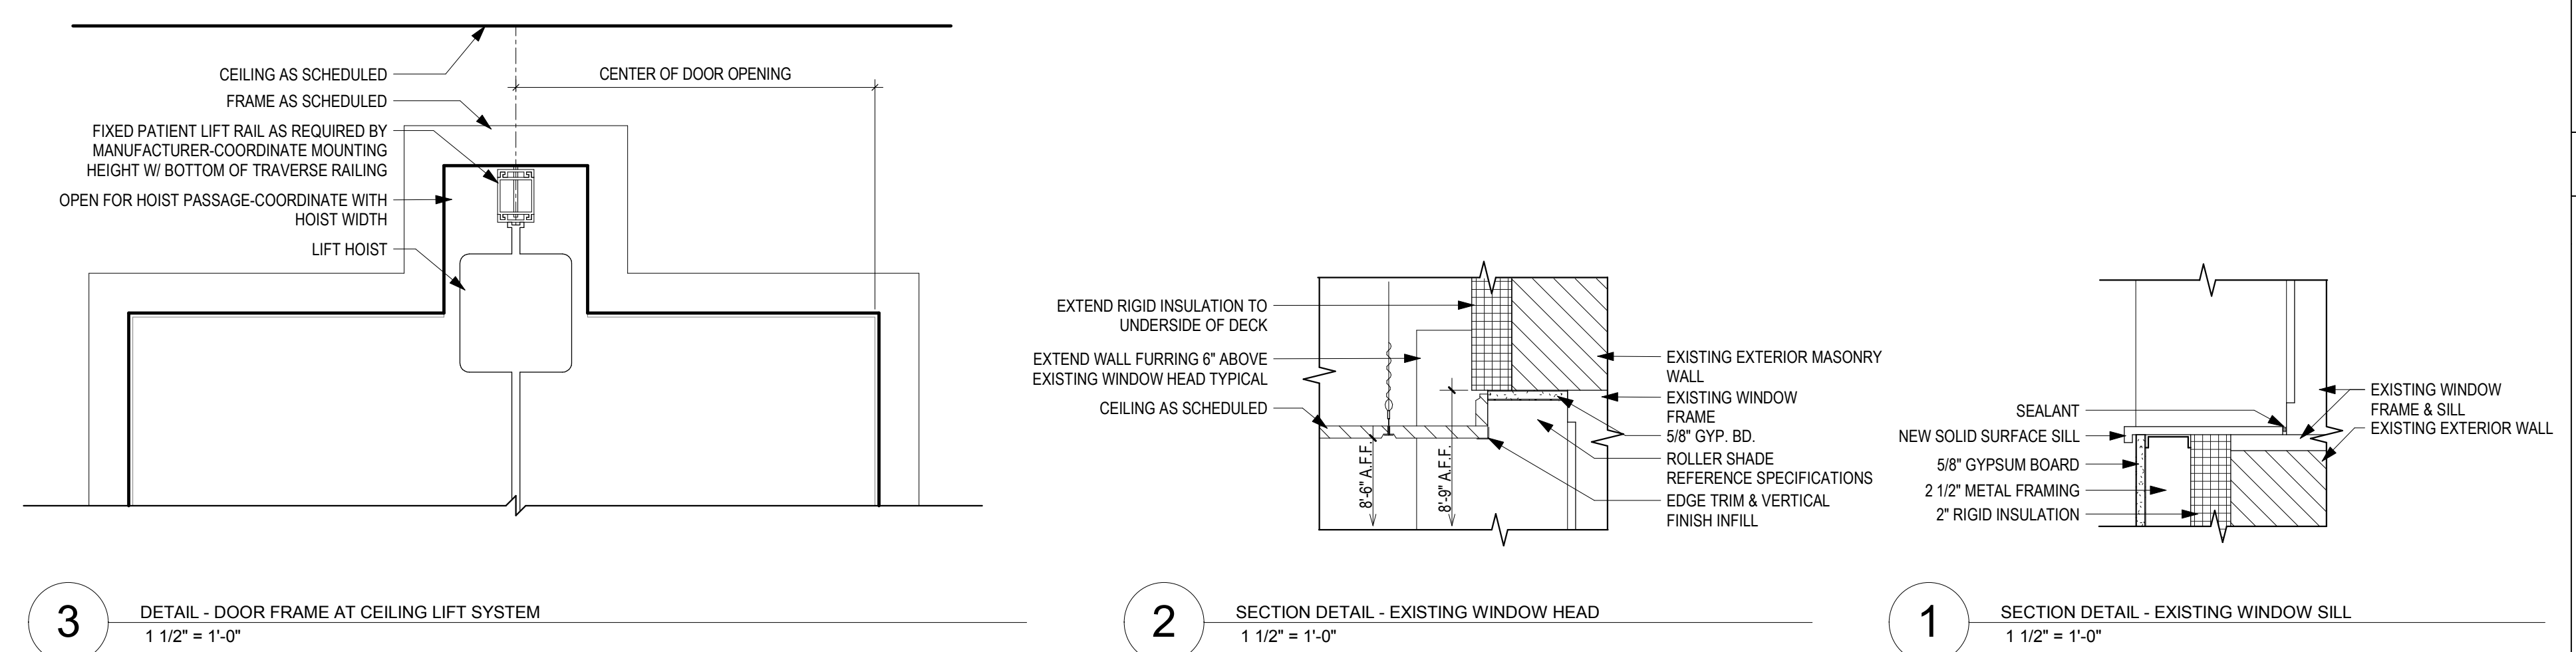

GENERAL DOOR NOTES

- ALL DOOR FRAMES TO BE LOCATED 3" FROM OUTSIDE OF FRAME TO FINISH FACE OF ADJACENT WALL UNLESS NOTED OTHERWISE.
- DOOR JAMBS SHOULD HAVE HOSPITAL-TYPE SANITARY STOPS THAT STOP 8" FROM THE FINISH FLOOR TO FACILITATE MOPPING.
- KICKMOP PLATES SHOULD BE APPLIED TO BOTH SIDES OF THE DOORS, UNLESS OTHERWISE NOTED.
- 1/4" FIRE GLASS AT RATED DOORS.

GENERAL WINDOW LEGEND

* TEMPERED GLAZING

PROJECT TITLE
RENOVATE A & B WING BUILDING 6

PROJECT LOCATION
2200 SW GAGE BLVD.
TOPEKA, KS 66622

VA PROJECT NUMBER
589A5-19-116

BUILDING NUMBER
6

DRAWING NUMBER
6-AS-500

DATE
07/10/2019

CHECKED BY
AWM

DRAWN BY
JET

Dwg. 27 OF 160

ADDENDUM 02 01/24/2020

CONSULTANT INFORMATION

STRUCTURAL / CIVIL ENGINEER: STANFORD STRUCTURAL ENGINEERING, 11227 W. 112TH STREET, SUITE 200, OVERLAND PARK, KS 66210 (913) 214-2169

MECHANICAL / ELECTRICAL / PLUMBING / TECHNICAL ENGINEER: SPUR DESIGN, 11020 KING STREET, SUITE 350, OVERLAND PARK, KS 66210 (405) 842-6100

FIRE PROTECTION ENGINEER: POOLE FIRE PROTECTION, INC., 19910 W. 161ST STREET, OLATH, KS 66062 (913) 829-8650

ARCHITECT

Office of Construction and Facilities Management

VA U.S. Department of Veteran Affairs

SHEET TITLE
DOOR, FRAME & WINDOW SCHEDULES & ELEVATIONS

APPROVED: PROJECT DIRECTOR

PROJECT PHASE
BID DOCUMENTS

FULLY SPRINKLERED


ROOM FINISH SCHEDULE - WING A

#	ROOM NAME	ARCH - SCHEDULE, ROOM FINISH, WING A										CEILING			
		FLOOR FINISHES		WALL FINISHES		NORTH		EAST		SOUTH			WEST		
		MATERIAL	BASE	NORTH	EAST	SOUTH	WEST	SOUTH	WEST	SOUTH	WEST		SOUTH	WEST	
A100	VESTIBULE	WCP1	RB	P2	P2	P2	P2	P2	P2	P2	P2	P2	P2	P2	GWB
A101	RECEPTION	TER	RB, ARB	P2	P2	P2	P2	P2	P2	P2	P2	P2	P2	P2	GWB
A102	FAMILY TLT	P14	ARB	P1, PT1, PT2, PT3, PT4	P2, PT1, PT2, PT3, PT4	P2, PT1, PT2, PT3, PT4	P2, PT1, PT2, PT3, PT4	P2, PT1, PT2, PT3, PT4	P2, PT1, PT2, PT3, PT4	P2, PT1, PT2, PT3, PT4	P2, PT1, PT2, PT3, PT4	P2, PT1, PT2, PT3, PT4	P2, PT1, PT2, PT3, PT4	P2, PT1, PT2, PT3, PT4	GWB
A103	BARIATRIC TLT	ARB	ARB	P2, PT1, PT2, PT3, PT4	P2, PT1, PT2, PT3, PT4	P2, PT1, PT2, PT3, PT4	P2, PT1, PT2, PT3, PT4	P2, PT1, PT2, PT3, PT4	P2, PT1, PT2, PT3, PT4	P2, PT1, PT2, PT3, PT4	P2, PT1, PT2, PT3, PT4	P2, PT1, PT2, PT3, PT4	P2, PT1, PT2, PT3, PT4	P2, PT1, PT2, PT3, PT4	GWB
A104	STORAGE	LVT2	RB	P2	P2	P2	P2	P2	P2	P2	P2	P2	P2	P2	GWB
A105	STAFF TOILET	P14	ARB	P2, PT1, PT2, PT3, PT4	P2, PT1, PT2, PT3, PT4	P2, PT1, PT2, PT3, PT4	P2, PT1, PT2, PT3, PT4	P2, PT1, PT2, PT3, PT4	P2, PT1, PT2, PT3, PT4	P2, PT1, PT2, PT3, PT4	P2, PT1, PT2, PT3, PT4	P2, PT1, PT2, PT3, PT4	P2, PT1, PT2, PT3, PT4	P2, PT1, PT2, PT3, PT4	GWB
A106	STAFF TOILET	P14	ARB	P2, PT1, PT2, PT3, PT4	P2, PT1, PT2, PT3, PT4	P2, PT1, PT2, PT3, PT4	P2, PT1, PT2, PT3, PT4	P2, PT1, PT2, PT3, PT4	P2, PT1, PT2, PT3, PT4	P2, PT1, PT2, PT3, PT4	P2, PT1, PT2, PT3, PT4	P2, PT1, PT2, PT3, PT4	P2, PT1, PT2, PT3, PT4	P2, PT1, PT2, PT3, PT4	GWB
A107	MIS RESTOR OFFICE	LVT2	RB	P3	P3	P3	P3	P3	P3	P3	P3	P3	P3	P3	ACT
A108	TESTING INTERN	LVT2	RB	P3	P3	P3	P3	P3	P3	P3	P3	P3	P3	P3	GWB
A109	GEOT/OPS	LVT2	RB	P3	P3	P3	P3	P3	P3	P3	P3	P3	P3	P3	ACT
A110	PT / I OT	WSF1, WSF2	WSF2	P3	P3, P7	P3	P3, P7	P3	P3, P7	P3	P3, P7	P3	P3, P7	P3	ACT, GWB
A111	ELEC	LVT1	RB	P3	P3	P3	P3	P3	P3	P3	P3	P3	P3	P3	NO CEILING
A112	STOR	LVT1	RB	P3	P3	P3	P3	P3	P3	P3	P3	P3	P3	P3	NO CEILING
A113	ENG SERV	LVT1	RB	P3	P3	P3	P3	P3	P3	P3	P3	P3	P3	P3	NO CEILING
A114	IT	LVT2	RB	P3	P3	P3	P3	P3	P3	P3	P3	P3	P3	P3	NO CEILING
A114.1	EXISTING IT	LVT2	RB	P3	P3	P3	P3	P3	P3	P3	P3	P3	P3	P3	NO CEILING
A115	REC THERAPY	LVT1	RB	P3, P7	P3, P7	P3	P3	P3	P3	P3	P3	P3	P3	P3	ACT, GWB
A116	ASST NURSE MNGR	LVT2	RB	P3	P3	P3	P3	P3	P3	P3	P3	P3	P3	P3	ACT
A117	ACNS	LVT2	RB	P3	P3	P3	P3	P3	P3	P3	P3	P3	P3	P3	ACT
A118	HOSPICE APRN	LVT2	RB	P3	P3	P3	P3	P3	P3	P3	P3	P3	P3	P3	ACT
A119	REPORT ROOM	LVT2	RB	P3	P3	P3	P3	P3	P3	P3	P3	P3	P3	P3	ACT
A120	STORAGE	LVT2	RB	P3	P3	P3	P3	P3	P3	P3	P3	P3	P3	P3	ACT
A121	DITCHMAN	LVT2	RB	P3	P3	P3	P3	P3	P3	P3	P3	P3	P3	P3	ACT
A122	LACTATION / PUMP	LVT2	RB	P7	P3	P3	P3	P3	P3	P3	P3	P3	P3	P3	GWB
A123	SOCIAL WORK	LVT2	RB	P3	P3	P3	P3	P3	P3	P3	P3	P3	P3	P3	ACT
A124	PHARM D	LVT2	RB	P3	P3	P3	P3	P3	P3	P3	P3	P3	P3	P3	ACT
A125	REC THERAPY OFFICE	LVT2	RB	P3	P3	P3	P3	P3	P3	P3	P3	P3	P3	P3	ACT
A126	EXAM	LVT2	RB	P3	P3	P3	P3	P3	P3	P3	P3	P3	P3	P3	ACT
A127	HAC	LVT2	RB	P2	P2	P2	P2	P2	P2	P2	P2	P2	P2	P2	NO CEILING
A128	PILOT STOR	LVT2	RB	P2	P2	P2	P2	P2	P2	P2	P2	P2	P2	P2	ACT
A129	GEC PHYSICIAN	LVT2	RB	P3	P3	P3	P3	P3	P3	P3	P3	P3	P3	P3	ACT
A130	CONFERENCE	LVT2	RB	P3	P3	P3	P3	P3	P3	P3	P3	P3	P3	P3	ACT
A131	LEARNER OFFICE	LVT2	RB	P3	P3	P3	P3	P3	P3	P3	P3	P3	P3	P3	ACT
A132	BREAK ROOM	LVT2	RB	P3, PT2	P3, PT2	P3	P3	P3	P3	P3	P3	P3	P3	P3	ACT
A133	TOILET, BARIATRIC, SHOWER	P14	ARB	PT1, PT2, PT3, PT4	PT1, PT2, PT3, PT4	PT1, PT2, PT3, PT4	PT1, PT2, PT3, PT4	PT1, PT2, PT3, PT4	PT1, PT2, PT3, PT4	PT1, PT2, PT3, PT4	PT1, PT2, PT3, PT4	PT1, PT2, PT3, PT4	PT1, PT2, PT3, PT4	PT1, PT2, PT3, PT4	GWB
A134	TESTING	LVT2	RB	P3	P3	P3	P3	P3	P3	P3	P3	P3	P3	P3	ACT
A135	EXAM	LVT2	RB	P3	P3	P3	P3	P3	P3	P3	P3	P3	P3	P3	ACT
A135	STAIR	-	-	-	-	-	-	-	-	-	-	-	-	-	ACT
A136	EXAM	LVT2	RB	P3	P3	P3	P3	P3	P3	P3	P3	P3	P3	P3	ACT
A137	NURSE MED	LVT2	RB	P3	P3	P3	P3	P3	P3	P3	P3	P3	P3	P3	ACT
A138	EXAM, BARIATRIC	LVT2	RB	P3	P3	P3	P3	P3	P3	P3	P3	P3	P3	P3	ACT
A139	ED SUPPLY ROOM	LVT2	RB	P3	P3	P3	P3	P3	P3	P3	P3	P3	P3	P3	ACT
ACOR1	CORRIDOR A	LVT1, LVT2, TER	RB	P3, WP	P3, WP	P3, WP	P3, WP	P3, WP	P3, WP	P3, WP	P3, WP	P3, WP	P3, WP	P3, WP	ACT, GWB
ACOR2	CORRIDOR	LVT1	RB	P3, WP	P3, WP	P3, WP	P3, WP	P3, WP	P3, WP	P3, WP	P3, WP	P3, WP	P3, WP	P3, WP	ACT, GWB
ACOR3	CORRIDOR A	LVT1, LVT2	RB	P3, WP	P3, WP	P3, WP	P3, WP	P3, WP	P3, WP	P3, WP	P3, WP	P3, WP	P3, WP	P3, WP	ACT, GWB

ROOM FINISH SCHEDULE - WING B

#	ROOM NAME	ARCH - SCHEDULE, ROOM FINISH, WING B										CEILING			
		FLOOR FINISHES		WALL FINISHES		NORTH		EAST		SOUTH			WEST		
		MATERIAL	BASE	NORTH	EAST	SOUTH	WEST	SOUTH	WEST	SOUTH	WEST		SOUTH	WEST	
B100	MEDS	LVT2	RB	P3	P3	P3	P3	P3	P3	P3	P3	P3	P3	P3	GWB
B101	ELEC	LVT2	RB	P3	P3	P3	P3	P3	P3	P3	P3	P3	P3	P3	NO CEILING
B102	NURSE STATION	LVT2	ARB	P3, P6	P3, P6	P3, P6	P3, P6	P3, P6	P3, P6	P3, P6	P3, P6	P3, P6	P3, P6	P3, P6	ACT, GWB
B104	CORNER SUPPLY	LVT2	RB	P3	P3	P3	P3	P3	P3	P3	P3	P3	P3	P3	ACT, GWB
B105	STORAGE	LVT2	RB	P3	P3	P3	P3	P3	P3	P3	P3	P3	P3	P3	ACT
B106	SOILED-HOLDING	LVT2	RB	P3	P3	P3	P3	P3	P3	P3	P3	P3	P3	P3	ACT
B107	CLEAN LINEN	LVT2	RB	P2	P2	P2	P2	P2	P2	P2	P2	P2	P2	P2	ACT
B108	DINING & DAY ROOM	LVT1	RB	P3	P3	P3	P3	P3	P3	P3	P3	P3	P3	P3	ACT, GWB
B109	KITCHEN	LVT3	RB	P3, PT2	P3, PT2	P3, PT2	P3, PT2	P3, PT2	P3, PT2	P3, PT2	P3, PT2	P3, PT2	P3, PT2	P3, PT2	ACT, GWB
B110	APRN	LVT2	RB	P3	P3	P3	P3	P3	P3	P3	P3	P3	P3	P3	ACT
B111	GERIATRIC PSYCHIATRIST	LVT2	RB	P3	P3	P3	P3	P3	P3	P3	P3	P3	P3	P3	ACT
B112	NURSE MNGR	LVT2	RB	P3	P3	P3	P3	P3	P3	P3	P3	P3	P3	P3	ACT
B113	SOCIAL WORKER	LVT2	RB	P3	P3	P3	P3	P3	P3	P3	P3	P3	P3	P3	ACT
B114	CLINICAL NURSE LEADER	LVT2	RB	P3	P3	P3	P3	P3	P3	P3	P3	P3	P3	P3	ACT
B115	STAFF BREAK	LVT2	RB	P3	P3, PT2	P3, PT2	P3, PT2	P3, PT2	P3, PT2	P3, PT2	P3, PT2	P3, PT2	P3, PT2	P3, PT2	ACT
B116	STAFF TOILET	P14	ARB	PT1, PT2, PT3, PT4	P3, PT1, PT2, PT3, PT4	P3, PT1, PT2, PT3, PT4	P3, PT1, PT2, PT3, PT4	P3, PT1, PT2, PT3, PT4	P3, PT1, PT2, PT3, PT4	P3, PT1, PT2, PT3, PT4	P3, PT1, PT2, PT3, PT4	P3, PT1, PT2, PT3, PT4	P3, PT1, PT2, PT3, PT4	P3, PT1, PT2, PT3, PT4	ACT
B117	EXAM ROOM	LVT2	RB	P3	P3	P3	P3	P3	P3	P3	P3	P3	P3	P3	ACT
B118	COMPUTER LOUNGE	LVT2	RB	P6	P6	P6	P6	P6	P6	P6	P6	P6	P6	P6	ACT, GWB
B119	RESIDENT (BARIATRIC)	LVT3	RB	P8	P8	P8	P8	P8	P8	P8	P8	P8	P8	P8	ACT
B119A	TOILET (BARIATRIC)	RES	RES	PT1, PT2, PT3, PT4	PT1, PT2, PT3, PT4	PT1, PT2, PT3, PT4	PT1, PT2, PT3, PT4	PT1, PT2, PT3, PT4	PT1, PT2, PT3, PT4	PT1, PT2, PT3, PT4	PT1, PT2, PT3, PT4	PT1, PT2, PT3, PT4	PT1, PT2, PT3, PT4	PT1, PT2, PT3, PT4	GWB
B120	RESIDENT	LVT3	RB	P8	P8	P8	P8	P8	P8	P8	P8	P8	P8	P8	ACT, GWB
B120A	TOILET	RES	RES	RES	P3, PT1, PT2, PT3, PT4	P3, PT1, PT2, PT3, PT4	P3, PT1, PT2, PT3, PT4	P3, PT1, PT2, PT3, PT4	P3, PT1, PT2, PT3, PT4	P3, PT1, PT2, PT3, PT4	P3, PT1, PT2, PT3, PT4	P3, PT1, PT2, PT3, PT4	P3, PT1, PT2, PT3, PT4	P3, PT1, PT2, PT3, PT4	GWB
B121	RESIDENT	LVT3	RB	P8	P8	P8	P8	P8	P8	P8	P8	P8	P8	P8	ACT, GWB
B121A	TOILET	RES	RES	RES	PT1, PT2, PT3, PT4, RES	PT1, PT2, PT3, PT4, RES	PT1, PT2, PT3, PT4, RES	PT1, PT2, PT3, PT4, RES	PT1, PT2, PT3, PT4, RES	PT1, PT2, PT3, PT4, RES	PT1, PT2, PT3, PT4, RES	PT1, PT2, PT3, PT4, RES	PT1, PT2, PT3, PT4, RES	PT1, PT2, PT3, PT4, RES	GWB
B122	RESIDENT	LVT3	RB	P8	P8	P8	P8	P8	P8	P8	P8	P8	P8	P8	ACT, GWB
B122A	TOILET	RES	RES	RES	P3, PT1, PT2, PT3, PT4, RES	P3, PT1, PT2, PT3, PT4, RES	P3, PT1, PT2, PT3, PT4, RES	P3, PT1, PT2, PT3, PT4, RES	P3, PT1, PT2, PT3, PT4, RES	P3, PT1, PT2, PT3, PT4, RES	P3, PT1, PT2, PT3, PT4, RES	P3, PT1, PT2, PT3, PT4, RES	P3, PT1, PT2, PT3, PT4, RES	P3, PT1, PT2, PT3, PT4, RES	GWB
B123	RESIDENT	LVT3	RB	P8	P8	P8	P8	P8	P8	P8	P8	P8	P8	P8	ACT, GWB
B124	RESIDENT	LVT3	RB	P3, PT1, PT2, PT3, PT4	P3, PT1, PT2, PT3, PT4	P3, PT1, PT2, PT3, PT4	P3, PT1, PT2, PT3, PT4	P3, PT1, PT2, PT3, PT4	P3, PT1, PT2, PT3, PT4	P3, PT1, PT2, PT3, PT4	P3, PT1, PT2, PT3, PT4	P3, PT1, PT2, PT3, PT4	P3, PT1, PT2, PT3, PT4	P3, PT1, PT2, PT3, PT4	ACT, GWB
B124A	TOILET	RES	RES	P3, PT1, PT2, PT3, PT4	PT1, PT2, PT3, PT4, RES	PT1, PT2, PT3, PT4, RES	PT1, PT2, PT3, PT4, RES	PT1, PT2, PT3, PT4, RES	PT1, PT2, PT3, PT4, RES	PT1, PT2, PT3, PT4, RES	PT1, PT2, PT3, PT4, RES	PT1, PT2, PT3, PT4, RES	PT1, PT2, PT3, PT4, RES	PT1, PT2, PT3, PT4, RES	GWB
B125	RESIDENT	LVT3	RB	P8	P8	P8	P8	P8	P8	P8	P8	P8	P8	P8	ACT, GWB
B125A	TOILET	RES	RES	P3, PT1, PT2, PT3, PT4	P3, PT1, PT2, PT3, PT4, RES	P3, PT1, PT2, PT3, PT4, RES	P3, PT1, PT2, PT3, PT4, RES	P3, PT1, PT2, PT3, PT4, RES	P3, PT1, PT2, PT3, PT4, RES	P3, PT1, PT2, PT3, PT4, RES	P3, PT1, PT2, PT3, PT4, RES	P3, PT1, PT2, PT3, PT4, RES	P3, PT1, PT2, PT3, PT4, RES	P3, PT1, PT2, PT3, PT4, RES	GWB
B126	TOILET	LVT3	RB	P8	P8	P8	P8	P8	P8	P8	P8	P8	P8	P8	ACT, GWB
B127	LAUNDRY	LVT1	RB	P3	P3	P3	P3	P3	P3	P3	P3	P3	P3	P3	ACT, GWB
B128	HAC	LVT2	RB	P3	P3	P3	P3	P3							

A
B
C
D
E
F

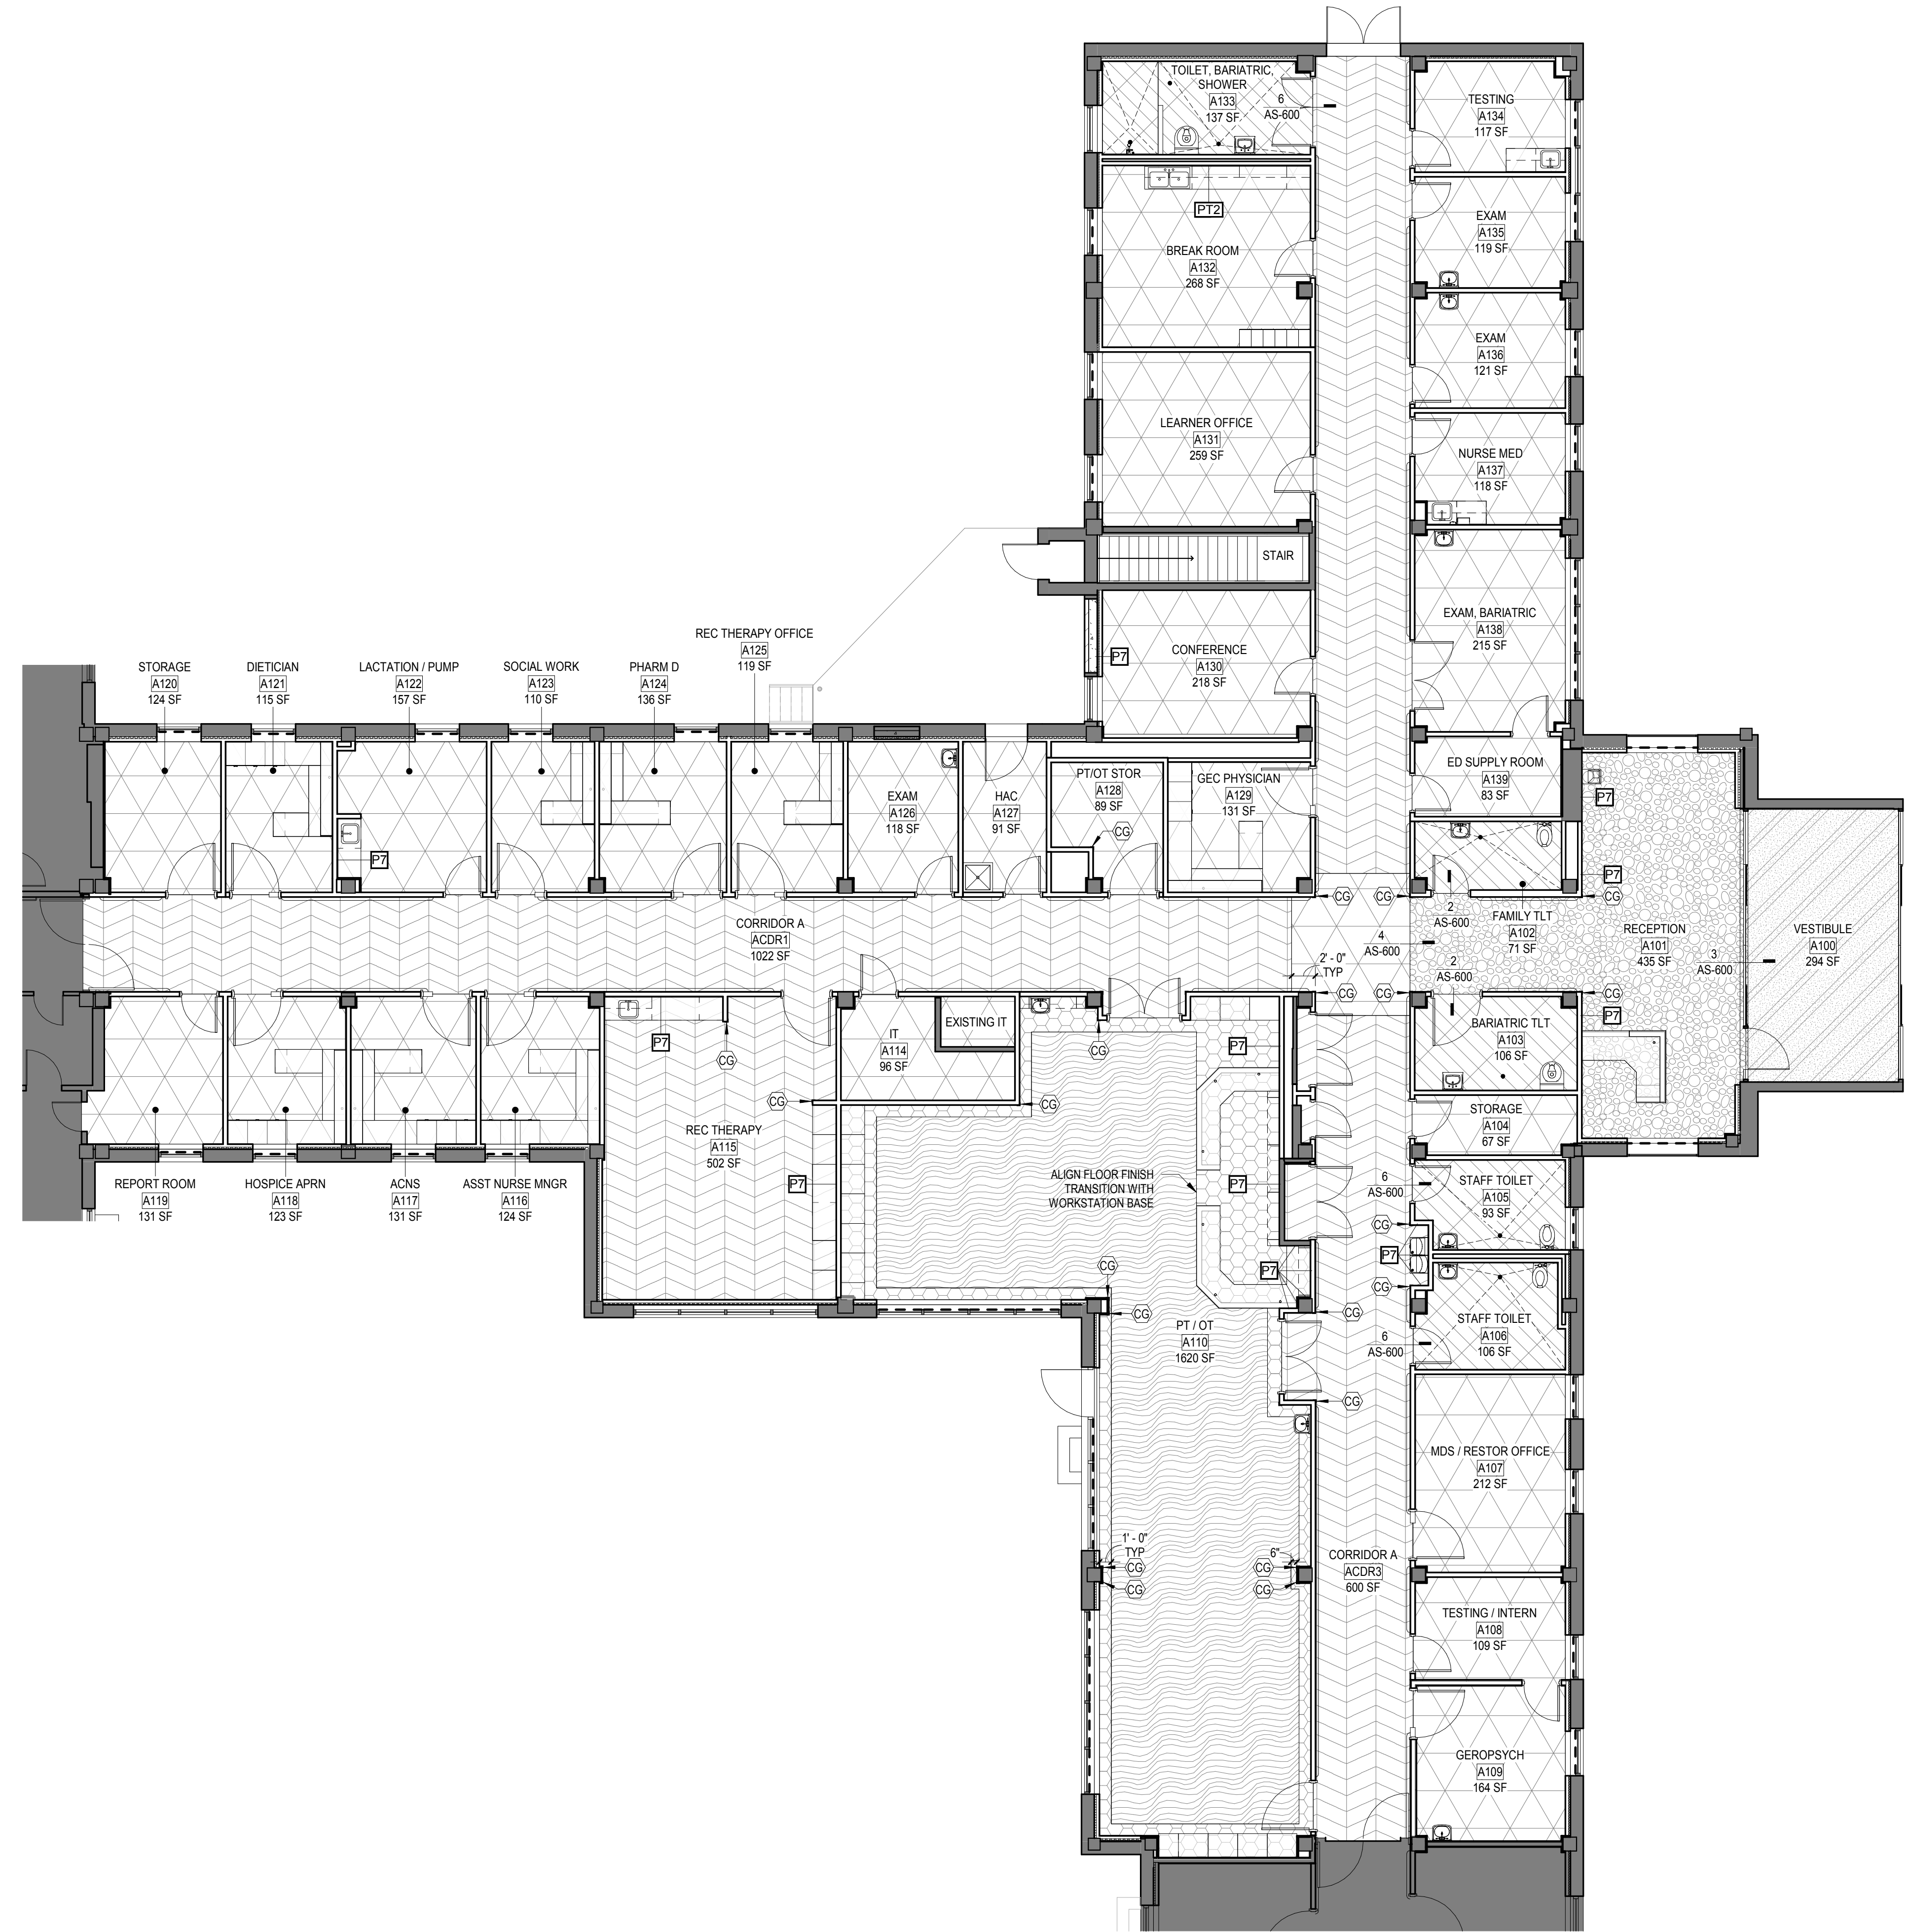


1 WING A - FINISH FLOOR PLAN
1/8" = 1'-0"

GENERAL FINISH NOTES

1. ALL CEILINGS TO BE PAINTED (P1) UNLESS OTHERWISE NOTED!
 2. ALL HOLLOW METAL DOORS AND FRAMES TO BE PAINTED (P2)
 3. ALL WALLS TO BE PAINTED (P3) UNLESS OTHERWISE NOTED!
 4. ALL WOOD DOORS TO BE STAINED (STAIN)
 5. ALL WALL BASE TO BE (WB) UNLESS OTHERWISE NOTED!
 6. ALL CABINETS, CABINET FILLERS, AND SHELVING TO BE PLASTIC LAMINATE ON 3/4" PLYWOOD UNLESS OTHERWISE NOTED!
 7. ALL COUNTERTOPS TO BE PLASTIC LAMINATE (PL), SOLID SURFACE (SS), OR QUARTZ (QTZ), AS SCHEDULED!
- *REFERENCE FINISH LEGEND AND FINISH SCHEDULES
*REFERENCE ARCHITECTURAL CASEWORK LEGEND, PLANS, AND ELEVATIONS

GENERAL FINISH FLOOR PLAN LEGEND

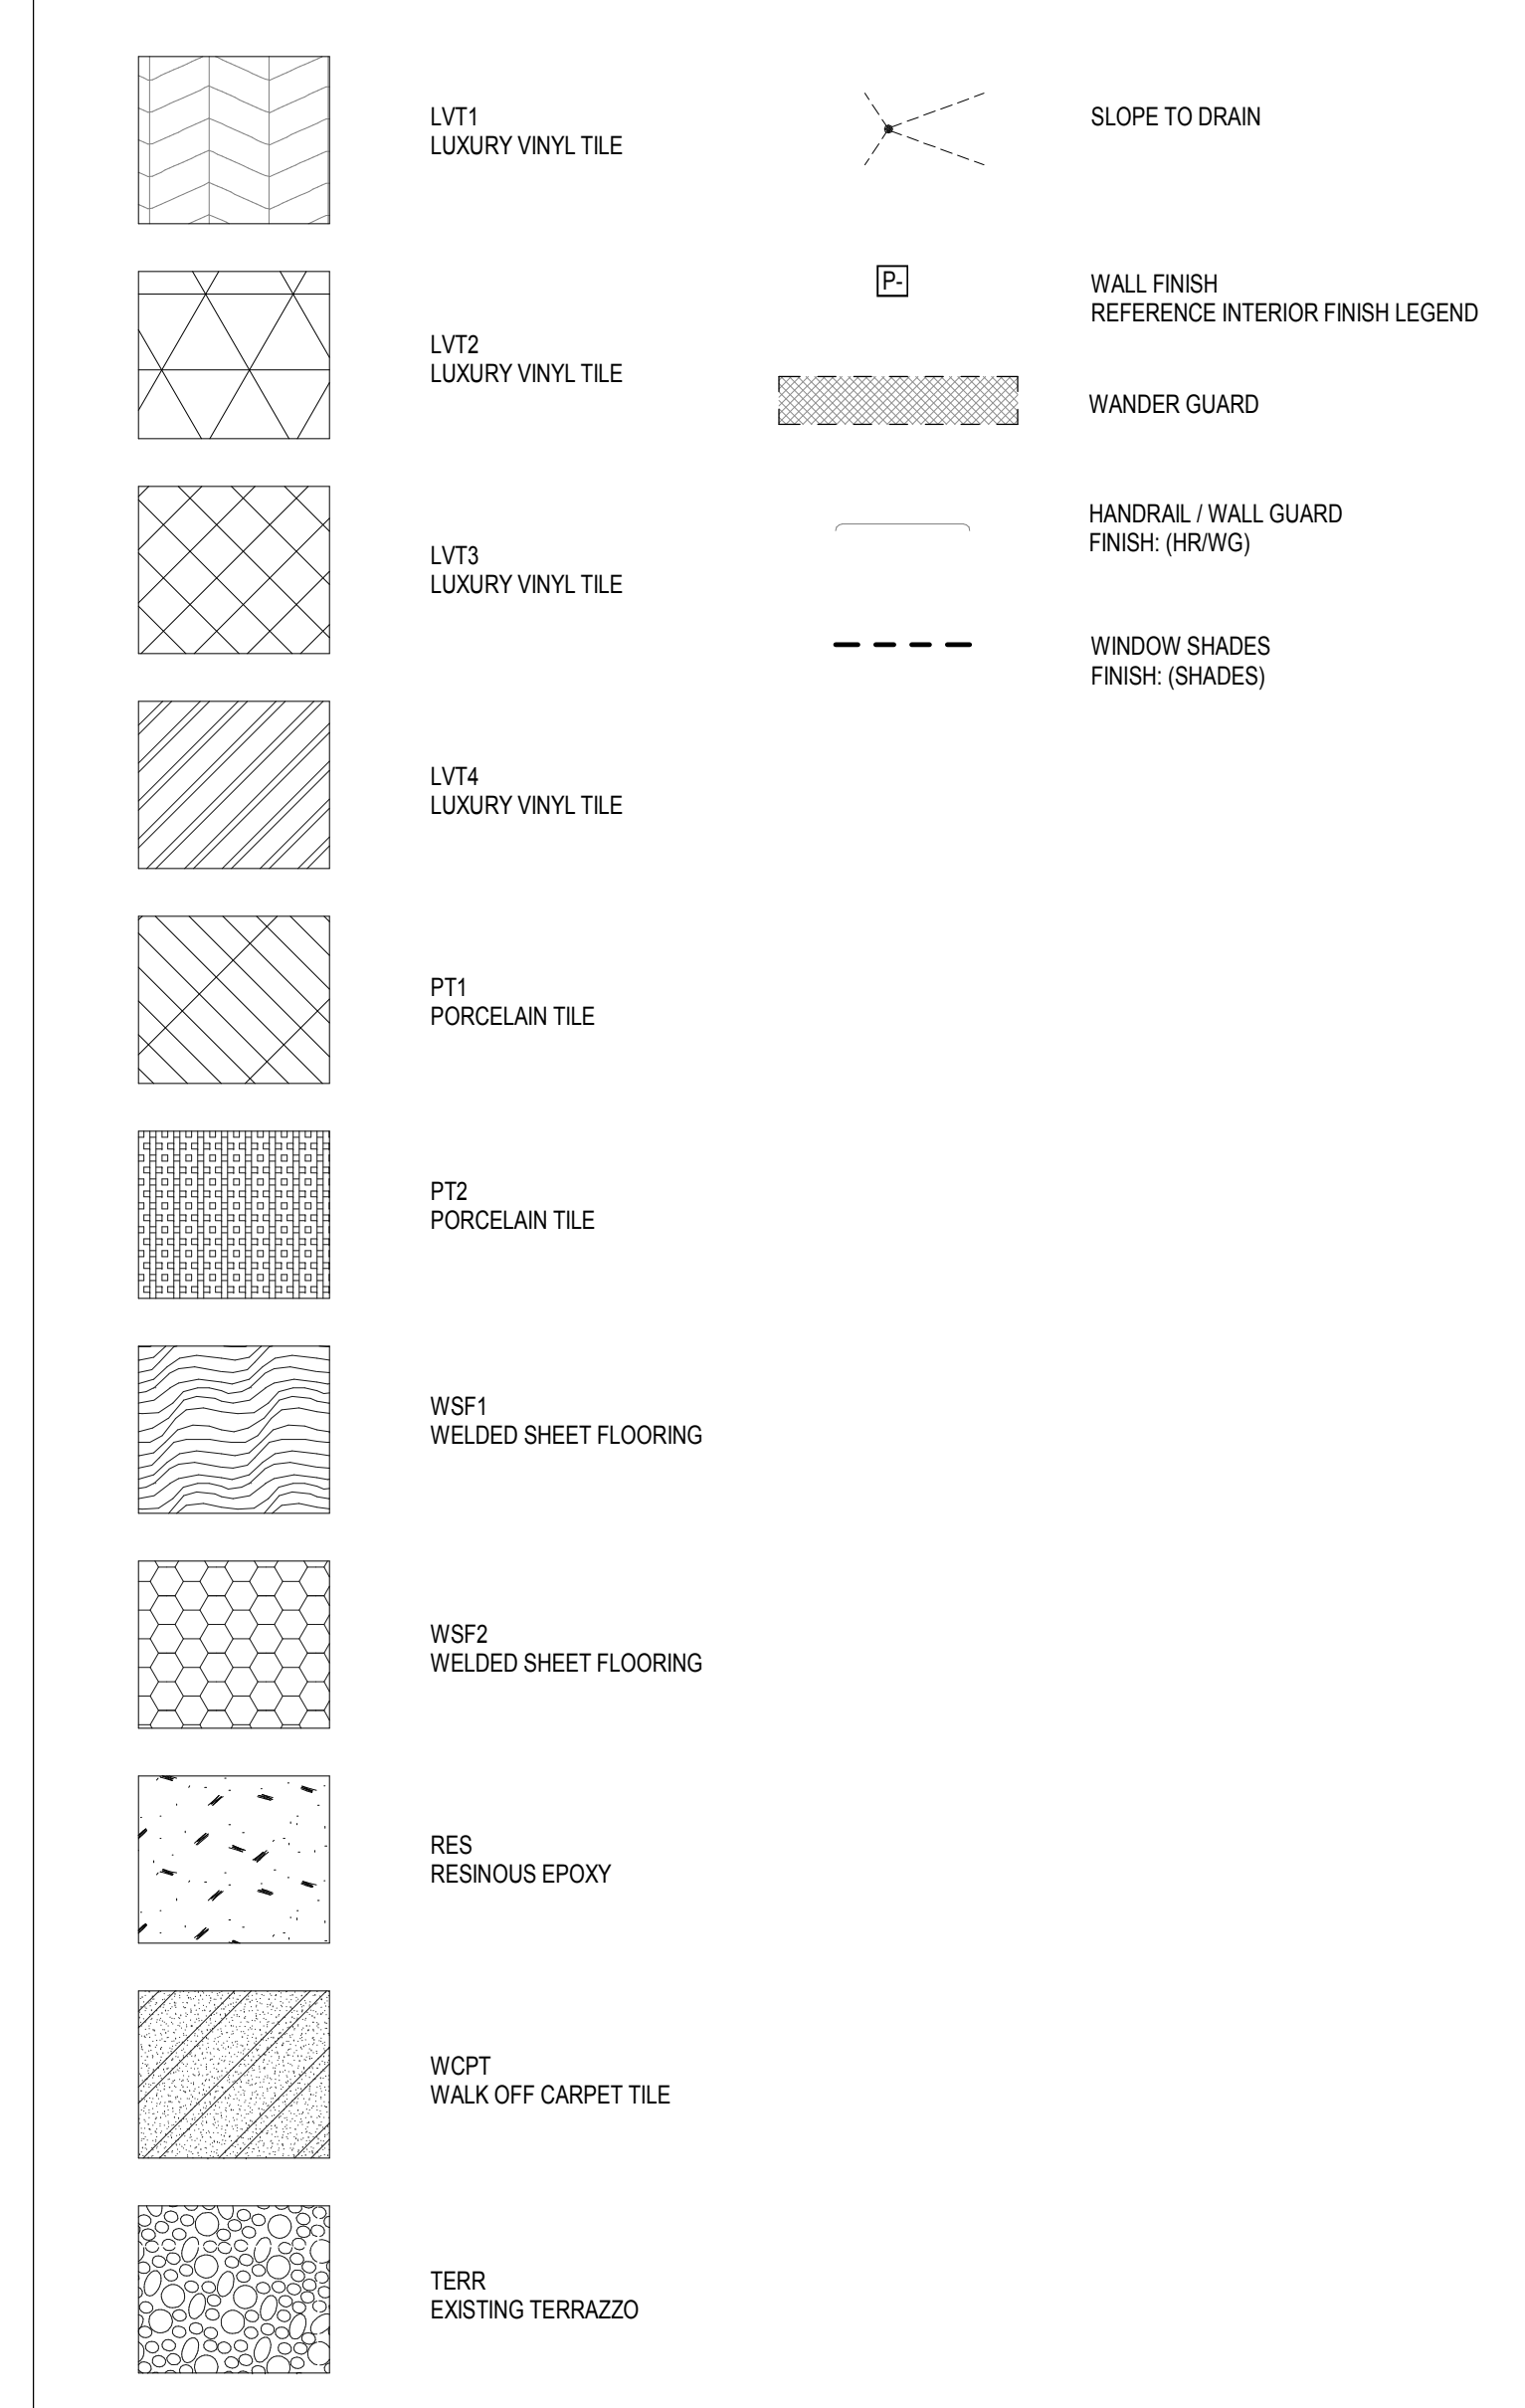


EPOXY FLOOR NOTES


1. FLOORSTONE AT AREAS OF EPOXY FLOOR FINISH ONLY - DO NOT REMOVE EXISTING MATERIAL BEYOND FINISH AREA, EXCEPT AS REQUIRED TO REPAIR EXISTING FLOOR DAMAGE.
2. FLOORSTONE MAXIMUM DEPTH 1/4" - DO NOT EXCEED THIS DEPTH.
3. REFER 13AS-600 FOR TRANSITION DETAIL BETWEEN BUILT-UP EPOXY FLOOR AND ADJACENT FLOOR FINISH MATERIAL.

KEYED NOTES


1. REPLACE EXISTING DOOR AND GLASS WITH 1/4" INSULATED PANEL
2. DOOR, FRAME, AND NEW INSULATED PANEL PAINT FINISH TO MATCH ADJACENT WALL PAINT FINISH AND COLOR.

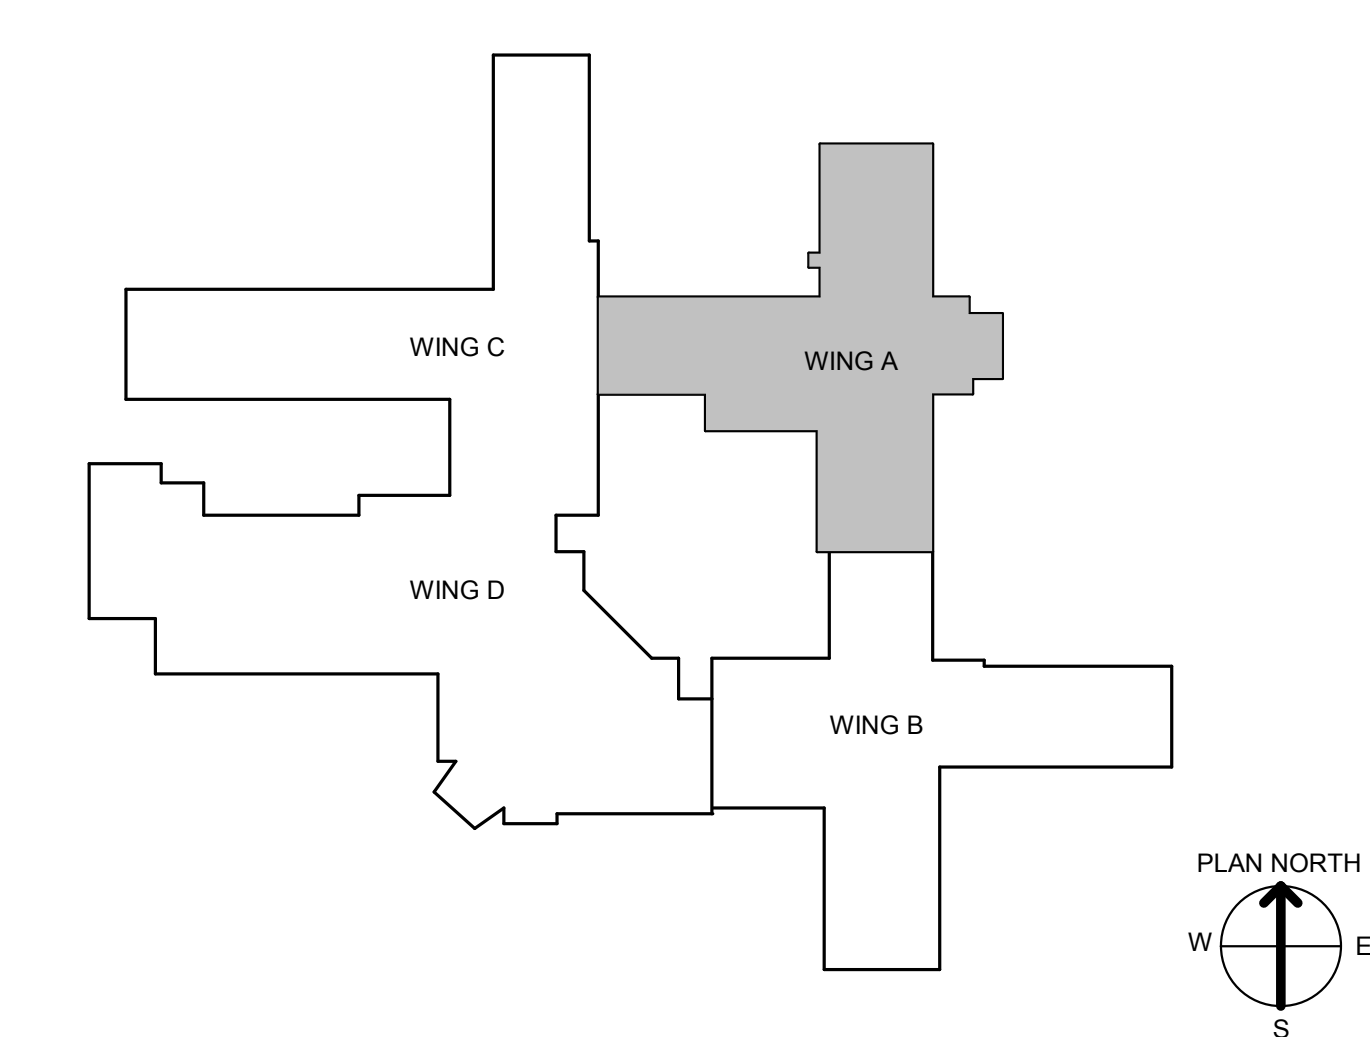


CONSULTANT INFORMATION STRUCTURAL / CIVIL ENGINEER: STAND STRUCTURAL ENGINEERING, 11827 W. 112TH STREET, SUITE 200, OVERLAND PARK, KS 66210 (913) 214-2169 MECHANICAL / ELECTRICAL / PLUMBING / TECHNICAL ENGINEER: SPUR DESIGN, 11020 KING STREET, SUITE 350, OVERLAND PARK, KS 66210 (405) 842-6100 FIRE PROTECTION ENGINEER: POOLE FIRE PROTECTION, INC., 19910 W. 161ST STREET, OLATH, KS 66062 (913) 829-8650		ARCHITECT 512 5th Street, Overland Park, KS 66209 10020 King Street, Suite 300, Overland Park, KS 66209 KS ARCH REG. NO. A-1139, EXP. 12/31/2019 KS ENGR REG. NO. E-2586, EXP. 12/31/2019		Office of Construction and Facilities Management VA U.S. Department of Veteran Affairs		SHEET TITLE: WING A - FINISH PLAN APPROVED: PROJECT DIRECTOR		PROJECT PHASE: BID DOCUMENTS FULLY SPRINKLERED		PROJECT TITLE: RENOVATE A & B WING BUILDING 6 PROJECT LOCATION: 2200 SW GAGE BLVD. TOPEKA, KS 66622 DATE: 07/10/2019 CHECKED BY: AWM DRAWN BY: JET		VA PROJECT NUMBER: 589A5-19-116 BUILDING NUMBER: 6 DRAWING NUMBER: 6-AS-601A Dwg. 29 OF 160	
--	--	--	--	--	--	---	--	---	--	--	--	--	--

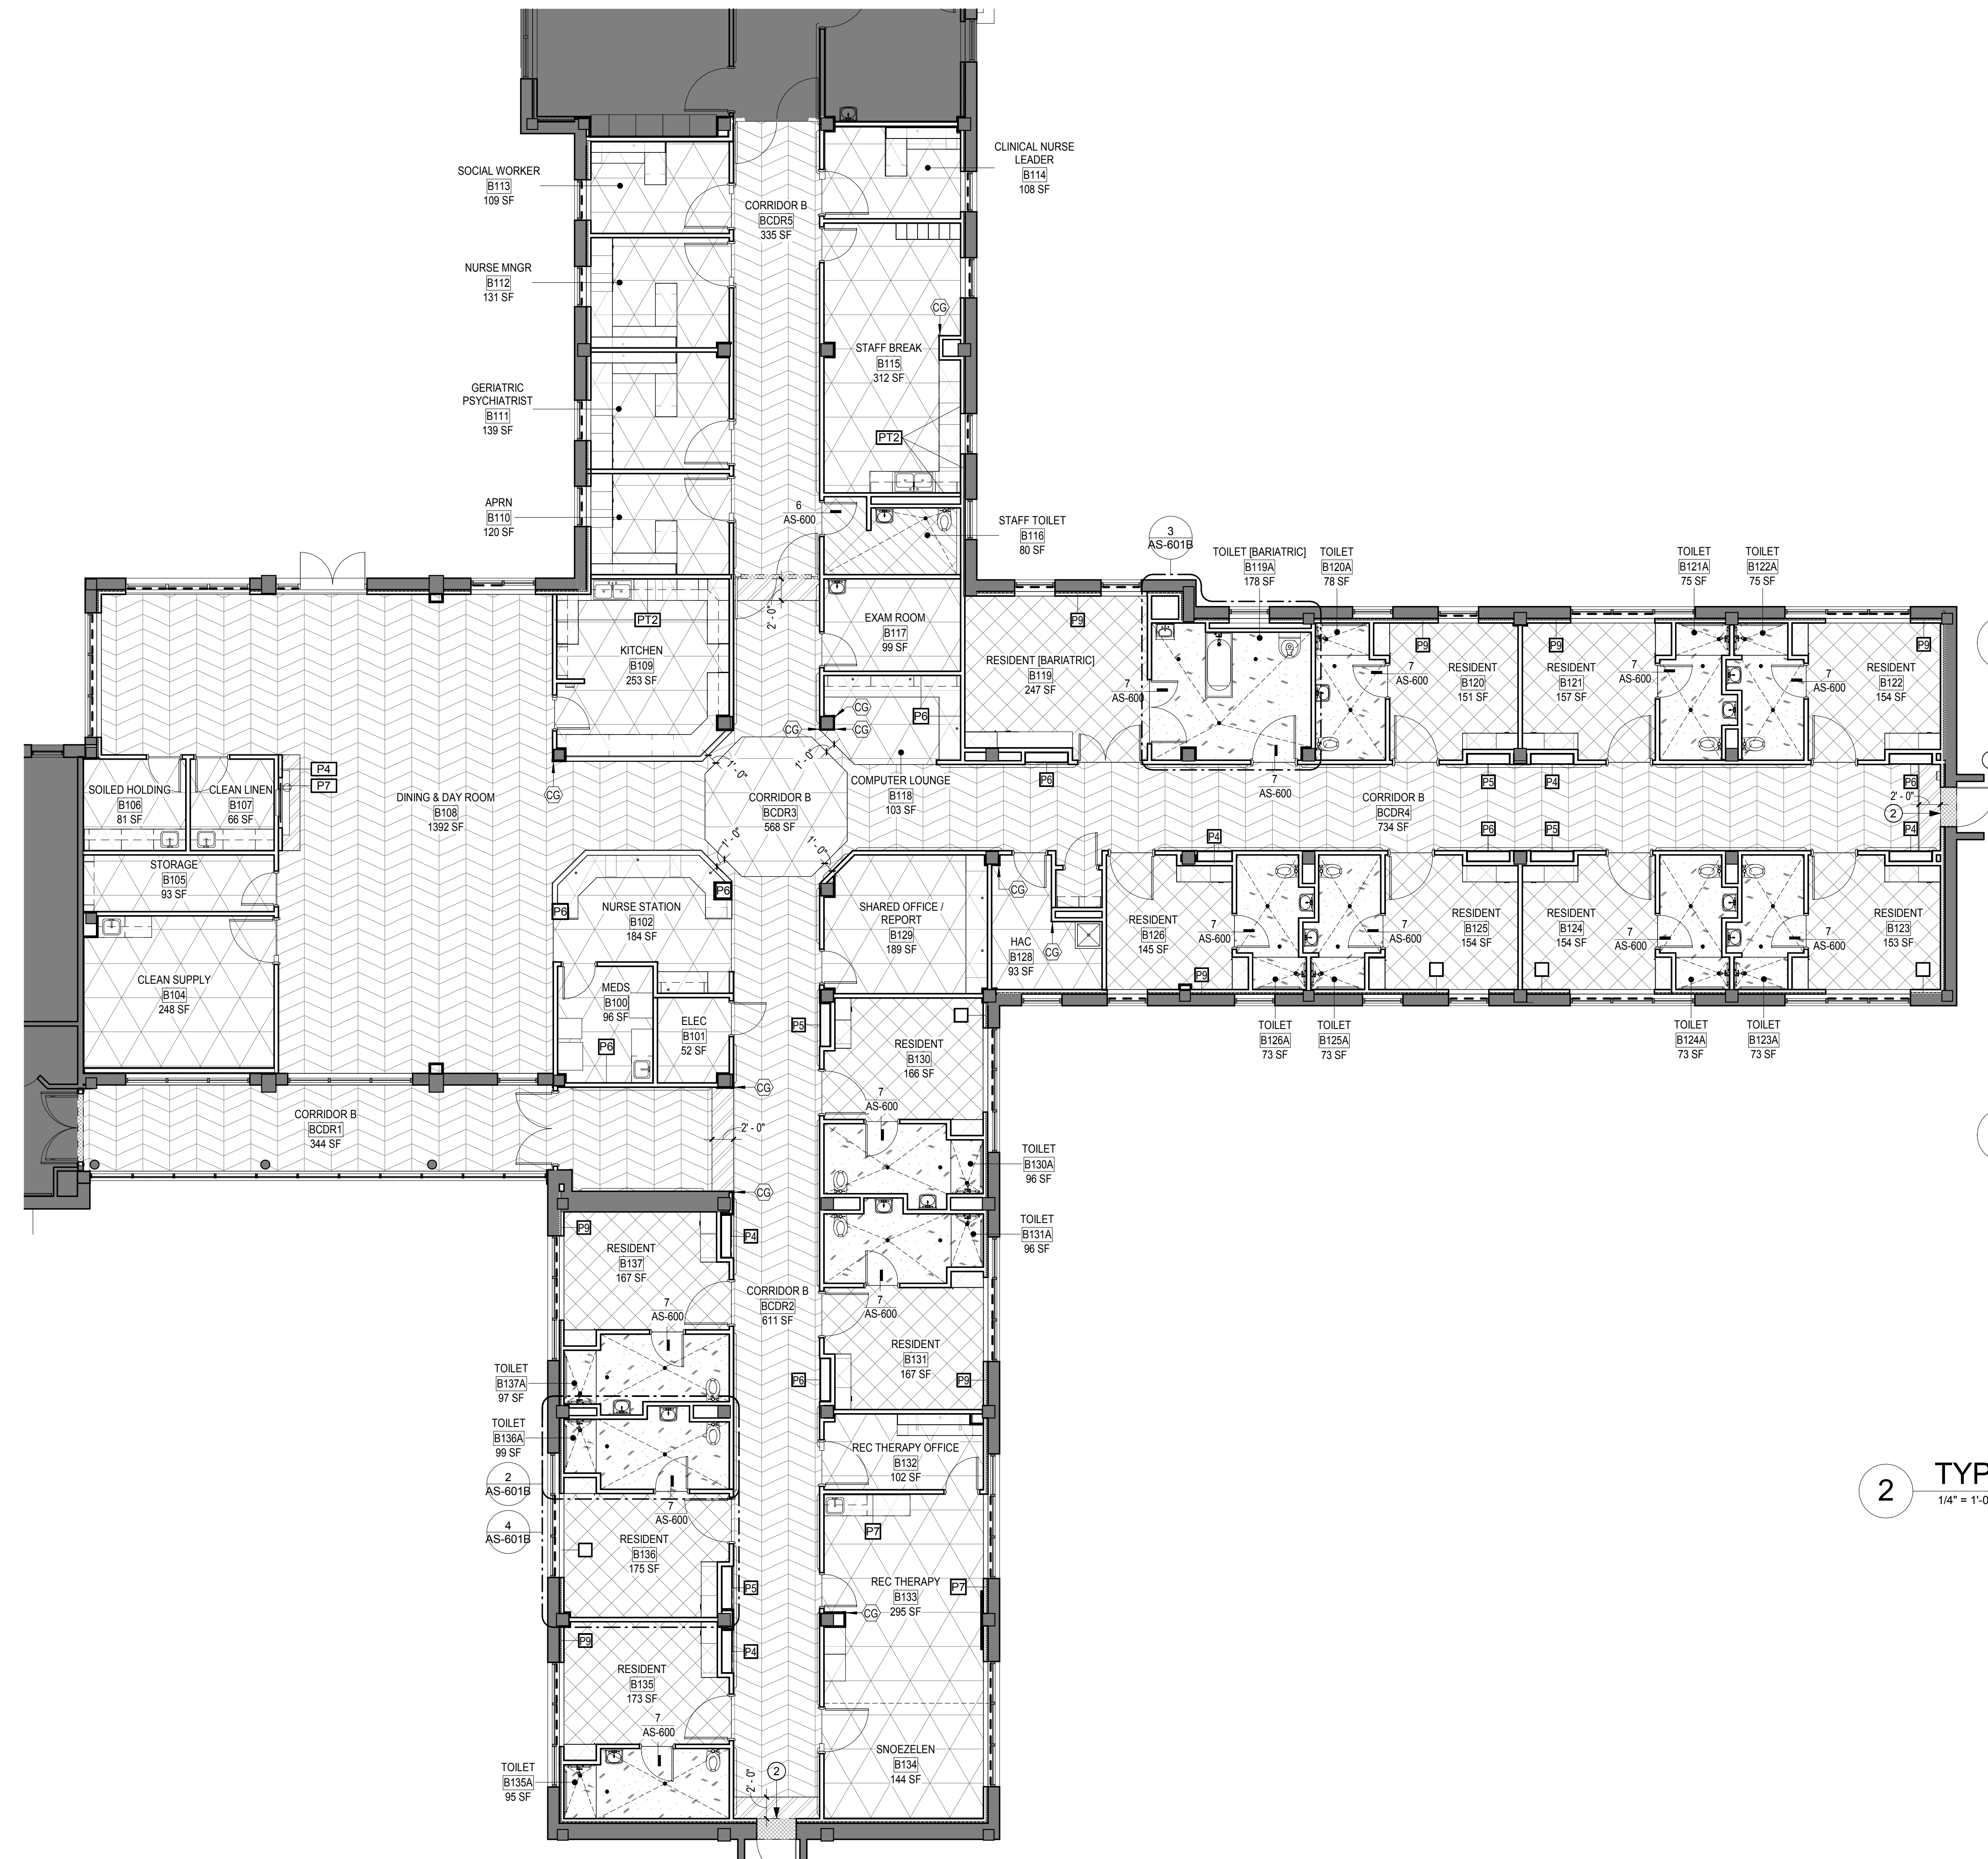


1 WING B - FINISH FLOOR PLAN
1/8" = 1'-0"

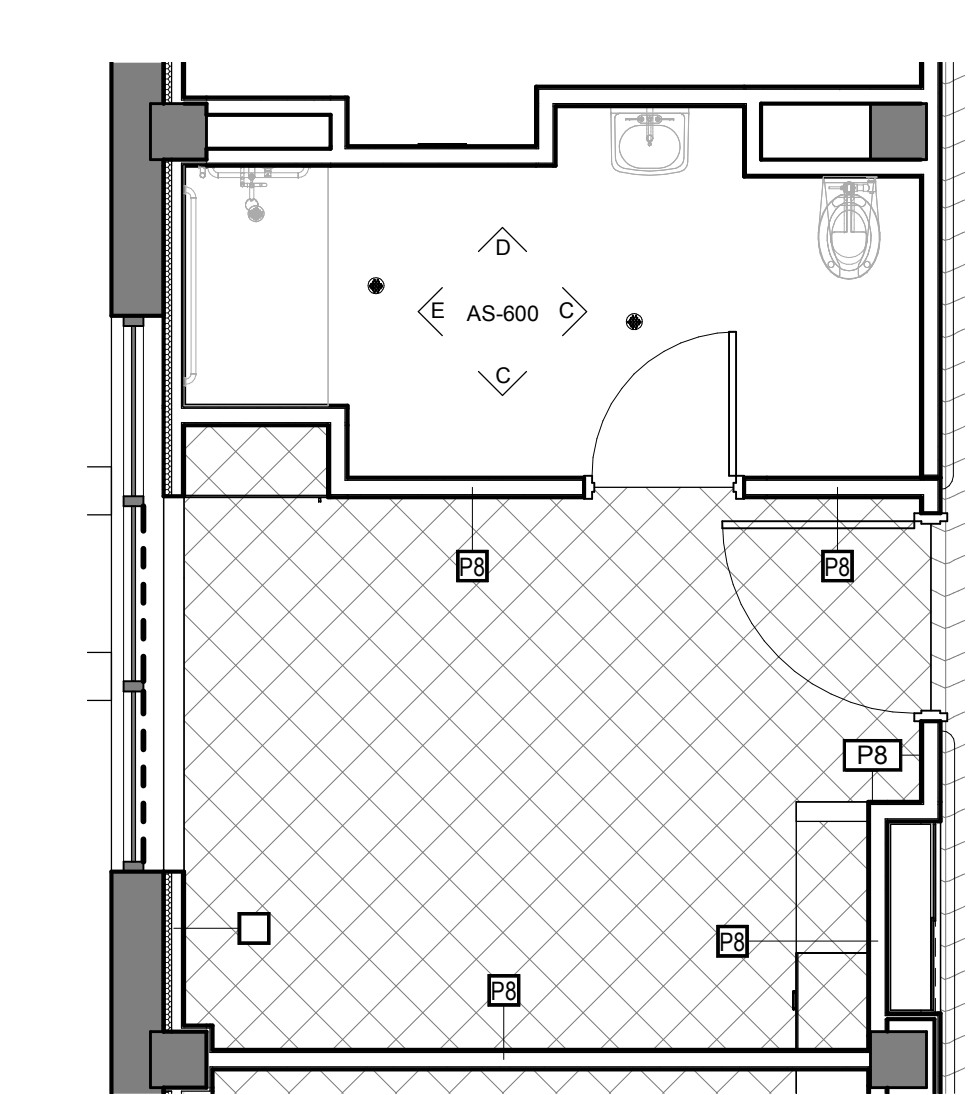

4 TYPICAL - RESIDENT ROOM FINISHES
1/4" = 1'-0"

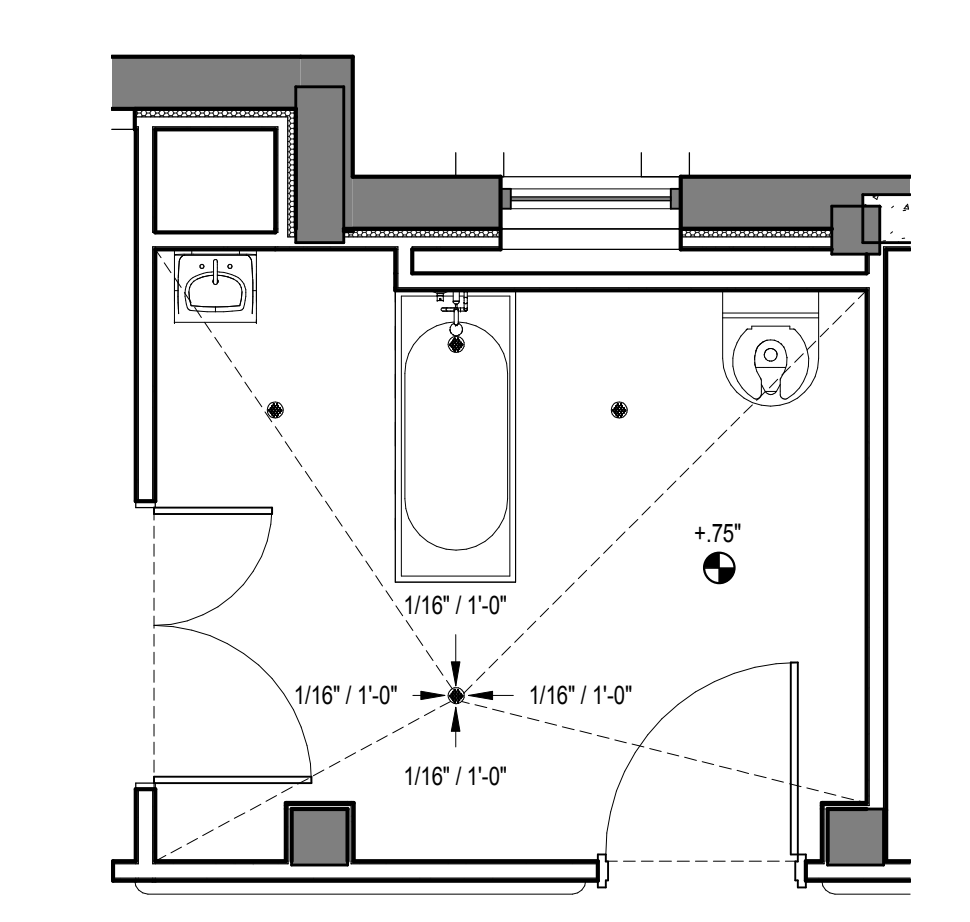

3 SLOPE CONDITION @ BARIATRIC TOILET
1/4" = 1'-0"

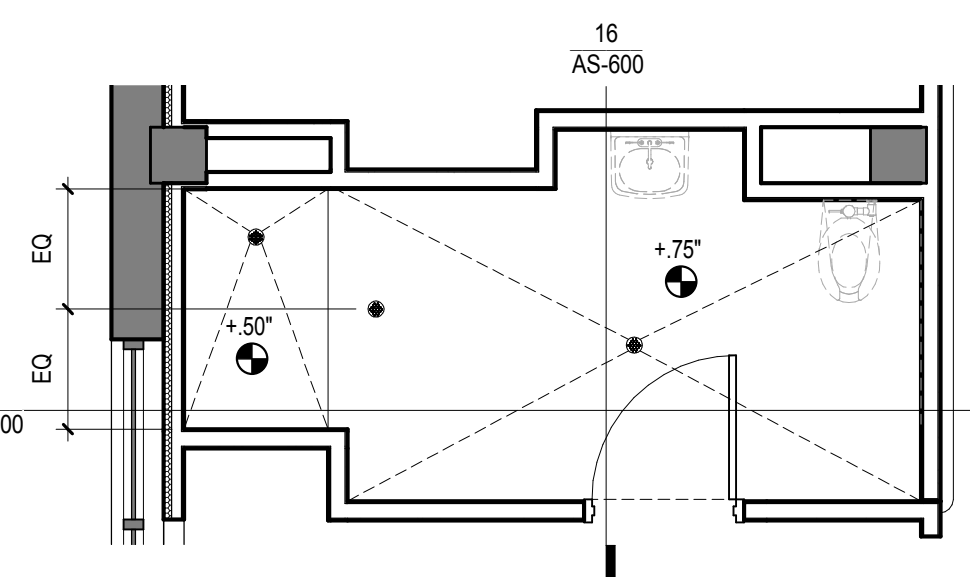

2 TYPICAL - SLOPE CONDITION @ RESIDENT TOILET
1/4" = 1'-0"


- ### GENERAL FINISH NOTES
- ALL CEILINGS TO BE PAINTED (P1) UNLESS OTHERWISE NOTED
 - ALL HOLLOW METAL DOORS AND FRAMES TO BE PAINTED (P2)
 - ALL WALLS TO BE PAINTED (P3) UNLESS OTHERWISE NOTED
 - ALL WOOD DOORS TO BE STAINED (STAIN)
 - ALL WALL BASE TO BE (PB) UNLESS OTHERWISE NOTED
 - ALL CABINETS, CABINET FILLERS, AND SHELVING TO BE PLASTIC LAMINATE ON 3/4" PLYWOOD UNLESS OTHERWISE NOTED
 - ALL COUNTERTOPS TO BE PLASTIC LAMINATE (PL), SOLID SURFACE (SS), OR QUARTZ (QTZ), AS SCHEDULED
- *REFERENCE FINISH LEGEND AND FINISH SCHEDULES
**REFERENCE ARCHITECTURAL CASEWORK LEGEND, PLANS, AND ELEVATIONS

GENERAL FINISH FLOOR PLAN LEGEND

	LV1 LUXURY VINYL TILE		SLOPE TO DRAIN
	LV2 LUXURY VINYL TILE		WALL FINISH REFERENCE INTERIOR FINISH LEGEND
	LV3 LUXURY VINYL TILE		WANDER GUARD
	LV4 LUXURY VINYL TILE		HANDRAIL / WALL GUARD FINISH (HR/WG)
	P1 PORCELAIN TILE		WINDOW SHADES FINISH (SHADES)
	P2 PORCELAIN TILE		
	WSF1 WELDED SHEET FLOORING		
	WSF2 WELDED SHEET FLOORING		
	RES RESINOUS EPOXY		
	WCPT WALK OFF CARPET TILE		
	TERR EXISTING TERRAZZO		

- ### EPOXY FLOOR NOTES
- FLOORSTONE AT AREAS OF EPOXY FLOOR FINISH ONLY - DO NOT REMOVE EXISTING MATERIAL BEYOND FINISH AREA, EXCEPT AS REQUIRED TO REPAIR EXISTING FLOOR DAMAGE.
 - FLOORSTONE MAXIMUM DEPTH 1/4" - DO NOT EXCEED THIS DEPTH.
 - REFER 13AS-600 FOR TRANSITION DETAIL BETWEEN BUILT-UP EPOXY FLOOR AND ADJACENT FLOOR FINISH MATERIAL.

- ### KEYED NOTES
- REPLACE EXISTING DOOR AND GLASS WITH 1/4" INSULATED PANEL
 - DOOR, FRAME, AND NEW INSULATED PANEL PAINT FINISH TO MATCH ADJACENT WALL PAINT FINISH AND COLOR.

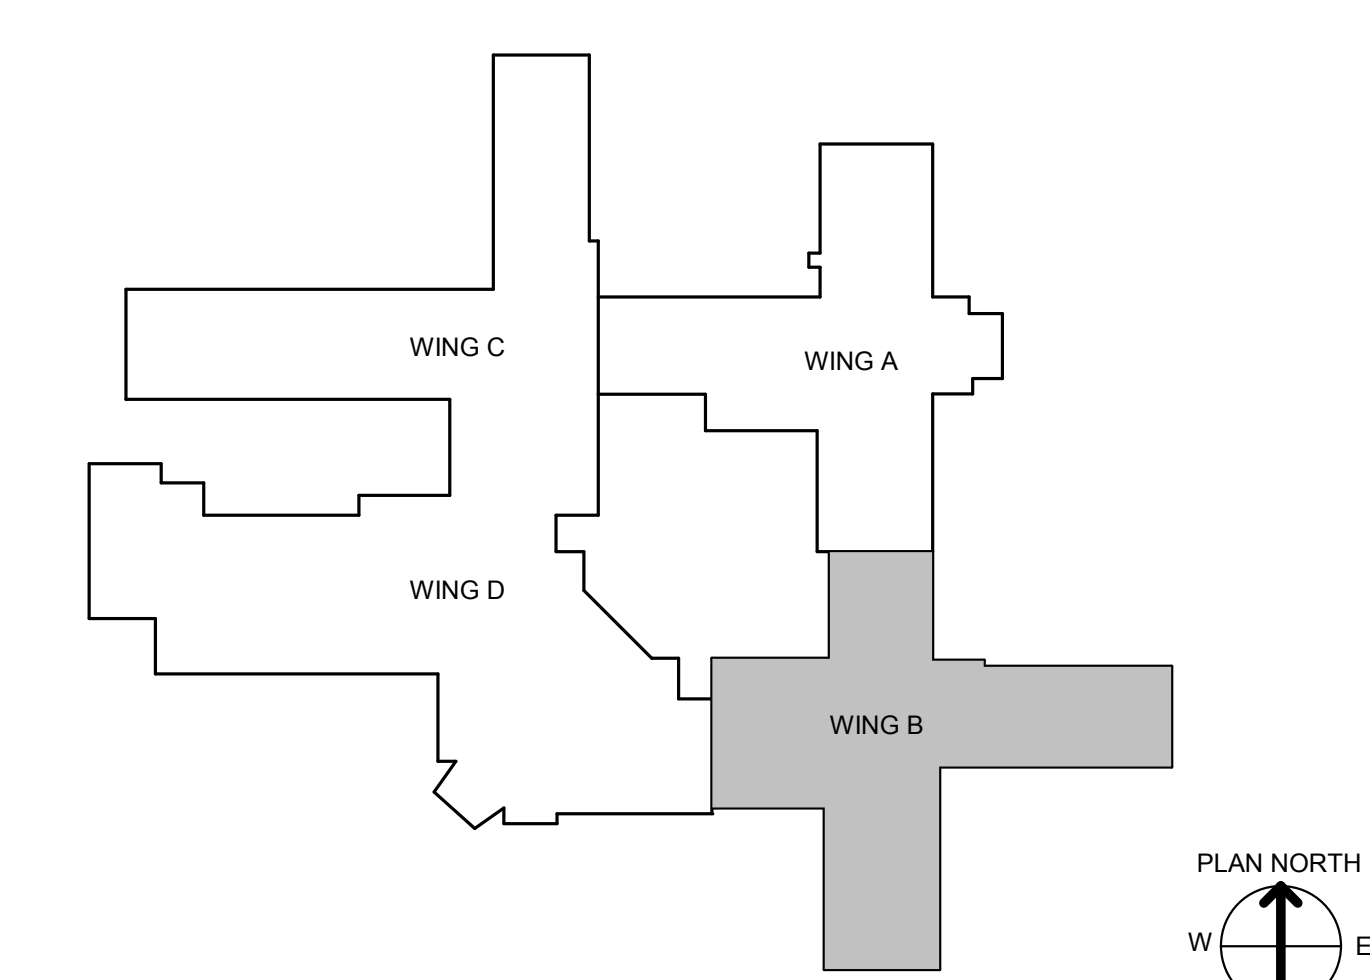

Revision #	Date

CONSULTANT INFORMATION

STRUCTURAL / CIVIL ENGINEER STAND STRUCTURAL ENGINEERING 11927 W. 112TH STREET, SUITE 200 OVERLAND PARK, KS 66210 (913) 214-2169	MECHANICAL / ELECTRICAL / PLUMBING / TECHNICAL ENGINEER SPUR DESIGN 11020 KING STREET, SUITE 350 OVERLAND PARK, KS 66210 (405) 842-6100	FIRE PROTECTION ENGINEER POOLE FIRE PROTECTION, INC. 19910 W. 161ST STREET OLATH, KS 66062 (913) 829-8650
---	--	--

ARCHITECT

312 5th Street, Overland Park, KS 66201
 11020 King Street, Suite 300, Overland Park, KS 66201
 spur-design.com

KS ARCH REG. NO. A-1139, EXP. 12/31/2019
 KS ENGR REG. NO. E-2586, EXP. 12/31/2019

Office of Construction and Facilities Management


VA U.S. Department of Veteran Affairs

SHEET TITLE WING B - FINISH PLAN
APPROVED: PROJECT DIRECTOR
PROJECT PHASE BID DOCUMENTS
FULLY SPRINKLERED

PROJECT TITLE RENOVATE A & B WING BUILDING 6	VA PROJECT NUMBER 589A5-19-116
PROJECT LOCATION 2200 SW GAGE BLVD. TOPEKA, KS 66622	BUILDING NUMBER 6
DATE 07/10/2019	DRAWING NUMBER 6-AS-601B
CHECKED BY AWM	Dwg. 30 OF 160
DRAWN BY JET	



1 WING A - SIGNAGE
1/8" = 1'-0"

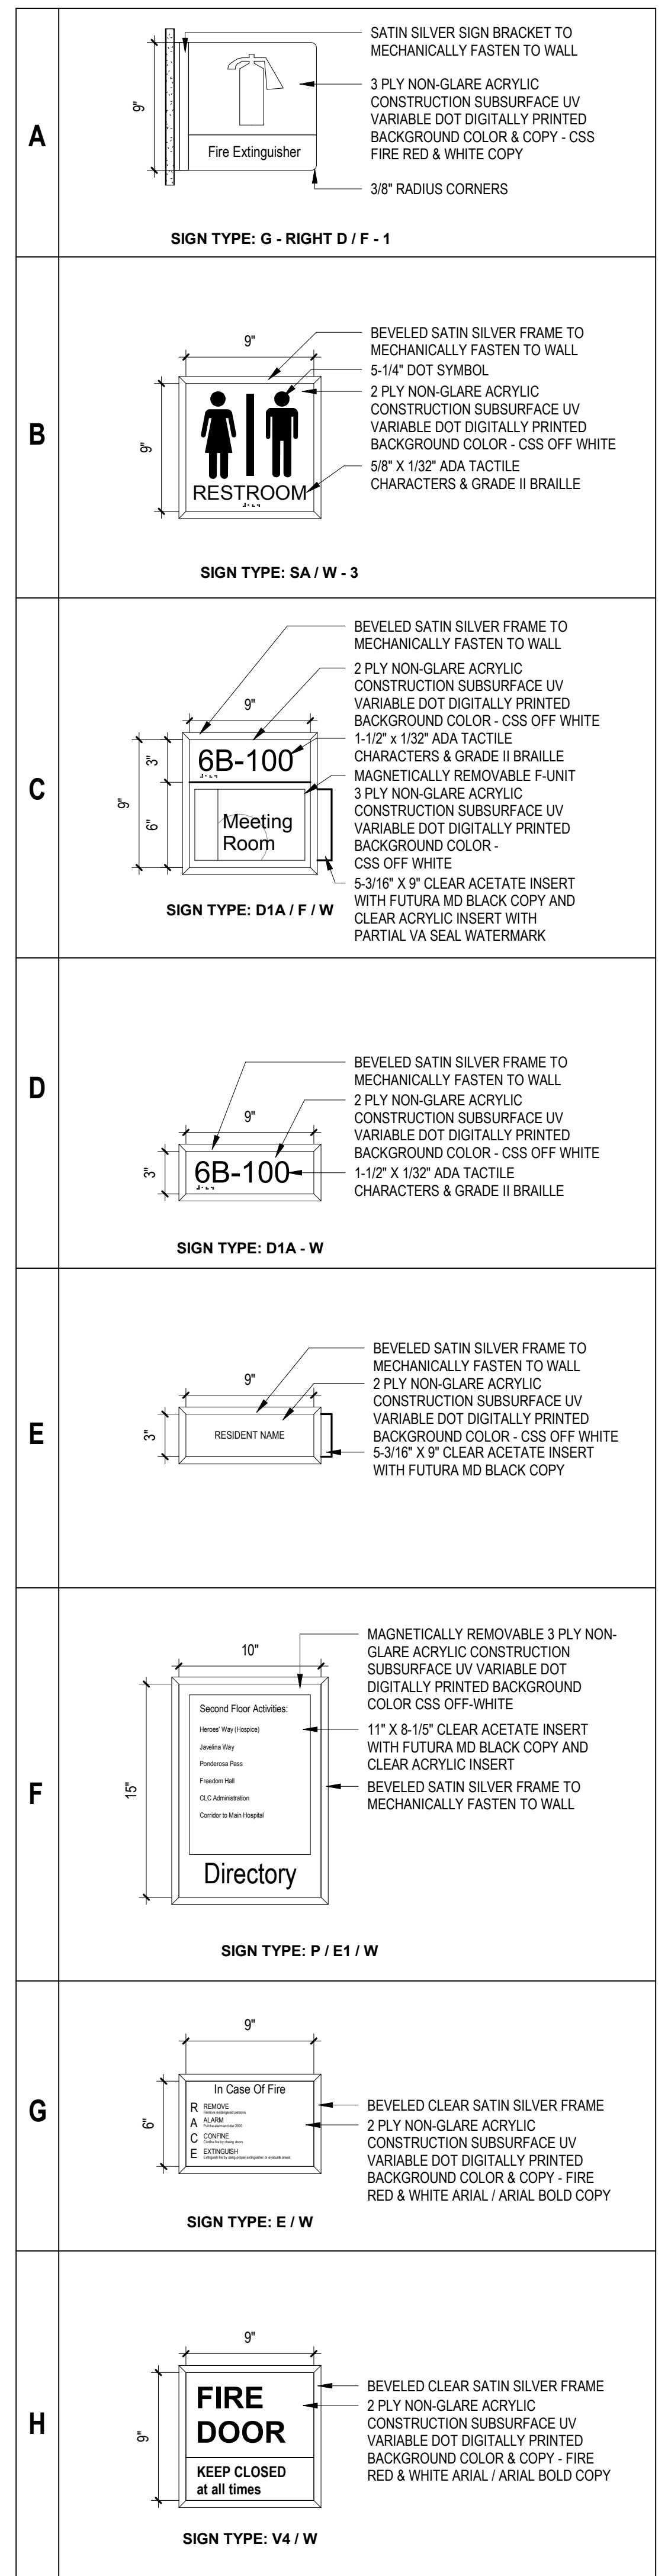

SIGNAGE NOTES


COMPLY WITH ADA AND CODE PROVISIONS AS ADOPTED BY AUTHORITIES HAVING JURISDICTION.

- ALL SIGNS LOCATED NEXT TO A DOOR WILL BE HUNG 9" FROM THE STRIKE SIDE OF THE DOOR FRAME.
- TACTILE CHARACTERS ON SIGNS SHALL BE LOCATED 48" MINIMUM ABOVE THE FINISHED FLOOR, MEASURED FROM THE BASELINE OF THE LOWEST TACTILE CHARACTER AND 80" MAXIMUM ABOVE THE FINISHED FLOOR, MEASURED FROM THE BASELINE OF THE HIGHEST TACTILE CHARACTER.
- VERIFY ROOM NUMBERS AND COPY WITH VA BEFORE SIGN PRODUCTION.

LOCATION INDICATOR
XXX
REFERENCE NUMBER


SIGNAGE SCHEDULE

REFERENCE NUMBER	SIGN TYPE REFERENCE	REFERENCE NUMBER	SIGN TYPE REFERENCE	REFERENCE NUMBER	SIGN TYPE REFERENCE
A101	F	A115	C	A131	C
A102	B	A116	C	A132	C
A103	C	A117	C	A133	B
A104	D	A118	C	A134	C
A105	B	A119	C	A135	C
A106	B	A120	D	A136	C
A107	C	A121	C	A137	C
A108	C	A122	C	A138	C
A109	C	A123	C	A139	D
A110	C	A124	C	A-E1	H
A110.1	C	A125	C	A-E2	A
A110.2	C	A126	C	A-E3	A
A111	D	A127	D	A-E4	G
A112	D	A128	D	A-E5	G
A113	D	A129	C	A-E6	G
A114	D	A130	C		

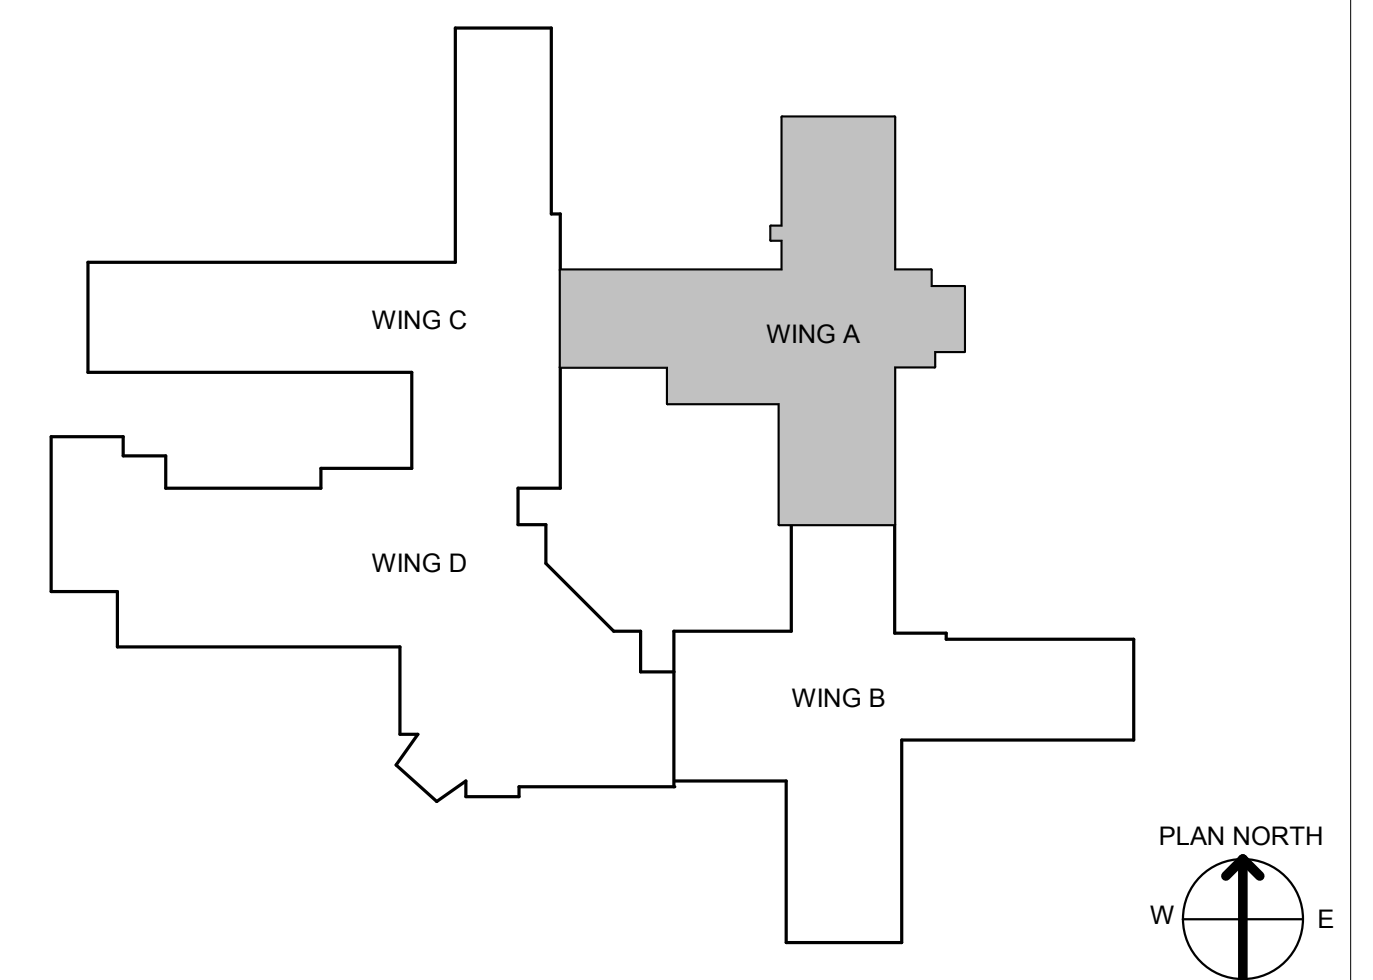


CONSULTANT INFORMATION STRUCTURAL / CIVIL ENGINEER: STAND STRUCTURAL ENGINEERING, 11827 W. 112TH STREET, SUITE 200, OVERLAND PARK, KS 66210 (913) 214-2169 MECHANICAL / ELECTRICAL / PLUMBING / TECHNICAL ENGINEER: SPUR DESIGN, 11020 KING STREET, SUITE 350, OVERLAND PARK, KS 66210 (405) 842-6100 FIRE PROTECTION ENGINEER: POOLE FIRE PROTECTION, INC., 19910 W. 161ST STREET, OLATH, KS 66062 (913) 829-8650		ARCHITECT 513 5th Street, Overland Park, KS 66209 10020 King Street, Suite 300, Overland Park, KS 66209 KS ARCH REG. NO. A-1139, EXP. 12/31/2019 KS ENGR REG. NO. E-2586, EXP. 12/31/2019		Office of Construction and Facilities Management VA U.S. Department of Veteran Affairs		SHEET TITLE: WING A - SIGNAGE PLAN APPROVED: PROJECT DIRECTOR		PROJECT PHASE: BID DOCUMENTS FULLY SPRINKLERED		PROJECT TITLE: RENOVATE A & B WING BUILDING 6 PROJECT LOCATION: 2200 SW GAGE BLVD., TOPEKA, KS 66622 DATE: 07/10/2019 CHECKED BY: AWM DRAWN BY: JET		VA PROJECT NUMBER: 589A5-19-116 BUILDING NUMBER: 6 DRAWING NUMBER: 6-AS-602A Dwg. 31 OF 160	
--	--	--	--	--	--	--	--	---	--	---	--	--	--


A
B
C
D
E
F

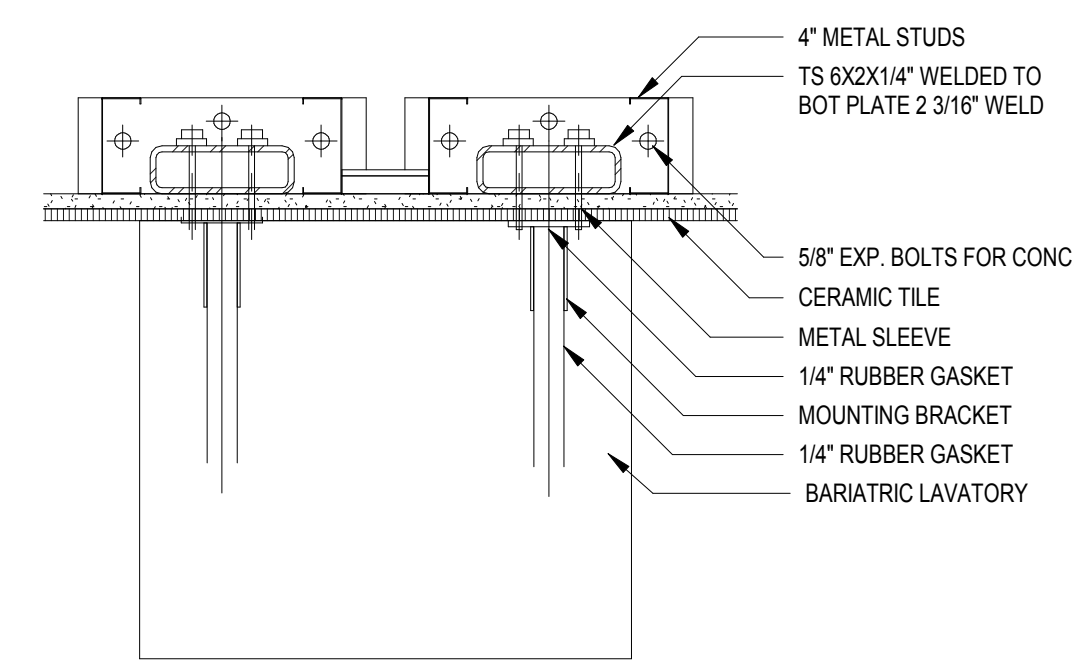


8 PLAN - BARIATRIC SINK SUPPORT
1 1/2" = 1'-0"

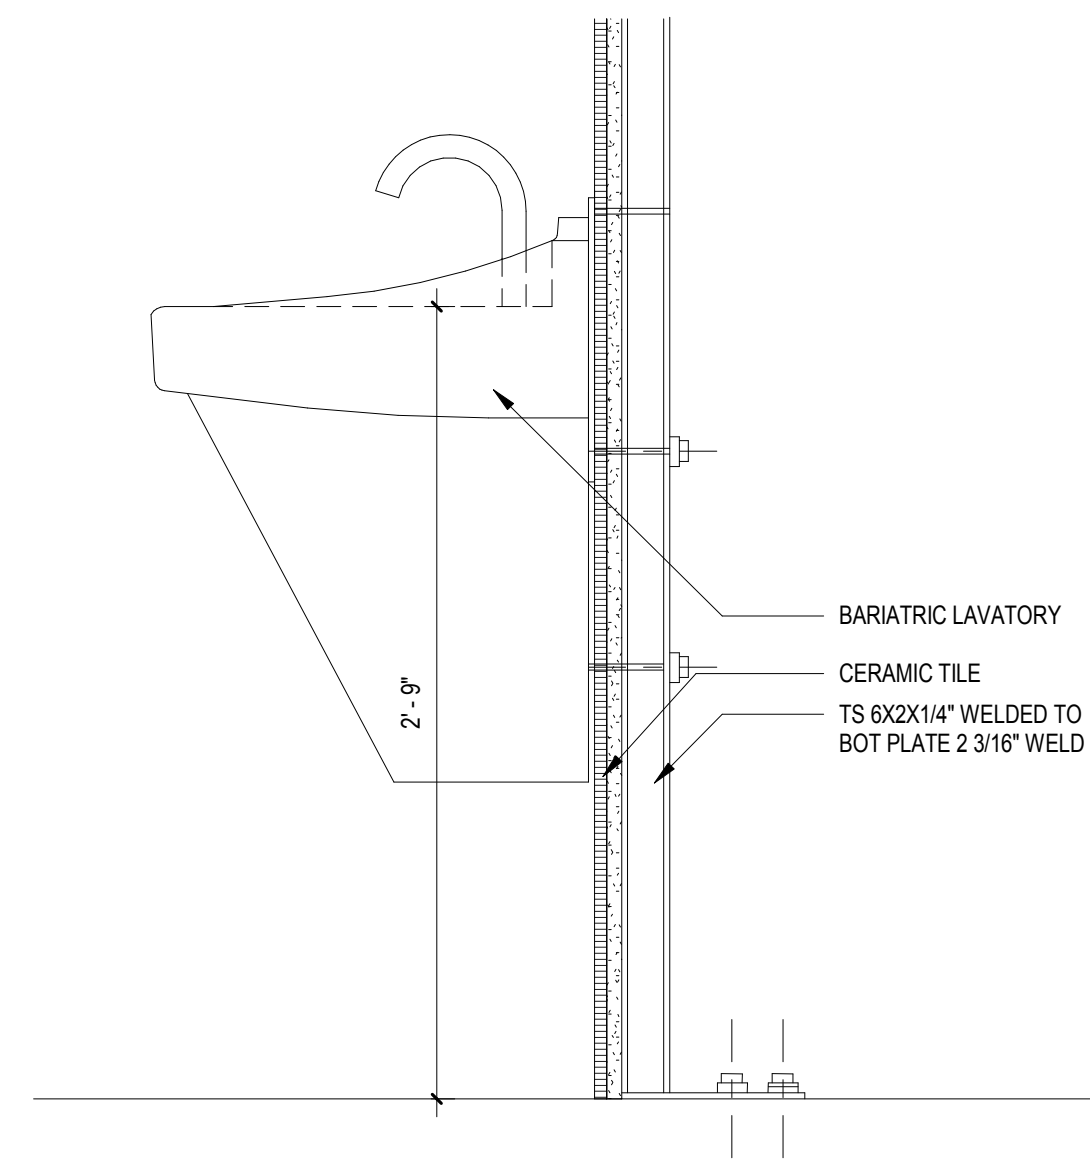


7 ELEVATION - BARIATRIC SINK SUPPORT
1 1/2" = 1'-0"

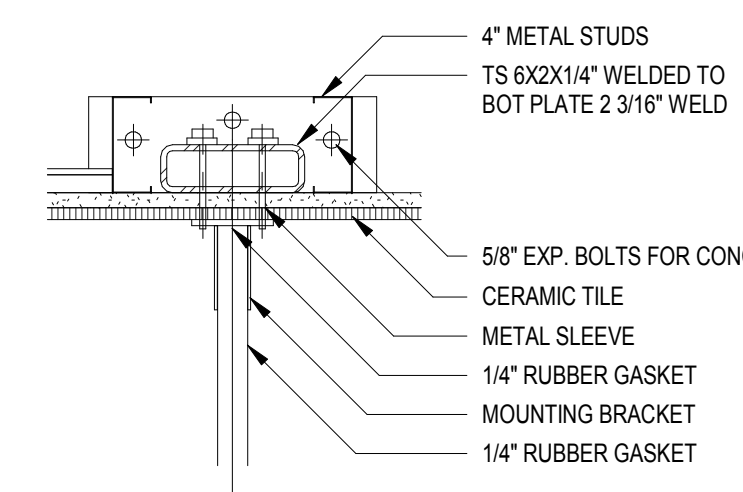


6 PLAN - GRAB BAR SUPPORT
1 1/2" = 1'-0"

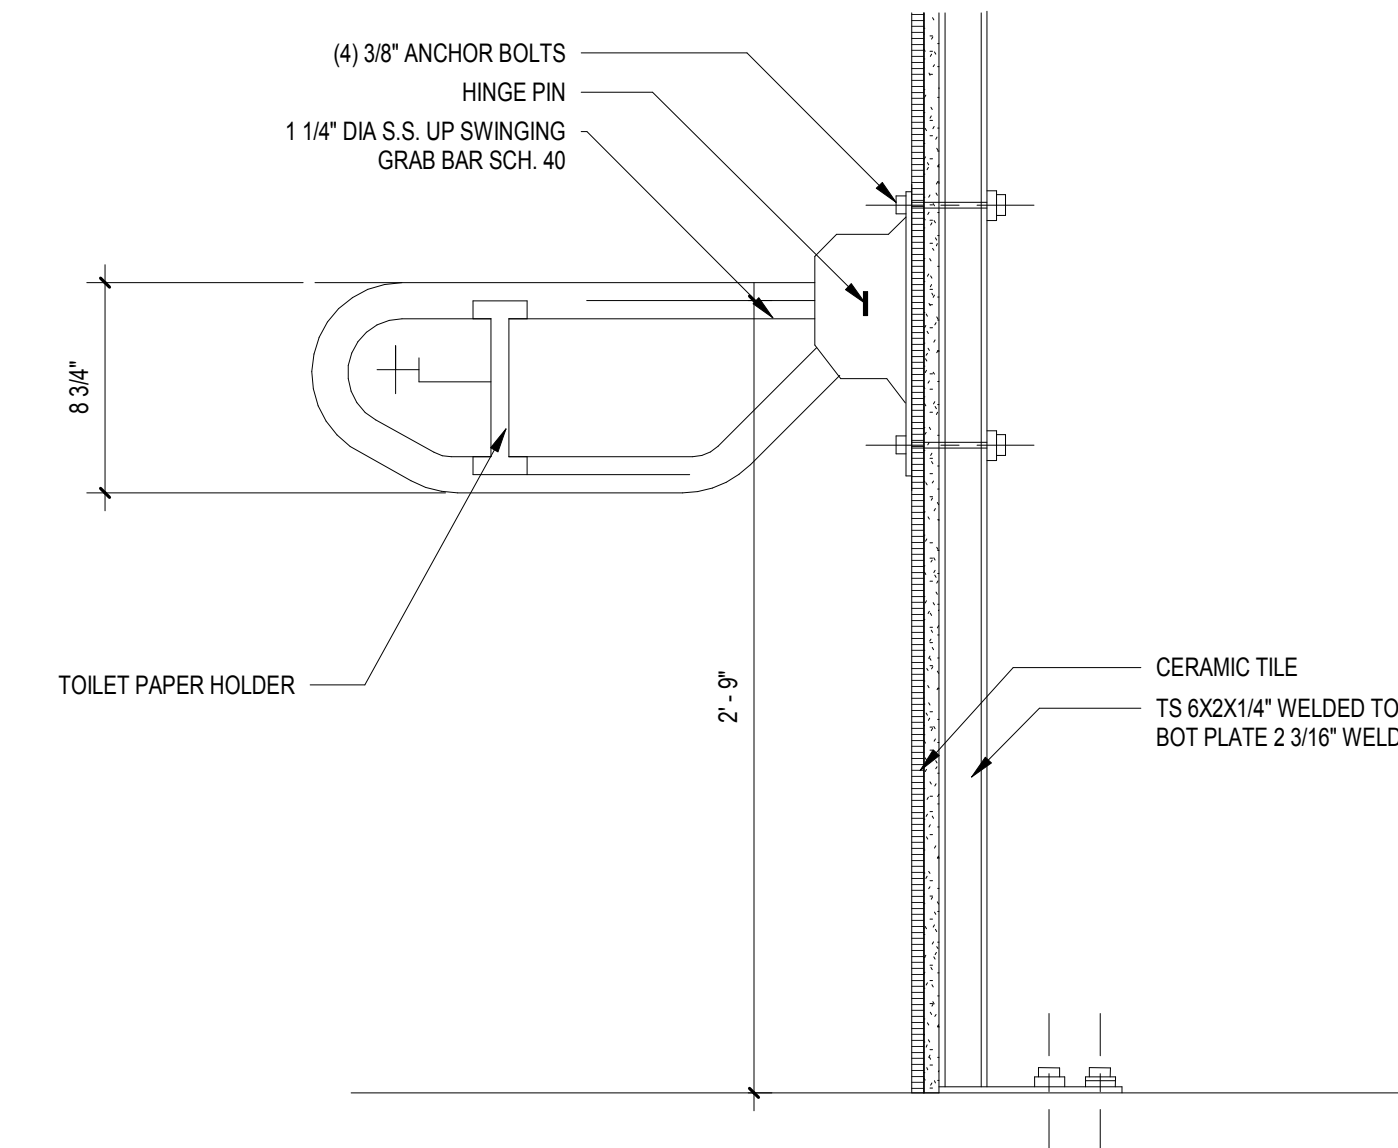


5 ELEVATION - GRAB BAR SUPPORT
1 1/2" = 1'-0"

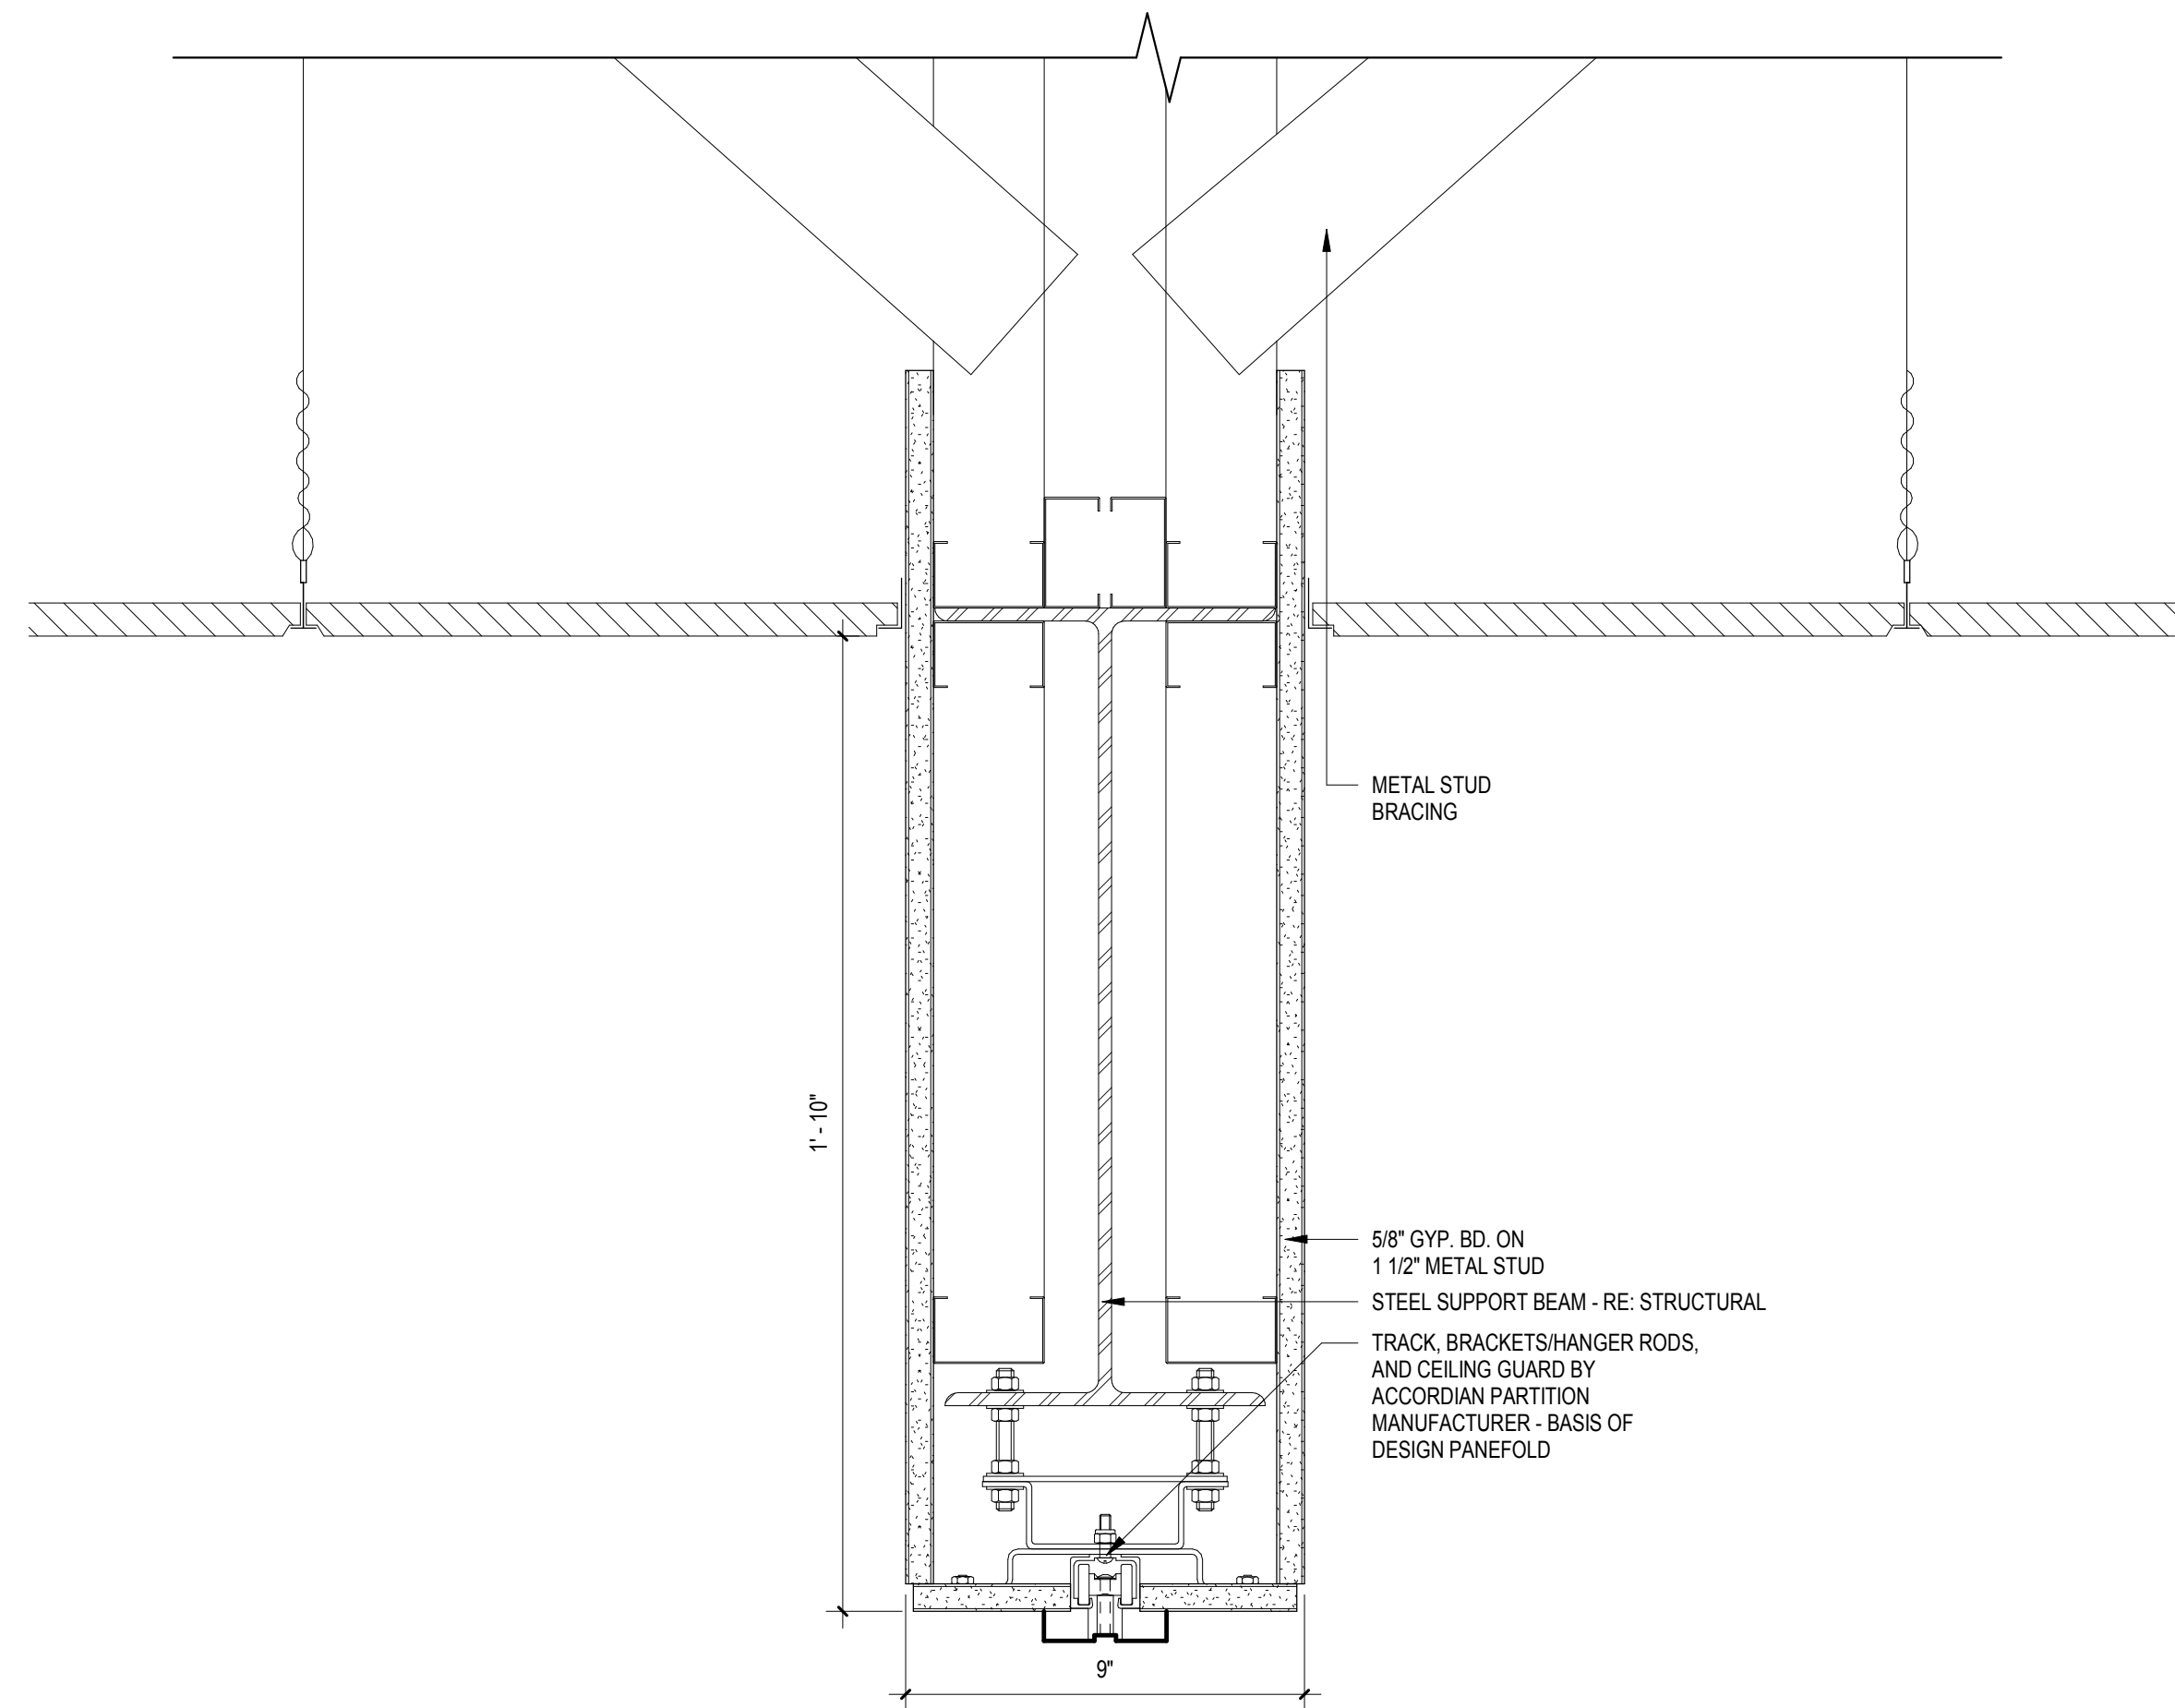


4 SECTION DETAIL - ACCORDION WALL SUPPORT
3" = 1'-0"

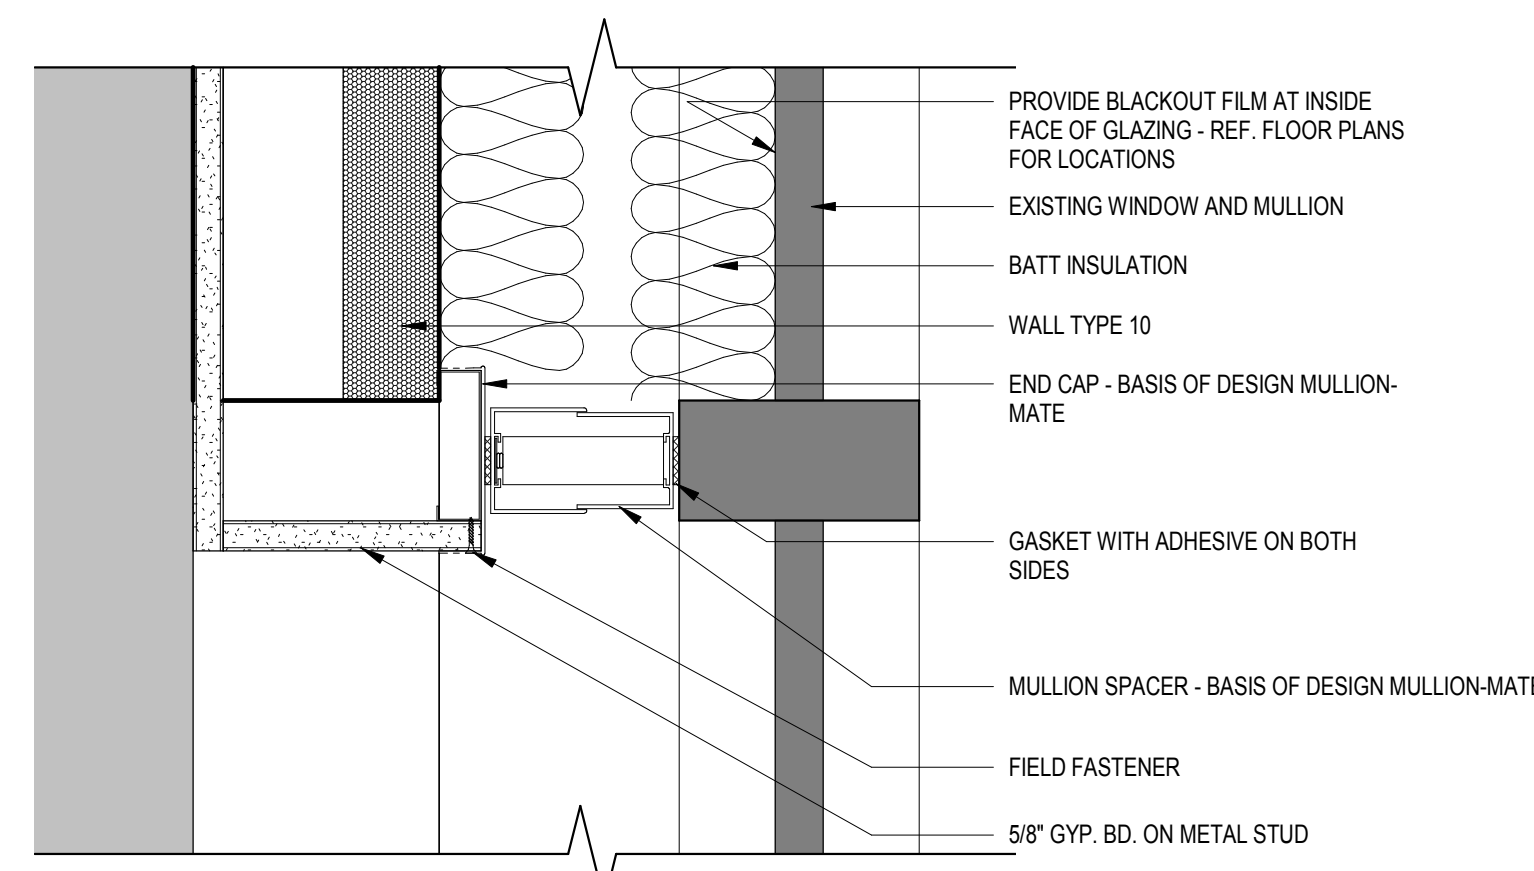

3 PLAN DETAIL - FRAMING OVER EXISTING WINDOW
3" = 1'-0"

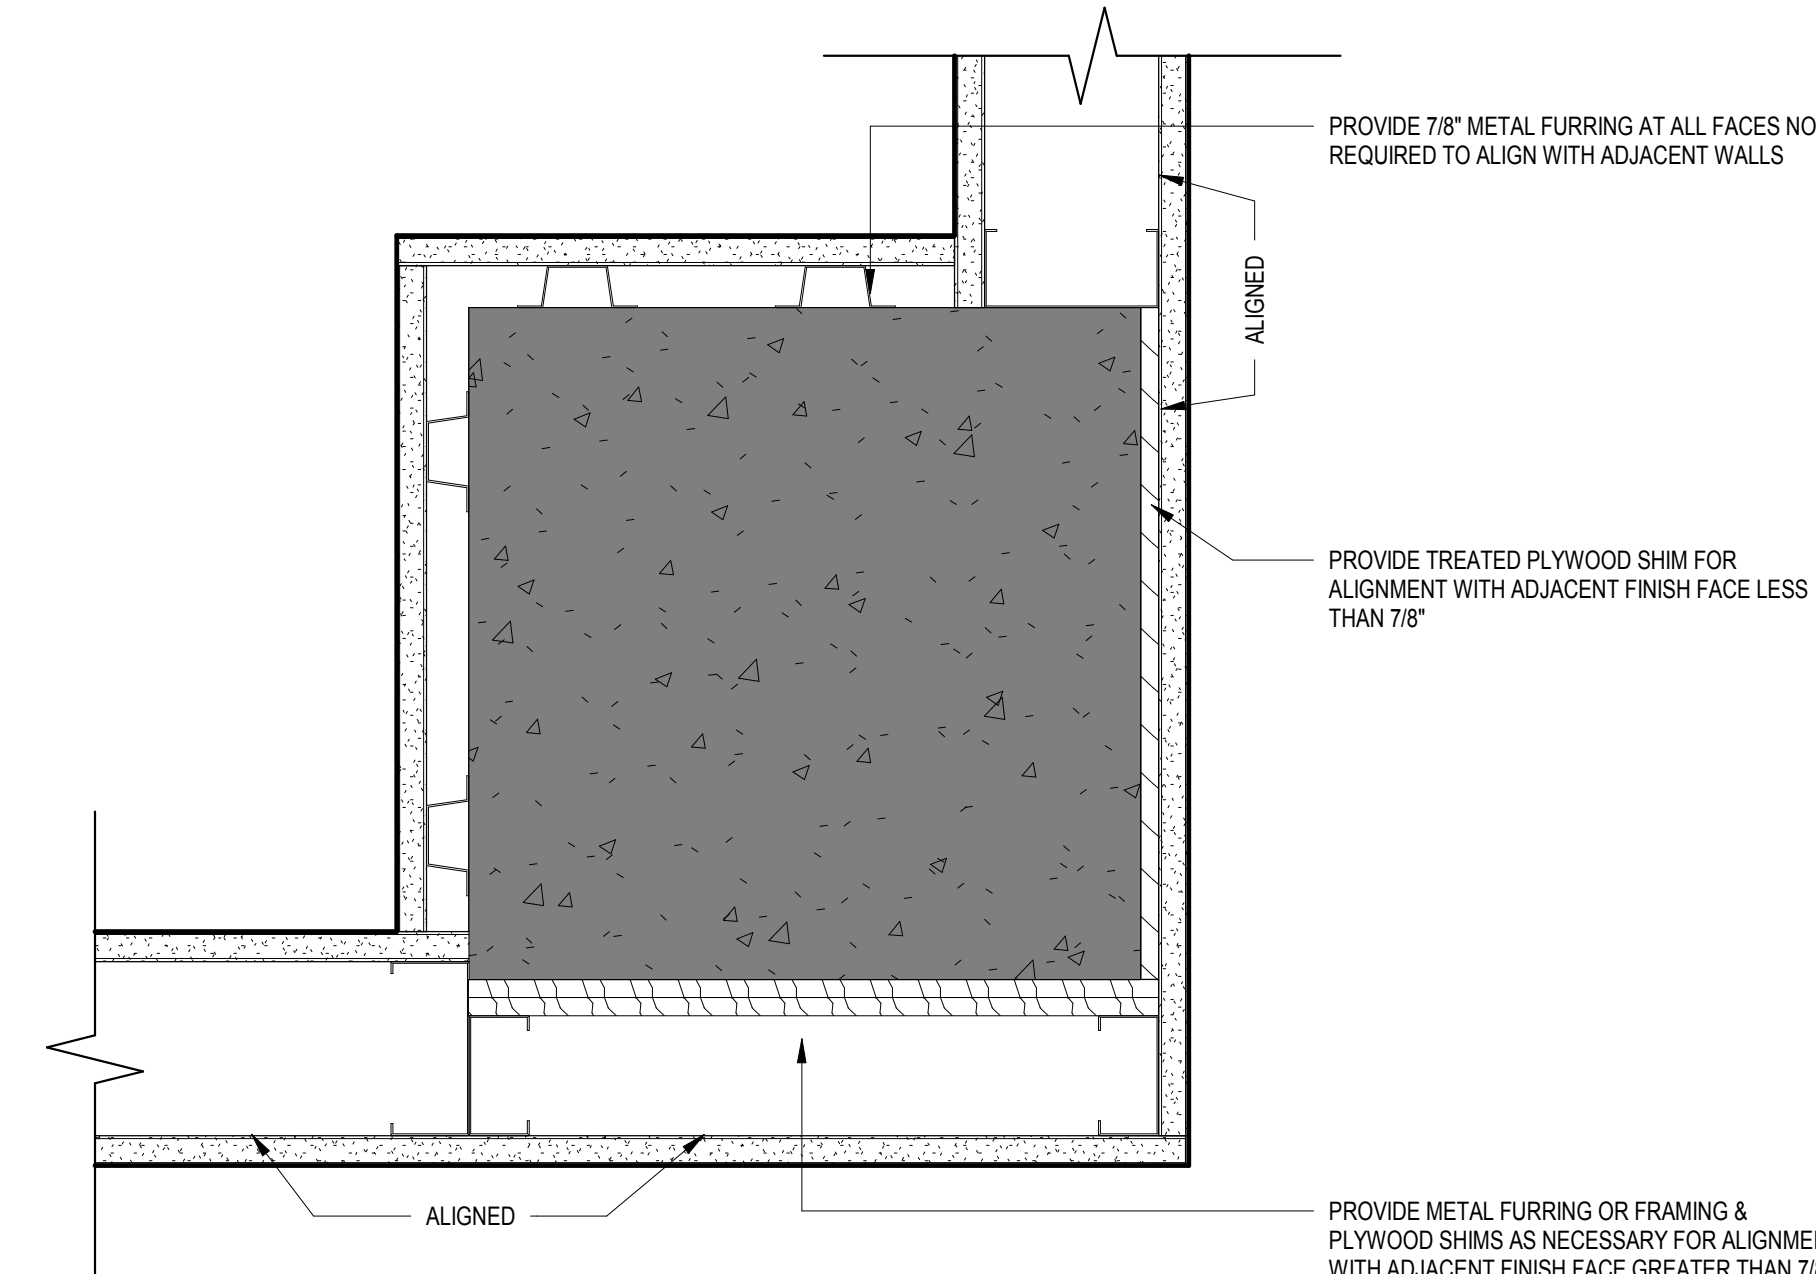

2 PLAN DETAIL - COLUMN
3" = 1'-0"

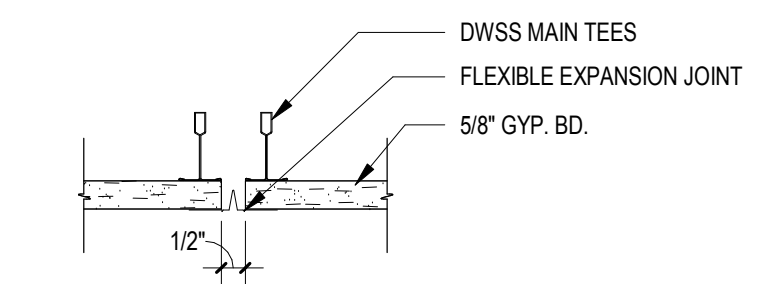

1 SECTION DETAIL - EXPANSION JOINT
3" = 1'-0"



CONSULTANT INFORMATION STRUCTURAL / CIVIL ENGINEER: STAND STRUCTURAL ENGINEERING, 11927 W. 112TH STREET, SUITE 200, OVERLAND PARK, KS 66210 (913) 214-2169 MECHANICAL / ELECTRICAL / PLUMBING / TECHNICAL ENGINEER: SPUR DESIGN, 11020 KING STREET, SUITE 350, OVERLAND PARK, KS 66210 (405) 842-6100 FIRE PROTECTION ENGINEER: POOLE FIRE PROTECTION, INC., 19910 W. 161ST STREET, OLATH, KS 66062 (913) 829-8660		ARCHITECT 513 5th Street, Overland Park, KS 66109 10020 King Street, Suite 300, Overland Park, KS 66109 KS ARCH REG. NO. A-1139, EXP. 12/31/2019 KS ENGR REG. NO. E-2586, EXP. 12/31/2019		Office of Construction and Facilities Management VA U.S. Department of Veteran Affairs		SHEET TITLE: PLAN & SECTION DETAILS APPROVED: PROJECT DIRECTOR		PROJECT PHASE: BID DOCUMENTS FULLY SPRINKLERED		PROJECT TITLE: RENOVATE A & B WING BUILDING 6 PROJECT LOCATION: 2200 SW GAGE BLVD., TOPEKA, KS 66622 DATE: 07/10/2019 CHECKED BY: AWM DRAWN BY: JET		VA PROJECT NUMBER: 589A5-19-116 BUILDING NUMBER: 6 DRAWING NUMBER: 6-AS-700 Dwg. 33 OF 160	
--	--	--	--	--	--	---	--	---	--	---	--	---	--

ARCHITECTURAL CASEWORK NOTES

1. ALL CABINETS, CABINET FILLERS, AND SHELVING TO BE PLASTIC LAMINATE, FINISH AS SCHEDULED!
 2. COUNTERTOPS TO BE PLASTIC LAMINATE (PL3), SOLID SURFACE (SS), OR QUARTZ (QTZ), FINISH AS SCHEDULED!
 3. GENERAL CONTRACTOR TO PROVIDE METAL SUPPORT BLOCKING FOR BUILT-INS AS REQUIRED
 4. SUPPORT BRACKETS TO BE PLACED AT ALL OPEN COUNTERTOPS. MAXIMUM SPACING BETWEEN BRACKETS NOT TO EXCEED 24" ON CENTER. REFER TO BRACKET MANUFACTURER REQUIREMENTS.
- *REFERENCE ARCHITECTURAL CASEWORK SCHEDULE, ARCHITECTURAL CASEWORK ENLARGED PLANS AND ELEVATIONS, & MATERIAL LEGEND.

ARCHITECTURAL CASEWORK SCHEDULE

MARK	CASEWORK	MATERIAL	FINISH / COMMENTS
C1	CASEWORK BASE CABINET	PLASTIC LAMINATE	PL1
C2	CASEWORK UPPER CABINET	PLASTIC LAMINATE	PL2
C3	CASEWORK TALL CABINET	PLASTIC LAMINATE	PL2
C4	CASEWORK TALL CABINET	PLASTIC LAMINATE	PL2
C5	CASEWORK TALL CABINET	PLASTIC LAMINATE	PL2
C6	CASEWORK TALL CABINET	PLASTIC LAMINATE	PL2
C7	CASEWORK TALL CABINET	PLASTIC LAMINATE	PL2
C8	CASEWORK TALL CABINET	PLASTIC LAMINATE	PL2
C9	CASEWORK TALL CABINET	PLASTIC LAMINATE	PL2
C10	CASEWORK COUNTERTOP	PLASTIC LAMINATE	PL1
C11	CASEWORK COUNTERTOP	SOLID SURFACE	SS
C12	CASEWORK COUNTERTOP	PLASTIC LAMINATE	PL3
C13	CASEWORK COUNTERTOP	QUARTZ	QTZ
C14	CASEWORK RESIDENT DESK	PLASTIC LAMINATE	COUNTER - PL3, CABINETS - PL1
C15	CASEWORK RESIDENT DESK BARIATRIC	PLASTIC LAMINATE	COUNTER - PL3, CABINETS - PL1
C16	CASEWORK RESIDENT WARDROBE	PLASTIC LAMINATE	PL1
C17	CASEWORK SHADOW BOX	PLASTIC LAMINATE & PLEXIGLASS	PL1, PLEXIGLASS
C18	PREMANUFACTURED FIREPLACE MANTEL	WOOD, PRIMED TO PAINT	PT

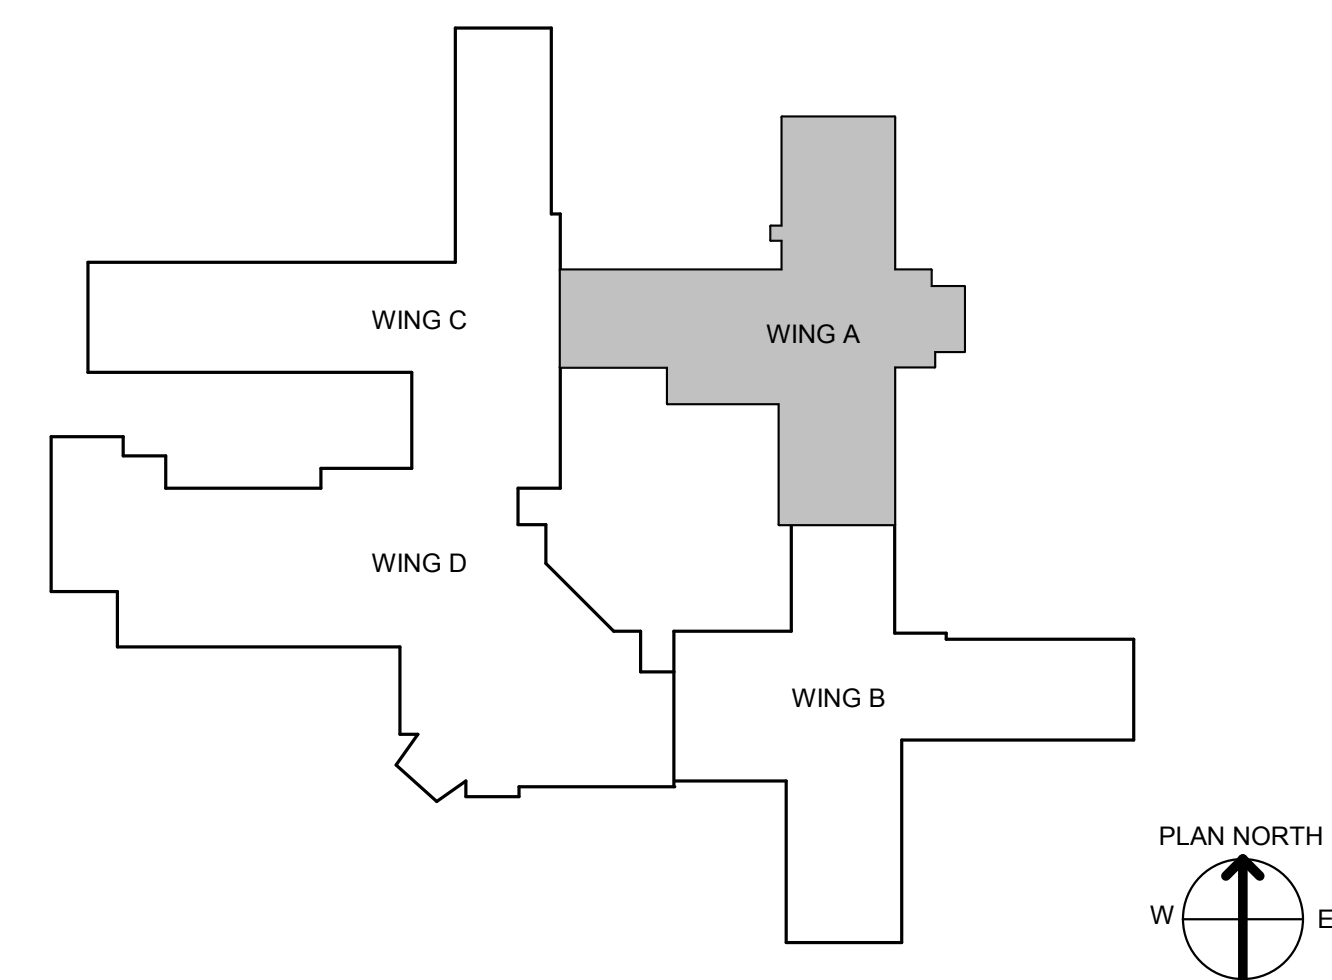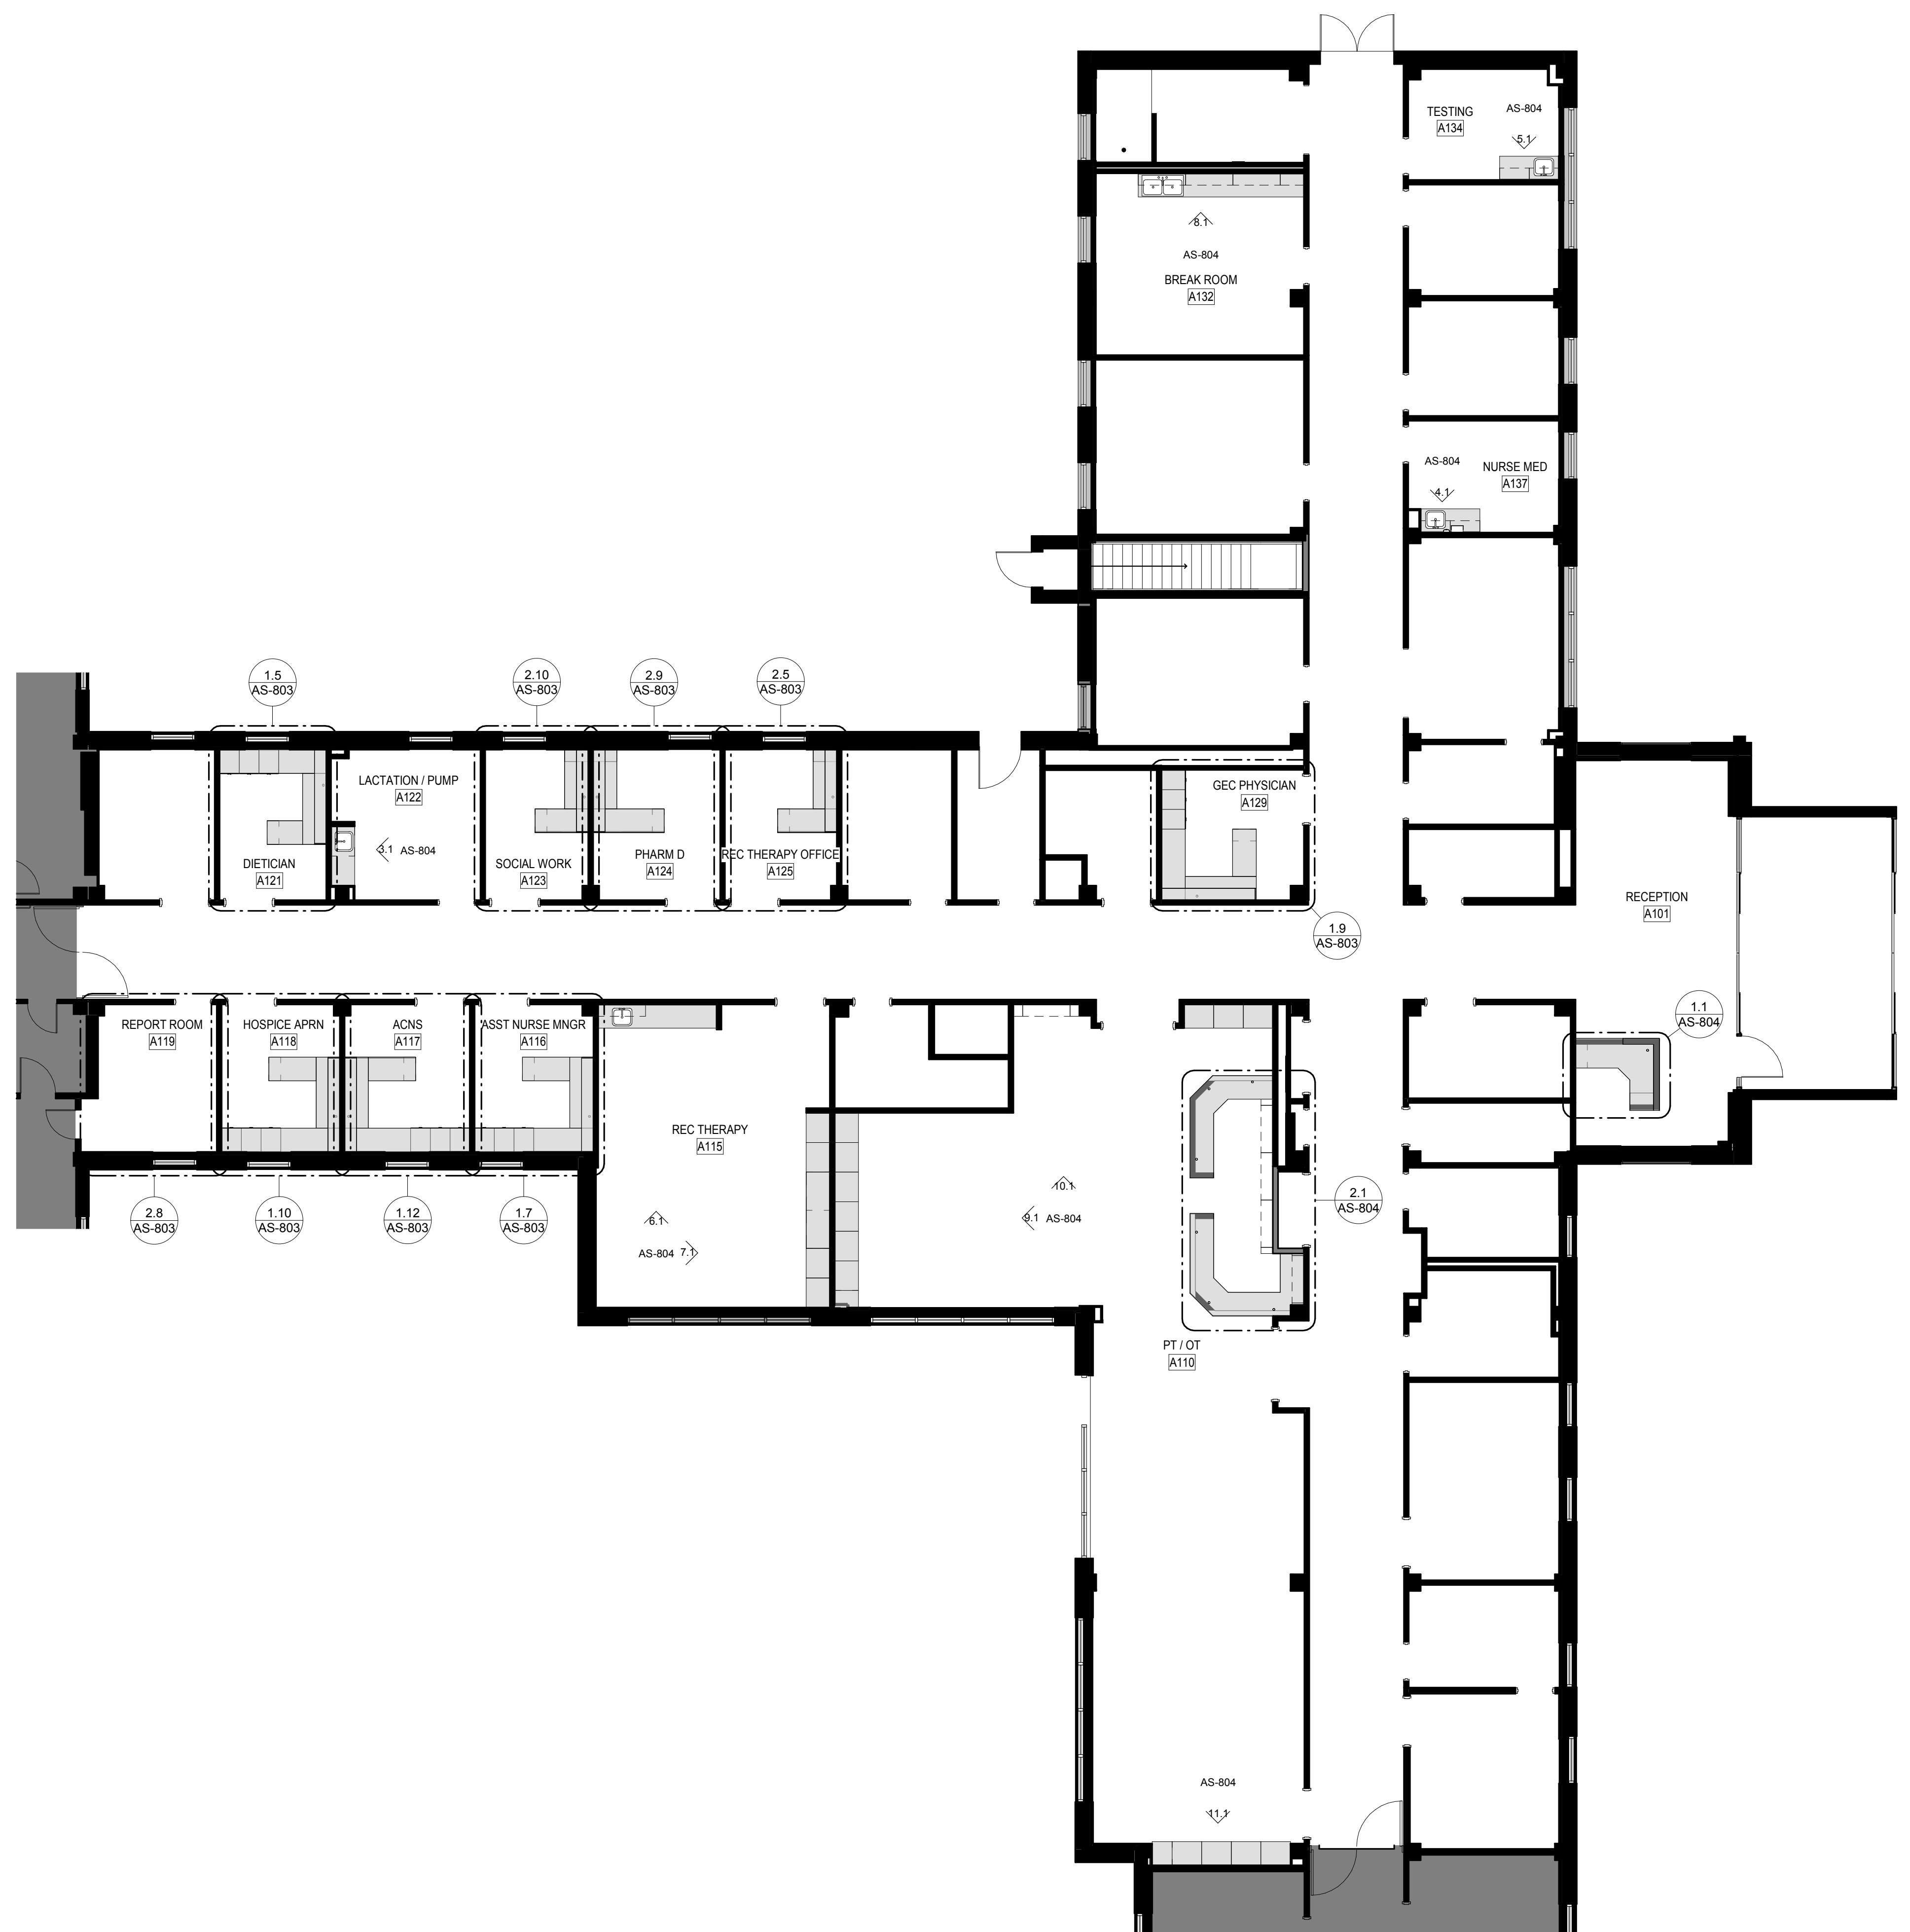

1 WING A - ARCHITECTURAL CASEWORK LEGEND
1/8" = 1'-0"

<p>CONSULTANT INFORMATION</p> <p>STRUCTURAL / CIVIL ENGINEER: STAND STRUCTURAL ENGINEERING, 11827 W. 112TH STREET, SUITE 200, OVERLAND PARK, KS 66210 (913) 214-2169</p> <p>MECHANICAL / ELECTRICAL / PLUMBING / TECHNICAL ENGINEER: SPUR DESIGN, 11020 KING STREET, SUITE 350, OVERLAND PARK, KS 66210 (405) 842-6100</p> <p>FIRE PROTECTION ENGINEER: POOLE FIRE PROTECTION, INC., 19910 W. 161ST STREET, OLATH, KS 66062 (913) 829-8650</p>		<p>ARCHITECT</p> <p>SPUR DESIGN</p> <p>512 SW 23rd Street, Overland Park, KS 66209 spur-design.com</p> <p>10302 King Street, Suite 300, Overland Park, KS 66209 spur-design.com</p> <p>KS ARCH REG. NO. A-1139, EXP. 12/31/2019 KS ENGR REG. NO. E-2586, EXP. 12/31/2019</p>		<p>Office of Construction and Facilities Management</p> <p>VA U.S. Department of Veteran Affairs</p>		<p>SHEET TITLE: ARCHITECTURAL CASEWORK LEGEND</p> <p>APPROVED: PROJECT DIRECTOR</p>		<p>PROJECT PHASE: BID DOCUMENTS</p> <p>FULLY SPRINKLERED</p>		<p>PROJECT TITLE: RENOVATE A & B WING BUILDING 6</p> <p>PROJECT LOCATION: 2200 SW GAGE BLVD. TOPEKA, KS 66622</p> <p>DATE: 07/10/2019</p> <p>CHECKED BY: AWM</p> <p>DRAWN BY: JET</p>		<p>VA PROJECT NUMBER: 589A5-19-116</p> <p>BUILDING NUMBER: 6</p> <p>DRAWING NUMBER: 6-AS-800</p> <p>Dwg. 34 OF 160</p>	
---	--	--	--	---	--	---	--	--	--	---	--	--	--


ARCHITECTURAL CASEWORK NOTES

1. ALL CABINETS, CABINET FILLERS, AND SHELVING TO BE PLASTIC LAMINATE, FINISH AS SCHEDULED!
 2. COUNTERTOPS TO BE PLASTIC LAMINATE, PL3, SOLID SURFACE (SS), OR QUARTZ (QTZ), FINISH AS SCHEDULED!
 3. GENERAL CONTRACTOR TO PROVIDE METAL SUPPORT BLOCKING FOR BUILT-INS AS REQUIRED
 4. SUPPORT BRACKETS TO BE PLACED AT ALL OPEN COUNTERTOPS, MAXIMUM SPACING BETWEEN BRACKETS NOT TO EXCEED 24" ON CENTER, REFER TO BRACKET MANUFACTURER REQUIREMENTS.
- REFERENCE ARCHITECTURAL CASEWORK SCHEDULE, ARCHITECTURAL CASEWORK ENLARGED PLANS AND ELEVATIONS, & MATERIAL LEGEND.

ARCHITECTURAL CASEWORK SCHEDULE


MARK	CASEWORK	MATERIAL	FINISH / COMMENTS
C1	CASEWORK, BASE CABINET	PLASTIC LAMINATE	PL1
C2	CASEWORK, BASE CABINET	PLASTIC LAMINATE	PL2
C3	CASEWORK, UPPER CABINET	PLASTIC LAMINATE	PL2
C4	CASEWORK, UPPER CABINET	PLASTIC LAMINATE	PL2
C8	CASEWORK, TALL CABINET	PLASTIC LAMINATE	PL2
C9	CASEWORK, TALL CABINET	PLASTIC LAMINATE	PL2
C10	CASEWORK, COUNTERTOP	PLASTIC LAMINATE	PL1
C11	CASEWORK, COUNTERTOP	SOLID SURFACE	SS
C12	CASEWORK, COUNTERTOP	PLASTIC LAMINATE	PL3
C13	CASEWORK, COUNTERTOP	QUARTZ	QTZ
C14	CASEWORK, RESIDENT DESK	PLASTIC LAMINATE	COUNTER - PL3, CABINETS - PL1
C15	CASEWORK, RESIDENT DESK - BARIATRIC	PLASTIC LAMINATE	COUNTER - PL3, CABINETS - PL1
C16	CASEWORK, RESIDENT WARDROBE	PLASTIC LAMINATE	PL1
C17	CASEWORK, SHADOW BOX	PLASTIC LAMINATE & PLEXIGLASS	PL1, PLEXIGLASS
C18	PREMANUFACTURED FIREPLACE MANTEL	WOOD, PRIMED TO PAINT	P7

A
B
C
D
E
F

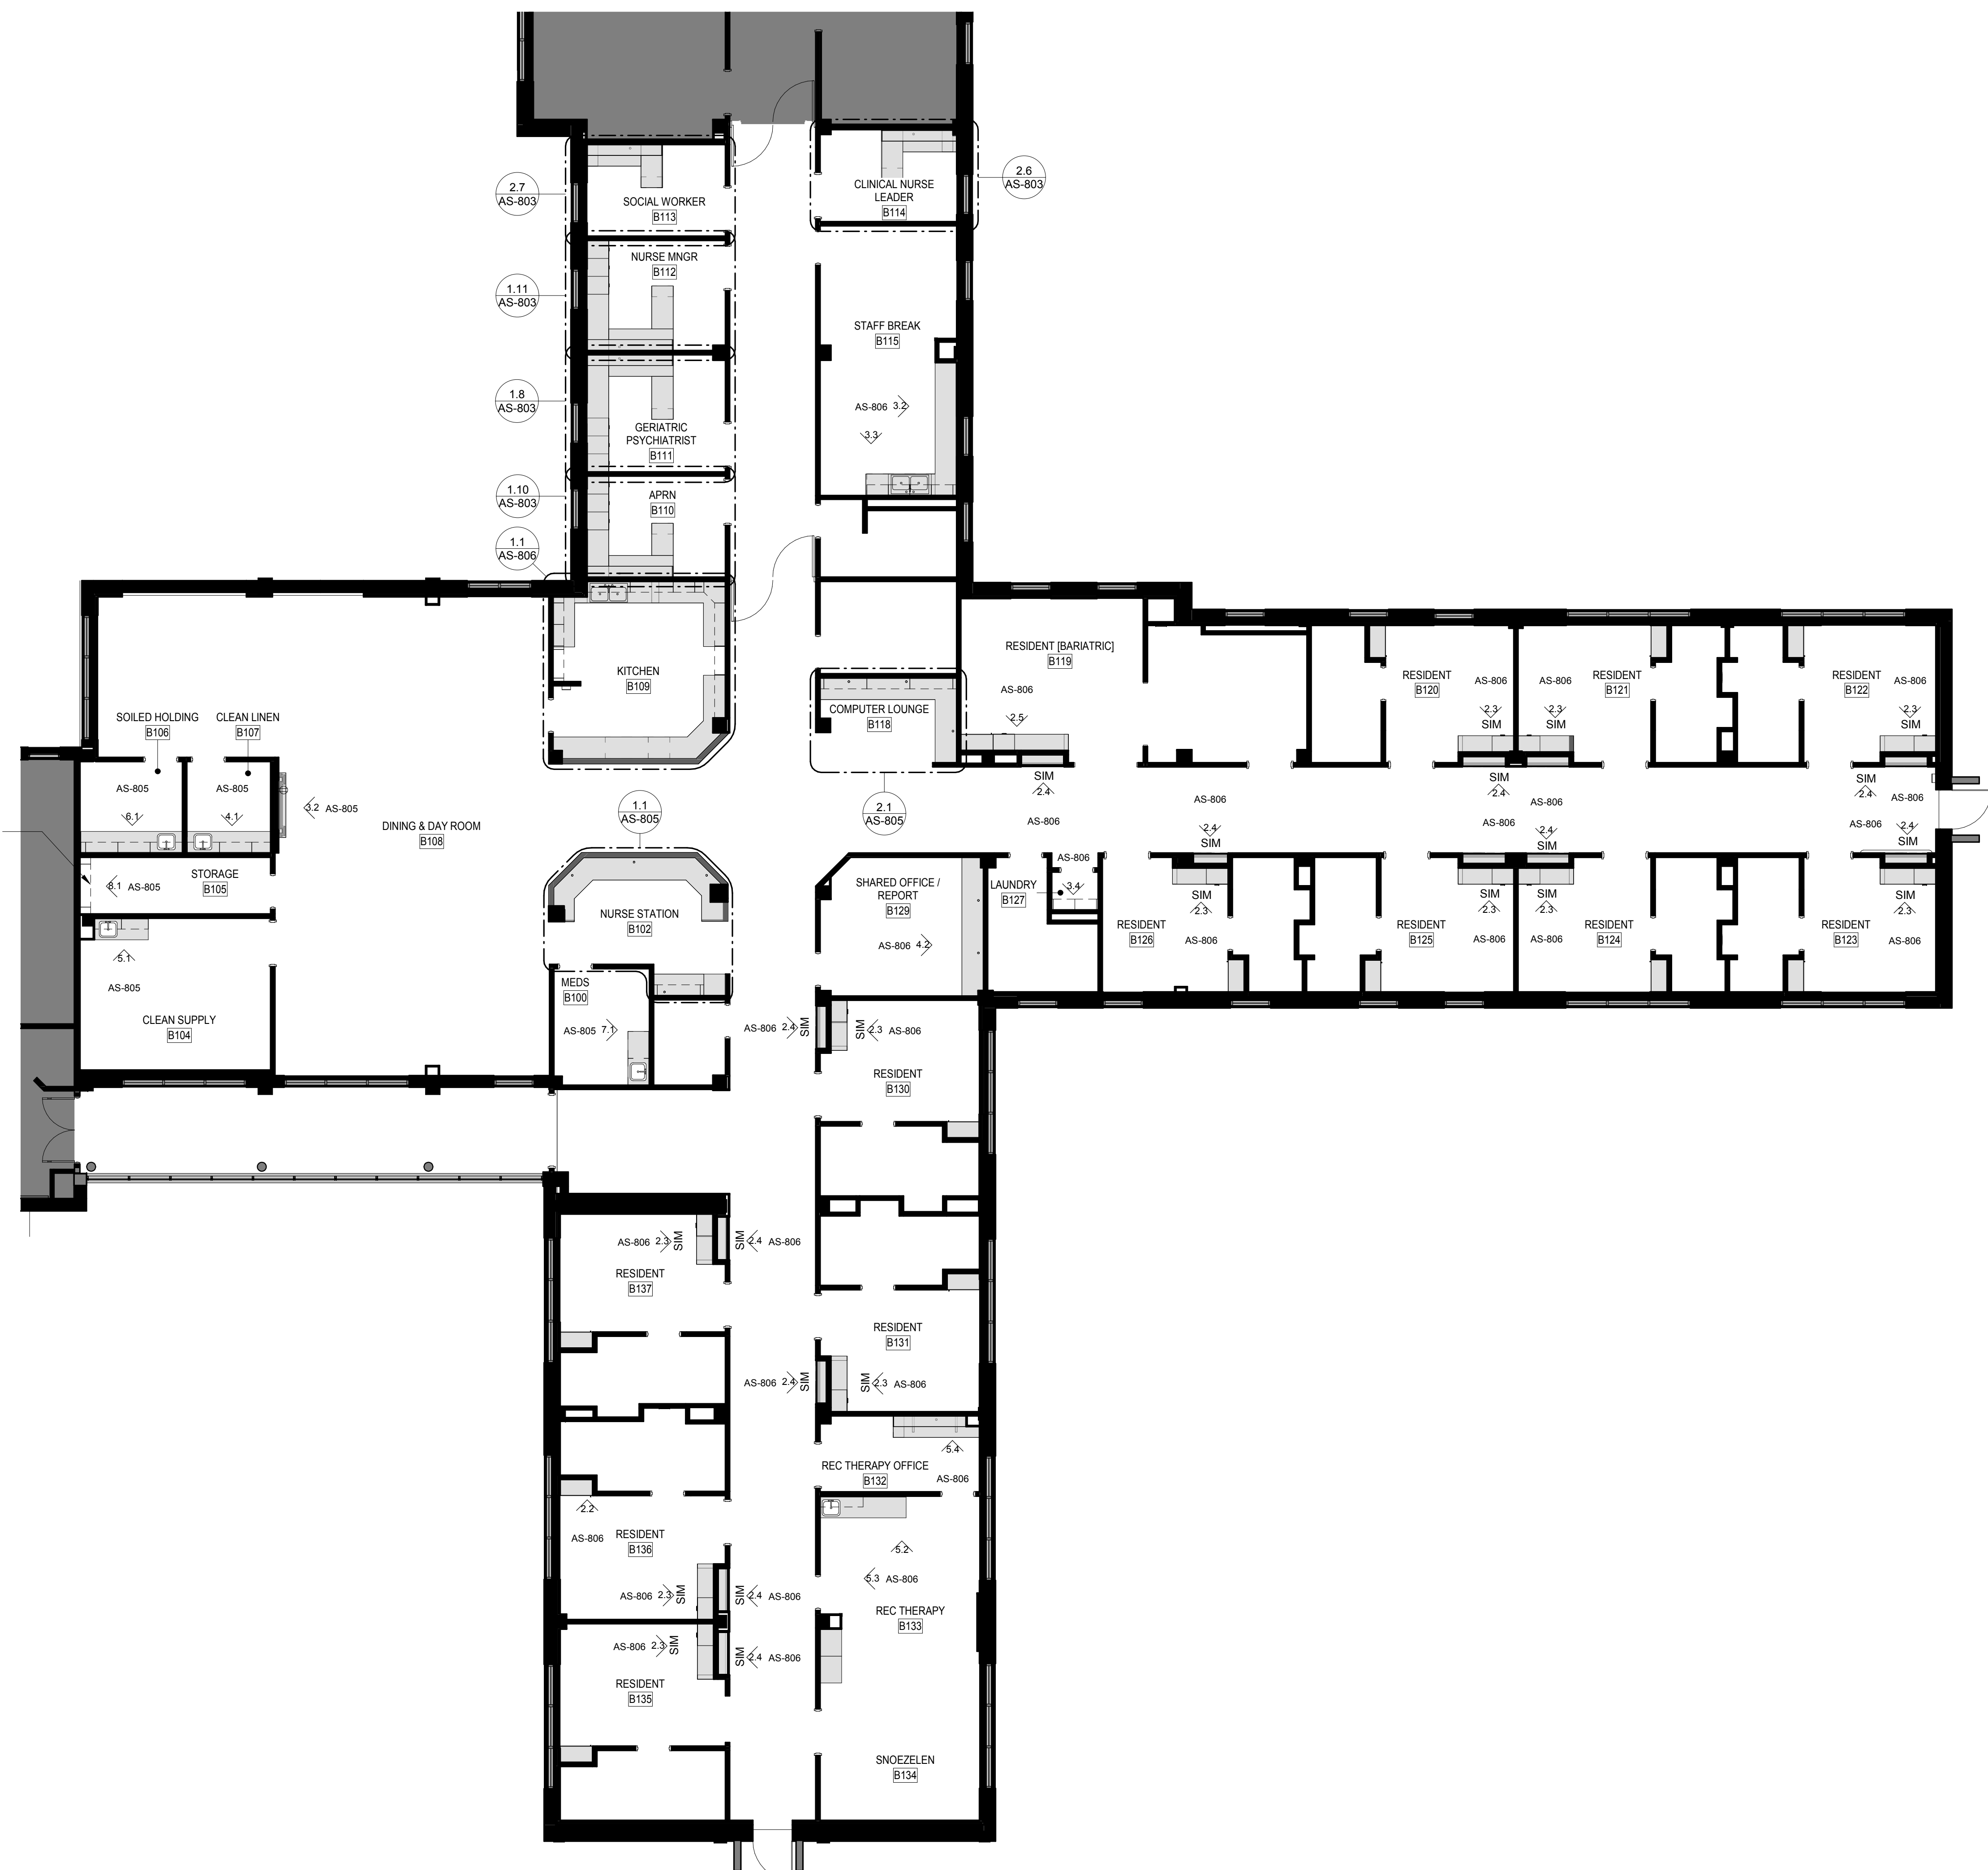

CABINET TO HOUSE CONTROLS FOR WALL-MOUNTED VIRTUAL AQUARIUM VIDEO DISPLAY SYSTEM. GENERAL CONTRACTOR TO COORDINATE MECHANICAL AND ELECTRICAL REQUIREMENTS WITH SYSTEM MANUFACTURER.

1 WING B - ARCHITECTURAL CASEWORK LEGEND
1/8" = 1'-0"

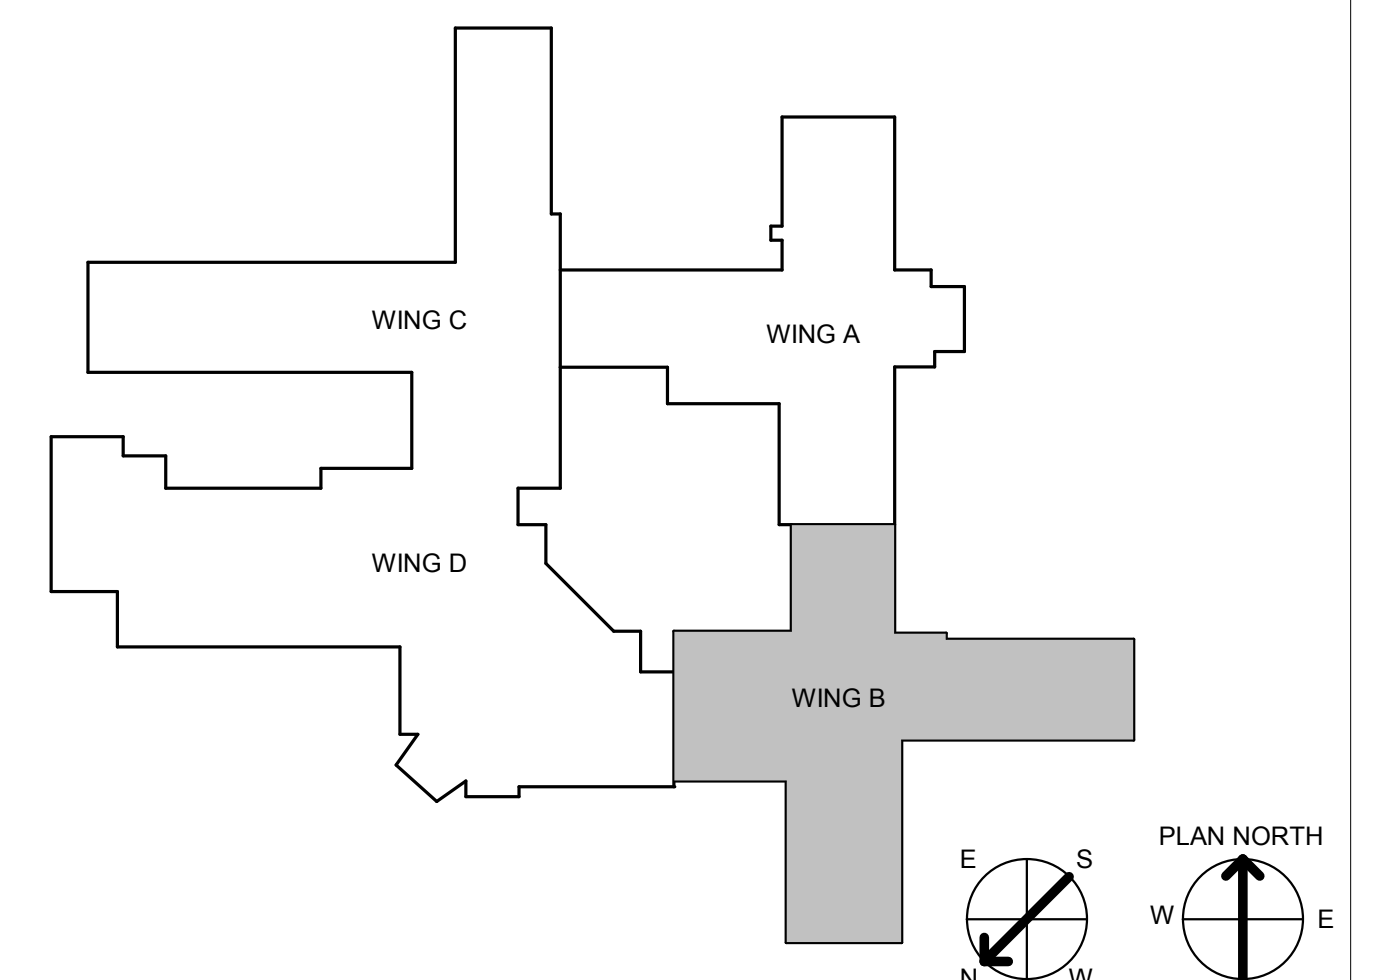

Revision #	Date

CONSULTANT INFORMATION		
STRUCTURAL / CIVIL ENGINEER STAND STRUCTURAL ENGINEERING 11927 W. 112TH STREET, SUITE 200 OVERLAND PARK, KS 66210 (913) 214-2169	MECHANICAL / ELECTRICAL / PLUMBING / TECHNICAL ENGINEER SPUR DESIGN 11020 KING STREET, SUITE 350 OVERLAND PARK, KS 66210 (405) 842-6100	FIRE PROTECTION ENGINEER POOLE FIRE PROTECTION, INC. 19910 W. 161ST STREET OLATH, KS 66062 (913) 829-8650

ARCHITECT

SPUR DESIGN

312 SW 23rd Street
Overland Park, KS 66209
spur-design.com

11020 King Street, Suite 350
Overland Park, KS 66210
www.spur-design.com

KS ARCH REG. NO. A-1139, EXP. 12/31/2019
KS ENGR REG. NO. E-2586, EXP. 12/31/2019



Office of Construction and Facilities Management

VA U.S. Department of Veteran Affairs

SHEET TITLE
ARCHITECTURAL CASEWORK LEGEND

APPROVED: PROJECT DIRECTOR

PROJECT PHASE
BID DOCUMENTS

FULLY SPRINKLERED

PROJECT TITLE RENOVATE A & B WING BUILDING 6	VA PROJECT NUMBER 589A5-19-116
PROJECT LOCATION 2200 SW GAGE BLVD. TOPEKA, KS 66622	BUILDING NUMBER 6
DATE 07/10/2019	DRAWING NUMBER 6-AS-802
CHECKED BY AWM	Dwg. 35 OF 160
DRAWN BY JET	


ARCHITECTURAL CASEWORK NOTES

1. ALL CABINETS, CABINET FILLERS, AND SHELVING TO BE PLASTIC LAMINATE. FINISH AS SCHEDULED.
 2. COUNTERTOPS TO BE PLASTIC LAMINATE (PL3, SOLID SURFACE (SS), OR QUARTZ (QTZ), FINISH AS SCHEDULED).
 3. GENERAL CONTRACTOR TO PROVIDE METAL SUPPORT BLOCKING FOR BUILT-INS AS REQUIRED.
 4. SUPPORT BRACKETS TO BE PLACED AT ALL OPEN COUNTERTOPS. MAXIMUM SPACING BETWEEN BRACKETS NOT TO EXCEED 24" ON CENTER. REFER TO BRACKET MANUFACTURER REQUIREMENTS.
- *REFERENCE ARCHITECTURAL CASEWORK SCHEDULE, ARCHITECTURAL CASEWORK ENLARGED PLANS AND ELEVATIONS, & MATERIAL LEGEND.


ARCHITECTURAL CASEWORK SCHEDULE

MARK	CASEWORK	MATERIAL	FINISH / COMMENTS
C1	CASEWORK, BASE CABINET	PLASTIC LAMINATE	PL1
C2	CASEWORK, UPPER CABINET	PLASTIC LAMINATE	PL2
C3	CASEWORK, UPPER CABINET	PLASTIC LAMINATE	PL2
C4	CASEWORK, UPPER CABINET	PLASTIC LAMINATE	PL2
C5	CASEWORK, TALL CABINET	PLASTIC LAMINATE	PL2
C6	CASEWORK, TALL CABINET	PLASTIC LAMINATE	PL2
C7	CASEWORK, TALL CABINET	PLASTIC LAMINATE	PL2
C8	CASEWORK, TALL CABINET	PLASTIC LAMINATE	PL2
C9	CASEWORK, TALL CABINET	PLASTIC LAMINATE	PL2
C10	CASEWORK, COUNTERTOP	PLASTIC LAMINATE	PL1
C11	CASEWORK, COUNTERTOP	SOLID SURFACE	SS
C12	CASEWORK, COUNTERTOP	PLASTIC LAMINATE	PL3
C13	CASEWORK, COUNTERTOP	QUARTZ	QTZ
C14	CASEWORK, RESIDENT DESK	PLASTIC LAMINATE	COUNTER - PL3 CABINETS - PL1
C15	CASEWORK, RESIDENT DESK, BAR/ATRIC	PLASTIC LAMINATE	COUNTER - PL3 CABINETS - PL1
C16	CASEWORK, RESIDENT WARDROBE	PLASTIC LAMINATE	PL1
C17	CASEWORK, SHADOW BOX	PLASTIC LAMINATE & PLEXIGLASS	PL1, PLEXIGLASS
C18	PREMANUFACTURED FIREPLACE MANTEL	WOOD, PRIMED TO PAINT	P7


A

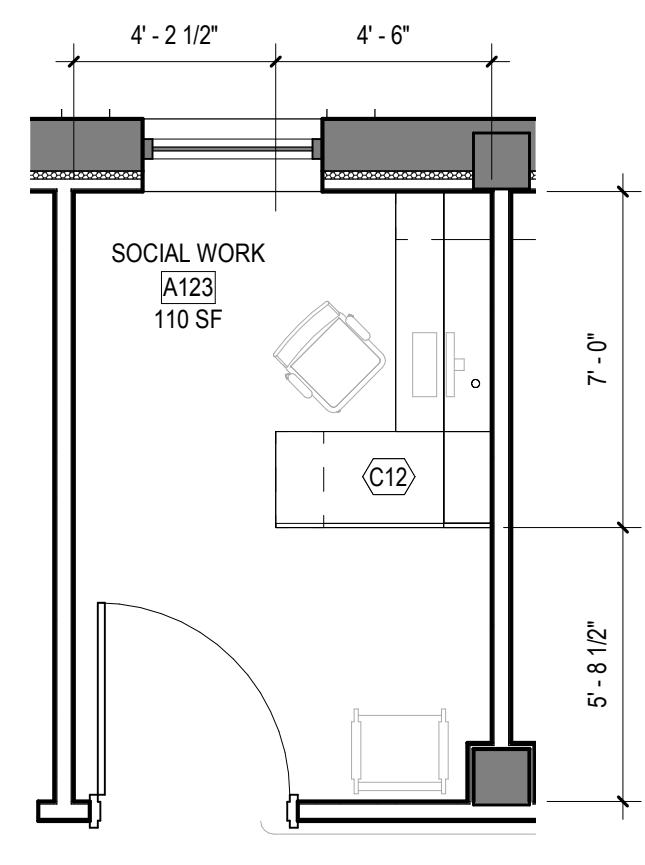


2.10 CASEWORK PLAN - OFFICE - TYPE 2
1/4" = 1'-0"

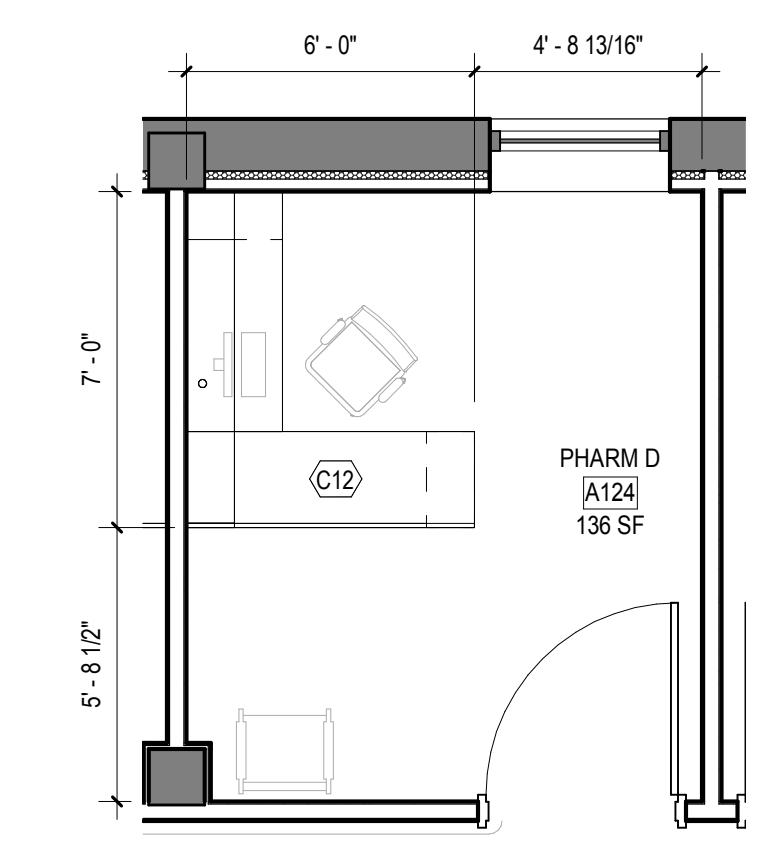


2.9 ENLARGED PLANS - TYPICAL OFFICE - TYPE II
1/4" = 1'-0"

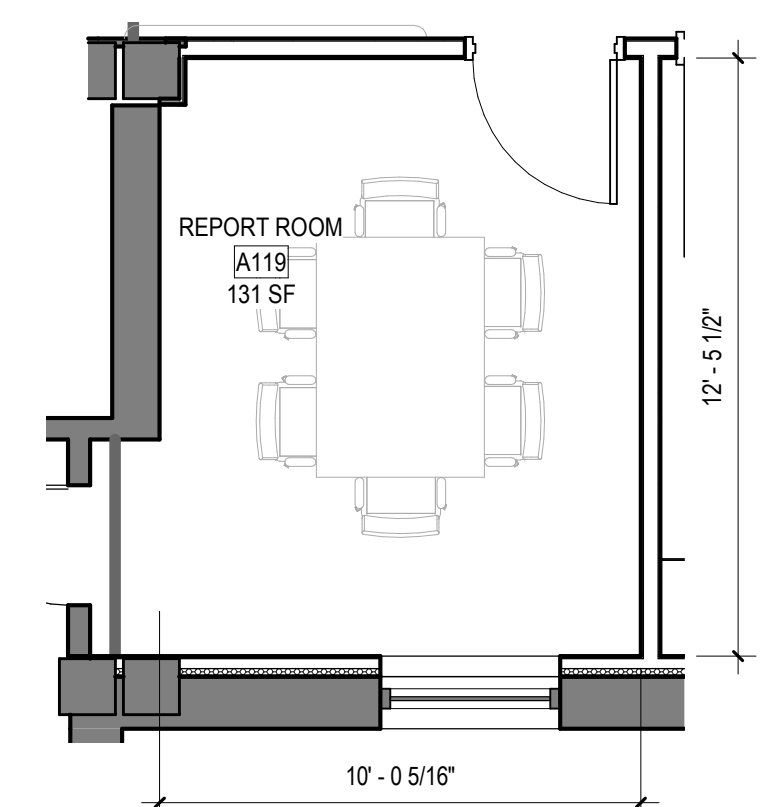


2.8 CASEWORK PLAN - OFFICE - TYPE 2
1/4" = 1'-0"

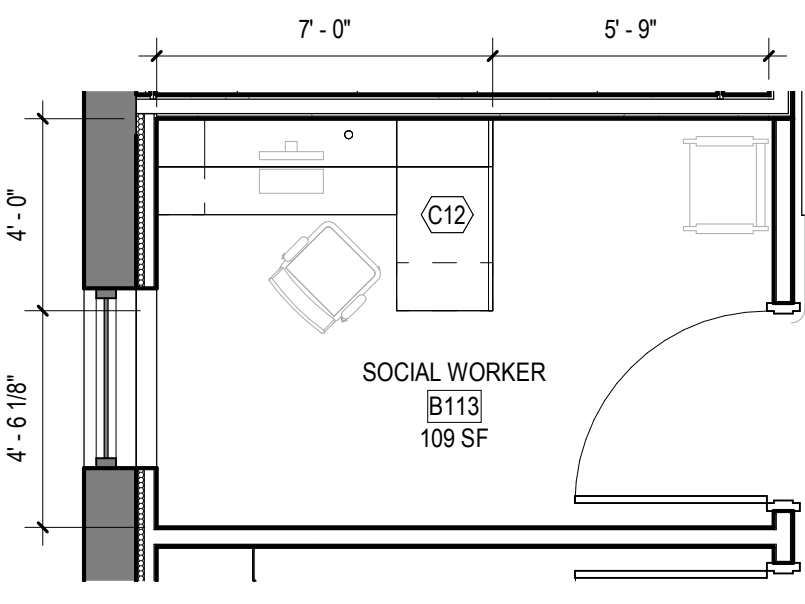

2.7 CASEWORK PLAN - OFFICE - TYPE 2
1/4" = 1'-0"

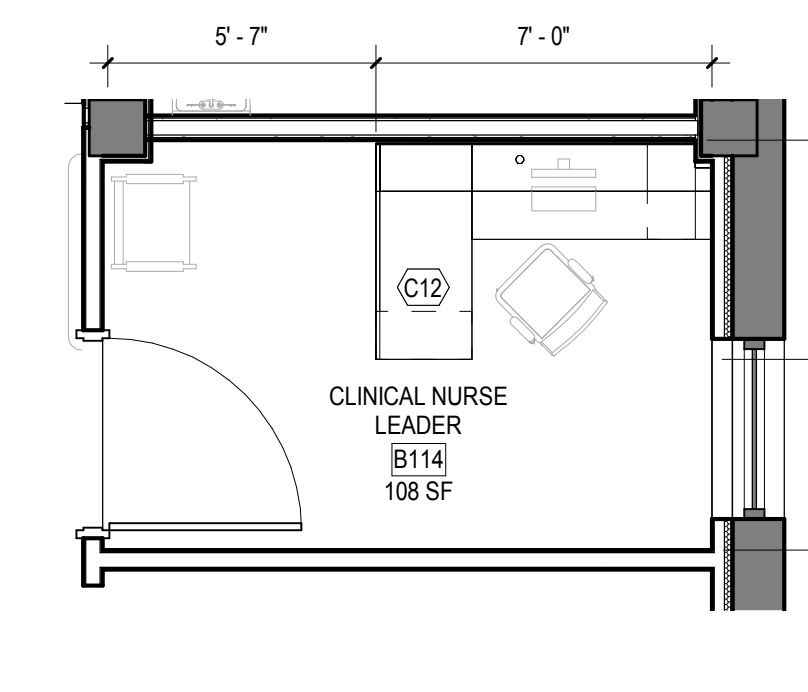


2.6 CASEWORK PLAN - OFFICE - TYPE 2
1/4" = 1'-0"

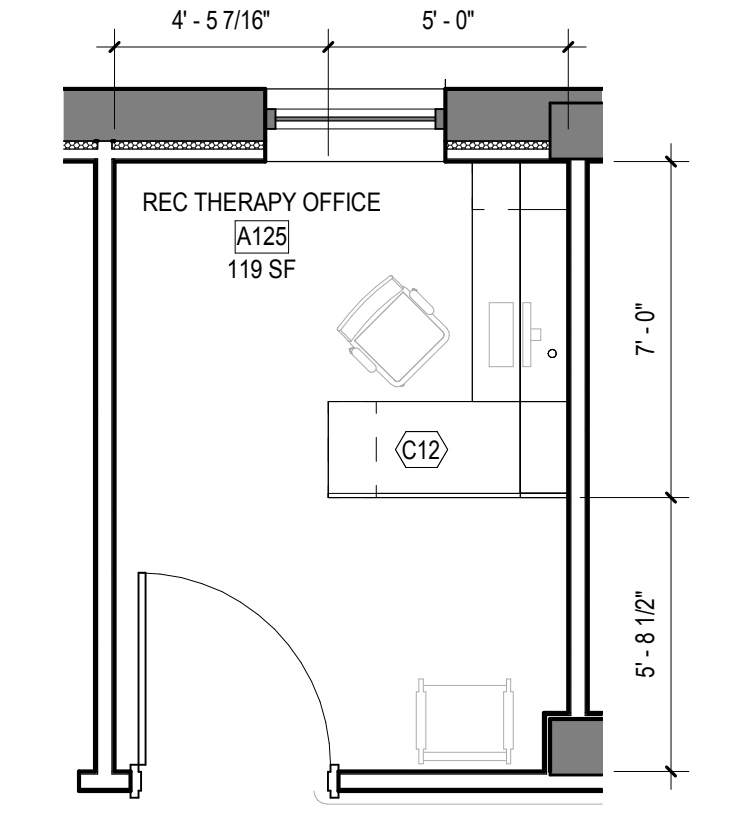


2.5 CASEWORK PLAN - OFFICE - TYPE 2
1/4" = 1'-0"


B

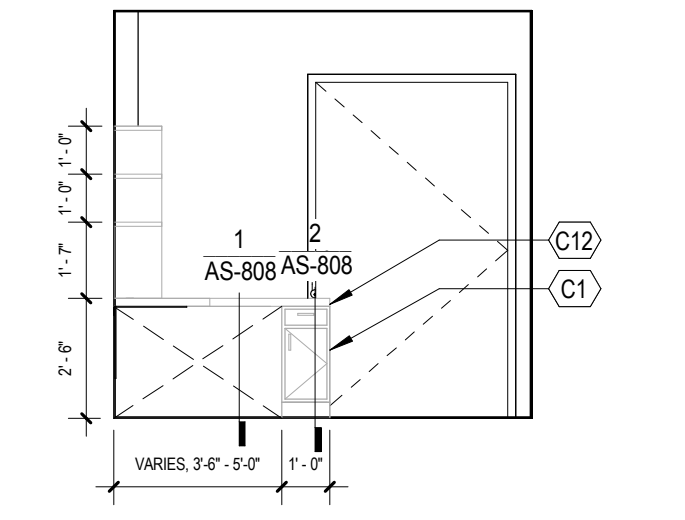


2.4 TYPICAL CASEWORK ELEVATION - OFFICES - TYPE 2
1/4" = 1'-0"

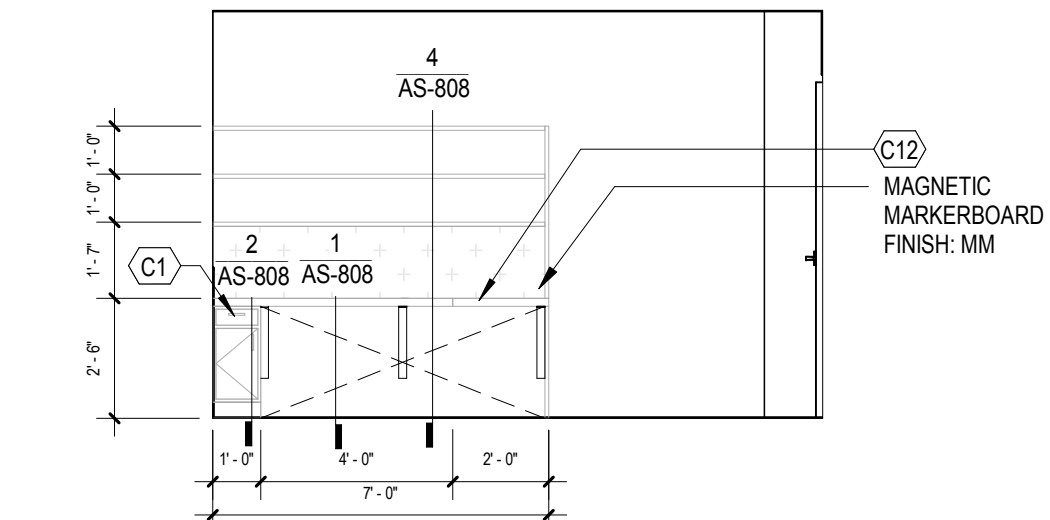


2.3 TYPICAL CASEWORK ELEVATION - OFFICES - TYPE 2
1/4" = 1'-0"

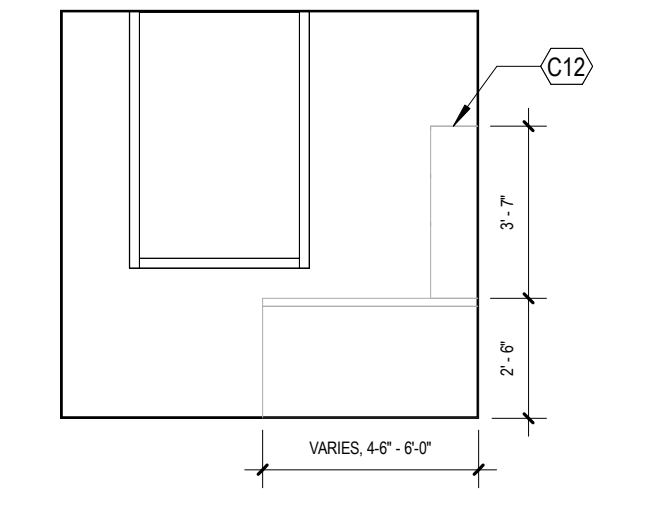

2.2 TYPICAL CASEWORK ELEVATION - OFFICES - TYPE 2
1/4" = 1'-0"

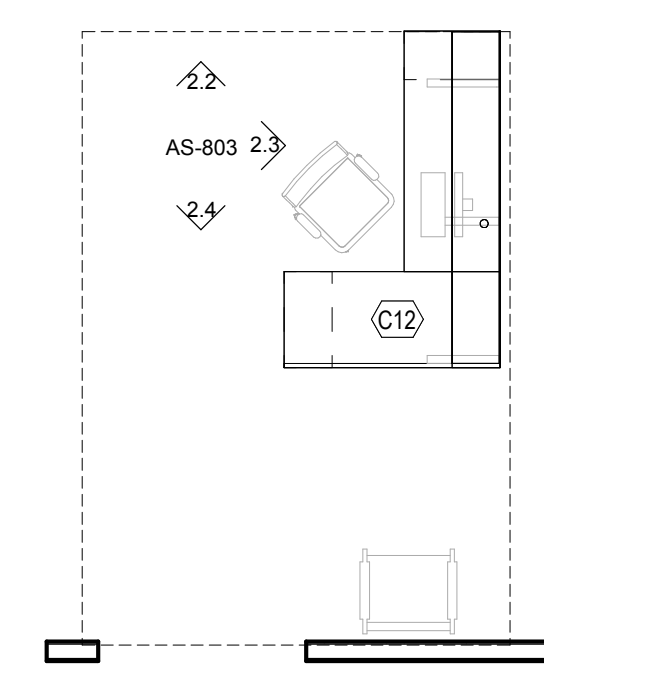


2.1 TYPICAL CASEWORK PLAN - OFFICES - TYPE 2
1/4" = 1'-0"

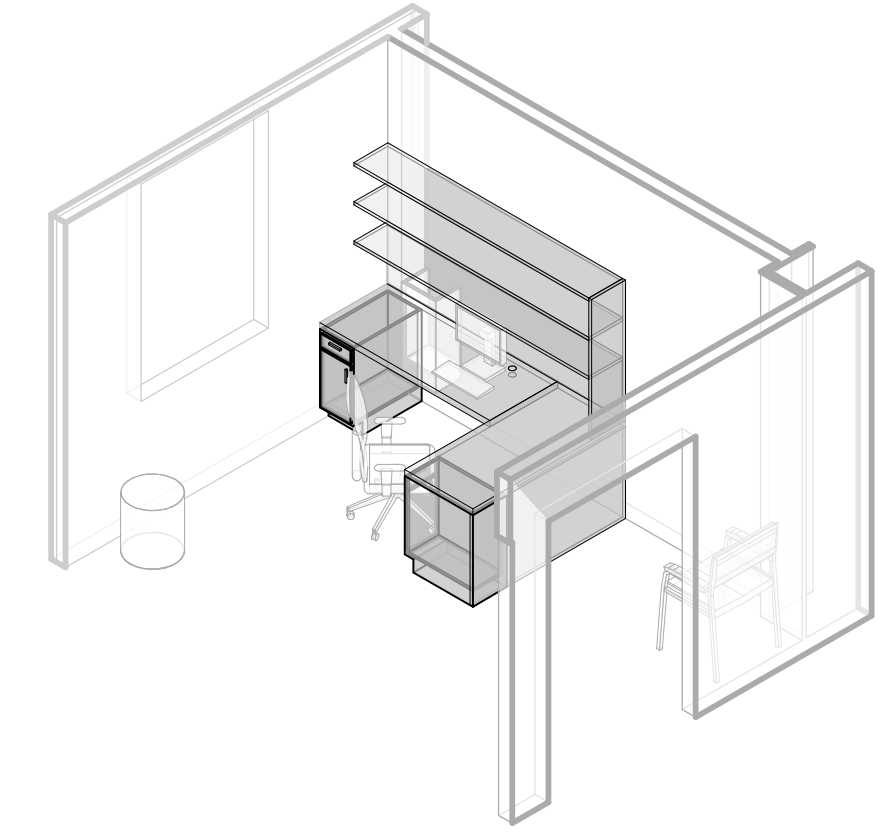


2 CASEWORK - TYPICAL OFFICE - TYPE 2

C


D

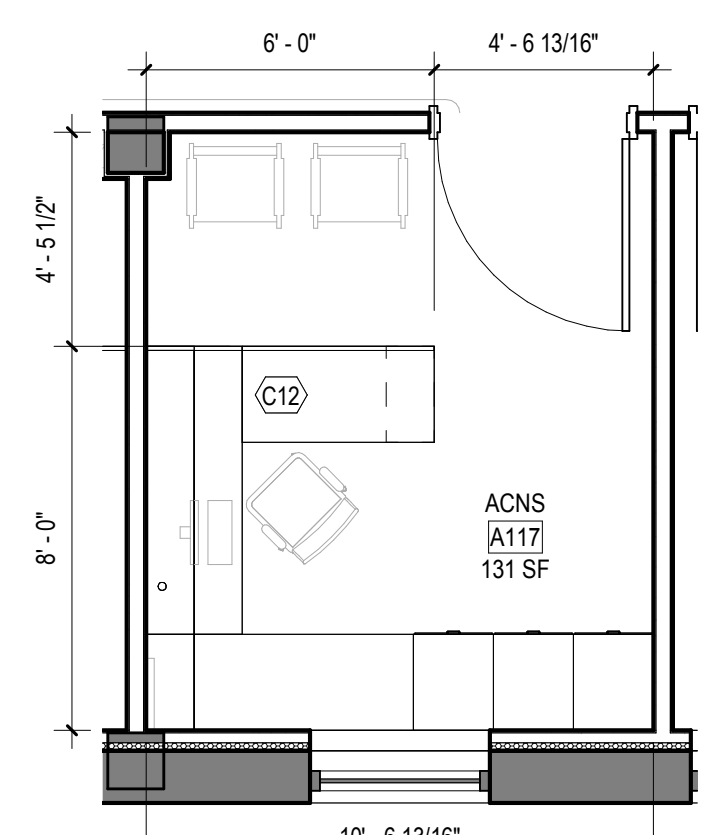


1.12 CASEWORK PLAN - OFFICE - TYPE 1
1/4" = 1'-0"

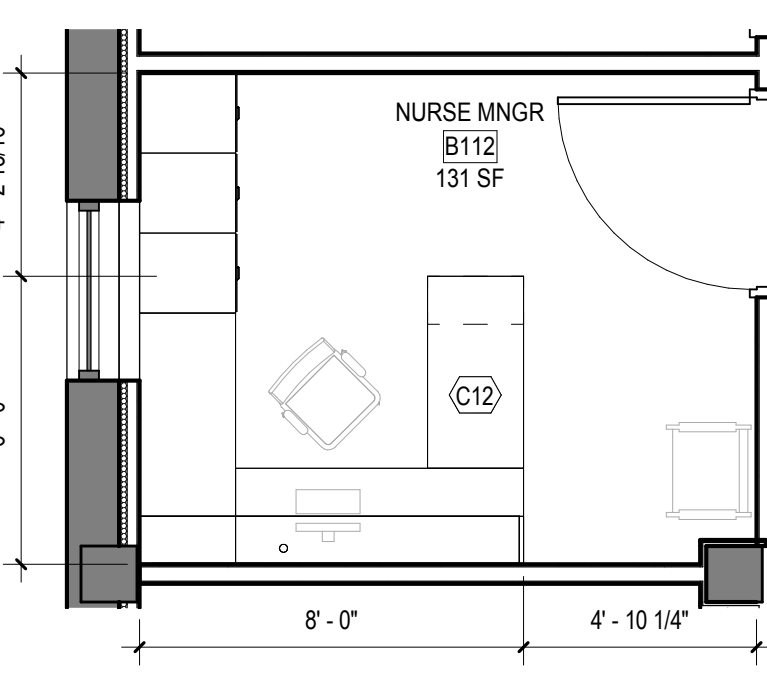


1.11 CASEWORK PLAN - OFFICE - TYPE 1
1/4" = 1'-0"

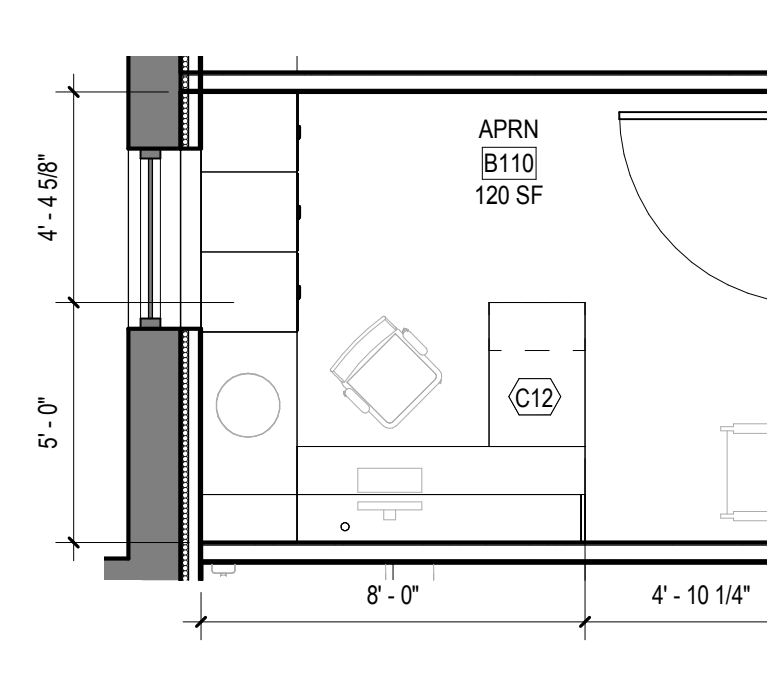


1.10 CASEWORK PLAN - OFFICE - TYPE 1
1/4" = 1'-0"

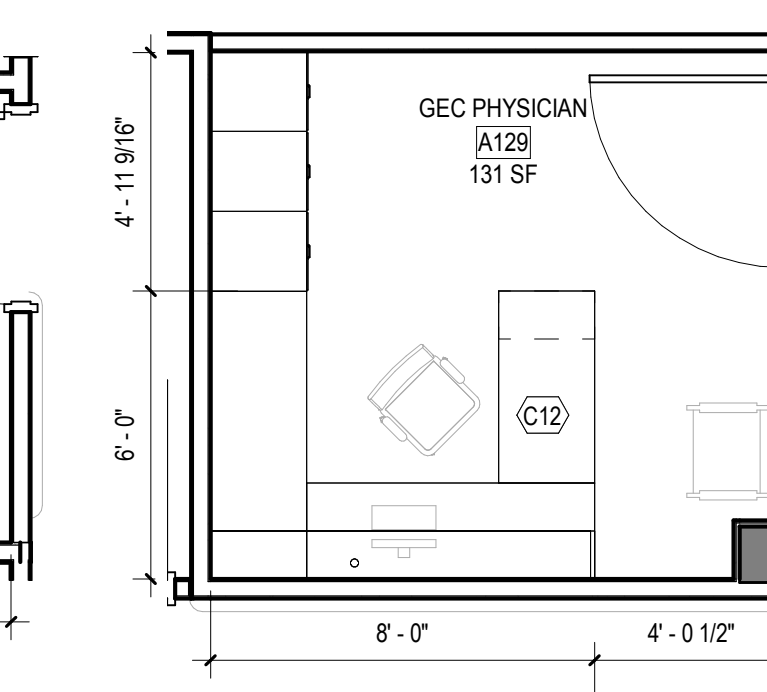


1.9 CASEWORK PLAN - OFFICE - TYPE 1
1/4" = 1'-0"

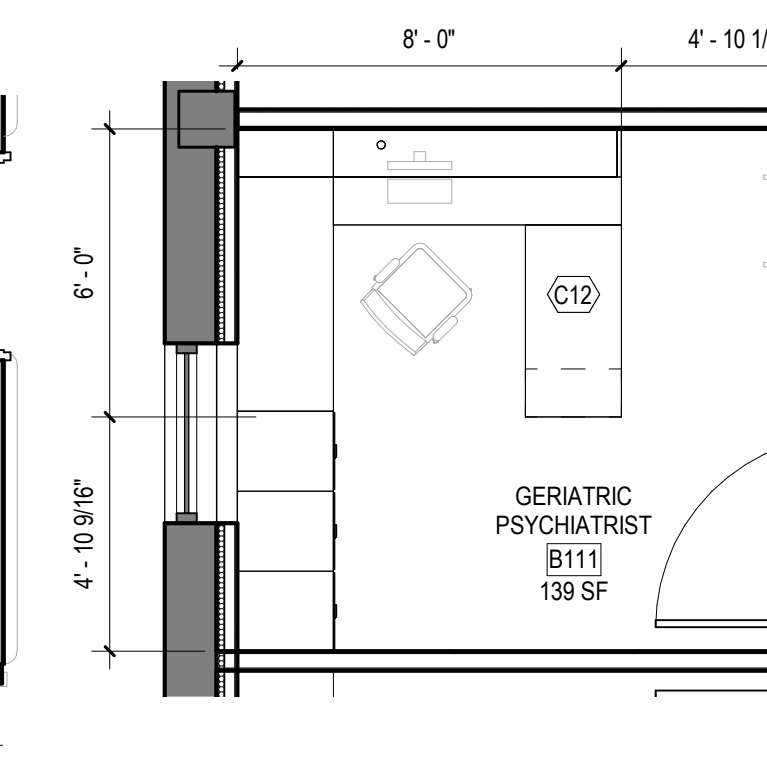


1.8 CASEWORK PLAN - OFFICE - TYPE 1
1/4" = 1'-0"

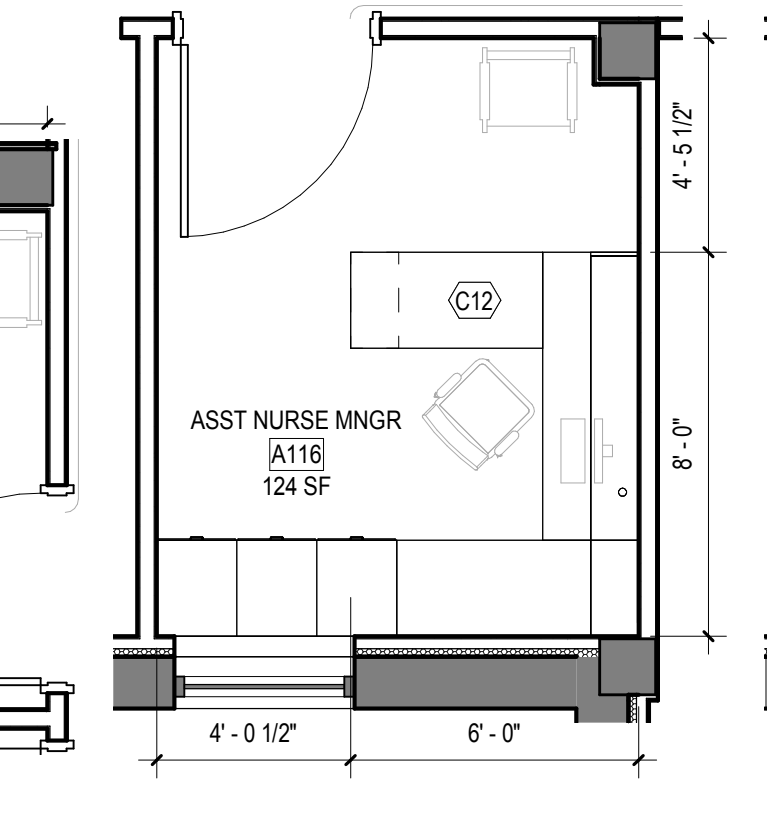

1.7 CASEWORK PLAN - OFFICE - TYPE 1
1/4" = 1'-0"

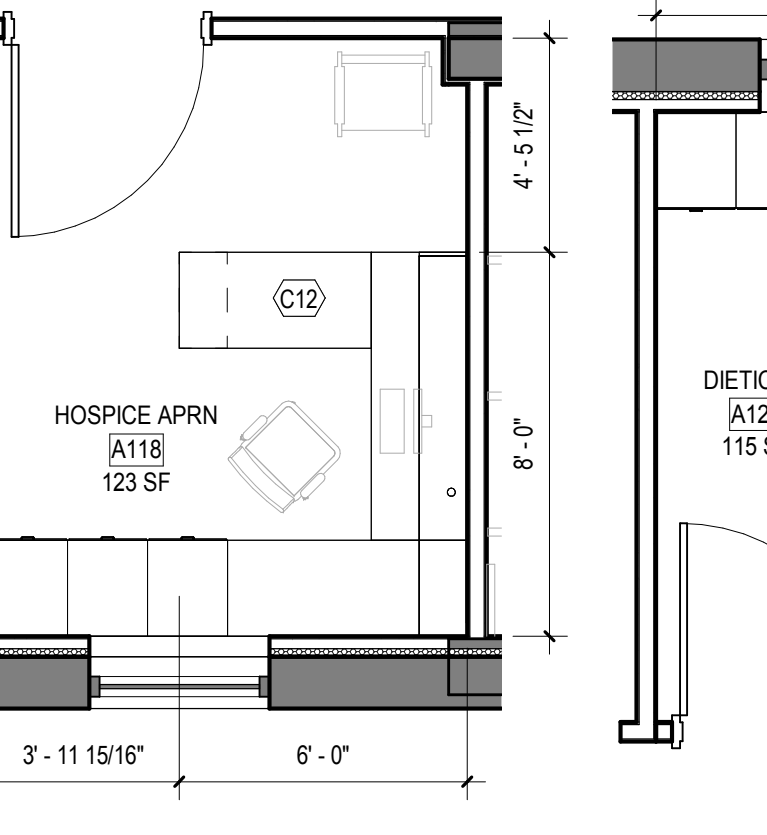


1.6 CASEWORK PLAN - OFFICE - TYPE 1
1/4" = 1'-0"

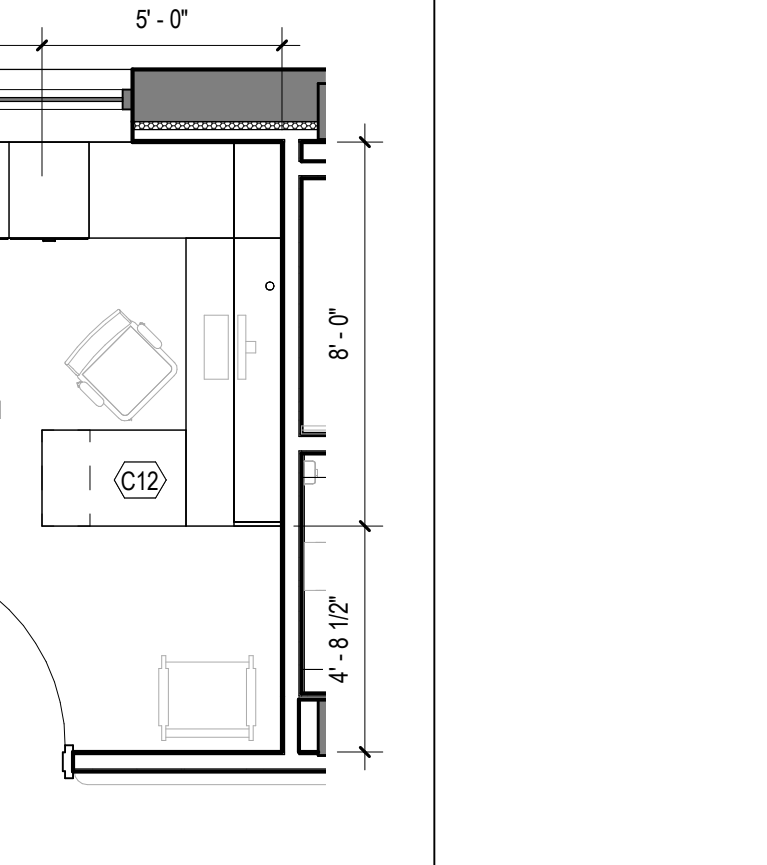


1.5 CASEWORK PLAN - OFFICE - TYPE 1
1/4" = 1'-0"


E

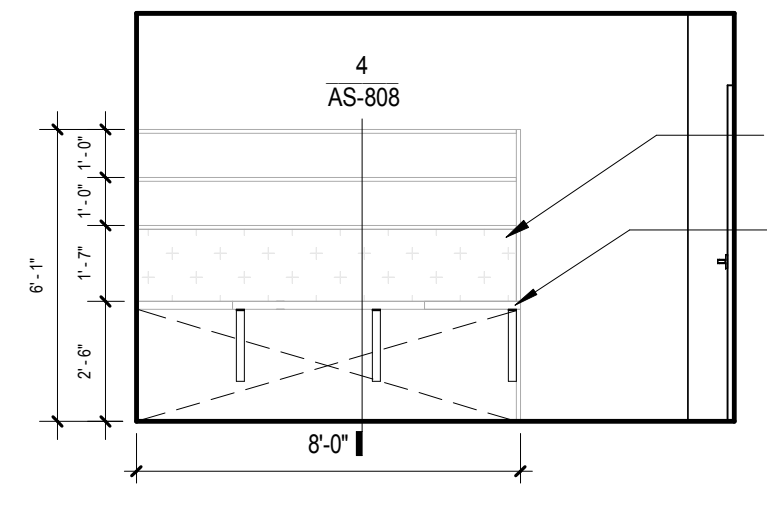


1.4 TYPICAL CASEWORK ELEVATION - OFFICES - TYPE 1
1/4" = 1'-0"

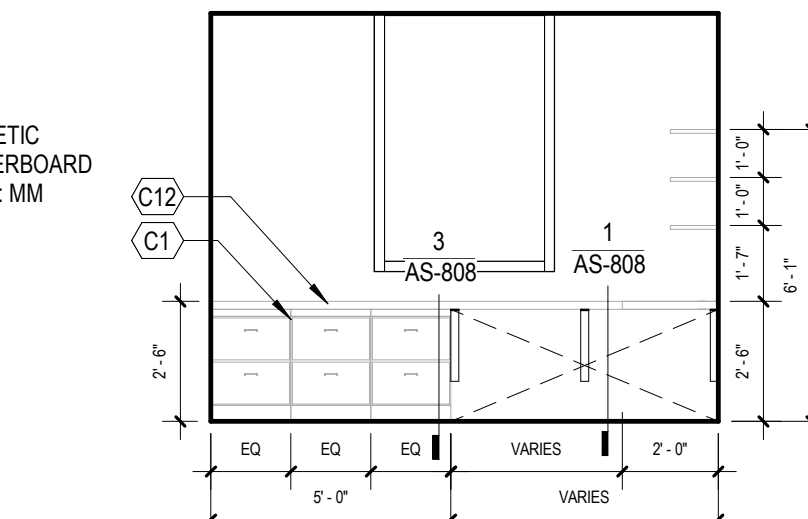


1.3 TYPICAL CASEWORK ELEVATION - OFFICES - TYPE 1
1/4" = 1'-0"

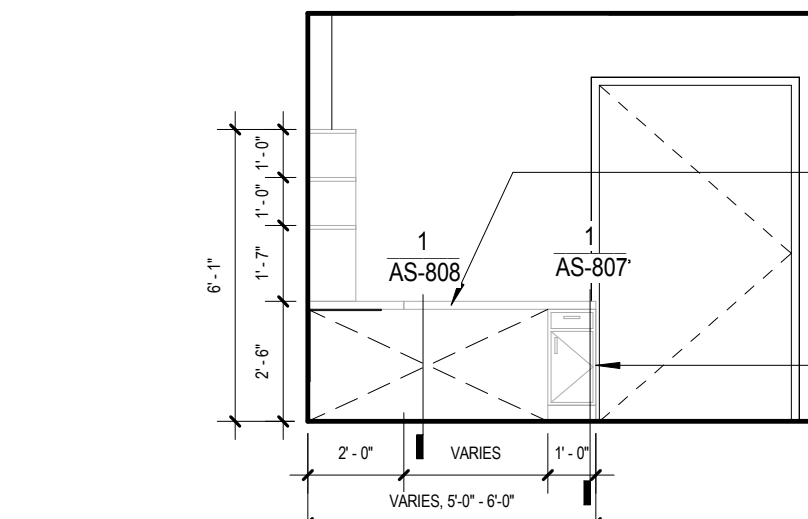

1.2 TYPICAL CASEWORK ELEVATION - OFFICES - TYPE 1
1/4" = 1'-0"


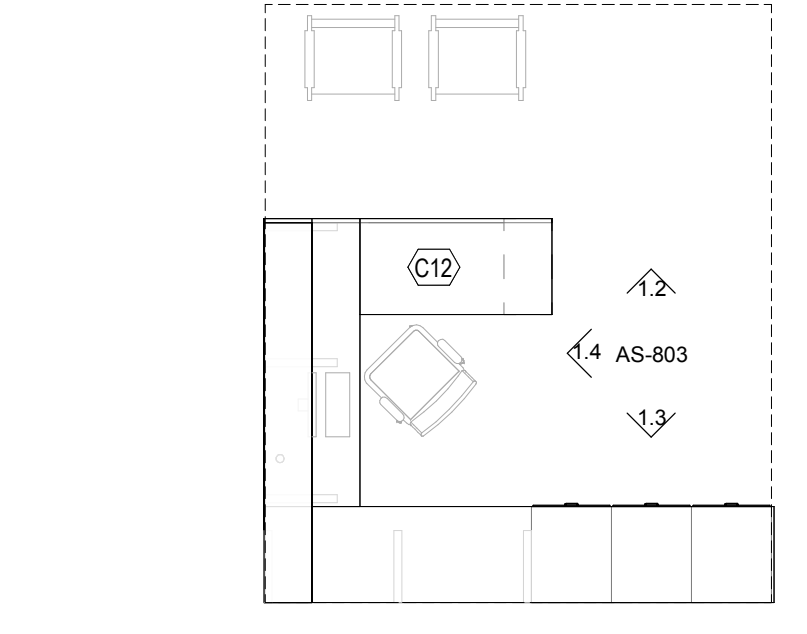


1.1 TYPICAL CASEWORK PLAN - OFFICES - TYPE 1
1/4" = 1'-0"

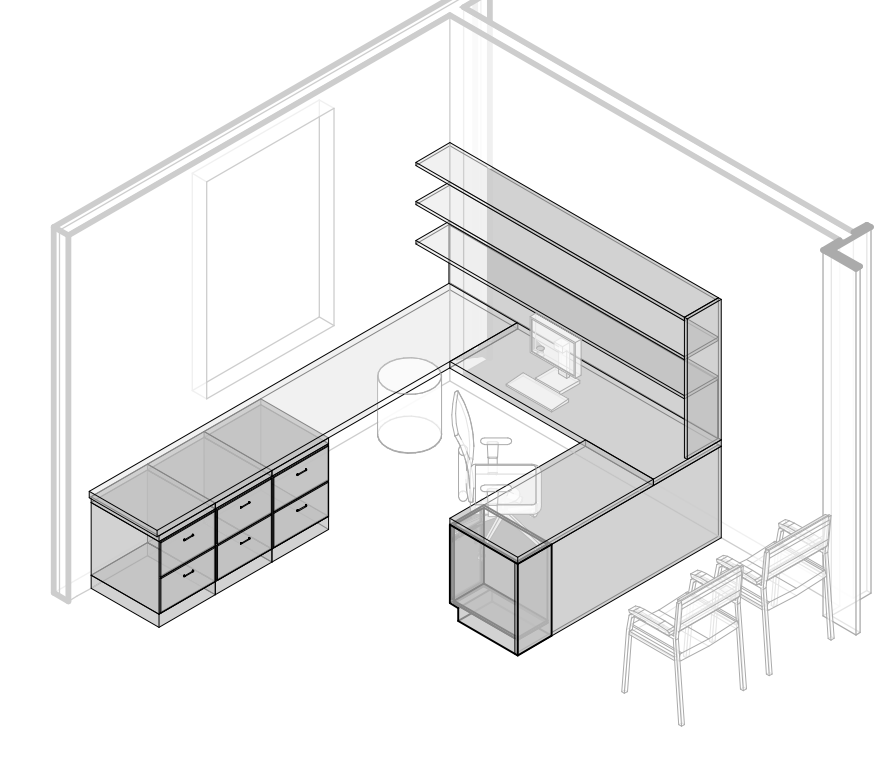

1 CASEWORK - TYPICAL OFFICE - TYPE 1

F

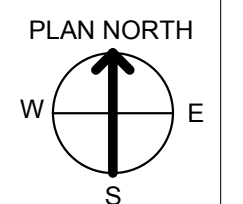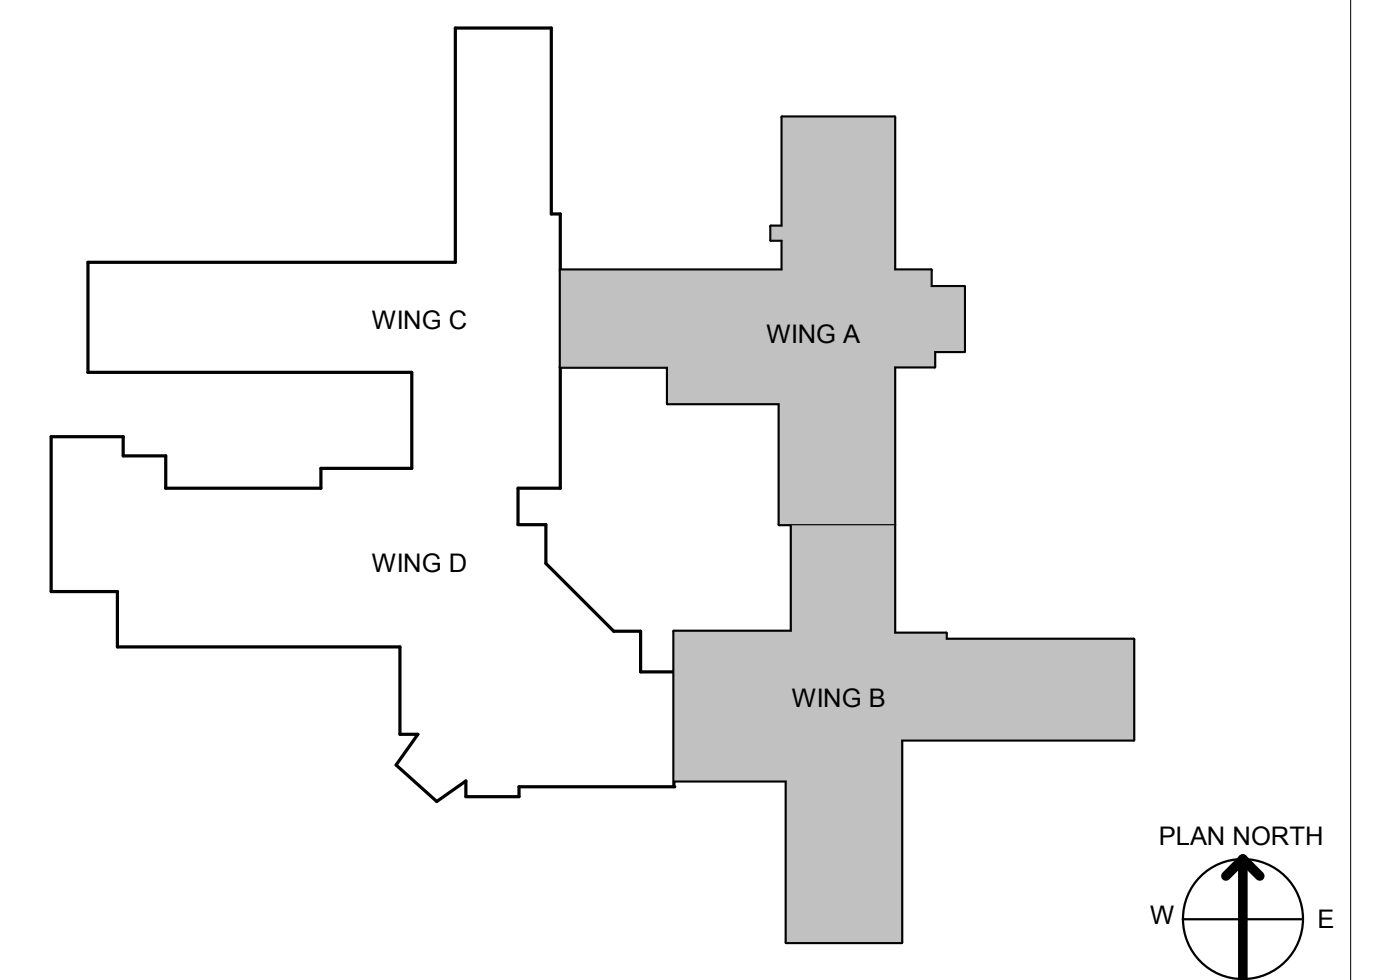

Revision #	Date

CONSULTANT INFORMATION		
STRUCTURAL / CIVIL ENGINEER	MECHANICAL / ELECTRICAL / PLUMBING / TECHNICAL ENGINEER	FIRE PROTECTION ENGINEER
STAND STRUCTURAL ENGINEERING 11927 W. 112TH STREET, SUITE 200 OVERLAND PARK, KS 66210 (913) 214-2169	SPUR DESIGN 11020 KING STREET, SUITE 350 OVERLAND PARK, KS 66210 (405) 842-6100	POOLE FIRE PROTECTION, INC. 19910 W. 161ST STREET OLATH, KS 66062 (913) 829-8650

ARCHITECT

Office of Construction and Facilities Management

VA U.S. Department of Veteran Affairs

SPUR DESIGN

312 SW 23rd Street
Overland Park, KS 66150
spur-design.com

10020 King Street, Suite 300
Overland Park, KS 66150
spur-design.com

KS ARCH REG. NO. A-1139, EXP. 12/31/2019
KS ENGR REG. NO. E-2586, EXP. 12/31/2019

6728
JULY 10, 2019
KANSAS ARCHITECT

SHEET TITLE	PROJECT PHASE
CASEWORK - ENLARGED PLANS & ELEVATIONS	BID DOCUMENTS
APPROVED: PROJECT DIRECTOR	FULLY SPRINKLERED

PROJECT TITLE	VA PROJECT NUMBER
RENOVATE A & B WING BUILDING 6	589A5-19-116
PROJECT LOCATION	BUILDING NUMBER
2200 SW GAGE BLVD. TOPEKA, KS 66622	6
DATE	CHECKED BY
07/10/2019	AWM
DRAWN BY	Dwg. #
JET	36 OF 160



ARCHITECTURAL CASEWORK NOTES

1. ALL CABINETS, CABINET FILLERS, AND SHELVING TO BE PLASTIC LAMINATE, FINISH AS SCHEDULED
2. COUNTERTOPS TO BE PLASTIC LAMINATE (PL3), SOLID SURFACE (SS), OR QUARTZ (QTZ), FINISH AS SCHEDULED
3. GENERAL CONTRACTOR TO PROVIDE METAL SUPPORT BLOCKING FOR BUILT-INS AS REQUIRED
4. SUPPORT BRACKETS TO BE PLACED AT ALL OPEN COUNTERTOPS, MAXIMUM SPACING BETWEEN BRACKETS NOT TO EXCEED 24" ON CENTER, REFER TO BRACKET MANUFACTURER REQUIREMENTS.


REFERENCE ARCHITECTURAL CASEWORK SCHEDULE, ARCHITECTURAL CASEWORK ENLARGED PLANS AND ELEVATIONS, & MATERIAL LEGEND.

ARCHITECTURAL CASEWORK SCHEDULE


MARK	CASEWORK	MATERIAL	FINISH / COMMENTS
C1	CASEWORK BASE CABINET	PLASTIC LAMINATE	PL1
C2	CASEWORK UPPER CABINET	PLASTIC LAMINATE	PL2
C3	CASEWORK TALL CABINET	PLASTIC LAMINATE	PL2
C4	CASEWORK TALL CABINET	PLASTIC LAMINATE	PL2
C5	CASEWORK TALL CABINET	PLASTIC LAMINATE	PL2
C6	CASEWORK TALL CABINET	PLASTIC LAMINATE	PL2
C7	CASEWORK TALL CABINET	PLASTIC LAMINATE	PL2
C8	CASEWORK TALL CABINET	PLASTIC LAMINATE	PL2
C9	CASEWORK TALL CABINET	PLASTIC LAMINATE	PL2
C10	CASEWORK COUNTERTOP	PLASTIC LAMINATE	PL1
C11	CASEWORK COUNTERTOP	SOLID SURFACE	SS
C12	CASEWORK COUNTERTOP	PLASTIC LAMINATE	PL3
C13	CASEWORK COUNTERTOP	QUARTZ	QTZ
C14	CASEWORK RESIDENT DESK	PLASTIC LAMINATE	COUNTER - PL3; CABINETS - PL1
C15	CASEWORK RESIDENT DESK BARIATRIC	PLASTIC LAMINATE	COUNTER - PL3; CABINETS - PL1
C16	CASEWORK RESIDENT WARDROBE	PLASTIC LAMINATE	PL1
C17	CASEWORK SHADOW BOX	PLASTIC LAMINATE & PLEXIGLASS	PL1, PLEXIGLASS
C18	PREMANUFACTURED FIREPLACE MANTEL	WOOD, PRIMED TO PAINT	PT

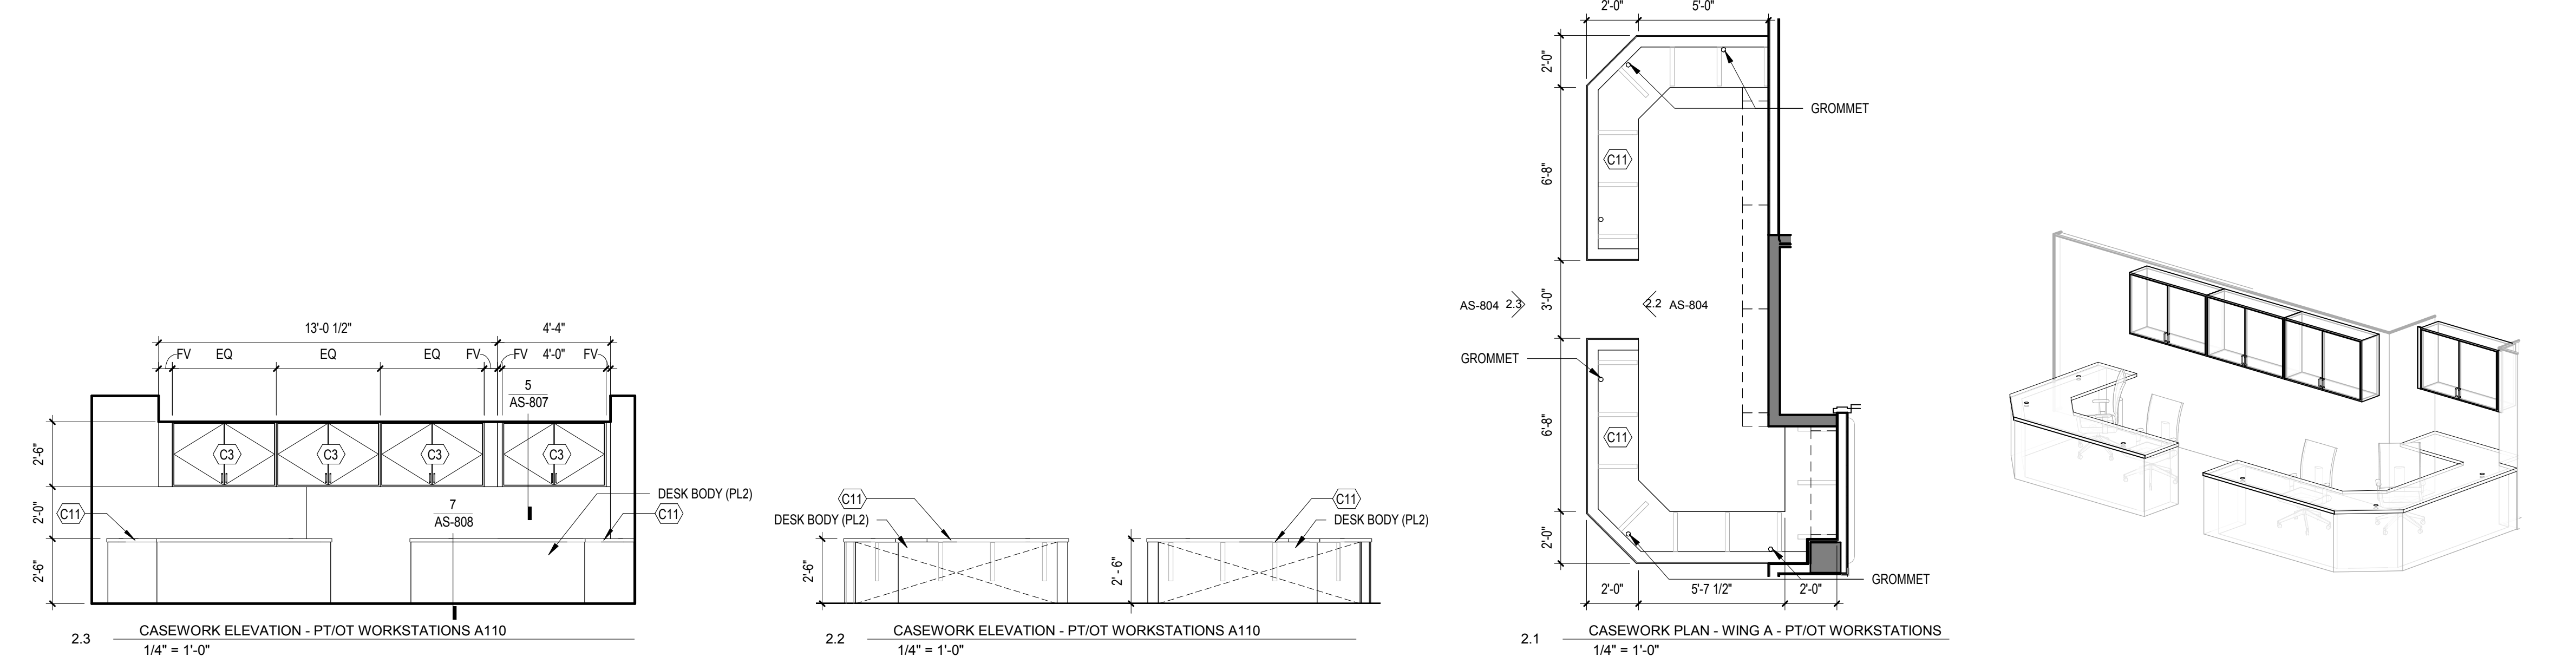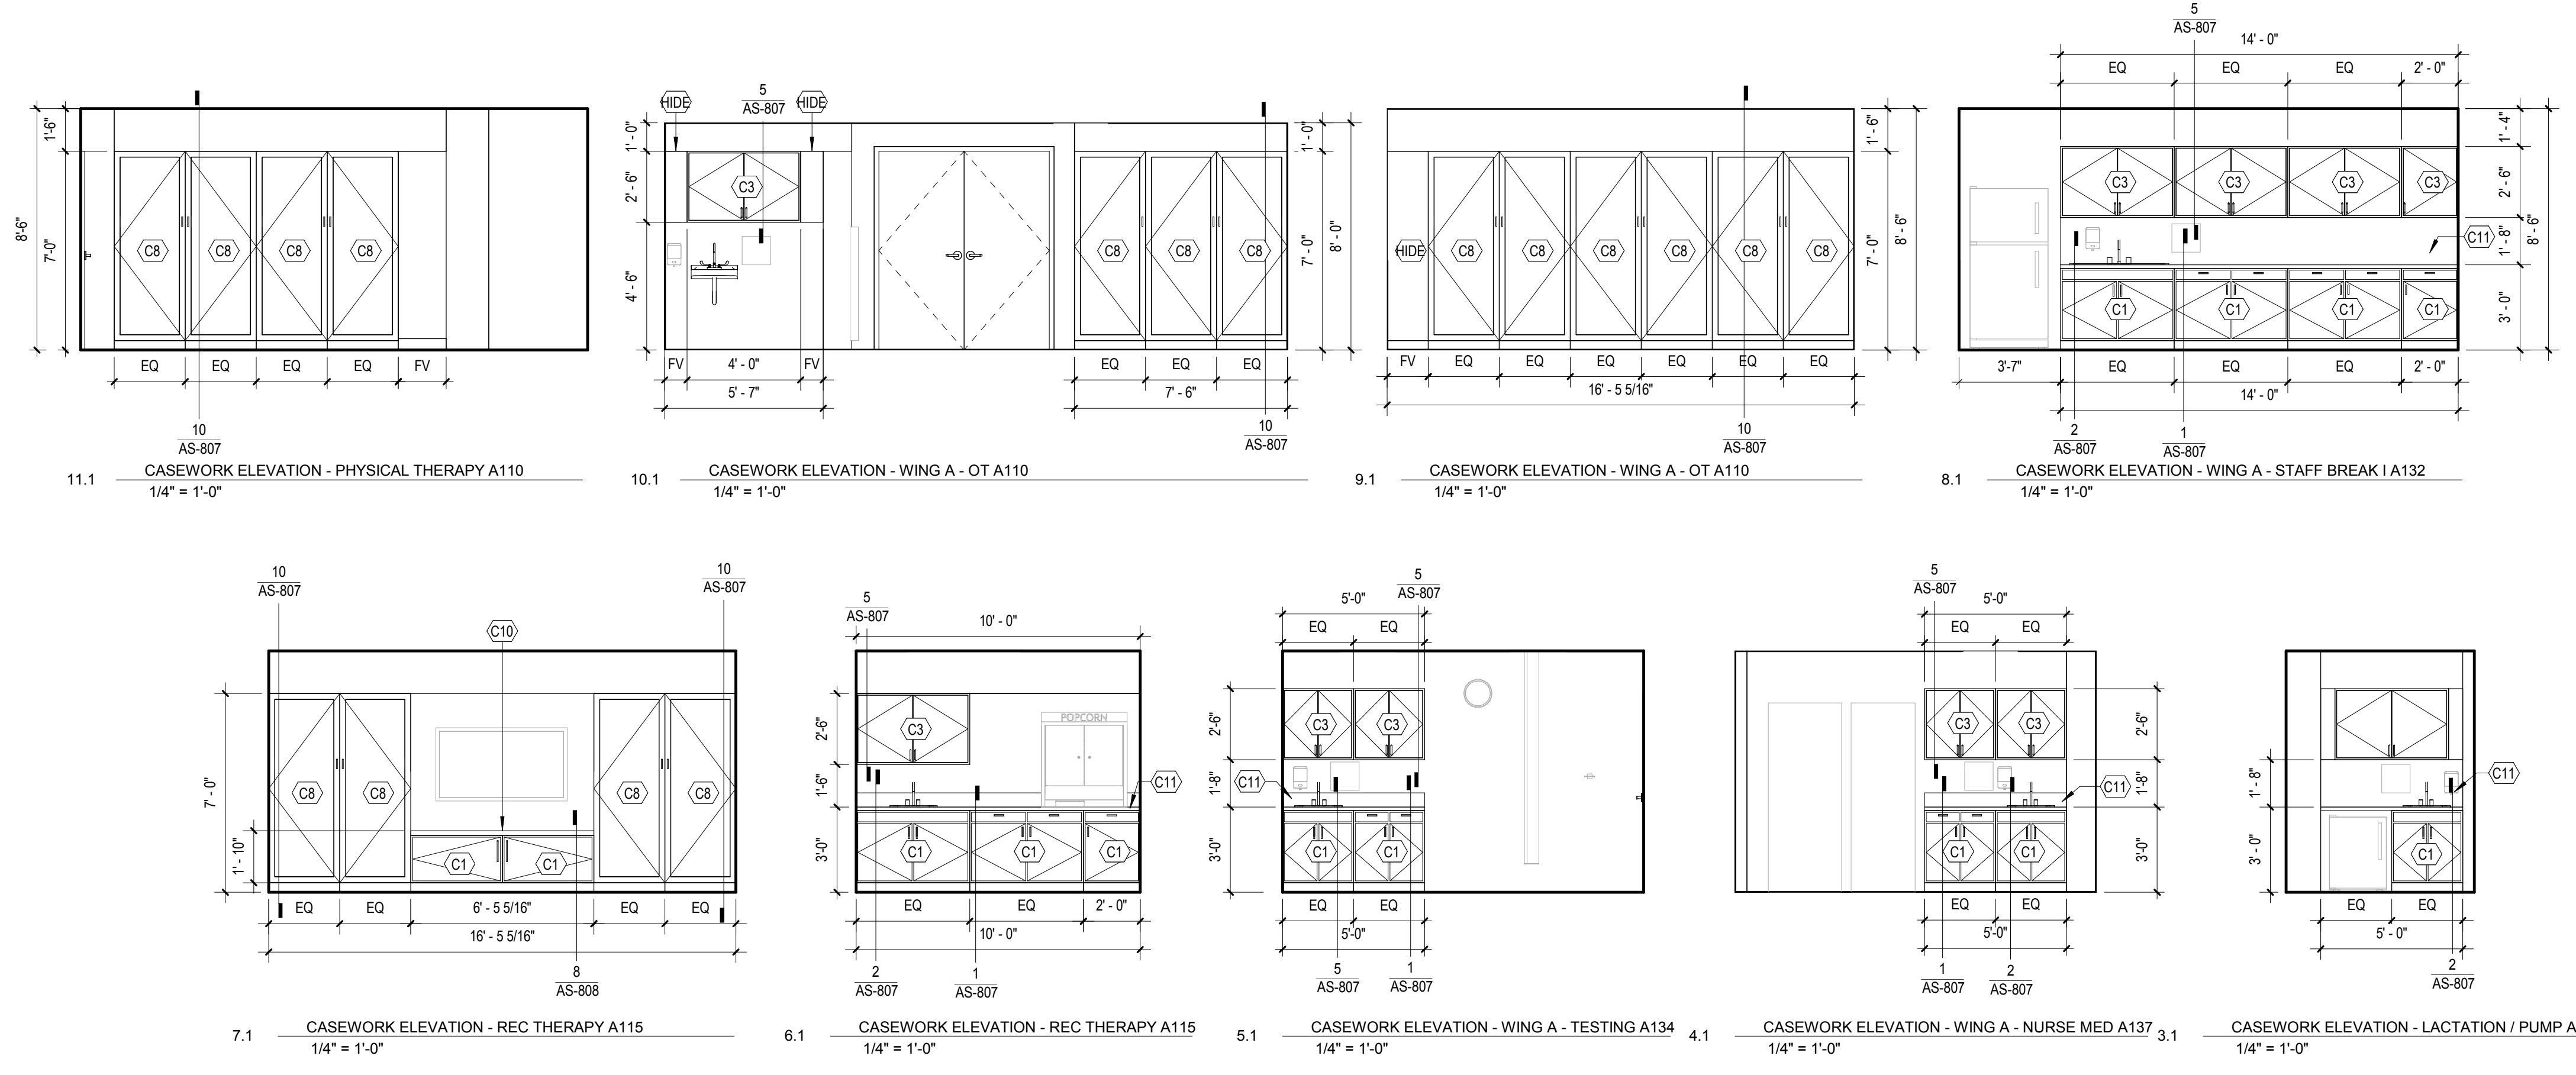

2 CASEWORK - WING A - PT / OT WORKSTATIONS

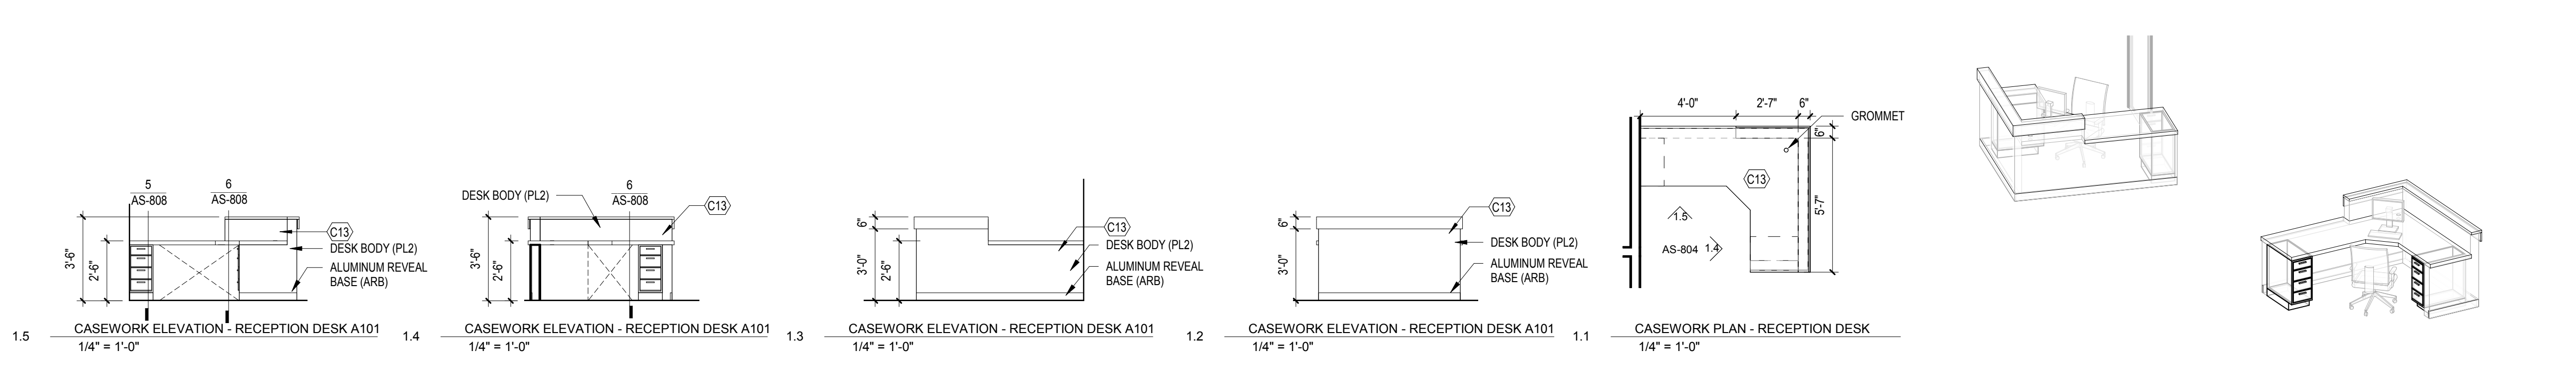

1 CASEWORK - WING A - RECEPTION DESK

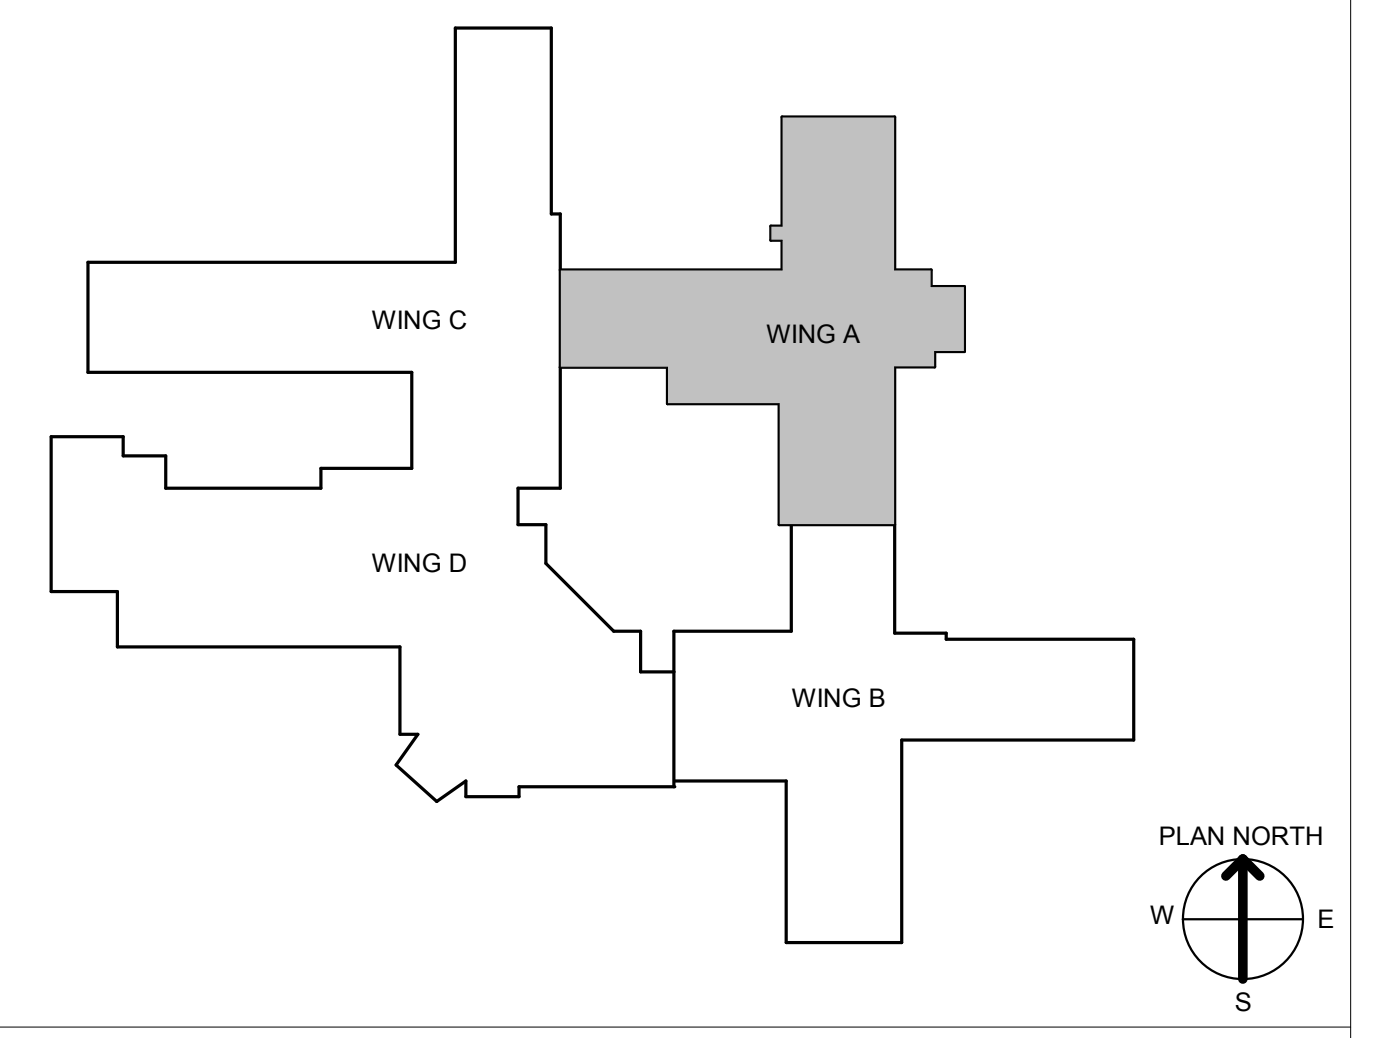



<p>CONSULTANT INFORMATION</p> <p>STRUCTURAL / CIVIL ENGINEER: STAND STRUCTURAL ENGINEERING, 11627 W. 112TH STREET, SUITE 200, OVERLAND PARK, KS 66210 (913) 214-2169</p> <p>MECHANICAL / ELECTRICAL / PLUMBING / TECHNICAL ENGINEER: SPUR DESIGN, 11020 KING STREET, SUITE 350, OVERLAND PARK, KS 66210 (405) 842-6100</p> <p>FIRE PROTECTION ENGINEER: POOLE FIRE PROTECTION, INC., 19910 W. 161ST STREET, OLATH, KS 66062 (913) 829-8650</p>		<p>ARCHITECT</p> <p>SPUR DESIGN</p> <p>313 SW 23rd Street, Overland Park, KS 66209 spur-design.com</p> <p>1002 King Street, Suite 300, Overland Park, KS 66209 spur-design.com</p> <p>KS ARCH REG. NO. A-1139, EXP. 12/31/2019 KS ENGR REG. NO. E-2586, EXP. 12/31/2019</p>		<p>Office of Construction and Facilities Management</p> <p>VA U.S. Department of Veteran Affairs</p>		<p>SHEET TITLE: CASEWORK - ENLARGED PLANS & ELEVATIONS</p> <p>APPROVED: PROJECT DIRECTOR</p>		<p>PROJECT PHASE: BID DOCUMENTS</p> <p>FULLY SPRINKLERED</p>		<p>PROJECT TITLE: RENOVATE A & B WING BUILDING 6</p> <p>PROJECT LOCATION: 2200 SW GAGE BLVD. TOPEKA, KS 66622</p> <p>DATE: 07/10/2019</p> <p>CHECKED BY: AWM</p> <p>DRAWN BY: JET</p>		<p>VA PROJECT NUMBER: 589A5-19-116</p> <p>BUILDING NUMBER: 6</p> <p>DRAWING NUMBER: 6-AS-804</p> <p>Dwg. 37 OF 160</p>	
---	--	---	--	---	--	--	--	--	--	---	--	--	--

ARCHITECTURAL CASEWORK NOTES


1. ALL CABINETS, CABINET FILLERS, AND SHELVING TO BE PLASTIC LAMINATE, FINISH AS SCHEDULED!
 2. COUNTERTOPS TO BE PLASTIC LAMINATE (PL3), SOLID SURFACE (SS), OR QUARTZ (QTZ), FINISH AS SCHEDULED!
 3. GENERAL CONTRACTOR TO PROVIDE METAL SUPPORT BLOCKING FOR BUILT-INS AS REQUIRED
 4. SUPPORT BRACKETS TO BE PLACED AT ALL OPEN COUNTERTOPS, MAXIMUM SPACING BETWEEN BRACKETS NOT TO EXCEED 24" ON CENTER, REFER TO BRACKET MANUFACTURER REQUIREMENTS.
- REFERENCE ARCHITECTURAL CASEWORK SCHEDULE, ARCHITECTURAL CASEWORK ENLARGED PLANS AND ELEVATIONS, & MATERIAL LEGEND.

ARCHITECTURAL CASEWORK SCHEDULE


MARK	CASEWORK	MATERIAL	FINISH / COMMENTS
C1	CASEWORK, BASE CABINET	PLASTIC LAMINATE	PL1
C2	CASEWORK, BASE CABINET	PLASTIC LAMINATE	PL2
C3	CASEWORK, UPPER CABINET	PLASTIC LAMINATE	PL2
C4	CASEWORK, UPPER CABINET	PLASTIC LAMINATE	PL2
C8	CASEWORK, TALL CABINET	PLASTIC LAMINATE	PL2
C9	CASEWORK, TALL CABINET	PLASTIC LAMINATE	PL2
C10	CASEWORK, COUNTERTOP	PLASTIC LAMINATE	PL1
C11	CASEWORK, COUNTERTOP	SOLID SURFACE	SS
C12	CASEWORK, COUNTERTOP	PLASTIC LAMINATE	PL3
C13	CASEWORK, COUNTERTOP	QUARTZ	QTZ
C14	CASEWORK, RESIDENT DESK	PLASTIC LAMINATE	COUNTER - PL3, CABINETS - PL1
C15	CASEWORK, RESIDENT DESK, BARIATRIC	PLASTIC LAMINATE	COUNTER - PL3, CABINETS - PL1
C16	CASEWORK, RESIDENT WARDROBE	PLASTIC LAMINATE	PL1
C17	CASEWORK, SHADOW BOX	PLASTIC LAMINATE & PLEXIGLASS	PL1, PLEXIGLASS
C18	PREMANUFACTURED FIREPLACE MANTEL	WOOD, PRIMED TO PAINT	P7

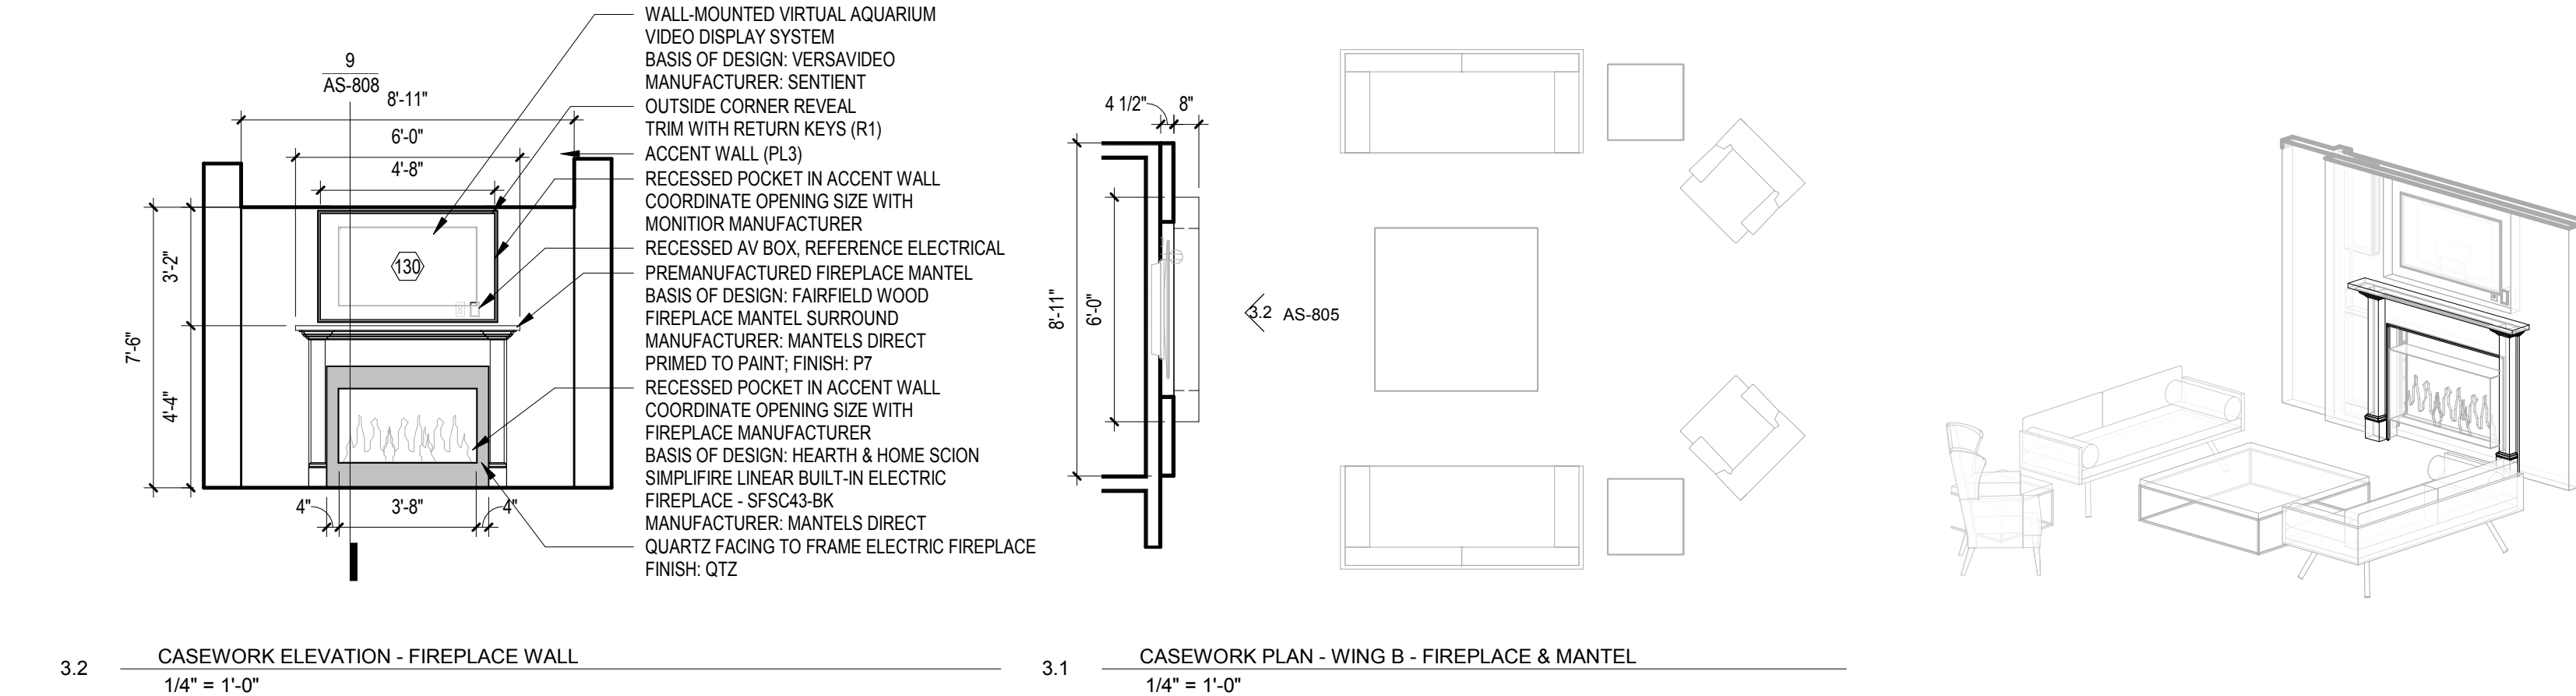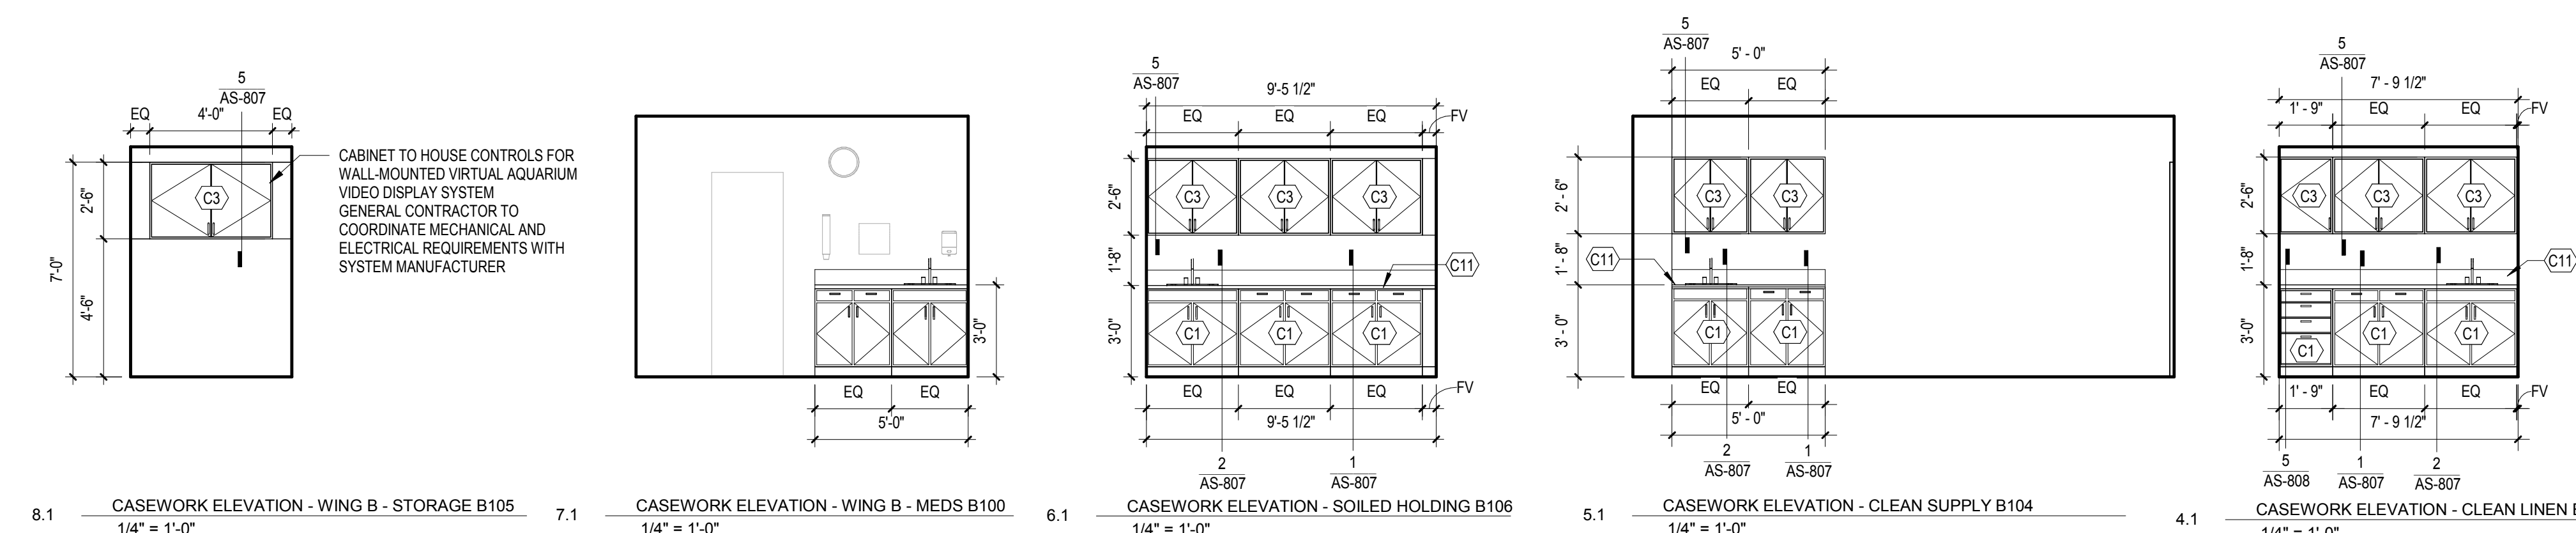


3 CASEWORK - WING B - FIREPLACE & MANTEL

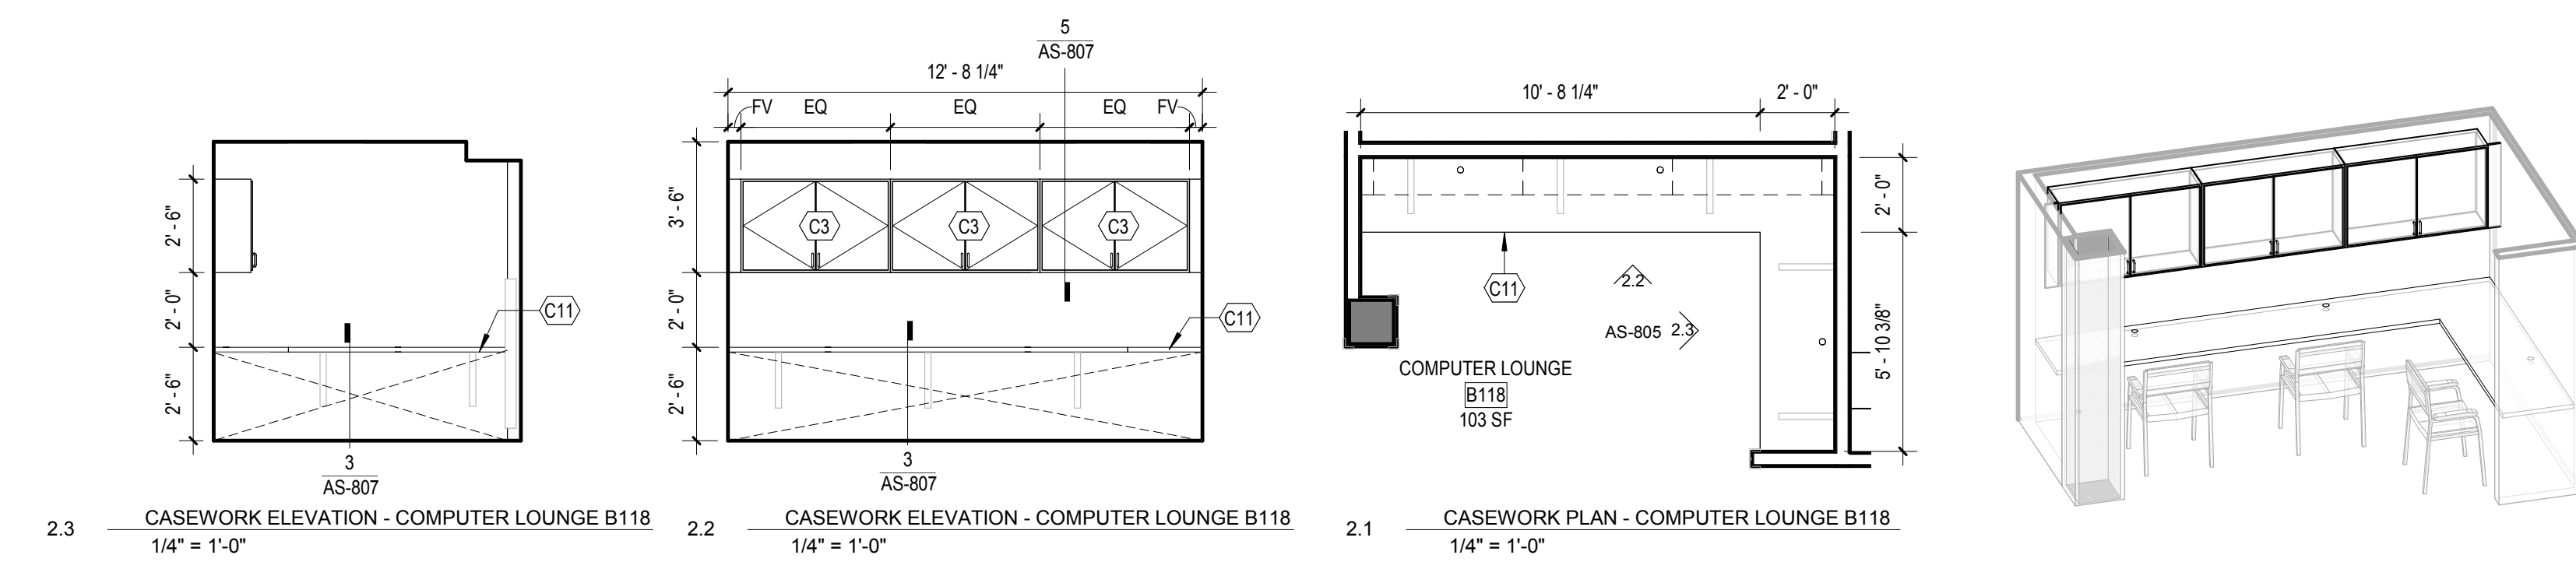

2 CASEWORK - WING B - COMPUTER LOUNGE B118

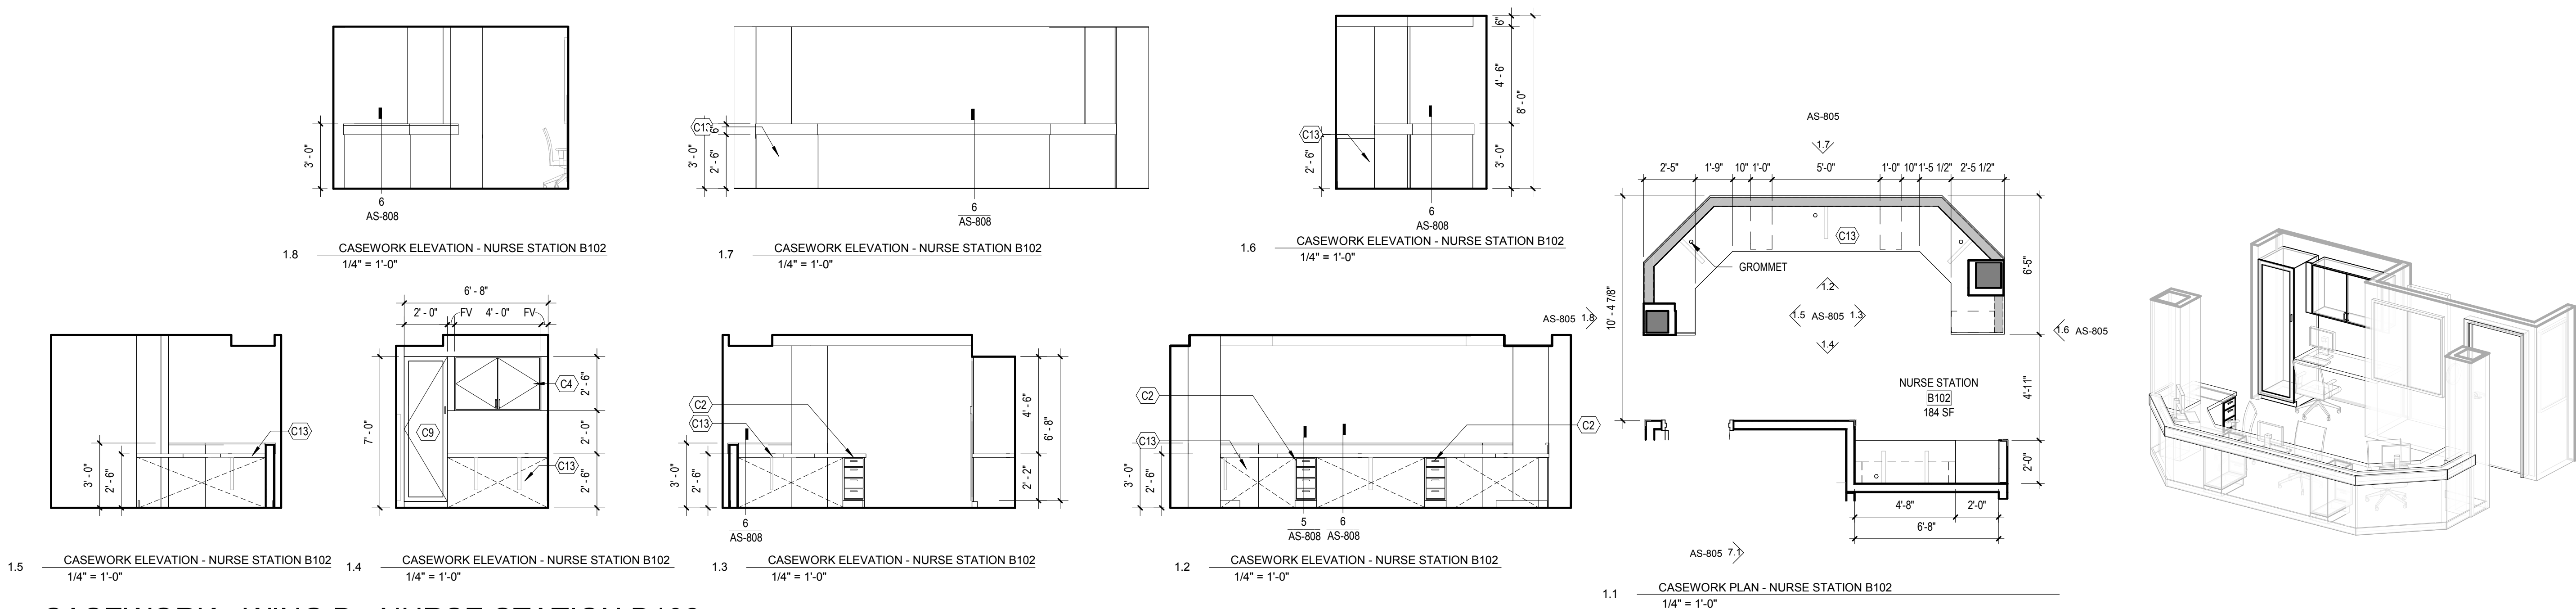

1 CASEWORK - WING B - NURSE STATION B102

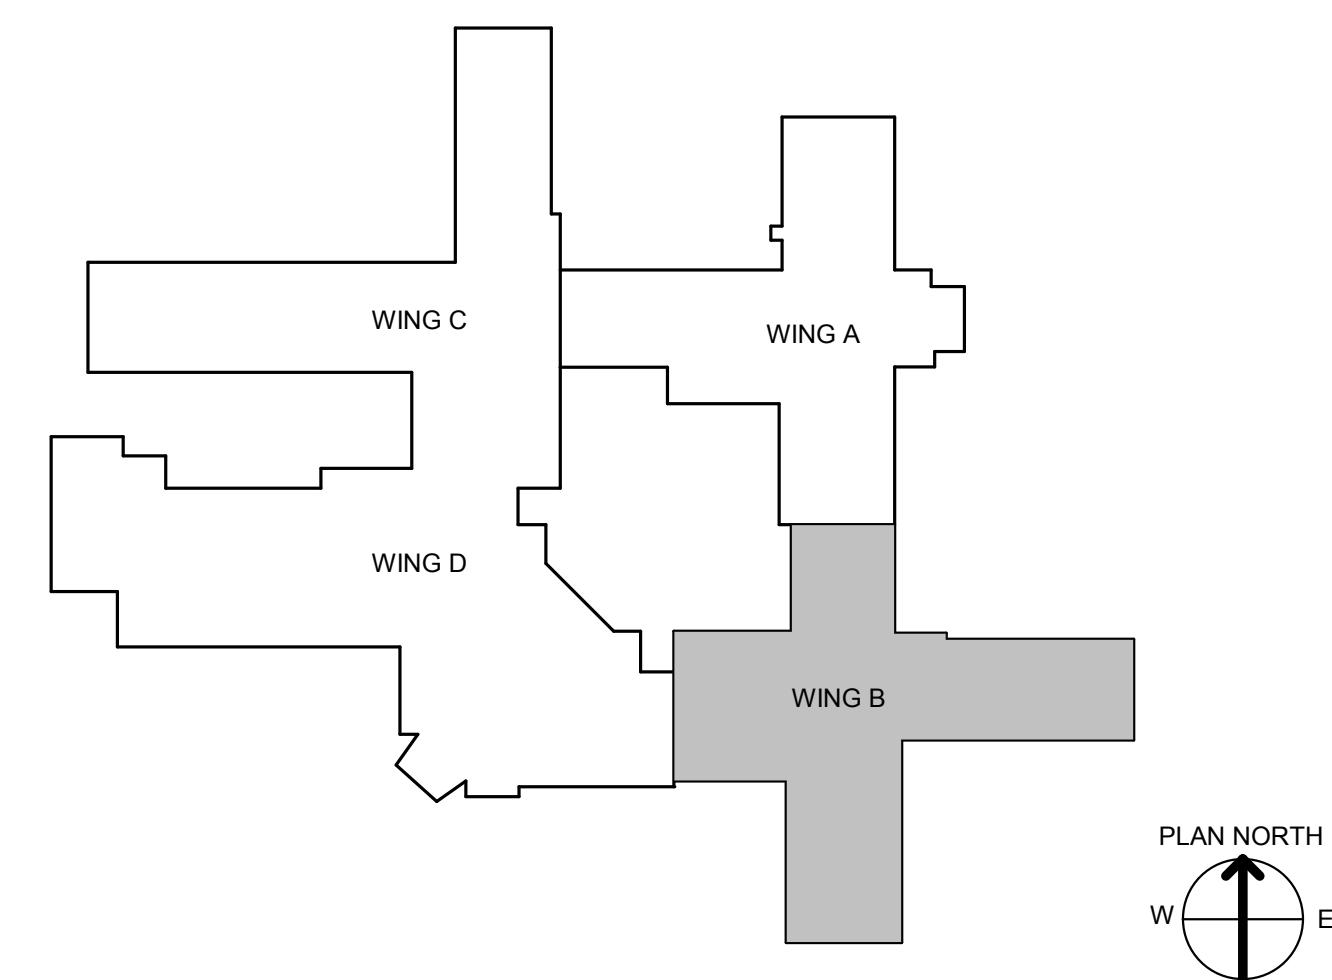




<p>CONSULTANT INFORMATION</p> <p>STRUCTURAL / CIVIL ENGINEER: STAND STRUCTURAL ENGINEERING, 11827 W. 112TH STREET, SUITE 200, OVERLAND PARK, KS 66210 (913) 214-2169</p> <p>MECHANICAL / ELECTRICAL / PLUMBING / TECHNICAL ENGINEER: SPUR DESIGN, 11020 KING STREET, SUITE 350, OVERLAND PARK, KS 66210 (405) 842-6100</p> <p>FIRE PROTECTION ENGINEER: POOLE FIRE PROTECTION, INC., 19910 W. 161ST STREET, OLATH, KS 66062 (913) 829-8650</p>		<p>ARCHITECT</p> <p>SPUR DESIGN</p> <p>313 5th Street, Overland Park, KS 66202 10020 King Street, Suite 300, Overland Park, KS 66202 spur-design.com</p> <p>KS ARCH REG. NO. A-1139, EXP. 12/31/2019 KS ENGR REG. NO. E-2586, EXP. 12/31/2019</p>		<p>Office of Construction and Facilities Management</p> <p>VA U.S. Department of Veteran Affairs</p>		<p>SHEET TITLE: CASEWORK - ENLARGED PLANS & ELEVATIONS</p> <p>APPROVED: PROJECT DIRECTOR</p>		<p>PROJECT PHASE: BID DOCUMENTS</p> <p>FULLY SPRINKLERED</p>		<p>PROJECT TITLE: RENOVATE A & B WING BUILDING 6</p> <p>PROJECT LOCATION: 2200 SW GAGE BLVD. TOPEKA, KS 66622</p> <p>DATE: 07/10/2019</p> <p>CHECKED BY: AWM</p> <p>DRAWN BY: JET</p>		<p>VA PROJECT NUMBER: 589A5-19-116</p> <p>BUILDING NUMBER: 6</p> <p>DRAWING NUMBER: 6-AS-805</p> <p>Dwg. 38 OF 160</p>	
---	--	---	--	---	--	--	--	--	--	---	--	--	--

ARCHITECTURAL CASEWORK NOTES


1. ALL CABINETS, CABINET FILLERS, AND SHELVING TO BE PLASTIC LAMINATE. FINISH AS SCHEDULED.
 2. COUNTERTOPS TO BE PLASTIC LAMINATE (PL3), SOLID SURFACE (SS), OR QUARTZ (QTZ). FINISH AS SCHEDULED.
 3. GENERAL CONTRACTOR TO PROVIDE METAL SUPPORT BLOCKING FOR BUILT-INS AS REQUIRED.
 4. SUPPORT BRACKETS TO BE PLACED AT ALL OPEN COUNTERTOPS. MAXIMUM SPACING BETWEEN BRACKETS NOT TO EXCEED 24" ON CENTER. REFER TO BRACKET MANUFACTURER REQUIREMENTS.
- *REFERENCE ARCHITECTURAL CASEWORK SCHEDULE, ARCHITECTURAL CASEWORK ENLARGED PLANS AND ELEVATIONS, & MATERIAL LEGEND.

ARCHITECTURAL CASEWORK SCHEDULE


MARK	CASEWORK	MATERIAL	FINISH / COMMENTS
C1	CASEWORK, BASE CABINET	PLASTIC LAMINATE	PL1
C2	CASEWORK, BASE CABINET	PLASTIC LAMINATE	PL2
C3	CASEWORK, UPPER CABINET	PLASTIC LAMINATE	PL2
C4	CASEWORK, UPPER CABINET	PLASTIC LAMINATE	PL2
C8	CASEWORK, TALL CABINET	PLASTIC LAMINATE	PL2
C9	CASEWORK, TALL CABINET	PLASTIC LAMINATE	PL2
C10	CASEWORK, COUNTERTOP	PLASTIC LAMINATE	PL1
C11	CASEWORK, COUNTERTOP	SOLID SURFACE	SS
C12	CASEWORK, COUNTERTOP	PLASTIC LAMINATE	PL3
C13	CASEWORK, COUNTERTOP	QUARTZ	QTZ
C14	CASEWORK, RESIDENT DESK	PLASTIC LAMINATE	COUNTER - PL3, CABINETS - PL1
C15	CASEWORK, RESIDENT DESK, BARIATRIC	PLASTIC LAMINATE	COUNTER - PL3, CABINETS - PL1
C16	CASEWORK, RESIDENT WARDROBE	PLASTIC LAMINATE	PL1
C17	CASEWORK, SHADOW BOX	PLASTIC LAMINATE & PLEXIGLASS	PL1, PLEXIGLASS
C18	PREMANUFACTURED FIREPLACE MANTEL	WOOD, PRIMED TO PAINT	P7

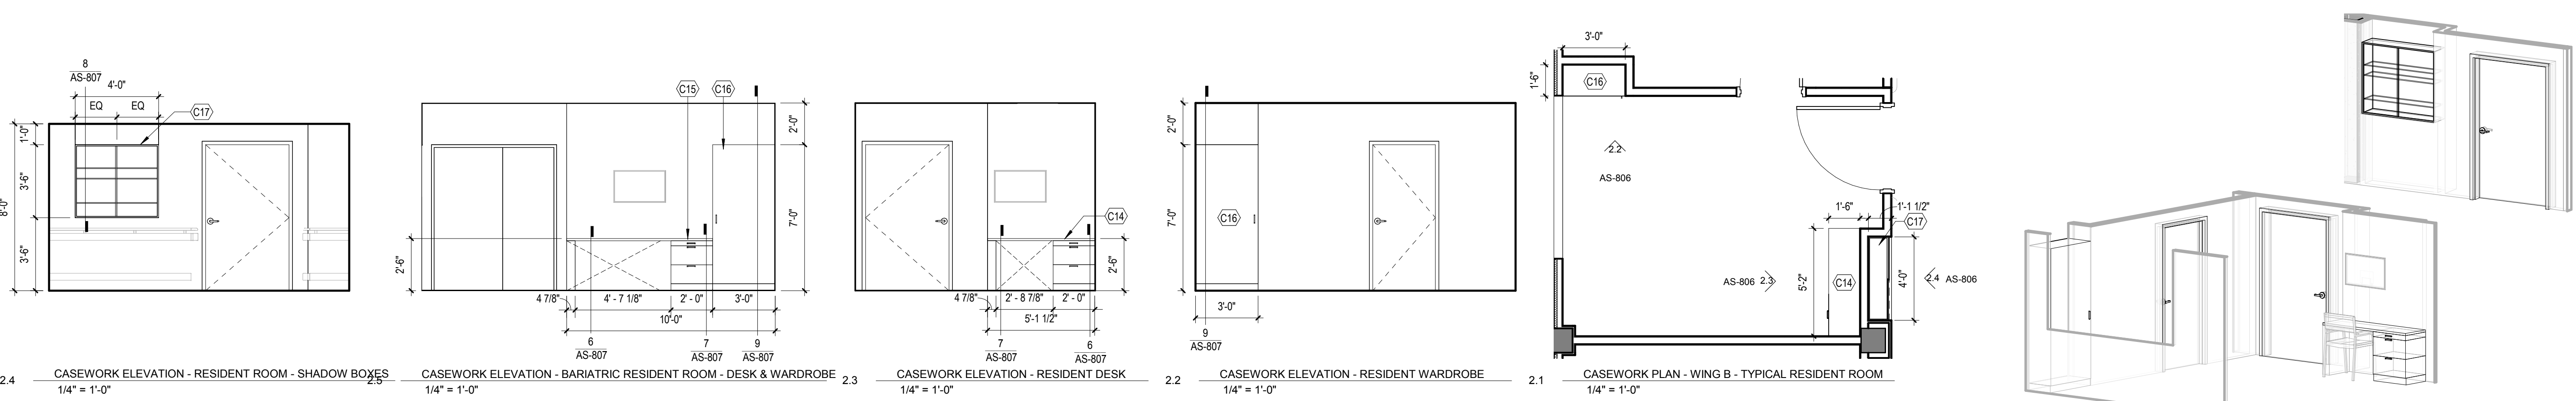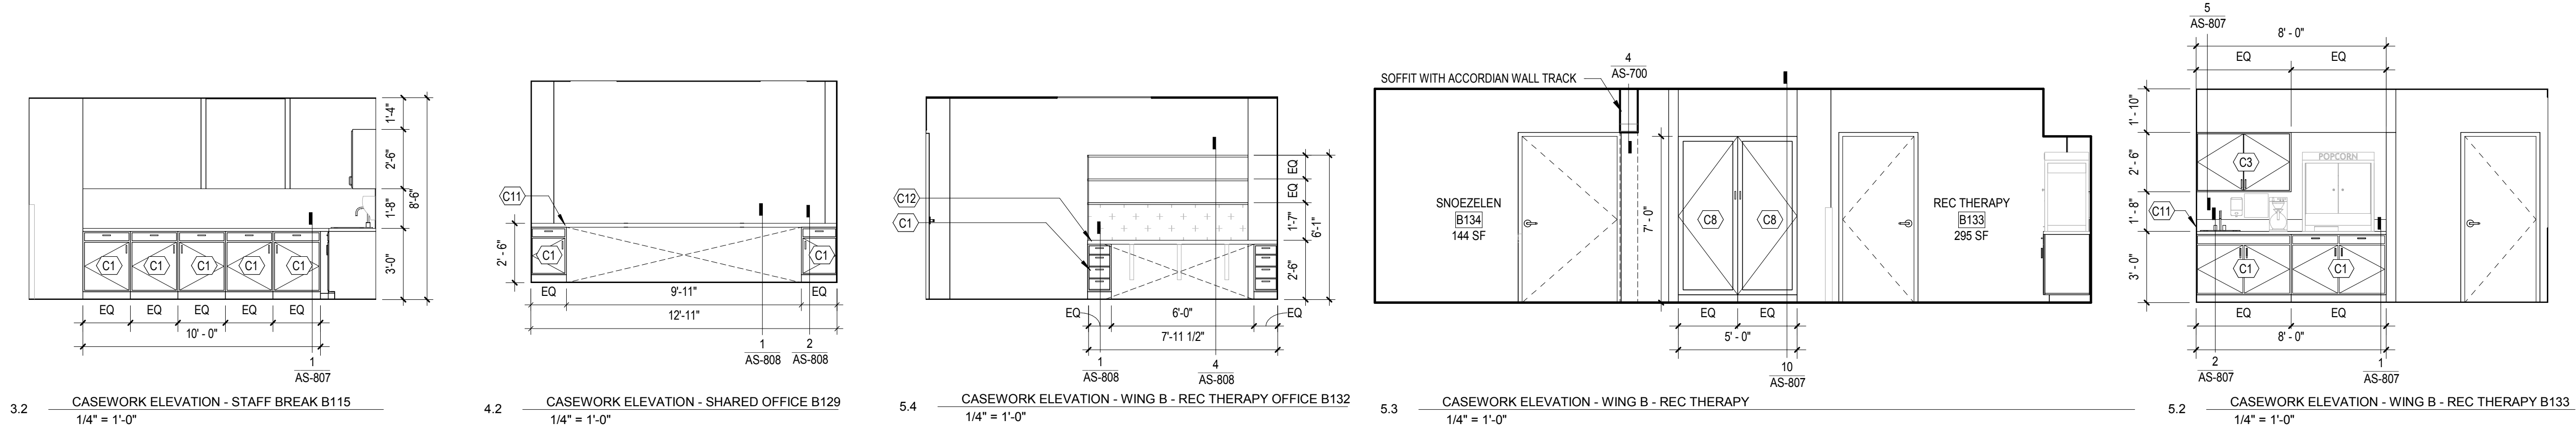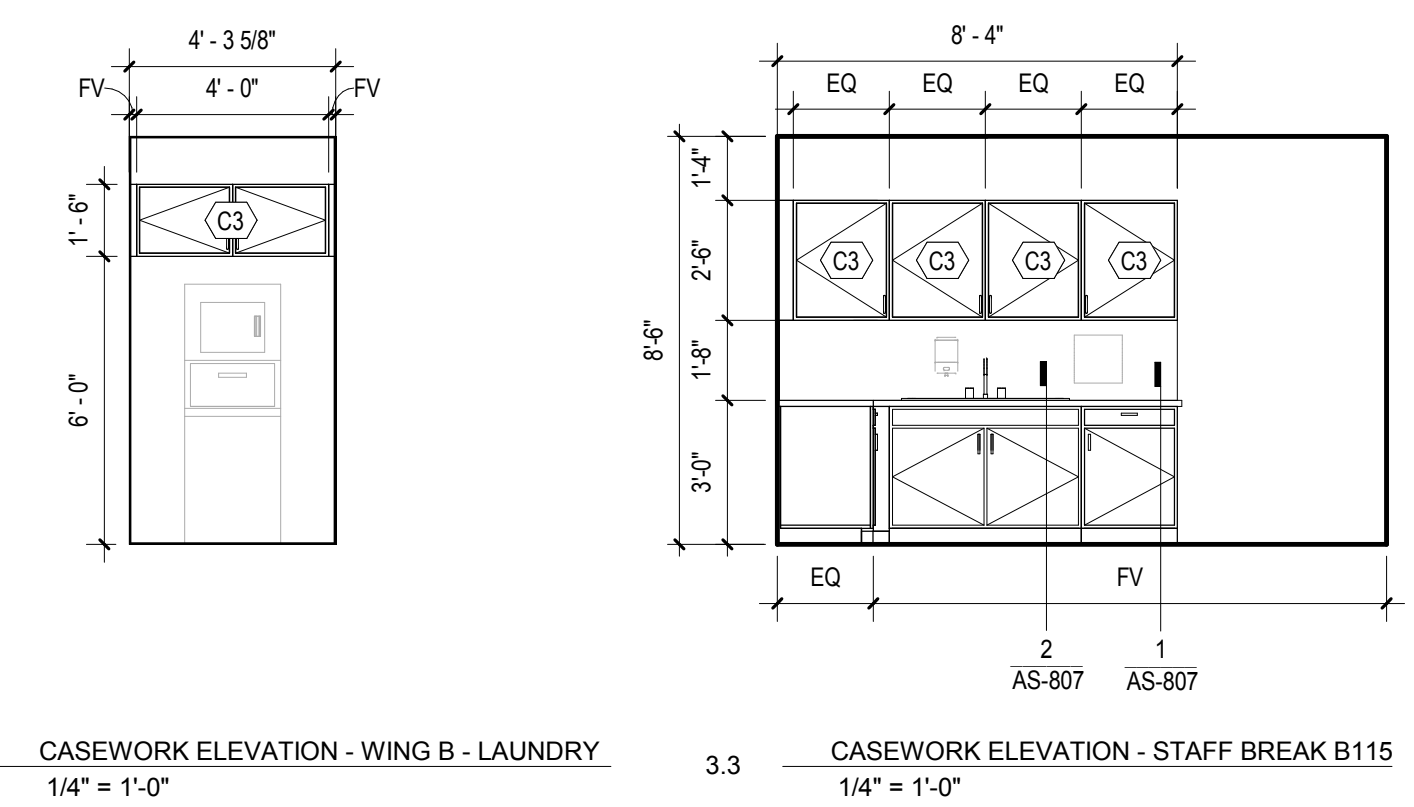

2 CASEWORK - WING B - RESIDENT WARDROBE, DESK, SHADOW BOX

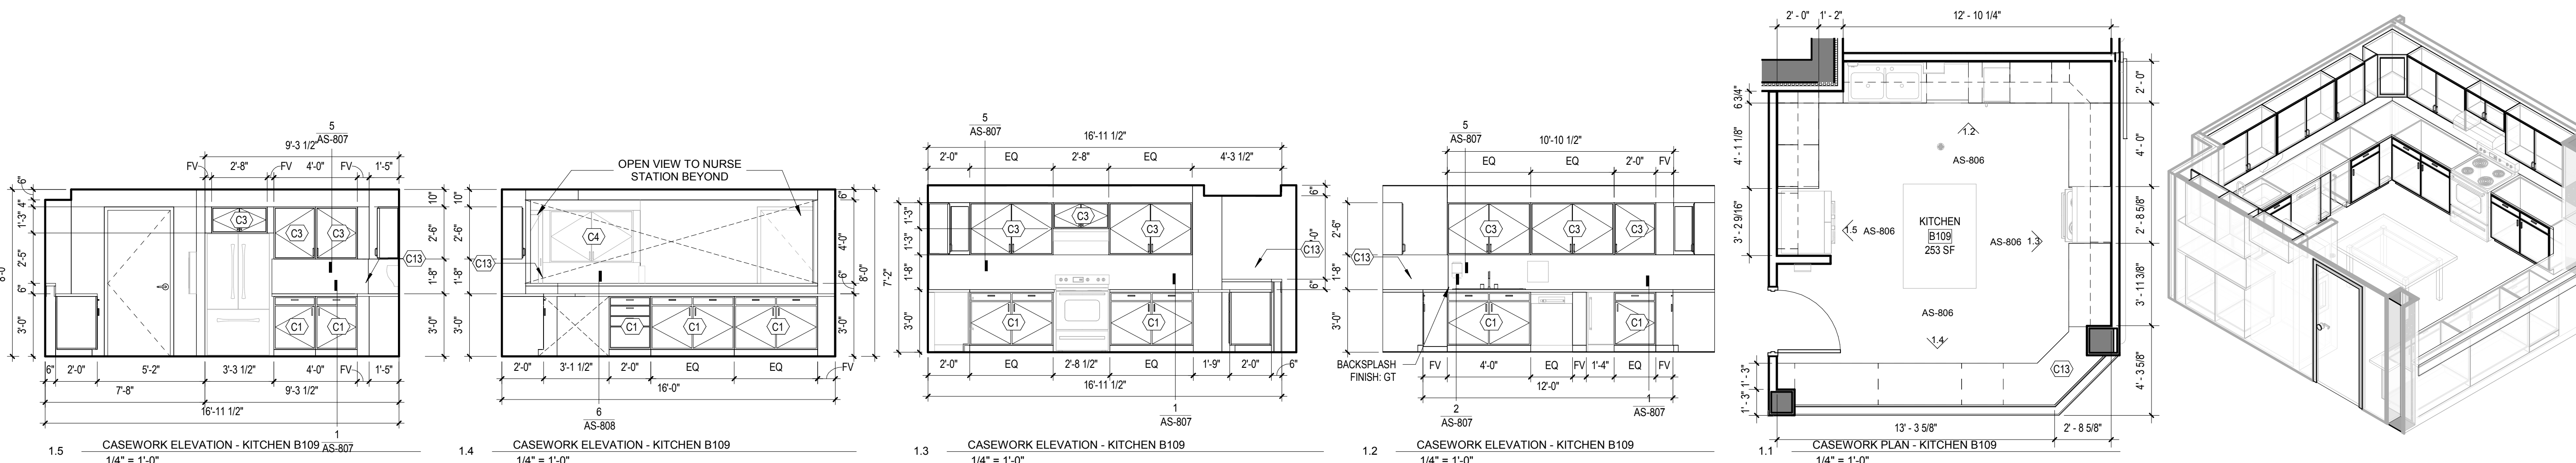

1 CASEWORK - WING B - KITCHEN

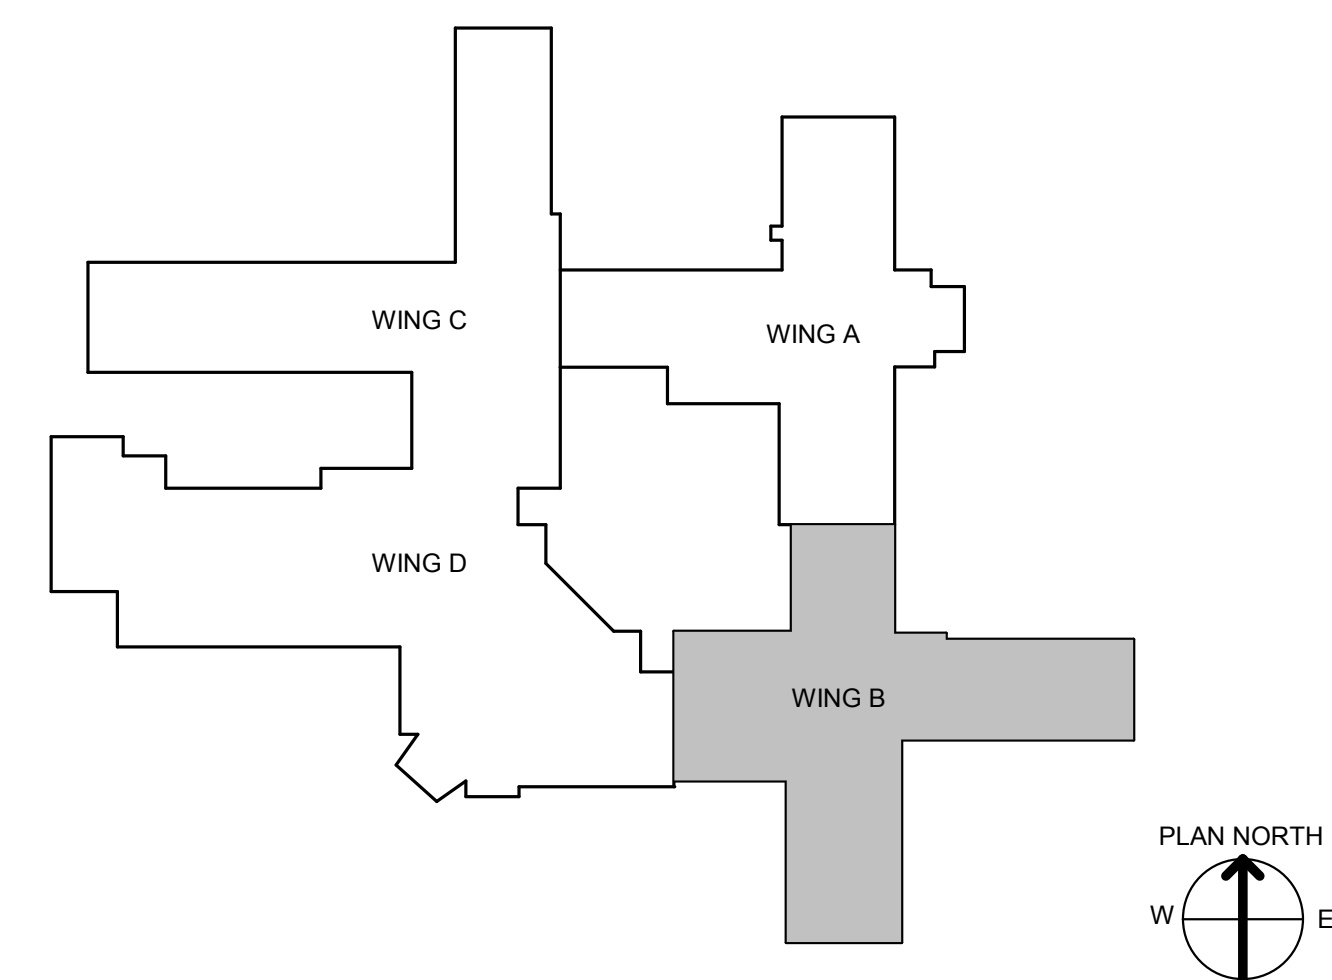

Revision #	Date

CONSULTANT INFORMATION

<p>STRUCTURAL / CIVIL ENGINEER</p> <p>STAND STRUCTURAL ENGINEERING 11927 W. 112TH STREET, SUITE 200 OVERLAND PARK, KS 66210 (913) 214-2169</p>	<p>MECHANICAL / ELECTRICAL / PLUMBING / TECHNICAL ENGINEER</p> <p>SPUR DESIGN 11020 KING STREET, SUITE 350 OVERLAND PARK, KS 66210 (405) 842-6100</p>	<p>FIRE PROTECTION ENGINEER</p> <p>POOLE FIRE PROTECTION, INC. 19910 W. 161ST STREET OLATH, KS 66062 (913) 829-8650</p>
--	---	---

ARCHITECT

SPUR DESIGN

333 SW 23rd Street
Overland Park, KS 66209
spur-design.com

10020 King Street, Suite 300
Overland Park, KS 66210
spur-design.com

KS ARCH REG. NO. A-1139, EXP. 12/31/2019
KS ENGR REG. NO. E-2586, EXP. 12/31/2019

6728
JULY 10, 2019
KANSAS ARCHITECT

Office of Construction and Facilities Management

VA U.S. Department of Veteran Affairs

SHEET TITLE
CASEWORK - ENLARGED PLANS & ELEVATIONS

APPROVED: PROJECT DIRECTOR

PROJECT PHASE
BID DOCUMENTS

FULLY SPRINKLERED

PROJECT TITLE
RENOVATE A & B WING BUILDING 6

PROJECT LOCATION
**2200 SW GAGE BLVD.
TOPEKA, KS 66622**

DATE
07/10/2019

CHECKED BY
AWM

DRAWN BY
JET

VA PROJECT NUMBER
589A5-19-116

BUILDING NUMBER
6

DRAWING NUMBER
6-AS-806


Dwg. 39 OF 160

GENERAL MILLWORK NOTES


1. SCRIBE COUNTERTOPS TO WALL FOR SEAMLESS INSTALLATION.
2. PROVIDE METAL BLOCKING AS REQUIRED.
3. ALL HARDWARE TO BE SELECTED BY OWNER.
4. COUNTERTOP SUPPORT PLATES TO BE PLACED AT ALL OPEN COUNTERTOPS - 18" 24" ON CENTER.

BASIS OF DESIGN

1. COUNTERTOP SUPPORT PLATE
FEDERAL BRACE - LIBERTY HIDDEN COUNTERTOP SUPPORT PLATE
SIZE 8" - 20" LENGTH, 3" WIDTH, 1/4" - 1/2" THICK
FINISH FLAT WHITE

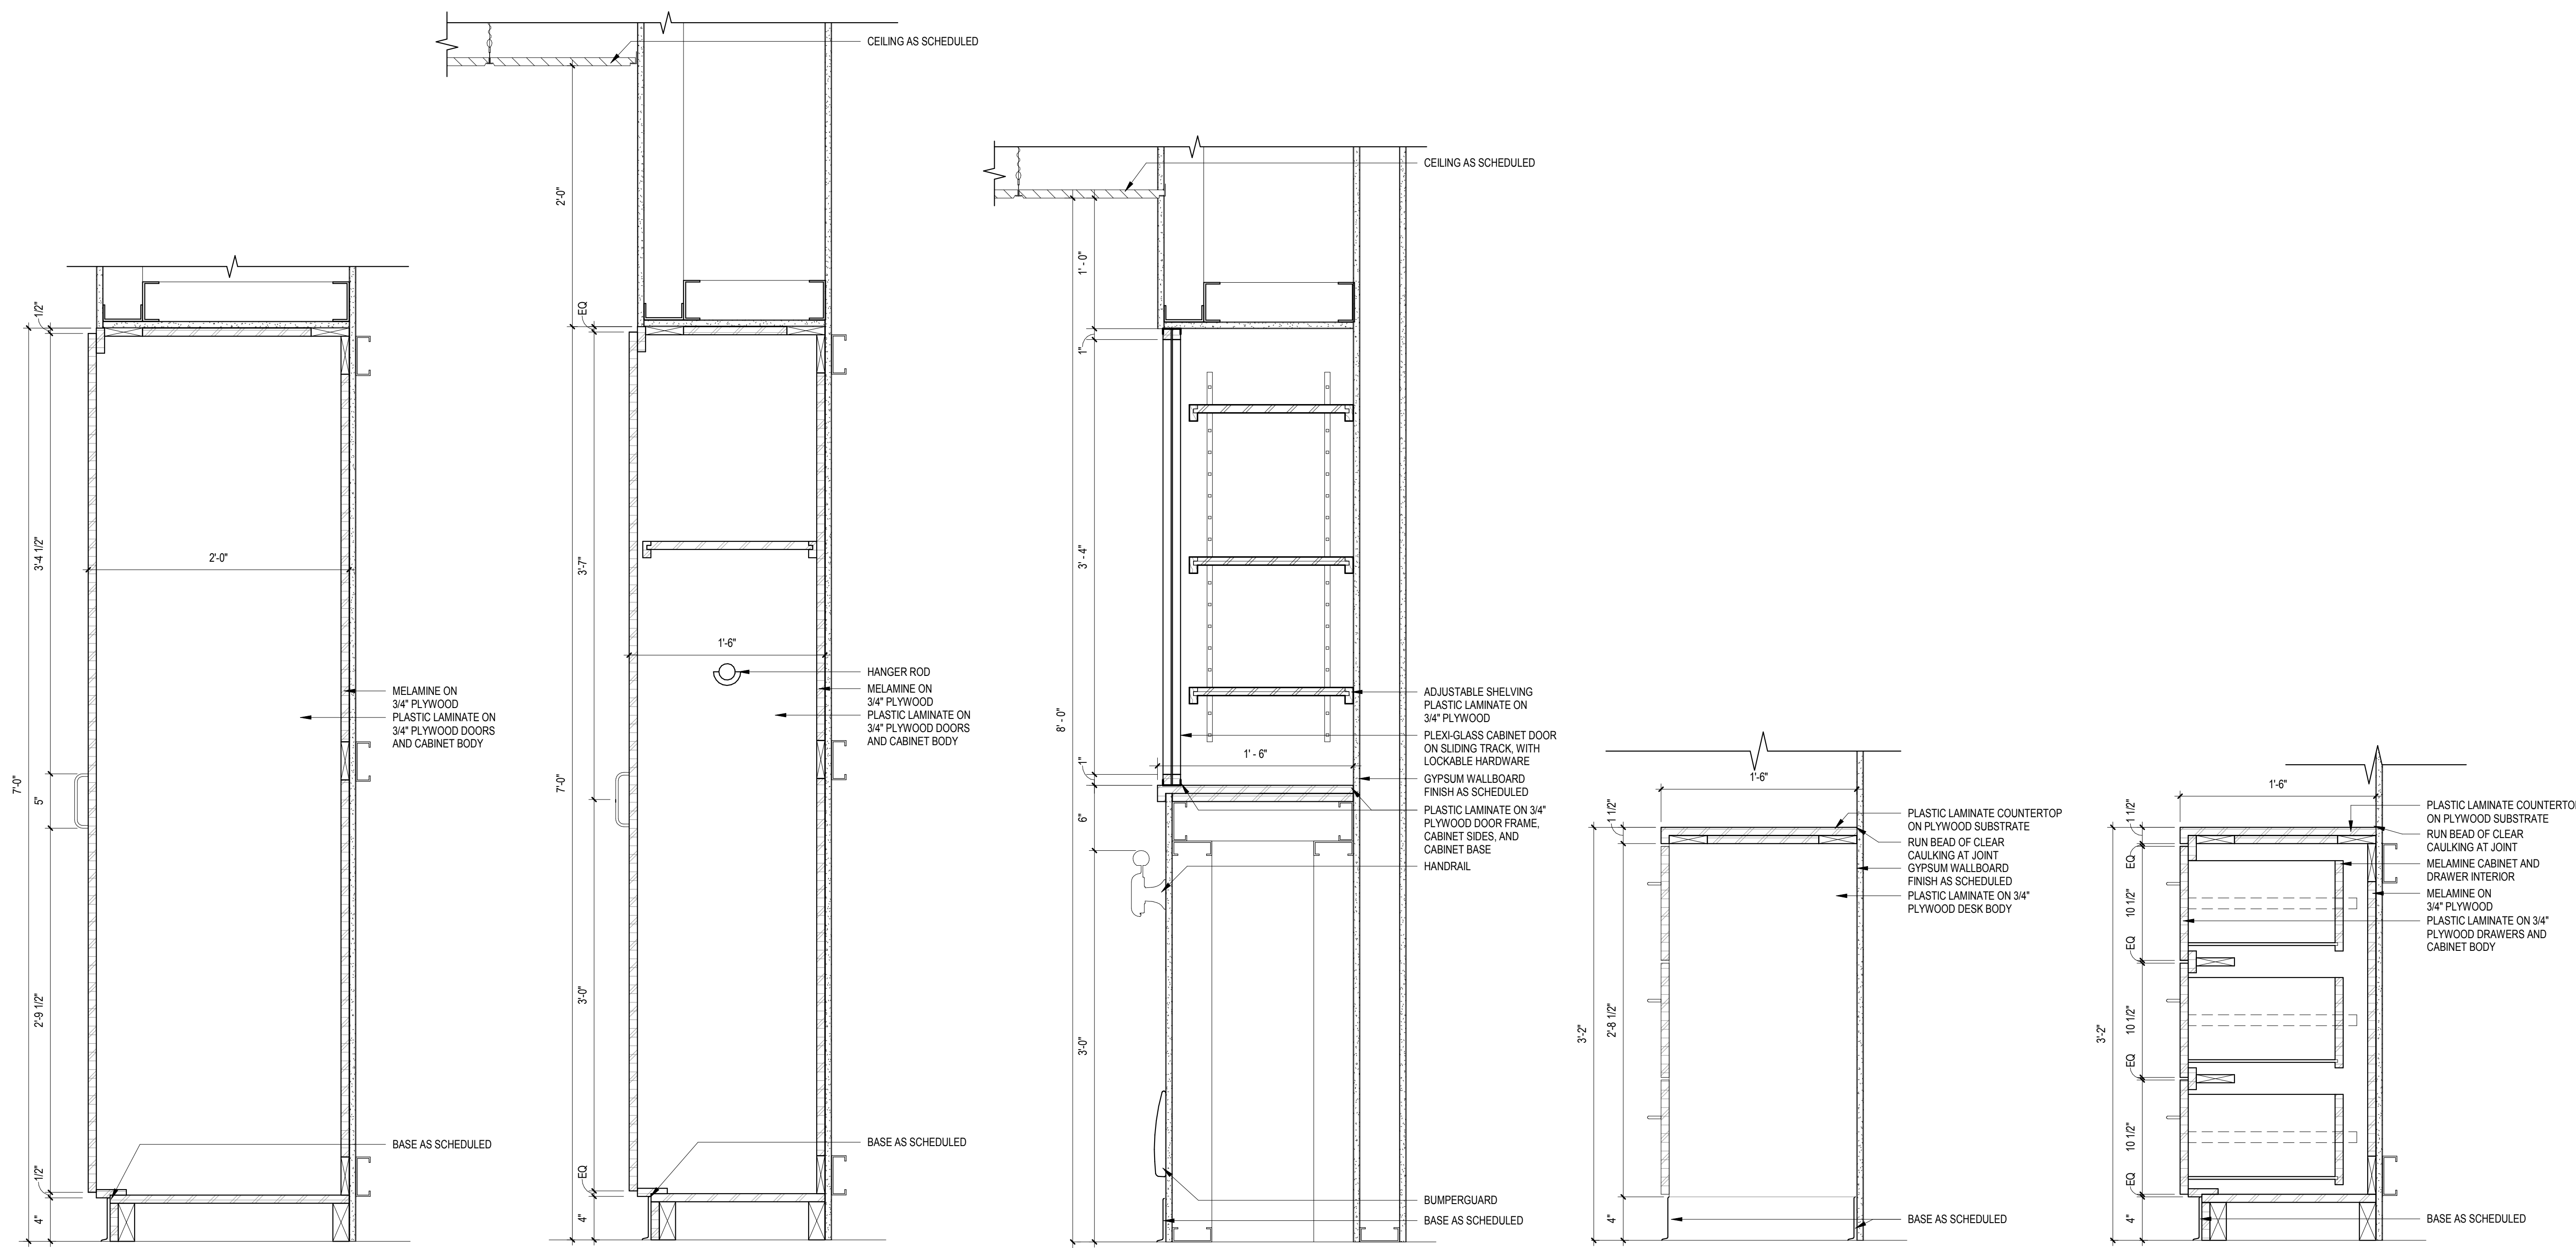

10 TALL CABINET, SINGLE DOOR 1 1/2" = 1'-0" 9 RESIDENT WARDROBE 1 1/2" = 1'-0" 8 RESIDENT, SHADOW BOX 1 1/2" = 1'-0" 7 RESIDENT DESK, OPEN SPACE 1 1/2" = 1'-0" 6 RESIDENT DESK, DRAWERS 1 1/2" = 1'-0"

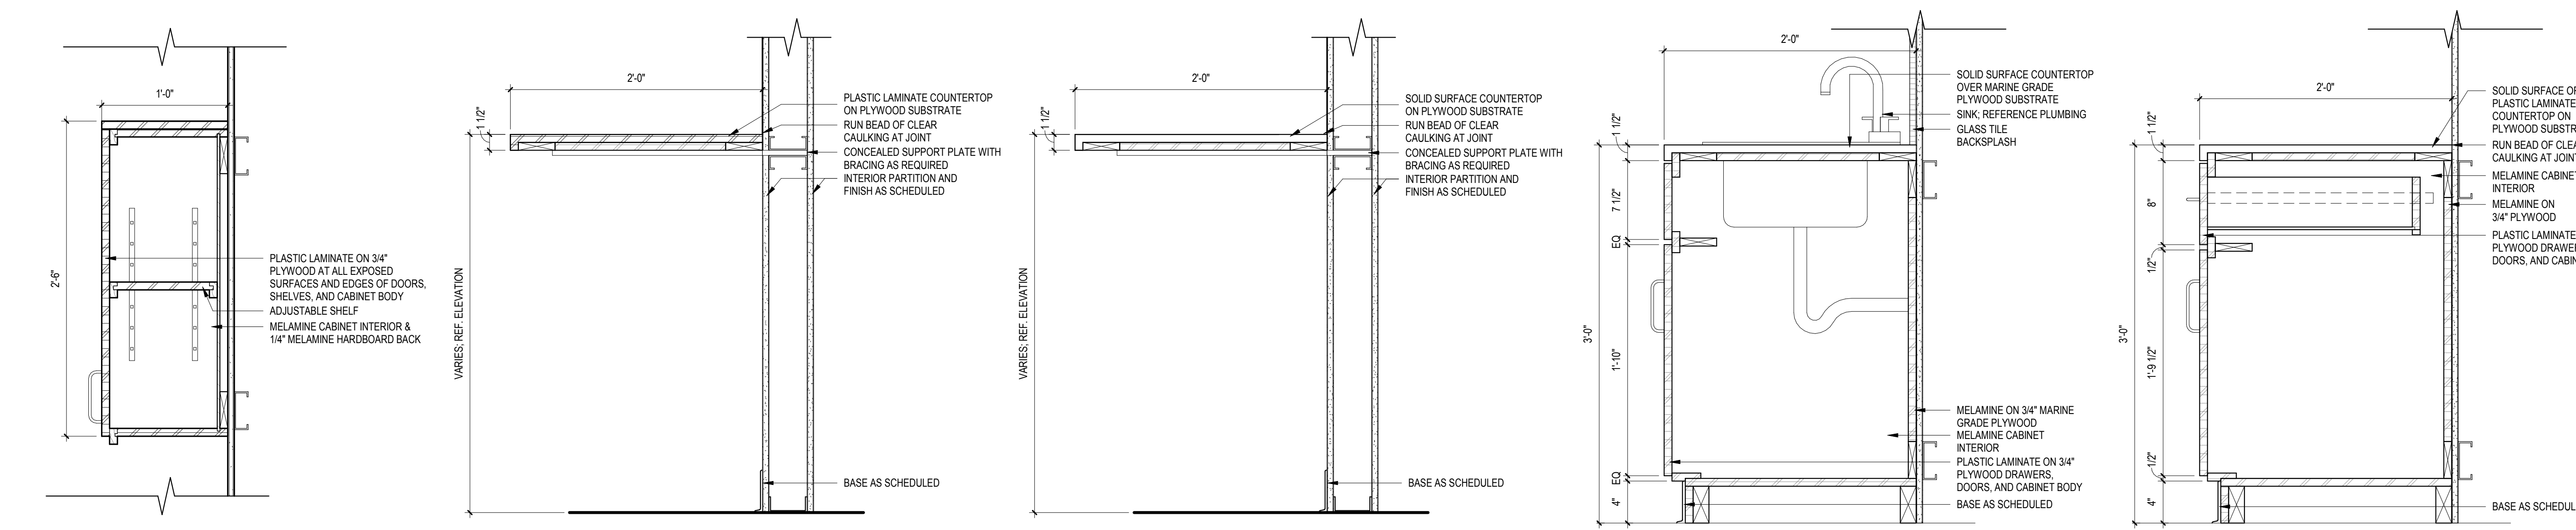

5 CABINET, UPPER 1 1/2" = 1'-0" 4 COUNTERTOP (PL) 1 1/2" = 1'-0" 3 COUNTERTOP (SS) 1 1/2" = 1'-0" 2 CABINET, LOWER @ SINK 1 1/2" = 1'-0" 1 CABINET, LOWER 1 1/2" = 1'-0"

<p>CONSULTANT INFORMATION</p> <p>STRUCTURAL / CIVIL ENGINEER: STAND STRUCTURAL ENGINEERING, 11927 W. 112TH STREET, SUITE 200, OVERLAND PARK, KS 66210 (913) 214-2169</p> <p>MECHANICAL / ELECTRICAL / PLUMBING / TECHNICAL ENGINEER: SPUR DESIGN, 11020 KING STREET, SUITE 350, OVERLAND PARK, KS 66210 (405) 842-6100</p> <p>FIRE PROTECTION ENGINEER: POOLE FIRE PROTECTION, INC., 19910 W. 161ST STREET, OLATH, KS 66062 (913) 829-8650</p>		<p>ARCHITECT</p> <p>SPUR DESIGN</p> <p>333 SW 23rd Street, Overland Park, KS 66209 spur-design.com</p> <p>10020 King Street, Suite 300, Overland Park, KS 66209 spur-design.com</p> <p>KS ARCH REG. NO. A-1139, EXP. 12/31/2019 KS ENGR REG. NO. E-2586, EXP. 12/31/2019</p>		<p>Office of Construction and Facilities Management</p> <p>VA U.S. Department of Veteran Affairs</p>		<p>SHEET TITLE: MILLWORK DETAILS</p> <p>APPROVED: PROJECT DIRECTOR</p>		<p>PROJECT PHASE: BID DOCUMENTS</p> <p>FULLY SPRINKLERED</p>		<p>PROJECT TITLE: RENOVATE A & B WING BUILDING 6</p> <p>PROJECT LOCATION: 2200 SW GAGE BLVD. TOPEKA, KS 66622</p> <p>DATE: 07/10/2019</p>		<p>VA PROJECT NUMBER: 589A5-19-116</p> <p>BUILDING NUMBER: 6</p> <p>DRAWING NUMBER: 6-AS-807</p> <p>Dwg. 40 OF 160</p>	
Revision #	Date							CHECKED BY: AWM	DRAWN BY: JET				

STRUC ABBREVIATIONS

+/	PLUS OR MINUS
A.R.	ANCHOR ROD
ADDNL	ADDITIONAL
ADJ	ADJACENT
AESS	ARCHITECTURALLY EXPOSED STRUC
STL	STRUCTURAL
AFF	ABOVE FINISH FLOOR
ALT	ALTERNATE
ARCH	ARCHITECT OR ARCHITECTURAL
B/	BOTTOM OF
BTW	BETWEEN
BLDG	BUILDING
BLKG	BLOCKING
BM	BEAM
BOT	BOTTOM
BRG	BEARING
CF	COLD FORMED METAL FRAMING
CHKD	CHECKED
CIP	CAST IN PLACE
CJ	CONTROL JOINT
CJP	COMPLETE JOINT PENETRATION
CL	CENTERLINE
CLR	CLEAR
COL	COLUMN
CONC	CONCRETE
CONN	CONNECTION
CONT	CONTINUOUS
CTR	CENTER
db	DIA OF REIN BAR, DIA OF BOLT
DBA	DEFORMED BAR ANCHOR
DBL	DOUBLE
DIA	DIAMETER
DIAG	DIAGONAL
DIR	DIRECTION
DWL	DOWN
EA	EACH
EE	EXTENDED END
EJ	EXPANSION JOINT
EL	ELEVATION
ENGR	ENGINEER
EOD	EDGE OF DECK
EOS	EDGE OF SLAB
EQ	EQUAL
EQP	EQUIPMENT
EW	EACH WAY
EXIST	EXISTING
EXT	EXTERIOR
F.V.	FIELD VERIFY
FLG	FLANGE
FLR	FLOOR
FND	FOUNDATION
FS	FAR SIDE
FTG	FOOTING
G.C.	GENERAL CONTRACTOR
GA	GAGE
GALV	GALVANIZED
GB	GRADE BEAM
HORIZ	HORIZONTAL
HSA	HEADED STUD ANCHOR
HSS	HOLLOW STRUCTURAL SECTION
IF	INSIDE FACE
INT	INTERIOR
JST	JOIST
K	KIPS (1000 LBS)
LCE	COMPRESSION EMBEDMENT LENGTH
LCS	COMPRESSION LAP SPlice LENGTH
LLH	LONG LEG HORIZONTAL
LLV	LONG LEG VERTICAL
LTE	TENSION EMBEDMENT LENGTH
LTS	TENSION LAP SPlice LENGTH
LW	LIGHTWEIGHT
MAS	MASONRY
MATL	MATERIAL
MCRF	MANUFACTURER
MTL	METAL
NIC	NOT IN CONTRACT
NS	NEAR SIDE
NSH	NON-SHINK
NTS	NOT TO SCALE
O.F.	OUTSIDE FACE
OC	ON CENTER
OPP	OPPOSITE
OVS	OVERSIZED
PC	PRECAST
PAF	POWDER ACTUATED FASTENER
PEN	PENETRATION
PERP	PERPENDICULAR
PL	PLATE
PLF	POUNDS PER LINEAL FOOT
PMB	PRE-ENGINEERED METAL BUILDING
PREFAB	PREFABRICATED
PRELIM	PRELIMINARY
PSF	POUNDS PER SQUARE FOOT
PSI	POUNDS PER SQUARE INCH
R.F.	RIGID FRAME
RC	REINFORCED CONCRETE
REF	REFER TO
REIN	REINFORCING
REQD	REQUIRED
SC	SLIP CRITICAL
SOS	SELF DRILLING SCREW
SM	SIMILAR
SLV	SHORT LEG VERTICAL
SOG	SLAB ON GRADE
SO	SQUARE
SS	STAINLESS STEEL
STR	STIRRUPS
STL	STEEL
SW	SHEAR WALL
SYM	SYMMETRICAL
T&B	TOP AND BOTTOM
T/	TOP OF
TOS	TOP OF STEEL
TRANS	TRANSVERSE
TYP	TYPICAL
UNO	UNLESS NOTED OTHERWISE
VERT	VERTICAL
W	WITH
WO	WITHOUT
WF	WIDE FLANGE
WP	WORK POINT
WWF	WELDED WIRE FABRIC

STRUCTURAL DESIGN CRITERIA (2012 IBC AND ASCE 7-10):

- BUILDING OCCUPANCY RISK CATEGORY II.
- LIVE LOADS (UNIFORM (PSF) / POINT LOADS (KIPS))
 - ROOF: 20 PSF / 3000
 - OFFICES: 50 PSF + 15 PSF PARTITIONS / 2.0 K
 - UPPER LEVEL CORRIDORS: 80 PSF / 2.0 K
 - GROUND LEVEL SLAB: 100 PSF / 2.0 K
 - STAIRS: 100 PSF / 300#
 - LOBBIES: 100 PSF / 2.0 K
 - DINING / RETAIL: 100 PSF / 1.0 K
 - RESIDENTIAL / HOTEL / DECK: 40 PSF + PARTITIONS
- ROOF SNOW LOAD:
 - GROUND SNOW LOAD (Pg): 20 PSF
 - FLAT ROOF SNOW LOAD (P): 15.4 PSF W/ DRIFT
 - MIN UNIFORM ROOF SNOW LOAD (Pm): 20 PSF (NO DRIFT OR RAIN)
 - RAIN ON SNOW SURCHARGE (Pr): 5.0 PSF
 - SNOW EXPOSURE FACTOR (Ce): 1.0 EXPOSURE B & C
 - SNOW LOAD IMPORTANCE FACTOR (Is): 1.0
 - THERMAL FACTOR (Tc): 1.1 (use above freezing)
- WIND DESIGN DATA:
 - BASIC WIND SPEED (3 SEC GUST): 115 MPH
 - WIND IMPORTANCE FACTOR (Iw): 1.0
 - WIND EXPOSURE: B
 - DIRECTIONALITY FACTOR (Kd): 0.85
 - INTERNAL PRESSURE COEFF: 0.18
 - COMPONENTS AND CLADDING WIND (ULTIMATE 1.0PW) PRESSURES (BASED ON TRIB 10.5 F, EXP. B. MAY BE REDUCED FOR COMPONENTS WITH LARGER TRIB PER BLDG CODE)
 - WALLS AT CORNERS & EDGES: +30 / -40 PSF
 - ALL OTHER MAIN WALL CONDITIONS: +30 / -30 PSF
 - ROOF CORNERS: +15 / -57 PSF
 - ROOF EDGES: +15 / -39 PSF
 - ALL OTHER MAIN ROOF CONDITIONS: +15 / -23 PSF
- EARTHQUAKE DESIGN DATA:
 - SEISMIC IMPORTANCE FACTOR (Ie): 1.0
 - MAPPED SPECTRAL RESP ACCEL (Ss / S1): 0.12 / 0.07
 - SITE CLASS: D
 - SPECTRAL RESPONSE COEFF (Sms / Sdt): 0.13 / 0.11
 - SEISMIC DESIGN CATEGORY: B
 - SEISMIC FORCE RESISTING SYSTEM: R=3 STEEL
 - DESIGN BASE SHEAR: 15 K (ELF AND ASD)
 - SEISMIC RESPONSE COEFF (Cs): 0.043
 - ANALYSIS PROCEDURE: ELF
- GUARD RAILS: 50 PLF AND/OR 200# CONCENTRATED LOAD APPLIED IN ANY DIRECTION.

STRUCTURAL GENERAL NOTES:

- DESIGN AND CONSTRUCTION SHALL CONFORM TO THE "INTERNATIONAL BUILDING CODE, 2012 EDITION". REFER TO THE SPECIAL STRUCTURAL INSPECTION NOTES FOR ADDITIONAL REQUIREMENTS.
- CONTRACTOR TO VERIFY ALL DIMENSIONS, ELEVATIONS AND EXISTING CONDITIONS AND REPORT ANY DISCREPANCIES TO THE ARCHITECT IMMEDIATELY.
- IF DISCREPANCIES EXIST BETWEEN STRUCTURAL PLANS, ARCHITECTURAL PLANS, OTHER PLANS, OR SPECIFICATIONS, THE CONTRACTOR OR SUBCONTRACTOR SHALL PROVIDE A WRITTEN REQUEST FOR CLARIFICATION FROM THE ARCHITECT AND/OR ENGINEER PRIOR TO PROCEEDING WITH THE WORK.
- THE STRUCTURE IS DESIGNED TO BE SELF-SUPPORTING AND STABLE AFTER THE BUILDING IS FULLY COMPLETED. IT IS SOLELY THE CONTRACTOR'S RESPONSIBILITY TO EXECUTE AND DETERMINE FINAL ERECTION PROCEDURES, SEQUENCING AND TO INSURE THE SAFETY OF THE BUILDING AND ITS COMPONENT PARTS DURING ERECTION. THIS INCLUDES WHATEVER SHORING, SHEETING, TEMPORARY BRACING, GUYING OR TIE DOWNS WHICH MIGHT BE NECESSARY.
- THE STRUCTURE AND FOUNDATIONS ARE NOT DESIGNED FOR FUTURE EXPANSION.
- FABRICATORS AND SUPPLIERS SHALL CLEARLY NOTE AND HIGHLIGHT CHANGES MADE IN SHOP DRAWINGS, WHICH DO NOT COMPLY WITH THE CONTRACT DOCUMENTS.
- COLUMNS, BEAMS, JOISTS, OR TRUSSES SHALL NOT BE FIELD CUT OR TRIMMED FOR ANY REASON WITHOUT THE WRITTEN APPROVAL OF THE ARCHITECT/ENGINEER.
- HOLES, PIPES, SLEEVES, ETC. NOT SHOWN ON THE DRAWINGS MUST BE REVIEWED BY THE ARCHITECT BEFORE PLACEMENT THROUGH STRUCTURAL MEMBERS.
- IF MECHANICAL AND ELECTRICAL EQUIPMENT SIZES, WEIGHTS, OR LOCATIONS DO NOT CONFORM WITH EQUIPMENT SHOWN ON THE PLANS, COORDINATE ADJUSTMENTS WITH THE ARCHITECT.
- NO AREA OF THE STRUCTURE SHALL BE LOADED WITH CONSTRUCTION MATERIALS OR EQUIPMENT THAT EXCEEDS FINAL DESIGN CRITERIA.
- BEAMS, COLUMNS, WALLS AND FOOTING CENTERS SHALL BE CENTERED UNDER SUPPORTING MEMBERS (TYPICAL UNLESS NOTED).
- FOR DEFERRED SUBMITTALS (EXAMPLES: PRE-ENGINEERED CANOPIES, WOOD TRUSSES, PRECAST CONCRETE ELEMENTS, COLD FORMED FRAMING), SHOP DRAWINGS AND CALCULATIONS SEALED BY A STRUCTURAL ENGINEER LICENSED TO PRACTICE IN THE JURISDICTION OF THE PROJECT SHALL BE FURNISHED TO THE ENGINEER OF RECORD FOR REVIEW.
- TYPICAL DETAILS ARE SHOWN ON SHEETS DESIGNATED "SDXX". THE INCLUDED TYPICAL DETAILS MAY OR MAY NOT BE CUT / REFERENCED ON PLANS OR SECTIONS, BUT ARE TO BE USED AS APPLICABLE.
- EARTHWORK AND FOUNDATIONS:**
 - REFERENCE THE GEOTECHNICAL INVESTIGATION PREPARED BY XXXXXX XXXXXXXX DATED XXXXXXXXXX, 2016 (JOB NO. XXXXXXX). THE CONTRACTOR SHALL OBTAIN A COPY OF THIS REPORT AND FOLLOW ALL RECOMMENDATIONS WITHIN.
 - ALL FOOTINGS SHALL BEAR A MINIMUM DEPTH BELOW GRADE OF 3'-0" ON FIRM NATIVE MATERIALS, COMPACTED OR ENGINEERED FILL CAPABLE OF SUPPORTING AN ALLOWABLE BEARING PRESSURE OF 2,000 PSF PER THE GEOTECHNICAL REPORT. DEEPEN FOOTINGS, AND REMOVE AND REPLACE SOFT SOILS WITH ENGINEERED FILL AS REQUIRED TO PROVIDE THIS MINIMUM DEPTH AND SUITABLE BEARING.
 - UNDERCUT THE PAD TO A DEPTH OF 18-INCHES BELOW BOTTOM OF FLOOR SLAB ELEVATION AND REPLACE WITH LOW-VOLUME-CHANGE MATERIALS PER THE GEOTECHNICAL REPORT.
 - FILL PLACEMENT, COMPACTION, AND SOIL BEARING TESTS SHALL BE PERFORMED BY A GEOTECHNICAL ENGINEER PRIOR TO INSTALLING FOOTINGS TO ENSURE DESIGN ALLOWABLE BEARING VALUES AND SLAB SUBGRADE REQUIREMENTS ARE SATISFIED. IF ACTUAL SITE CONDITIONS DO NOT SATISFY THESE REQUIREMENTS, COORDINATE ADJUSTMENTS WITH ARCHITECT/ENGINEER/ GEOTECHNICAL ENGINEER.
 - SURFACE WATER SHALL NOT BE ALLOWED TO STAND ADJACENT TO OR DRAIN TOWARDS THE FOUNDATION AND SLAB SUBGRADES UNDER ANY CIRCUMSTANCES. PAVEMENTS OR GRADED SOILS AT THE PERIMETER OF THE BUILDING, EXCEPT AS REQUIRED AT EXITS OR AS NOTED, SHALL BE SLOPED AWAY AT 6% OR 6" MIN FOR THE FIRST TEN FEET AND AS REQUIRED TO PROVIDE POSITIVE DRAINAGE.
 - FOOTINGS MAY BE POURED TO MEAT LINES OF EXCAVATIONS PROVIDING VERTICAL LINES OF EXCAVATIONS CAN BE MAINTAINED DURING CONCRETE PLACEMENT.
 - FOUNDATION WALL BACKFILL SHALL NOT BE UNBALANCED BY MORE THAN TWO FEET ON EITHER SIDE AT ANY TIME. BASEMENT WALL AND RESTRAINED RETAINING WALL BACKFILL SHALL NOT BE PLACED, UNLESS THE WALL IS ADEQUATELY BRACED. RETAINING WALL AND BASEMENT WALL BACKFILL SHALL BE FREE DRAINING GRANULAR BACKFILL ACCEPTABLE TO THE GEOTECHNICAL ENGINEER.

CONCRETE AND MASONRY REINFORCING STEEL:

- SUBMIT SHOP DRAWINGS FOR REBAR. ALL REINFORCING BARS SHALL MEET ASTM A615 GRADE 60.
- ALL MESH SHALL MEET ASTM A-185. LAP A MINIMUM OF 6" OR ONE FULL MESH, WHICHEVER IS GREATER.
- REINFORCING BARS QUANTITIES SHOWN ARE FOR ESTIMATING PURPOSES ONLY.
- PROVIDE AN ADDITIONAL ALLOWANCE OF 1% OF THE TOTAL REINFORCING SHOWN ON THE FINAL DRAWINGS TO BE FABRICATED AND ERECTED DURING THE PROGRESS OF THE WORK AT THE DIRECTION OF THE STRUCTURAL ENGINEER. FOR THE ADDITIONAL REINFORCING ALLOWANCE, INCLUDE BOTH THE COST OF THE REINFORCING AND THE LABOR TO PLACE IT.
- CONCRETE PROTECTION FOR REINFORCEMENT SHALL BE 1/2" CLEAR FOR SLABS, 2" CLEAR FOR FORMED SURFACES AND 3" CLEAR FOR FOOTINGS (TYPICAL UNLESS NOTED).
- CONTRACTOR SHALL VERIFY THAT ALL REINFORCEMENT, SLAB DOWELS, INSERTS, SLEEVES AND EMBEDDED ITEMS ARE PROPERLY LOCATED AND RIGIDLY SECURED PRIOR TO CONCRETE PLACEMENT. WET STIKING DOWELS WILL NOT BE ALLOWED.
- REINFORCEMENT SHALL BE DETAILED IN ACCORDANCE WITH THE LATEST A.C.I. DETAILING MANUAL BY A QUALIFIED AND EXPERIENCED FIRM AND PERSON. PLACE AND SUPPORT REINFORCEMENT WITH ACCESSORIES: MAXIMUM SPACING - 48" CENTERS (PLASTIC-TIPPED LEGS FOR EXPOSED SURFACES); USE 3" SBP SUPPORTS AT ALL FOOTINGS.

CAST IN PLACE CONCRETE:

- SUBMIT PROPOSED MIXED DESIGNS OF EACH TYPE FOR REVIEW. REQUIRED MINIMUM CONCRETE COMPRESSIVE STRENGTHS AT 28 DAYS:
 - a. FOOTING AND GRADEBEAM CONCRETE: 4000 PSI
 - b. BASEMENT / FOUNDATION WALL CONCRETE: 4000 PSI
 - c. SLAB ON GRADE AND STRUC SLAB ABOVE GRADE: 4000 PSI
- ALL CONCRETE MIX DESIGNS SHALL HAVE WATER TO CEMENT RATIOS LESS THAN 0.52, WITH A MAXIMUM 60/40 FINE TO COARSE AGGREGATE RATIO. CONCRETE MIX DESIGNS THAT DO NOT CONFORM TO THE ABOVE STANDARD AND/OR CONTAIN WATER REDUCING ADMIXTURES SHALL BE SUBMITTED WITH APPROPRIATE TEST DATA PER A.C.I. ALL CONCRETE SHALL BE IN CONFORMANCE WITH THE LATEST A.C.I. 301 STANDARDS PUBLICATION.
- LIGHTWEIGHT CONCRETE SHALL HAVE A MAXIMUM DRY UNIT WEIGHT OF 118 PCF.
- EXTERIOR CONCRETE (FLOOR SLABS, WALLS, ETC) SHALL HAVE 6% (PLUS/MINUS 1%) ENTRAINED AIR.
- ALL EXPOSED CONCRETE EDGES 3/4" (VERIFY WITH ARCHITECT).
- NO ALUMINUM SHALL BE EMBEDDED IN ANY CONCRETE.
- NO CALCIUM CHLORIDE SHALL BE USED IN CONCRETE.
- THE DESIGN, CONSTRUCTION, AND SAFETY OF ALL FORMWORK IS THE RESPONSIBILITY OF THE CONTRACTOR.
- ALL CONCRETE IS REINFORCED UNLESS SPECIFICALLY NOTED AS UNREINFORCED. REINFORCE ALL CONCRETE NOT OTHERWISE SHOWN WITH THE SAME REINFORCING AS SIMILAR SECTIONS OR AREAS.
- CONSTRUCTION JOINTS IN GRADE BEAMS, CONTINUOUS FOOTINGS, AND WALLS THAT DO NOT CHANGE DIRECTION SHALL BE SPACED NO GREATER THAN 8'-0". INTERMEDIATE CONTROL JOINTS SHALL BE SPACED AT 17'-0" MAX FOR WALLS. CONTROL JOINTS IN WALLS SHALL ALSO BE LOCATED 15'-0" FROM CORNERS AND AT CHANGES IN WALL THICKNESS.
- WHERE FRESH CONCRETE IS DEPOSITED AGAINST HARDENED CONCRETE (GREATER THAN 8 HRS OLD), CLEAN EXISTING SURFACE OF LAITANCE AND FOREIGN MATERIAL AND DAMPEN THE EXISTING SURFACE. IF REQUIRED, REMOVE EXISTING CONCRETE TO 1/2" AMPLITUDE.
- SLABS ON GRADE SHALL BE 4" THICK MINIMUM ON 4" OF GRANULAR FILL. REIN. SLAB WITH 6 X 6-NO. 14W2 1W W.F. OR 43 BARS @ 18" OC EA WAY. PLACE REIN IN UPPER 1/3 OF SLAB THICKNESS. AT INTERIOR SLABS, A 10 MIL VAPOR BARRIER SHALL BE PLACED BETWEEN THE CONCRETE AND GRANULAR BASE AND CARE SHOULD BE TAKEN DURING CURING TO PREVENT SLAB CURLING. THIS NOTE SHALL BE TYPICAL UNLESS NOTED OTHERWISE.
- SAW CUT JOINTS OR KEVED CONSTRUCTION JOINTS IN SLABS ON GRADE SHALL BE SPACED TO DIVIDE THE SLAB INTO PANELS NOT TO EXCEED 225 SQUARE FEET. THE LONGER DIMENSION OF EACH PANEL SHALL NOT EXCEED THE SHORTER DIMENSIONS BY MORE THAN 40%. JOINTS SHALL BE LOCATED AT COLUMN CENTERLINES WHERE POSSIBLE. SPACING BETWEEN JOINTS SHALL NOT EXCEED 15 FEET. CONTRACTOR SHALL SUBMIT JOINT LAYOUT TO ARCHITECT FOR APPROVAL. REFER TO TYP DETAIL RC-001A.
- REINFORCEMENT SHALL BE CONTINUOUS AND LAPPED 3B BAR DIAMETERS (2'-0" MIN), EXCEPT AS NOTED AND PROVIDED CORNER BARS OF SAME SIZE AND SPACING.
- MINIMUM CONCRETE WALL REINFORCING (WALL 10" OR GREATER) SHALL BE #5 AT 10" CENTERS EACH WAY, EACH FACE.

REINFORCING STEEL:

- SUBMIT SHOP DRAWINGS FOR REBAR. ALL REINFORCING BARS SHALL MEET ASTM A615 GRADE 60.
- ALL MESH SHALL MEET ASTM A-185. LAP A MINIMUM OF 6" OR ONE FULL MESH, WHICHEVER IS GREATER.
- REINFORCING BARS QUANTITIES SHOWN ARE FOR ESTIMATING PURPOSES ONLY.
- PROVIDE AN ADDITIONAL ALLOWANCE OF 1% OF THE TOTAL REINFORCING SHOWN ON THE FINAL DRAWINGS TO BE FABRICATED AND ERECTED DURING THE PROGRESS OF THE WORK AT THE DIRECTION OF THE STRUCTURAL ENGINEER. FOR THE ADDITIONAL REINFORCING ALLOWANCE, INCLUDE BOTH THE COST OF THE REINFORCING AND THE LABOR TO PLACE IT.
- CONCRETE PROTECTION FOR REINFORCEMENT SHALL BE 1/2" CLEAR FOR SLABS, 2" CLEAR FOR FORMED SURFACES AND 3" CLEAR FOR FOOTINGS (TYPICAL UNLESS NOTED).
- CONTRACTOR SHALL VERIFY THAT ALL REINFORCEMENT, SLAB DOWELS, INSERTS, SLEEVES AND EMBEDDED ITEMS ARE PROPERLY LOCATED AND RIGIDLY SECURED PRIOR TO CONCRETE PLACEMENT. WET STIKING DOWELS WILL NOT BE ALLOWED.
- REINFORCEMENT SHALL BE DETAILED IN ACCORDANCE WITH THE LATEST A.C.I. DETAILING MANUAL BY A QUALIFIED AND EXPERIENCED FIRM AND PERSON. PLACE AND SUPPORT REINFORCEMENT WITH ACCESSORIES: MAXIMUM SPACING - 48" CENTERS (PLASTIC-TIPPED LEGS FOR EXPOSED SURFACES); USE 3" SBP SUPPORTS AT ALL FOOTINGS.

CAST IN PLACE CONCRETE:

- SUBMIT PROPOSED MIXED DESIGNS OF EACH TYPE FOR REVIEW. REQUIRED MINIMUM CONCRETE COMPRESSIVE STRENGTHS AT 28 DAYS:
 - a. FOOTING AND GRADEBEAM CONCRETE: 4000 PSI
 - b. BASEMENT / FOUNDATION WALL CONCRETE: 4000 PSI
 - c. SLAB ON GRADE AND STRUC SLAB ABOVE GRADE: 4000 PSI
- ALL CONCRETE MIX DESIGNS SHALL HAVE WATER TO CEMENT RATIOS LESS THAN 0.52, WITH A MAXIMUM 60/40 FINE TO COARSE AGGREGATE RATIO. CONCRETE MIX DESIGNS THAT DO NOT CONFORM TO THE ABOVE STANDARD AND/OR CONTAIN WATER REDUCING ADMIXTURES SHALL BE SUBMITTED WITH APPROPRIATE TEST DATA PER A.C.I. ALL CONCRETE SHALL BE IN CONFORMANCE WITH THE LATEST A.C.I. 301 STANDARDS PUBLICATION.
- LIGHTWEIGHT CONCRETE SHALL HAVE A MAXIMUM DRY UNIT WEIGHT OF 118 PCF.
- EXTERIOR CONCRETE (FLOOR SLABS, WALLS, ETC) SHALL HAVE 6% (PLUS/MINUS 1%) ENTRAINED AIR.
- ALL EXPOSED CONCRETE EDGES 3/4" (VERIFY WITH ARCHITECT).
- NO ALUMINUM SHALL BE EMBEDDED IN ANY CONCRETE.
- NO CALCIUM CHLORIDE SHALL BE USED IN CONCRETE.
- THE DESIGN, CONSTRUCTION, AND SAFETY OF ALL FORMWORK IS THE RESPONSIBILITY OF THE CONTRACTOR.
- ALL CONCRETE IS REINFORCED UNLESS SPECIFICALLY NOTED AS UNREINFORCED. REINFORCE ALL CONCRETE NOT OTHERWISE SHOWN WITH THE SAME REINFORCING AS SIMILAR SECTIONS OR AREAS.
- CONSTRUCTION JOINTS IN GRADE BEAMS, CONTINUOUS FOOTINGS, AND WALLS THAT DO NOT CHANGE DIRECTION SHALL BE SPACED NO GREATER THAN 8'-0". INTERMEDIATE CONTROL JOINTS SHALL BE SPACED AT 17'-0" MAX FOR WALLS. CONTROL JOINTS IN WALLS SHALL ALSO BE LOCATED 15'-0" FROM CORNERS AND AT CHANGES IN WALL THICKNESS.
- WHERE FRESH CONCRETE IS DEPOSITED AGAINST HARDENED CONCRETE (GREATER THAN 8 HRS OLD), CLEAN EXISTING SURFACE OF LAITANCE AND FOREIGN MATERIAL AND DAMPEN THE EXISTING SURFACE. IF REQUIRED, REMOVE EXISTING CONCRETE TO 1/2" AMPLITUDE.
- SLABS ON GRADE SHALL BE 4" THICK MINIMUM ON 4" OF GRANULAR FILL. REIN. SLAB WITH 6 X 6-NO. 14W2 1W W.F. OR 43 BARS @ 18" OC EA WAY. PLACE REIN IN UPPER 1/3 OF SLAB THICKNESS. AT INTERIOR SLABS, A 10 MIL VAPOR BARRIER SHALL BE PLACED BETWEEN THE CONCRETE AND GRANULAR BASE AND CARE SHOULD BE TAKEN DURING CURING TO PREVENT SLAB CURLING. THIS NOTE SHALL BE TYPICAL UNLESS NOTED OTHERWISE.
- SAW CUT JOINTS OR KEVED CONSTRUCTION JOINTS IN SLABS ON GRADE SHALL BE SPACED TO DIVIDE THE SLAB INTO PANELS NOT TO EXCEED 225 SQUARE FEET. THE LONGER DIMENSION OF EACH PANEL SHALL NOT EXCEED THE SHORTER DIMENSIONS BY MORE THAN 40%. JOINTS SHALL BE LOCATED AT COLUMN CENTERLINES WHERE POSSIBLE. SPACING BETWEEN JOINTS SHALL NOT EXCEED 15 FEET. CONTRACTOR SHALL SUBMIT JOINT LAYOUT TO ARCHITECT FOR APPROVAL. REFER TO TYP DETAIL RC-001A.
- REINFORCEMENT SHALL BE CONTINUOUS AND LAPPED 3B BAR DIAMETERS (2'-0" MIN), EXCEPT AS NOTED AND PROVIDED CORNER BARS OF SAME SIZE AND SPACING.
- MINIMUM CONCRETE WALL REINFORCING (WALL 10" OR GREATER) SHALL BE #5 AT 10" CENTERS EACH WAY, EACH FACE.

REINFORCING STEEL:

- SUBMIT SHOP DRAWINGS FOR REBAR. ALL REINFORCING BARS SHALL MEET ASTM A615 GRADE 60.
- ALL MESH SHALL MEET ASTM A-185. LAP A MINIMUM OF 6" OR ONE FULL MESH, WHICHEVER IS GREATER.
- REINFORCING BARS QUANTITIES SHOWN ARE FOR ESTIMATING PURPOSES ONLY.
- PROVIDE AN ADDITIONAL ALLOWANCE OF 1% OF THE TOTAL REINFORCING SHOWN ON THE FINAL DRAWINGS TO BE FABRICATED AND ERECTED DURING THE PROGRESS OF THE WORK AT THE DIRECTION OF THE STRUCTURAL ENGINEER. FOR THE ADDITIONAL REINFORCING ALLOWANCE, INCLUDE BOTH THE COST OF THE REINFORCING AND THE LABOR TO PLACE IT.
- CONCRETE PROTECTION FOR REINFORCEMENT SHALL BE 1/2" CLEAR FOR SLABS, 2" CLEAR FOR FORMED SURFACES AND 3" CLEAR FOR FOOTINGS (TYPICAL UNLESS NOTED).
- CONTRACTOR SHALL VERIFY THAT ALL REINFORCEMENT, SLAB DOWELS, INSERTS, SLEEVES AND EMBEDDED ITEMS ARE PROPERLY LOCATED AND RIGIDLY SECURED PRIOR TO CONCRETE PLACEMENT. WET STIKING DOWELS WILL NOT BE ALLOWED.
- REINFORCEMENT SHALL BE DETAILED IN ACCORDANCE WITH THE LATEST A.C.I. DETAILING MANUAL BY A QUALIFIED AND EXPERIENCED FIRM AND PERSON. PLACE AND SUPPORT REINFORCEMENT WITH ACCESSORIES: MAXIMUM SPACING - 48" CENTERS (PLASTIC-TIPPED LEGS FOR EXPOSED SURFACES); USE 3" SBP SUPPORTS AT ALL FOOTINGS.

CAST IN PLACE CONCRETE:

- SUBMIT PROPOSED MIXED DESIGNS OF EACH TYPE FOR REVIEW. REQUIRED MINIMUM CONCRETE COMPRESSIVE STRENGTHS AT 28 DAYS:
 - a. FOOTING AND GRADEBEAM CONCRETE: 4000 PSI
 - b. BASEMENT / FOUNDATION WALL CONCRETE: 4000 PSI
 - c. SLAB ON GRADE AND STRUC SLAB ABOVE GRADE: 4000 PSI
- ALL CONCRETE MIX DESIGNS SHALL HAVE WATER TO CEMENT RATIOS LESS THAN 0.52, WITH A MAXIMUM 60/40 FINE TO COARSE AGGREGATE RATIO. CONCRETE MIX DESIGNS THAT DO NOT CONFORM TO THE ABOVE STANDARD AND/OR CONTAIN WATER REDUCING ADMIXTURES SHALL BE SUBMITTED WITH APPROPRIATE TEST DATA PER A.C.I. ALL CONCRETE SHALL BE IN CONFORMANCE WITH THE LATEST A.C.I. 301 STANDARDS PUBLICATION.
- LIGHTWEIGHT CONCRETE SHALL HAVE A MAXIMUM DRY UNIT WEIGHT OF 118 PCF.
- EXTERIOR CONCRETE (FLOOR SLABS, WALLS, ETC) SHALL HAVE 6% (PLUS/MINUS 1%) ENTRAINED AIR.
- ALL EXPOSED CONCRETE EDGES 3/4" (VERIFY WITH ARCHITECT).
- NO ALUMINUM SHALL BE EMBEDDED IN ANY CONCRETE.
- NO CALCIUM CHLORIDE SHALL BE USED IN CONCRETE.
- THE DESIGN, CONSTRUCTION, AND SAFETY OF ALL FORMWORK IS THE RESPONSIBILITY OF THE CONTRACTOR.
- ALL CONCRETE IS REINFORCED UNLESS SPECIFICALLY NOTED AS UNREINFORCED. REINFORCE ALL CONCRETE NOT OTHERWISE SHOWN WITH THE SAME REINFORCING AS SIMILAR SECTIONS OR AREAS.
- CONSTRUCTION JOINTS IN GRADE BEAMS, CONTINUOUS FOOTINGS, AND WALLS THAT DO NOT CHANGE DIRECTION SHALL BE SPACED NO GREATER THAN 8'-0". INTERMEDIATE CONTROL JOINTS SHALL BE SPACED AT 17'-0" MAX FOR WALLS. CONTROL JOINTS IN WALLS SHALL ALSO BE LOCATED 15'-0" FROM CORNERS AND AT CHANGES IN WALL THICKNESS.
- WHERE FRESH CONCRETE IS DEPOSITED AGAINST HARDENED CONCRETE (GREATER THAN 8 HRS OLD), CLEAN EXISTING SURFACE OF LAITANCE AND FOREIGN MATERIAL AND DAMPEN THE EXISTING SURFACE. IF REQUIRED, REMOVE EXISTING CONCRETE TO 1/2" AMPLITUDE.
- SLABS ON GRADE SHALL BE 4" THICK MINIMUM ON 4" OF GRANULAR FILL. REIN. SLAB WITH 6 X 6-NO. 14W2 1W W.F. OR 43 BARS @ 18" OC EA WAY. PLACE REIN IN UPPER 1/3 OF SLAB THICKNESS. AT INTERIOR SLABS, A 10 MIL VAPOR BARRIER SHALL BE PLACED BETWEEN THE CONCRETE AND GRANULAR BASE AND CARE SHOULD BE TAKEN DURING CURING TO PREVENT SLAB CURLING. THIS NOTE SHALL BE TYPICAL UNLESS NOTED OTHERWISE.
- SAW CUT JOINTS OR KEVED CONSTRUCTION JOINTS IN SLABS ON GRADE SHALL BE SPACED TO DIVIDE THE SLAB INTO PANELS NOT TO EXCEED 225 SQUARE FEET. THE LONGER DIMENSION OF EACH PANEL SHALL NOT EXCEED THE SHORTER DIMENSIONS BY MORE THAN 40%. JOINTS SHALL BE LOCATED AT COLUMN CENTERLINES WHERE POSSIBLE. SPACING BETWEEN JOINTS SHALL NOT EXCEED 15 FEET. CONTRACTOR SHALL SUBMIT JOINT LAYOUT TO ARCHITECT FOR APPROVAL. REFER TO TYP DETAIL RC-001A.
- REINFORCEMENT SHALL BE CONTINUOUS AND LAPPED 3B BAR DIAMETERS (2'-0" MIN), EXCEPT AS NOTED AND PROVIDED CORNER BARS OF SAME SIZE AND SPACING.
- MINIMUM CONCRETE WALL REINFORCING (WALL 10" OR GREATER) SHALL BE #5 AT 10" CENTERS EACH WAY, EACH FACE.

REINFORCING STEEL:

- SUBMIT SHOP DRAWINGS FOR REBAR. ALL REINFORCING BARS SHALL MEET ASTM A615 GRADE 60.
- ALL MESH SHALL MEET ASTM A-185. LAP A MINIMUM OF 6" OR ONE FULL MESH, WHICHEVER IS GREATER.
- REINFORCING BARS QUANTITIES SHOWN ARE FOR ESTIMATING PURPOSES ONLY.
- PROVIDE AN ADDITIONAL ALLOWANCE OF 1% OF THE TOTAL REINFORCING SHOWN ON THE FINAL DRAWINGS TO BE FABRICATED AND ERECTED DURING THE PROGRESS OF THE WORK AT THE DIRECTION OF THE STRUCTURAL ENGINEER. FOR THE ADDITIONAL REINFORCING ALLOWANCE, INCLUDE BOTH THE COST OF THE REINFORCING AND THE LABOR TO PLACE IT.
- CONCRETE PROTECTION FOR REINFORCEMENT SHALL BE 1/2" CLEAR FOR SLABS, 2" CLEAR FOR FORMED SURFACES AND 3" CLEAR FOR FOOTINGS (TYPICAL UNLESS NOTED).
- CONTRACTOR SHALL VERIFY THAT ALL REINFORCEMENT, SLAB DOWELS, INSERTS, SLEEVES AND EMBEDDED ITEMS ARE PROPERLY LOCATED AND RIGIDLY SECURED PRIOR TO CONCRETE PLACEMENT. WET STIKING DOWELS WILL NOT BE ALLOWED.
- REINFORCEMENT SHALL BE DETAILED IN ACCORDANCE WITH THE LATEST A.C.I. DETAILING MANUAL BY A QUALIFIED AND EXPERIENCED FIRM AND PERSON. PLACE AND SUPPORT REINFORCEMENT WITH ACCESSORIES: MAXIMUM SPACING - 48" CENTERS (PLASTIC-TIPPED LEGS FOR EXPOSED SURFACES); USE 3" SBP SUPPORTS AT ALL FOOTINGS.

STRUCTURAL STEEL:

- SUBMIT SHOP DRAWINGS FOR STEEL. STRUCTURAL STEEL SHAPES AND PLATE MATERIAL REQUIREMENTS (TYPICAL UNLESS NOTED OTHERWISE):
 - a. WIDE FLANGE SHAPES - ASTM A992 (FY = 50 KSI MIN)
 - b. CHANNELS, ANGLES, AND PLATES - ASTM A36 (FY = 36 KSI MIN)
 - c. ROUND HSS - ASTM A500, GR B (FY = 42 KSI)
 - d. RECTANGULAR HSS - ASTM A500, GR B (FY = 46 KSI)
 - e. PIPE - ASTM A53, GR B (FY = 35 KSI)
 - f. ANCHOR RODS - ASTM F1554 (FY = 36 KSI MIN).
- STRUCTURAL STEEL SHALL BE NEW AND MEET THE 13TH EDITION A.I.S.C. SPECIFICATIONS FOR STRUCTURAL STEEL, BUILDINGS AND BRIDGES; AND THE CODE OF STANDARD PRACTICES FOR STEEL BUILDINGS AND BRIGES; EXCLUDING SECTION 4.4.1.B.
- THE CONTRACTOR SHALL VERIFY THAT ALL STRUCTURAL STEEL SHALL BE AN AISI QUALITY CERTIFIED COMPANY FOR THE CATEGORY OF WORK IN THIS PROJECT OR PROVIDE A QUALITY ASSURANCE PLAN AND SPECIAL INSPECTIONS AS DEFINED IN THE CODE.
- USE STANDARD AISI CONNECTIONS WITH A325-N BOLTS AND WASHERS AS REQUIRED, UNLESS NOTED OTHERWISE.
- BOLTS IN MOMENT AND BRACED FRAME CONNECTIONS SHALL BE PRE-TENSIONED. ALL A590 BOLTS SHALL BE PRE-TENSIONED. OTHER BOLTED CONNECTIONS USING A325 BOLTS MAY BE SNUG-TIGHTENED, UNLESS NOTED OTHERWISE.
- STEEL BEAMS SHALL BE FABRICATED WITH MILL CAMBER UP.
- WELDING SHALL CONFORM TO THE CURRENT AND APPLICABLE AWS STANDARDS AND BE COMPLETED BY AN AWS CERTIFIED WELDER. ALL WELDS SHALL UTILIZE E70xx ELECTRODES. SHOP DRAWINGS SHALL SHOW FIELD WELDS, AS APPROPRIATE.
 - a. AWS D1.1 - STRUCTURAL WELDING CODE - STEEL
 - b. AWS D1.3 - STRUCTURAL WELDING CODE - SHEET STEEL
 - c. AWS D1.6 - STRUCTURAL WELDING CODE - STAINLESS STEEL
- WELD SIZES SHALL BE INCREASED TO MEET THE REQUIRED EFFECTIVE THROAT WIDTH IF IT EXISTS AT THE FAYING SURFACE.
- NO COLUMN OR BEAM BRACE SPICES, UNLESS CLEARLY INDICATED ON THE STRUCTURAL DRAWINGS, WILL BE ALLOWED WITHOUT WRITTEN APPROVAL OF THE STRUCTURAL ENGINEER.
- SEE ARCHITECTURAL PLANS FOR FIREPROOFING & FINISHING REQUIREMENTS, AND COORDINATE STEEL PRIMING & COATINGS ACCORDINGLY.
- GROUT WHERE INDICATED ON PLANS AT BASE PLATES SHALL BE NON-METALLIC NON-SHINK WITH A MINIMUM COMPRESSIVE STRENGTH OF 6000 PSI AT 28 DAYS CONFORMING TO ASTM C1107.
- ALL POST-INSTALLED ANCHORS WHERE NOTED SHALL BE MANUFACTURED BY SIMPSON STRONG-TIE OR HILLI, INC. AND INSTALLED PER MANUFACTURERS SPECIFICATIONS. SUBSTITUTIONS SHALL BE SUBMITTED FOR REVIEW AND APPROVAL WITH APPROPRIATE I-CES EVALUATION REPORTS.

OPEN WEB STEEL BAR JOISTS:

- OPEN WEB STEEL JOISTS SHALL BE ENGINEERED AND MANUFACTURED BY AN AISI-CERTIFIED COMPANY TO CONFORM TO THE CURRENT SJI SPECIFICATIONS AND SJI REQUIREMENTS.
- SUBMIT SHOP DRAWINGS FOR JOIST. DESIGN, DETAIL AND INSTALL JOIST-BRIDGING IN ACCORDANCE WITH SJI REQUIREMENTS, PROVIDING X-BRIDGING AT LOCATIONS WHERE HORIZONTAL BRIDGING IS DISCONTINUOUS AND INCLUDING INSTALLED ADDITIONAL ROW OF BOTTOM CHORD BRIDGING AT EACH END OF JOISTS AT THE FIRST BOTTOM CHORD PANEL POINTS AS REQUIRED FOR NET WIND UPLIFT.
- BOLT OR WELD ALL JOISTS TO BEARINGS PER SJI GUIDELINES, INCLUDING BOTTOM CHORD EXTENSIONS AND CONNECTIONS AT COLUMN LINES PER SJI AND PER OSHA REQUIREMENTS.
- REINFORCE WEBS OF JOISTS WITH ADDITIONAL ANGLES FIELD-WELDED PER THE TYPICAL DETAILS AT ALL LOCATIONS WHERE POINT LOADS OCCUR BETWEEN PANEL POINTS, INCLUDING AT EDGES AND CORNERS OF CURBS & FRAMES SUPPORTING ROOF TOP EQUIPMENT.
- PROVIDE EXTENDED ENDS FOR SUPPORT OF ROOF DECK EDGE ANGLES THROUGHOUT THE PROJECT AS MAY BE REQUIRED. PROVIDE SPECIAL SLOPED BEARING SEATS WHERE NEEDED BASED ON ROOF SLOPES SHOWN IN ACCORDANCE WITH SJI.
- WHERE SPECIAL "SP" JOISTS ARE INDICATED, DESIGN JOISTS FOR THE FOLLOWING, BUT IN NO CASE SHALL CHORD SIZES BE LESS THAN INDICATED ON THE FRAMING PLANS:
 - A. UNIFORM DEAD LOAD OF 15 PSF IN ADDITION TO SELF WT.
 - B. UNIFORM ROOF LIVE, SNOW, AND RAIN ON SNOW LOADS INDICATED IN STRUCTURAL GENERAL NOTES.
 - C. SNOW DRIFTS AROUND PARAPETS AS FOLLOWS:
 - C.1. ALONG THE NORTH AND SOUTH PARAPETS WALLS A MAX TOTAL DRIFT OF 60 PSF, TAPERED DOWN OVER A LENGTH OF 10'-FEET DOWN TO THE UNIFORM ROOF SNOW LOAD.
 - C.2. ALONG THE EAST-WEST PARAPET WALLS AND CENTER SCREENWALLS USE A MAX OF TOTAL OF 90 PSF, TAPERED DOWN OVER A LENGTH OF 8'-FEET DOWN TO UNIFORM ROOF SNOW LOAD.
 - D. WIND NET UPLIFT.
 - E. SPECIAL HANGING POINT LOADS AND ROOF EQUIPMENT LOADS AS DENOTED ON THE FRAMING PLAN.

METAL DECK:

- SUBMIT SHOP DRAWINGS FOR ALL METAL DECKING.
 - A. ROOF DECK: 1.88 20 GA (FY = 33 KSI MIN), PAINTED, MIN. FASTENING PATTERN: 364 WITH 3 SIDELAPS PER SPAN (UNO).
 - B. COMPOSITE FLOOR DECK: 2" 20 GA (FY = 33 KSI MIN), 60G GALVANIZED, MIN FASTENING PATTERN: 364 WITH 3 SIDELAPS PER SPAN (UNO).
- STEEL DECK MANUFACTURER SHALL BE A MEMBER OF THE STEEL DECK INSTITUTE (SDI). ALL METAL DECK TO BE ERECTED PER MANUFACTURER REQUIREMENTS AND SPECIFICATIONS.
- DECK SHALL BE WELDED AT SUPPORTS WITH 8/16 DIA RUDDELE WELDS MIN. AND SIDELAP CONNECTIONS SHALL BE #10 TEK SCREWS MIN (UNO).
- ALL METAL DECK SHALL BE DESIGNED TO BE CONTINUOUS OVER 2 SPANS MINIMUM AND SHALL BEAR 7' MINIMUM ON STEEL SUPPORTS. FOR ONE OR TWO SPAN CONDITIONS CONTRACTOR SHALL PROVIDE SHORING AS REQUIRED OR FURNISH THICKER GAGE DECK TO SUPPORT ALL APPLICABLE LOADS. CONTRACTOR TO SUBMIT ALTERNATES FOR APPROVAL.
- PROVIDE REINFORCING CHANNELS, STANDARD CLOSURES, CANT STRIPS, SLUMP PANS, AND OTHER ACCESSORIES AS REQUIRED FOR A PROPERLY FINISHED JOB. EVEN IF NOT SPECIFICALLY SHOWN ON THE STRUCTURAL DRAWINGS, PROVIDE BEARING ANGLE WELDED TO COLUMNS AS REQUIRED TO SUPPORT METAL DECK.
- ONE OPENING PER DECK SHEET, 6" OR LESS IN DIAMETER, IS PERMISSIBLE. HOLES LARGER THAN 6" IN DIAMETER OR MORE THAN ONE HOLE PER DECK SHEET REQUIRES REINFORCING PER SDI. HOLES LARGER THAN 12" (ROUND OR SQUARE) REQUIRE A STEEL FRAME.
- OPENINGS IN ROOF DECK TO BE FRAMED WITH L4x4x1/4 ANGLE. EXTEND ANGLES TO STRUCTURAL SUPPORTS, BLOCK VERTICAL LEGS AND FIELD WELD. TYPICAL UNLESS NOTED OTHERWISE.

LIGHT GAGE STRUCTURAL STEEL FRAMING NOTES:


- SUBMIT SHOP DRAWINGS FOR CFM. LIGHT GAGE FRAMING MEMBERS SHALL HAVE THE FOLLOWING MINIMUM MATERIAL PROPERTIES: FY = 33 KSI FOR 18 GA AND LIGHTER MEMBERS, FY = 50 KSI FOR ALL DIAGONAL STRAP BRACING AND FOR 16 GA AND HEAVIER MEMBERS. ALL MATERIALS, CONNECTORS, FASTENERS SHALL BE GALVANIZED.
- ALL DESIGN, FABRICATION, AND ERECTION SHALL BE IN CONFORMANCE WITH AISI SPECIFICATIONS FOR THE DESIGN OF COLD FORMED STEEL STRUCTURAL MEMBERS. LATERAL LOAD DEFLECTION SHALL BE LIMITED TO 1/600 OF THE SPAN AT LOCATIONS LATERALLY SUPPORTING MASONRY, MASONRY TILE, STONE OR SIMILAR PRODUCTS.
- ALL EXTERIOR OR LOAD BEARING INTERIOR STUDS SHALL BE 60MS162-43 (6" DEEP 18 GA) AT 16 INCHES ON CENTER, UNLESS NOTED. REFER TO PLANS.
- MINIMUM GAGE OF STRUCTURAL STUDS SHALL BE 43 mils (18 GAGE), UNLESS

SHEET NOTES:

A. REFERENCE SHEET SS-001 FOR STRUCTURAL GENERAL NOTES AND SS-200 FOR TYPICAL STRUCTURAL DETAILS. REVIEW NOTES & DETAILS FOR APPLICABILITY.

B. SEE ARCHITECTURAL DRAWING FOR DETAILS & DIMENSIONS NOT SHOWN.

C. EXISTING INFORMATION PROVIDED IS BASED ON ORIGINAL DRAWINGS AND SHOULD BE VERIFIED IN THE FIELD PRIOR TO BIDDING OR PRODUCTION OF SHOP DRAWINGS.

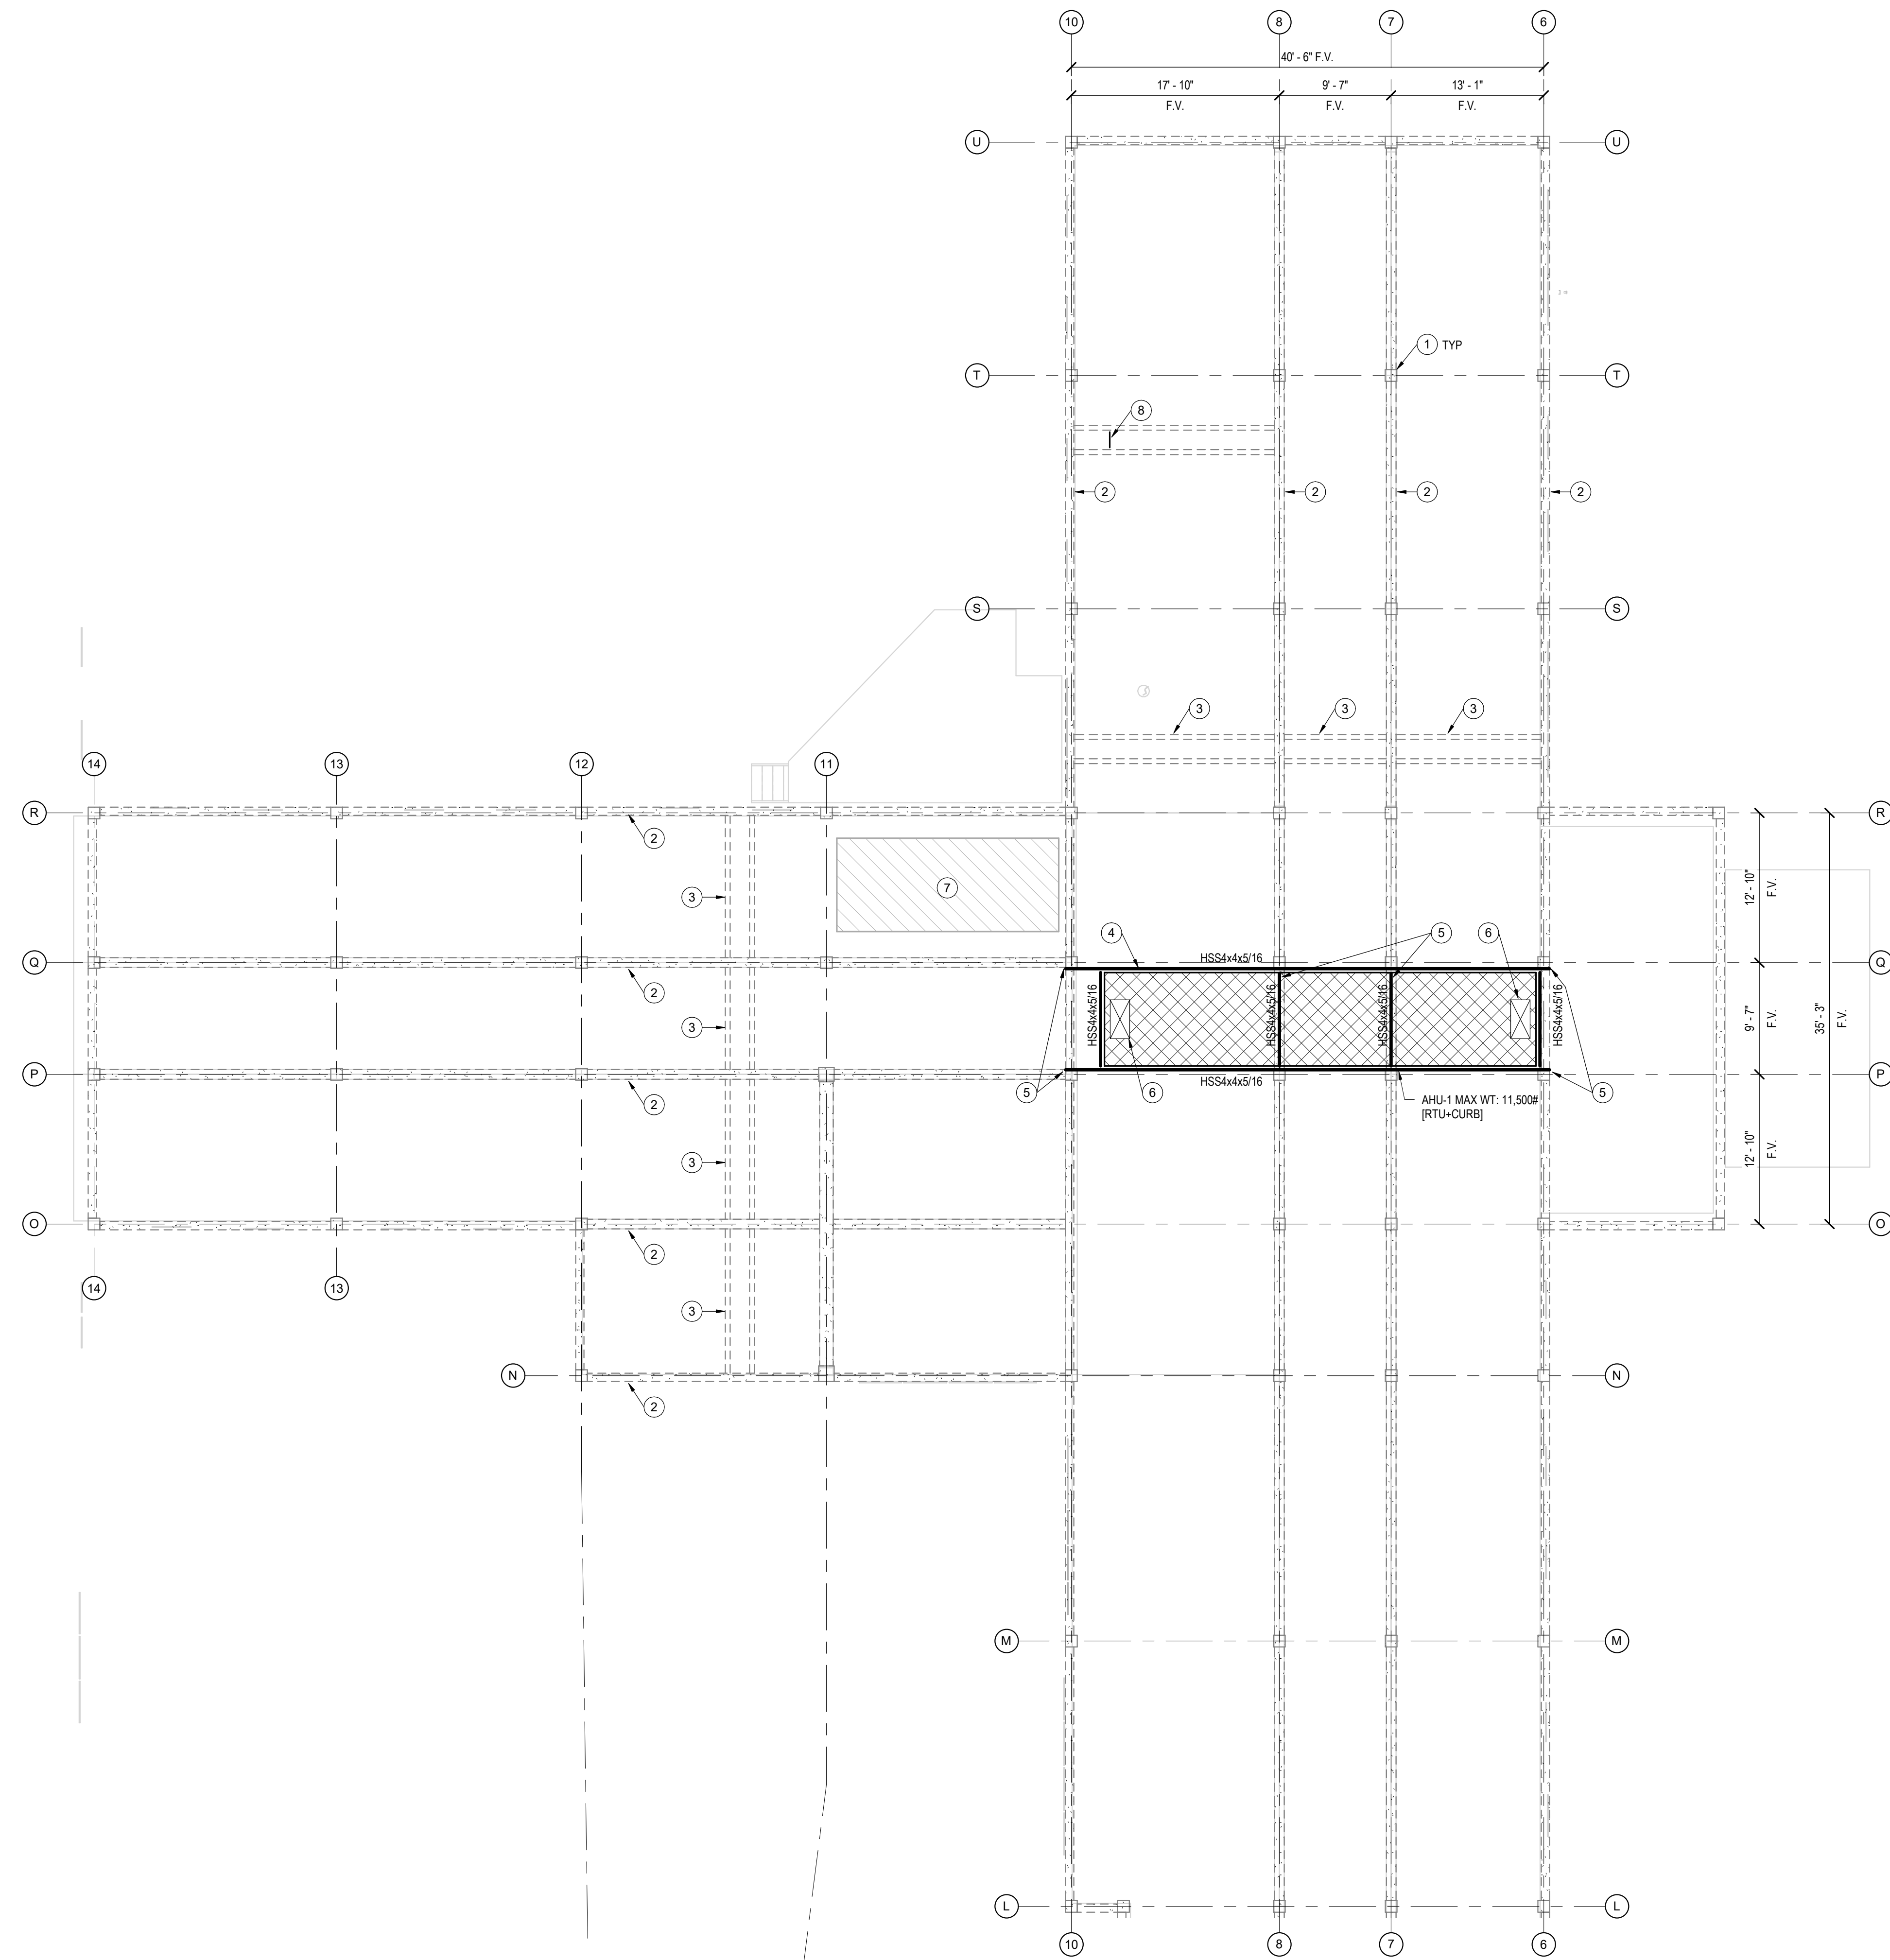

PLAN NOTES:

1 EXISTING CONCRETE COLUMN BELOW, F.V.

2 EXISTING CONCRETE BEAM, F.V.

3 EXISTING CONCRETE JOIST, DIRECTION TYP FOR BAY, F.V.


4 HSS SUPPORT FRAME. SHOP WELD ALL JOINTS. PROVIDE 3/16\" CAP PLATES ON ALL OPEN ENDS AND SEAL WELD ALL AROUND, TYP. FRAME SHALL BE GALVANIZED.

5 PROVIDE (2)ANCHORS MIN AT INTERMEDIATE CROSS BARS INTO CONCRETE BEAM BELOW AND (1)ANCHOR AT CAPPED ENDS, RE: 3SS-200


6 NEW OPENING FOR DUCT PENETRATION, COORD W/ MEP, RE: 4SS-200 FOR SUPPORT FRAMING

7 EXISTING COOLING TOWER TO BE DEMOED, COORD W/ MEP & ARCH

8 CEILING MOUNTED PATIENT LIFT, RE: ARCH FOR LOCATIONS. SEE 5/S200 FOR ATTACHMENT POINT DETAIL.

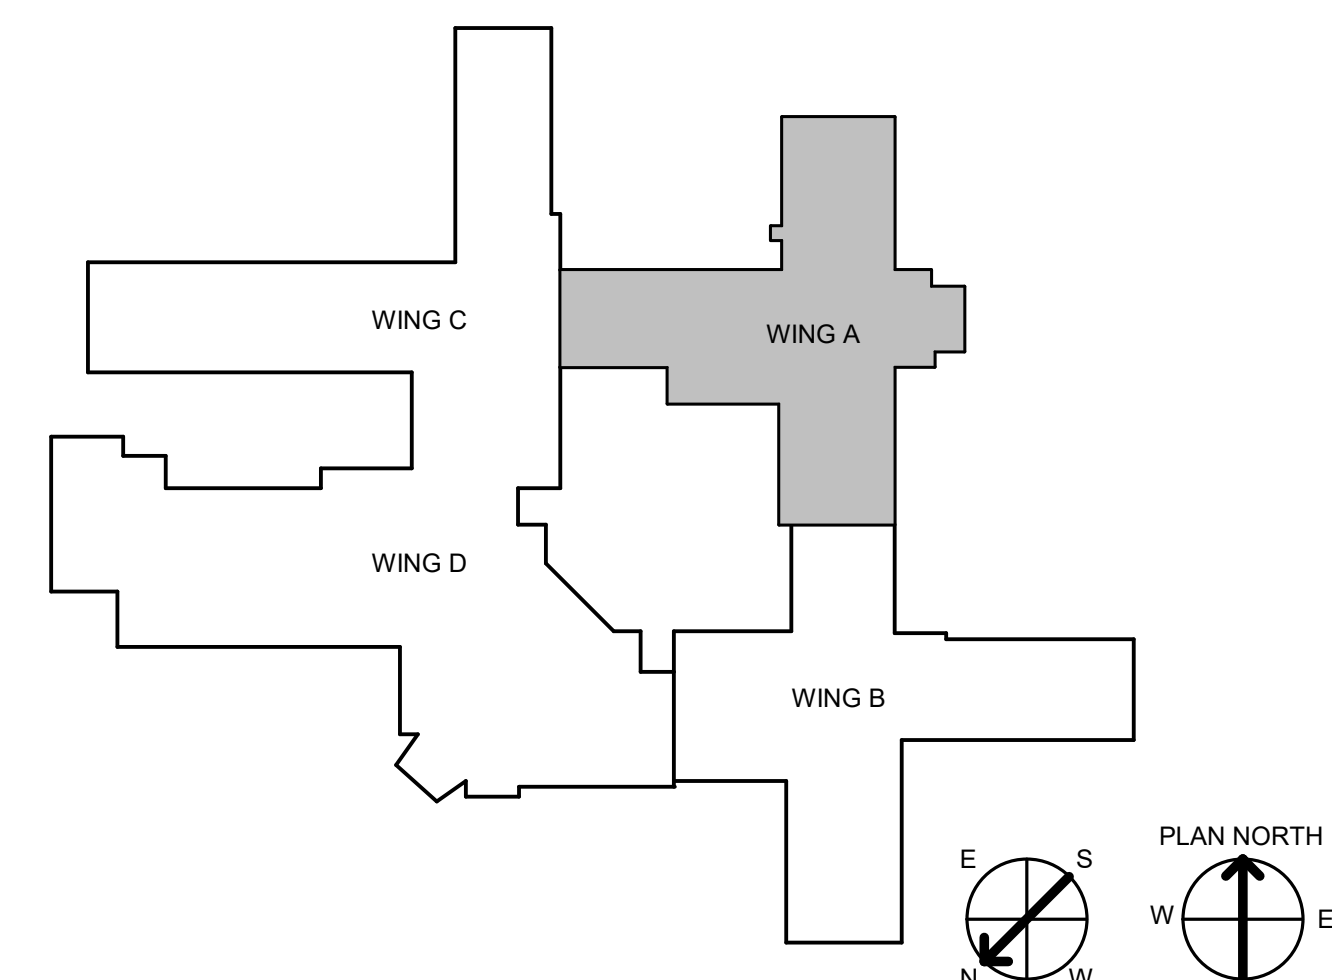


1 ROOF FRAMING PLAN - WING A
1/8" = 1'-0"


CONSULTANT INFORMATION STRUCTURAL / CIVIL ENGINEER: STAND STRUCTURAL ENGINEERING, 8234 ROBINSON ST, OVERLAND PARK, KS 66204, (913) 214-2169 MECHANICAL / ELECTRICAL / PLUMBING / TECHNICAL ENGINEER: SPUR DESIGN, 11020 KING STREET, SUITE 350, OVERLAND PARK, KS 66210, (405) 842-6100 FIRE PROTECTION ENGINEER: POOLE FIRE PROTECTION, INC., 19910 W. 161ST STREET, OLATH, KS 66062, (913) 829-8650		ARCHITECT  312 SW 20th Street, Overland Park, KS 66159, spur-design.com 11020 King Street, Suite 350, Overland Park, KS 66210, spur-design.com		Office of Construction and Facilities Management VA U.S. Department of Veteran Affairs		SHEET TITLE: STRUCTURAL ROOF PLAN - WING A APPROVED: PROJECT DIRECTOR		PROJECT PHASE: BID DOCUMENTS FULLY SPRINKLERED		PROJECT TITLE: RENOVATE A & B WING BUILDING 6 PROJECT LOCATION: 2200 SW GAGE BLVD., TOPEKA, KS 66622		VA PROJECT NUMBER: 589A5-19-116 BUILDING NUMBER: 6 DRAWING NUMBER: 6-SS-101A Dwg. 43 OF 160	
Revision #	Date							DATE: 07/10/2019		CHECKED BY: MJE		DRAWN BY: CRG	


SHEET NOTES
 A. REFERENCE SHEET SS-01 FOR STRUCTURAL GENERAL NOTES AND SS-200 FOR TYPICAL STRUCTURAL DETAILS. REVIEW NOTES & DETAILS FOR APPLICABILITY.
 B. SEE ARCHITECTURAL DRAWING FOR DETAILS & DIMENSIONS NOT SHOWN.
 C. EXISTING INFORMATION PROVIDED IS BASED ON ORIGINAL DRAWINGS AND SHOULD BE VERIFIED IN THE FIELD PRIOR TO BIDDING OR PRODUCTION OF SHOP DRAWINGS.


- PLAN NOTES:**
- 1 EXISTING CONCRETE COLUMN BELOW, F.V.
 - 2 EXISTING CONCRETE BEAM, F.V.
 - 3 EXISTING CONCRETE JOIST, DIRECTION TYP FOR BAY, F.V.
 - 4 HSS SUPPORT FRAME. SHOP WELD ALL JOINTS. PROVIDE 3/16" CAP PLATES ON ALL OPEN ENDS AND SEAL WELD ALL AROUND, TYP. FRAME SHALL BE GALVANIZED.
 - 5 PROVIDE 2 ANCHORS MIN AT INTERMEDIATE CROSS BARS INTO CONCRETE BEAM BELOW AND 1 ANCHOR AT CAPPED ENDS. RE: 3SS-200
 - 6 NEW OPENING FOR DUCT PENETRATION. COORD W/ MEP. RE: 4SS-200 FOR SUPPORT FRAMING
 - 7 EXISTING EXPANSION JOINT
 - 8 W10x19 OPERABLE WALL SUPPORT BEAM BELOW. L4x4x3/8 x 0'-6" ANGLE @ EA END W/ (2) 3/8" Ø x 4 1/2" CONC SCREW ANCHOR TO COL EA END. COORD BEAM ELEVATION W/ ARCH AND OPERABLE PARTITION SUPPLIER.
 - 9 CEILING MOUNTED PATIENT LIFT, RE: ARCH FOR LOCATIONS. SEE 5/SS200 FOR ATTACHMENT POINT DETAIL.

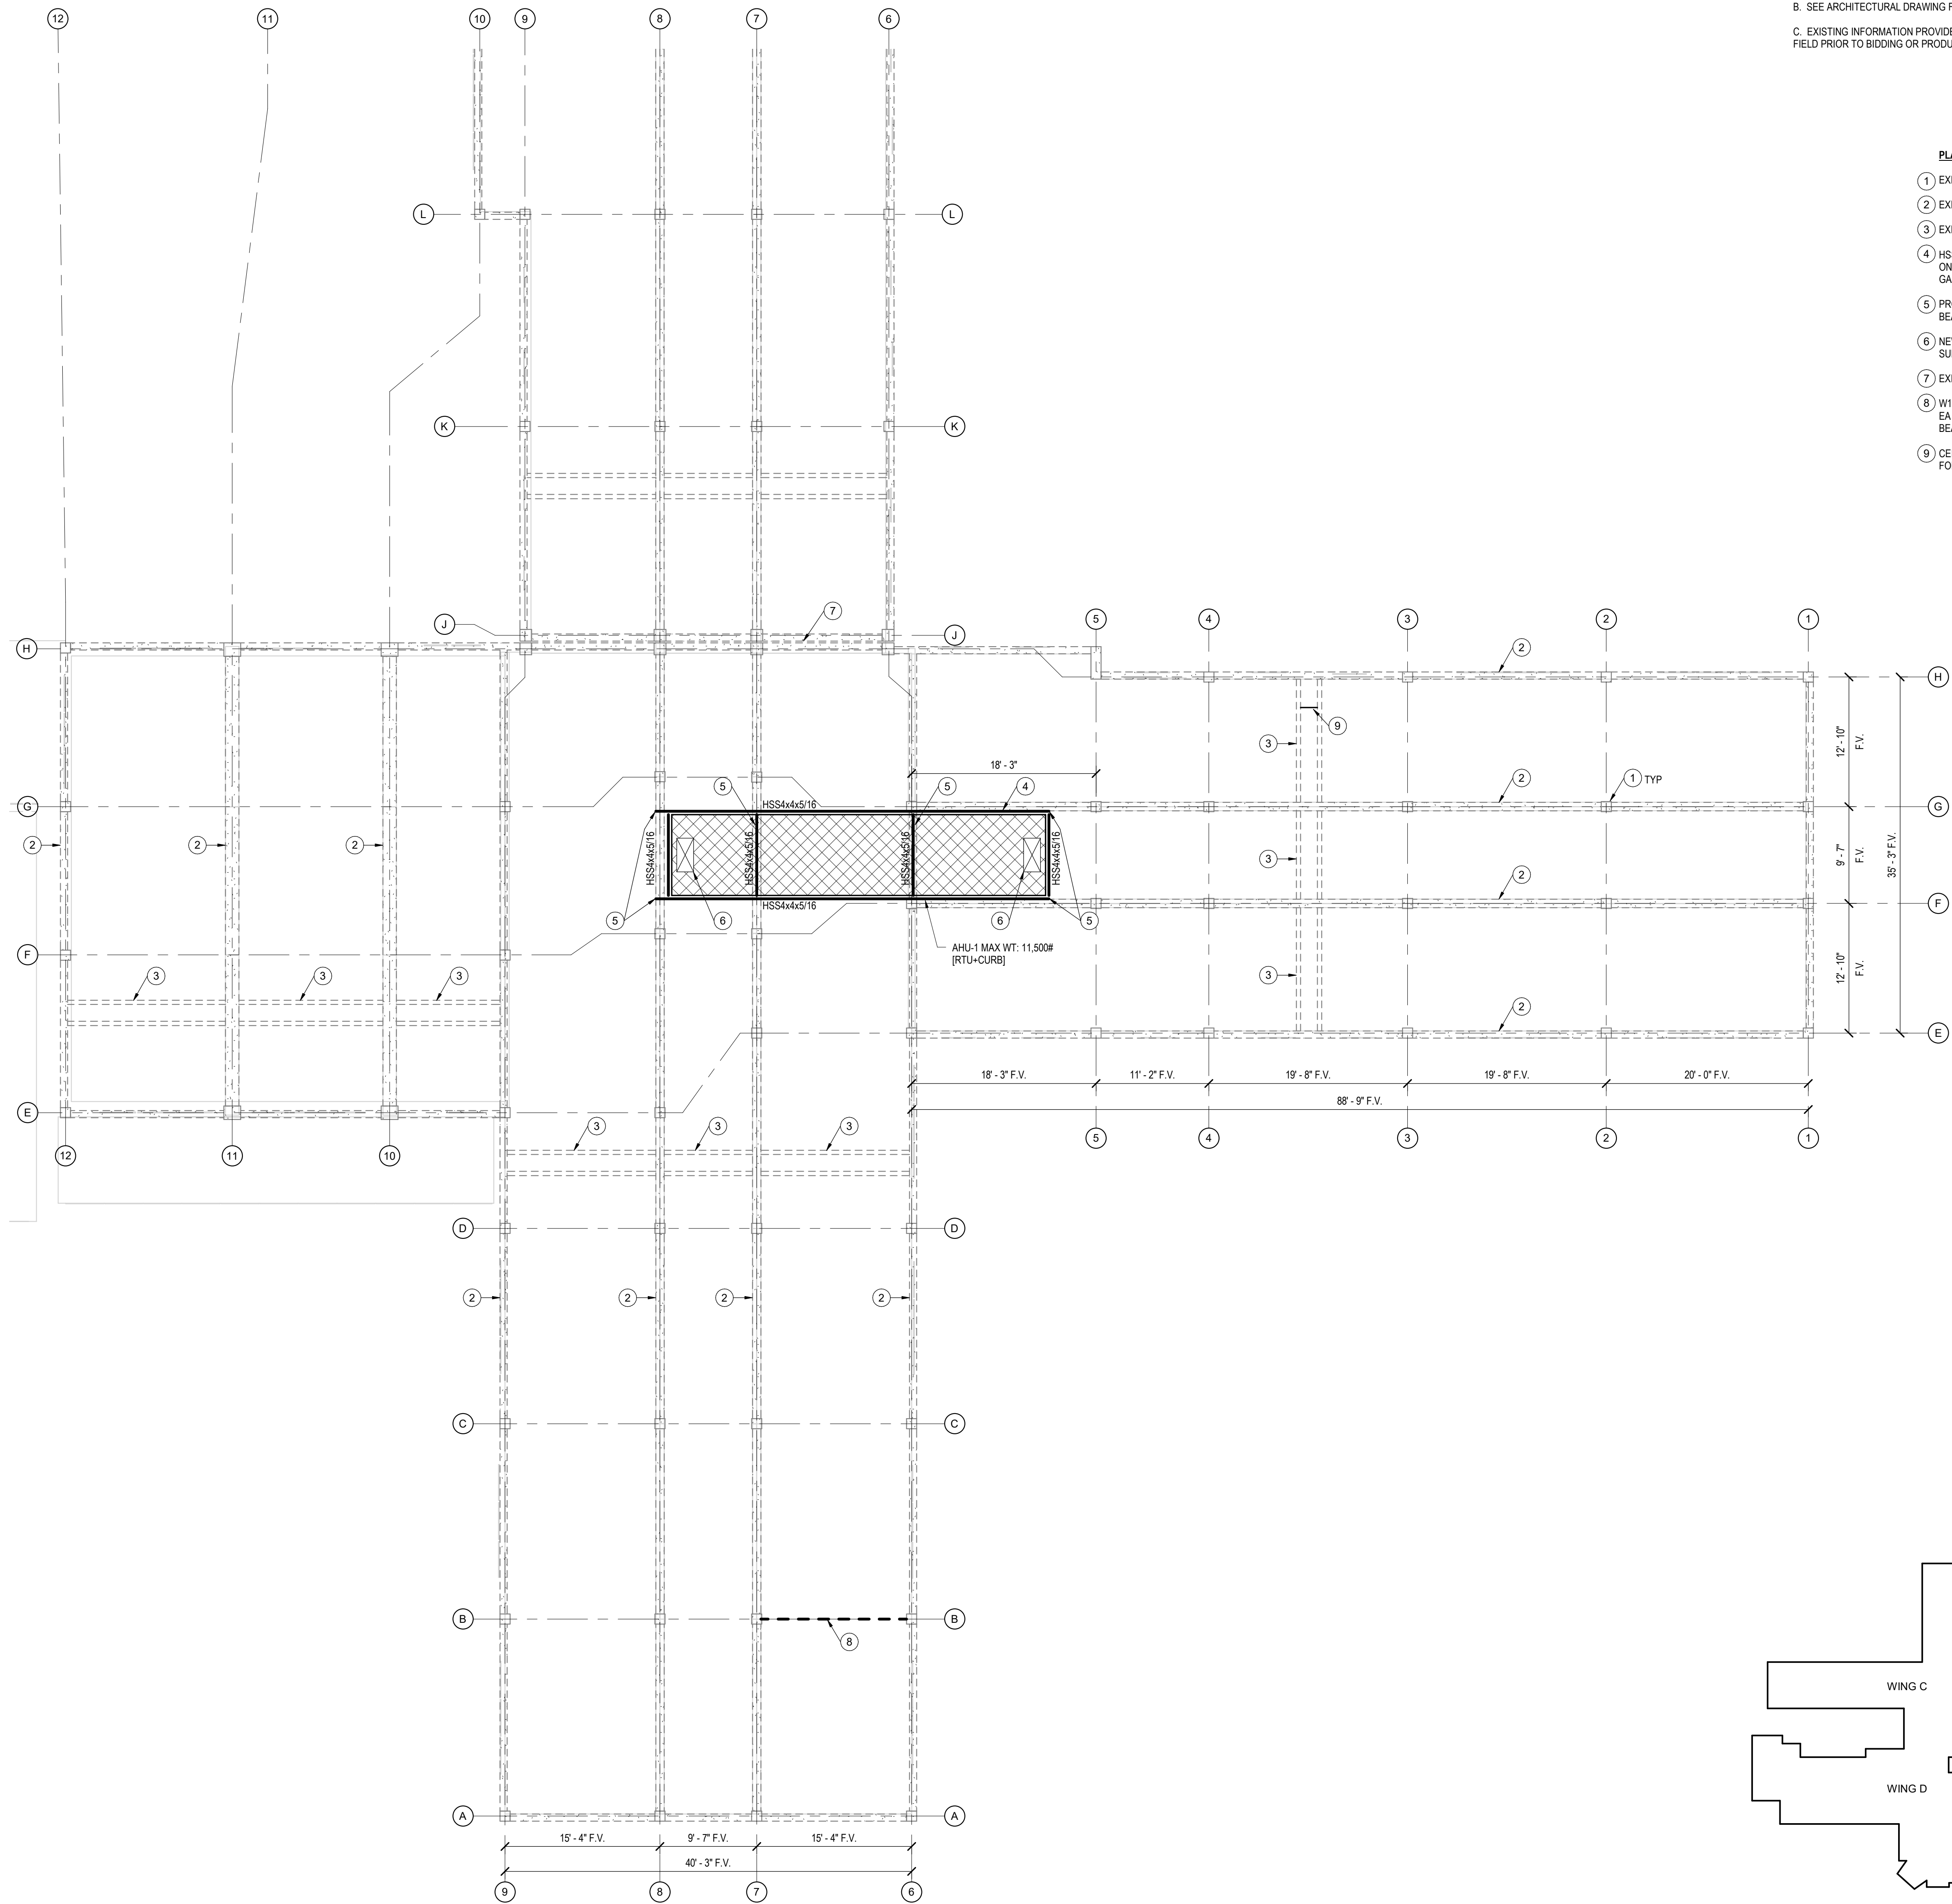

1 ROOF FRAMING PLAN - WING B
 1/8" = 1'-0"

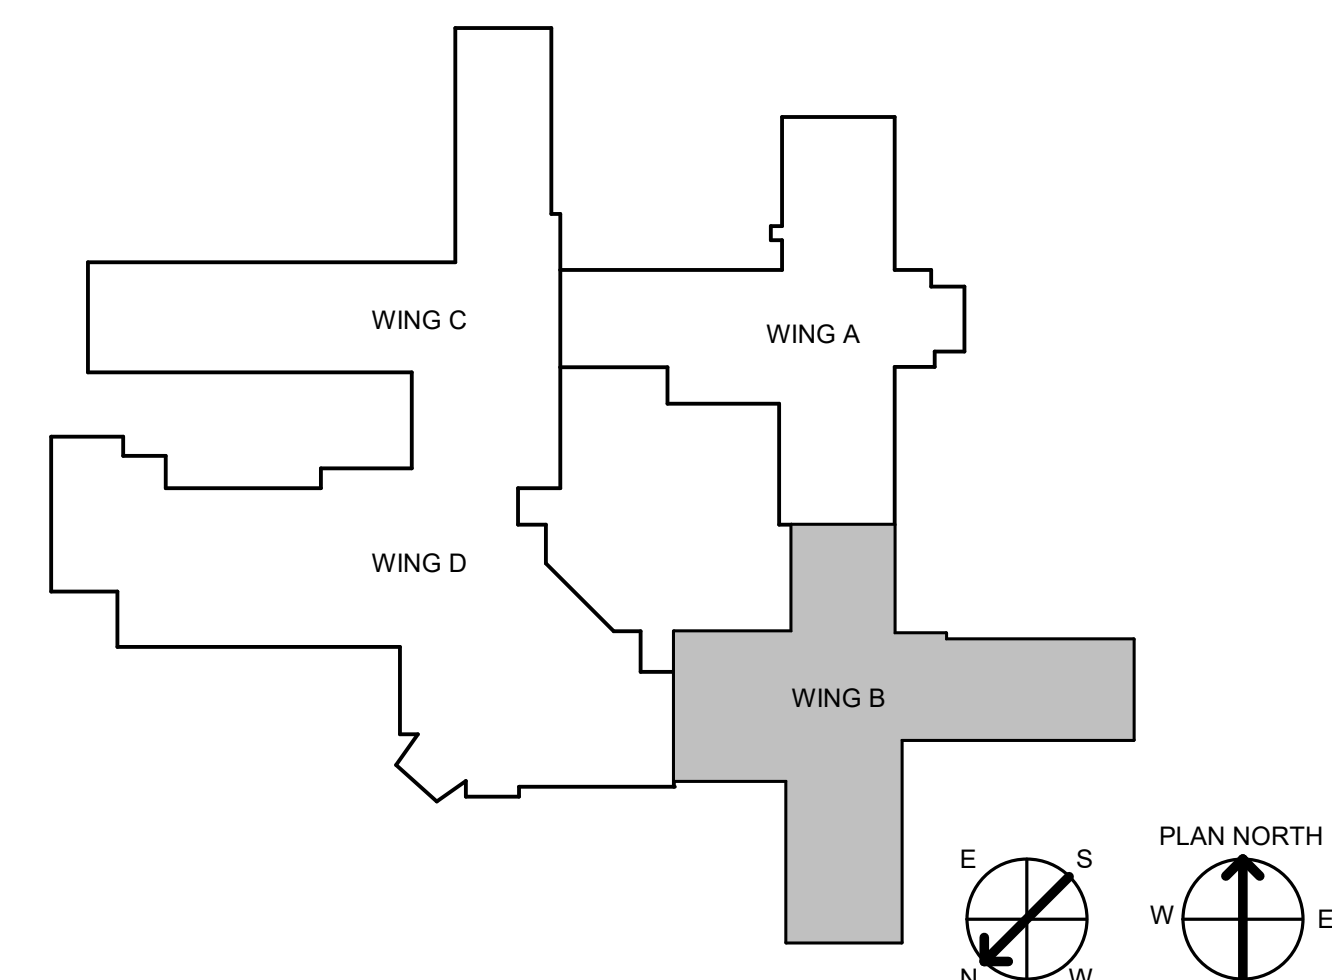


CONSULTANT INFORMATION STRUCTURAL / CIVIL ENGINEER: STAND STRUCTURAL ENGINEERING, 8234 ROBINSON ST, OVERLAND PARK, KS 66204, (913) 214-2169 MECHANICAL / ELECTRICAL / PLUMBING / TECHNICAL ENGINEER: SPUR DESIGN, 11020 KING STREET, SUITE 350, OVERLAND PARK, KS 66210, (405) 842-6100 FIRE PROTECTION ENGINEER: POOLE FIRE PROTECTION, INC., 19910 W. 161ST STREET, OLATH, KS 66062, (913) 829-8650		ARCHITECT  312 1st Street, Overland Park, KS 66110 11020 King Street, Suite 350, Overland Park, KS 66210 KS ARCH REG. NO. A-1139, EXP. 12/31/2019 KS ENGR REG. NO. E-2586, EXP. 12/31/2019		Office of Construction and Facilities Management VA U.S. Department of Veteran Affairs SHEET TITLE: STRUCTURAL ROOF PLAN - WING B PROJECT PHASE: BID DOCUMENTS APPROVED: PROJECT DIRECTOR		PROJECT TITLE: RENOVATE A & B WING BUILDING 6 PROJECT LOCATION: 2200 SW GAGE BLVD., TOPEKA, KS 66622 DATE: 07/10/2019 CHECKED BY: MJE DRAWN BY: CRG		VA PROJECT NUMBER: 589A5-19-116 BUILDING NUMBER: 6 DRAWING NUMBER: 6-SS-101B Dwg. 44 OF 160	
---	--	--	--	--	--	---	--	--	--

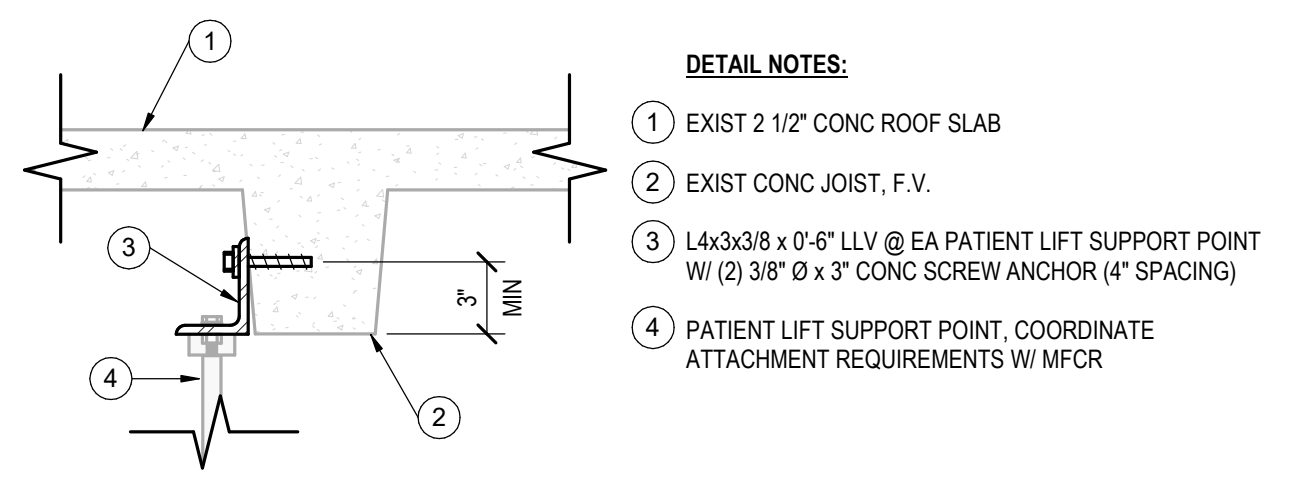


NOTE: SEE ARCH FOR PATIENT LIFT LOCATIONS AND COORDINATE ALL SUPPORT POINT REQUIREMENTS WITH MFCR

5 PATIENT LIFT SUPPORT POINT
1 1/2" = 1'-0"

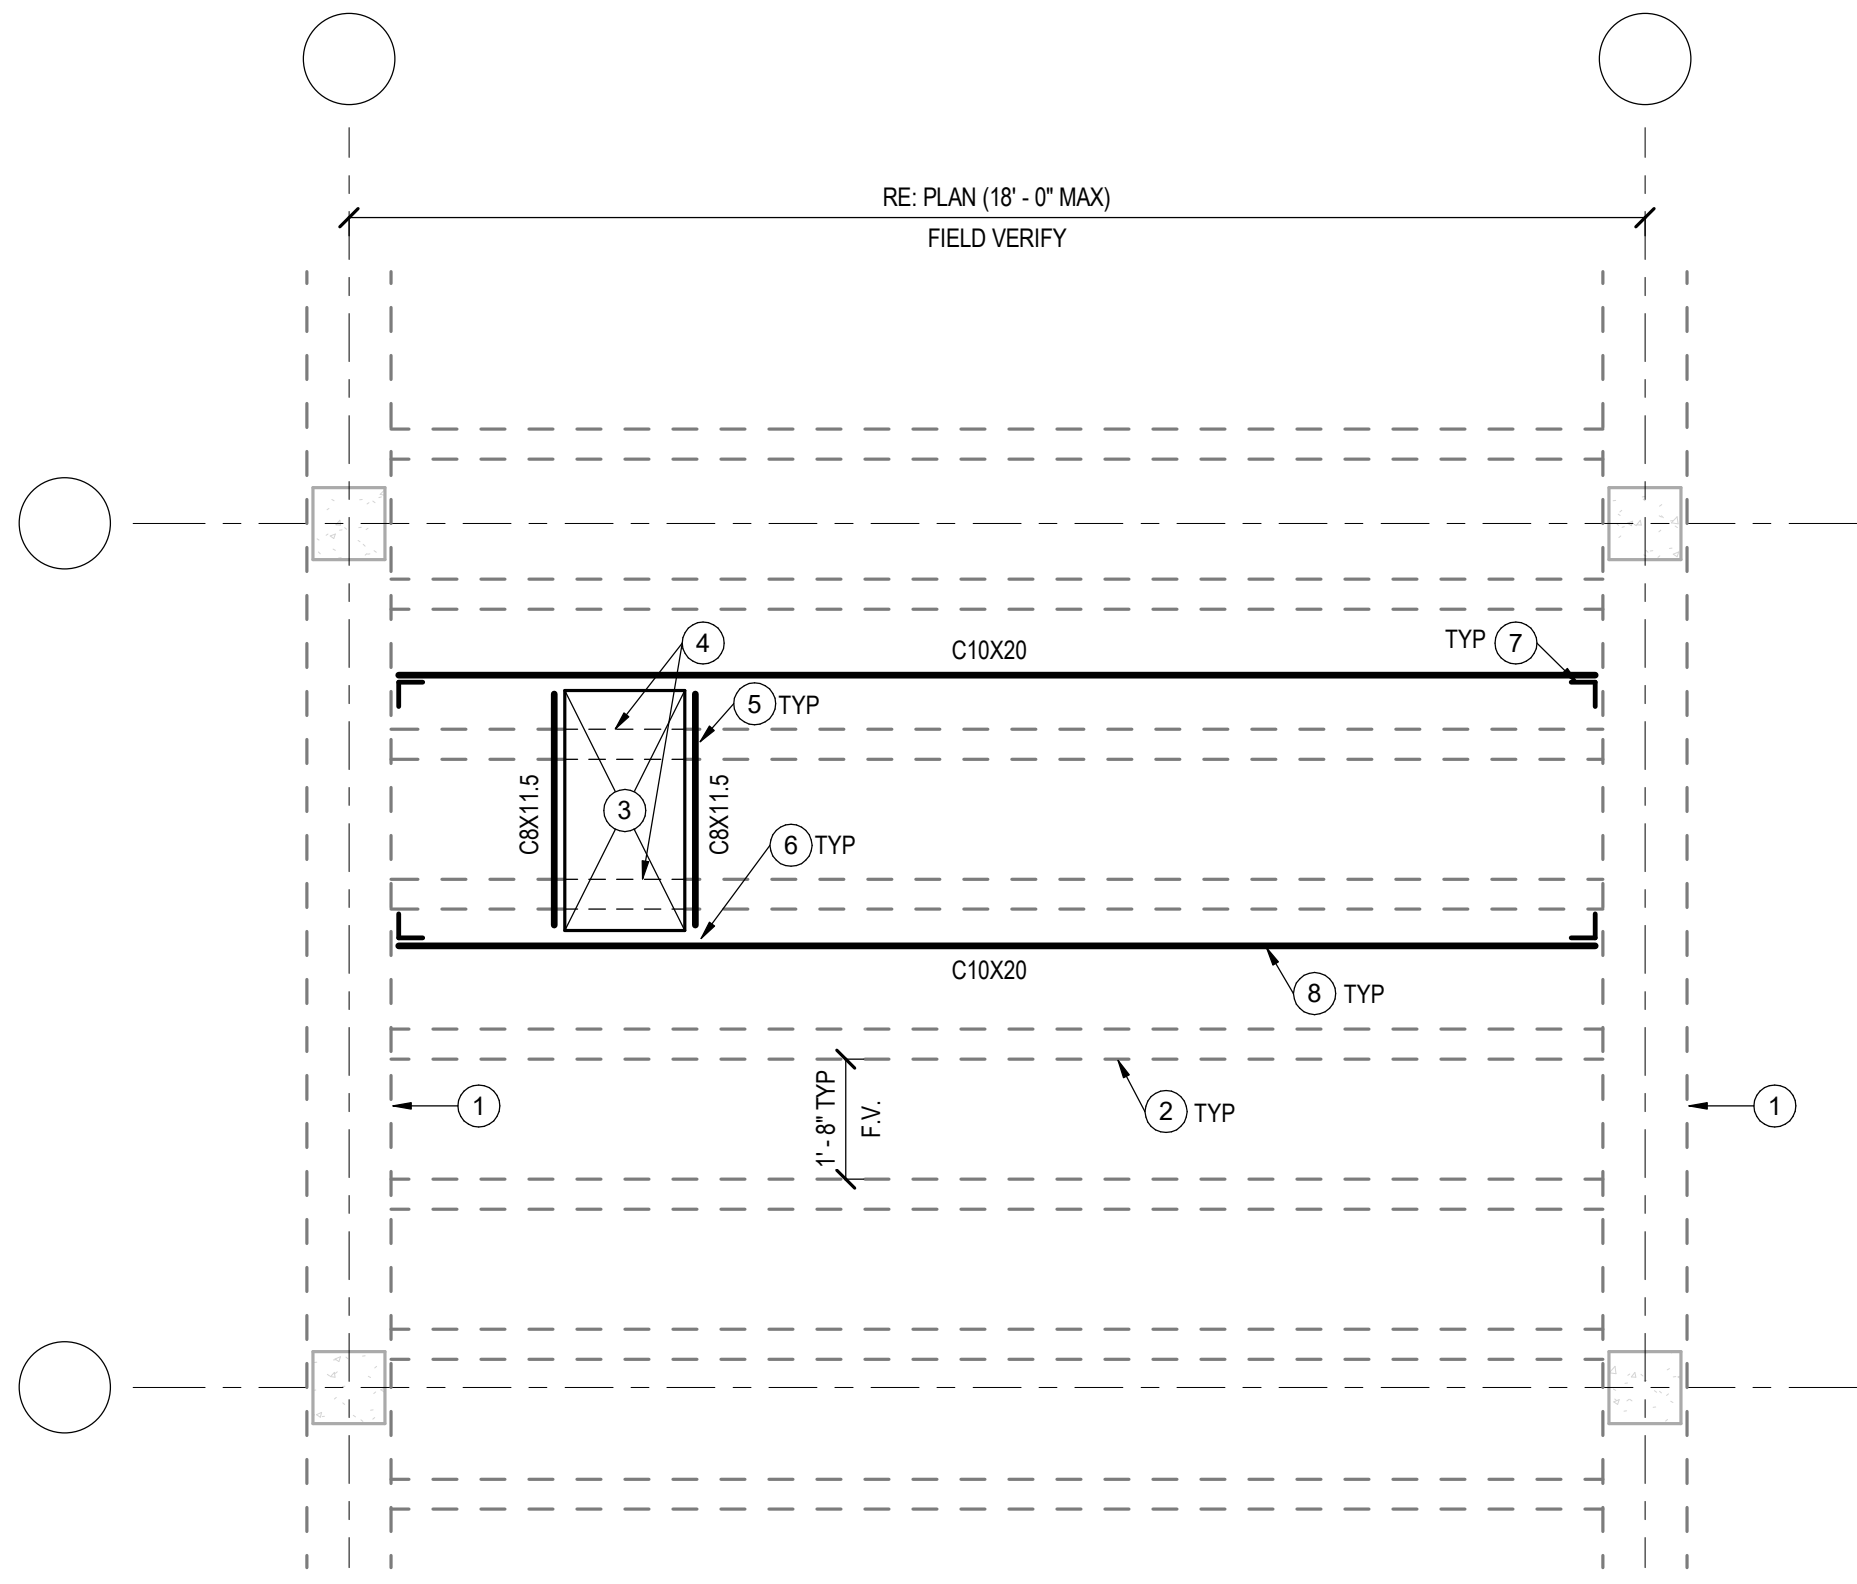


- DETAIL NOTES:**
- EXISTING CONCRETE BEAM
 - EXISTING CONCRETE JOIST - 5" WIDE x 8" TO 10" DEEP, FIELD VERIFY
 - NEW OPENING FOR MECH DUCTWORK, COORD SIZE AND LOCATION WITH MEP AND ARCH
 - SHORE JOIST TO REMAIN AND NEATLY SAWCUT SLAB AND JOIST AS NEEDED TO ACCOMMODATE DUCT OPENING. DETAIL IS APPLICABLE FOR UP TO TWO CUT JOISTS
 - L4x3/8 x 0-6" SEAT WELDED TO CHANNEL TO SUPPORT EXIST CUT JOIST W/ (1) 5/8" Ø x 4 1/2" SCREW ANCHOR INTO CUT JOIST END
 - 3/8" SHEAR TAB W/ (2) 3/4" Ø BOLTS
 - L4x3/8 x 0-8" WELDED TO CHANNEL W/ (2) 5/8" Ø x 4 1/2" SCREW ANCHORS INTO EXISTING CONCRETE BEAM (4" VERTICAL SPACING)
 - INSTALL CHANNEL FRAMING TIGHT TO UNDERSIDE OF EXISTING CONC SLAB

4 ROOF PENETRATION PARTIAL PLAN DETAIL
3/8" = 1'-0"

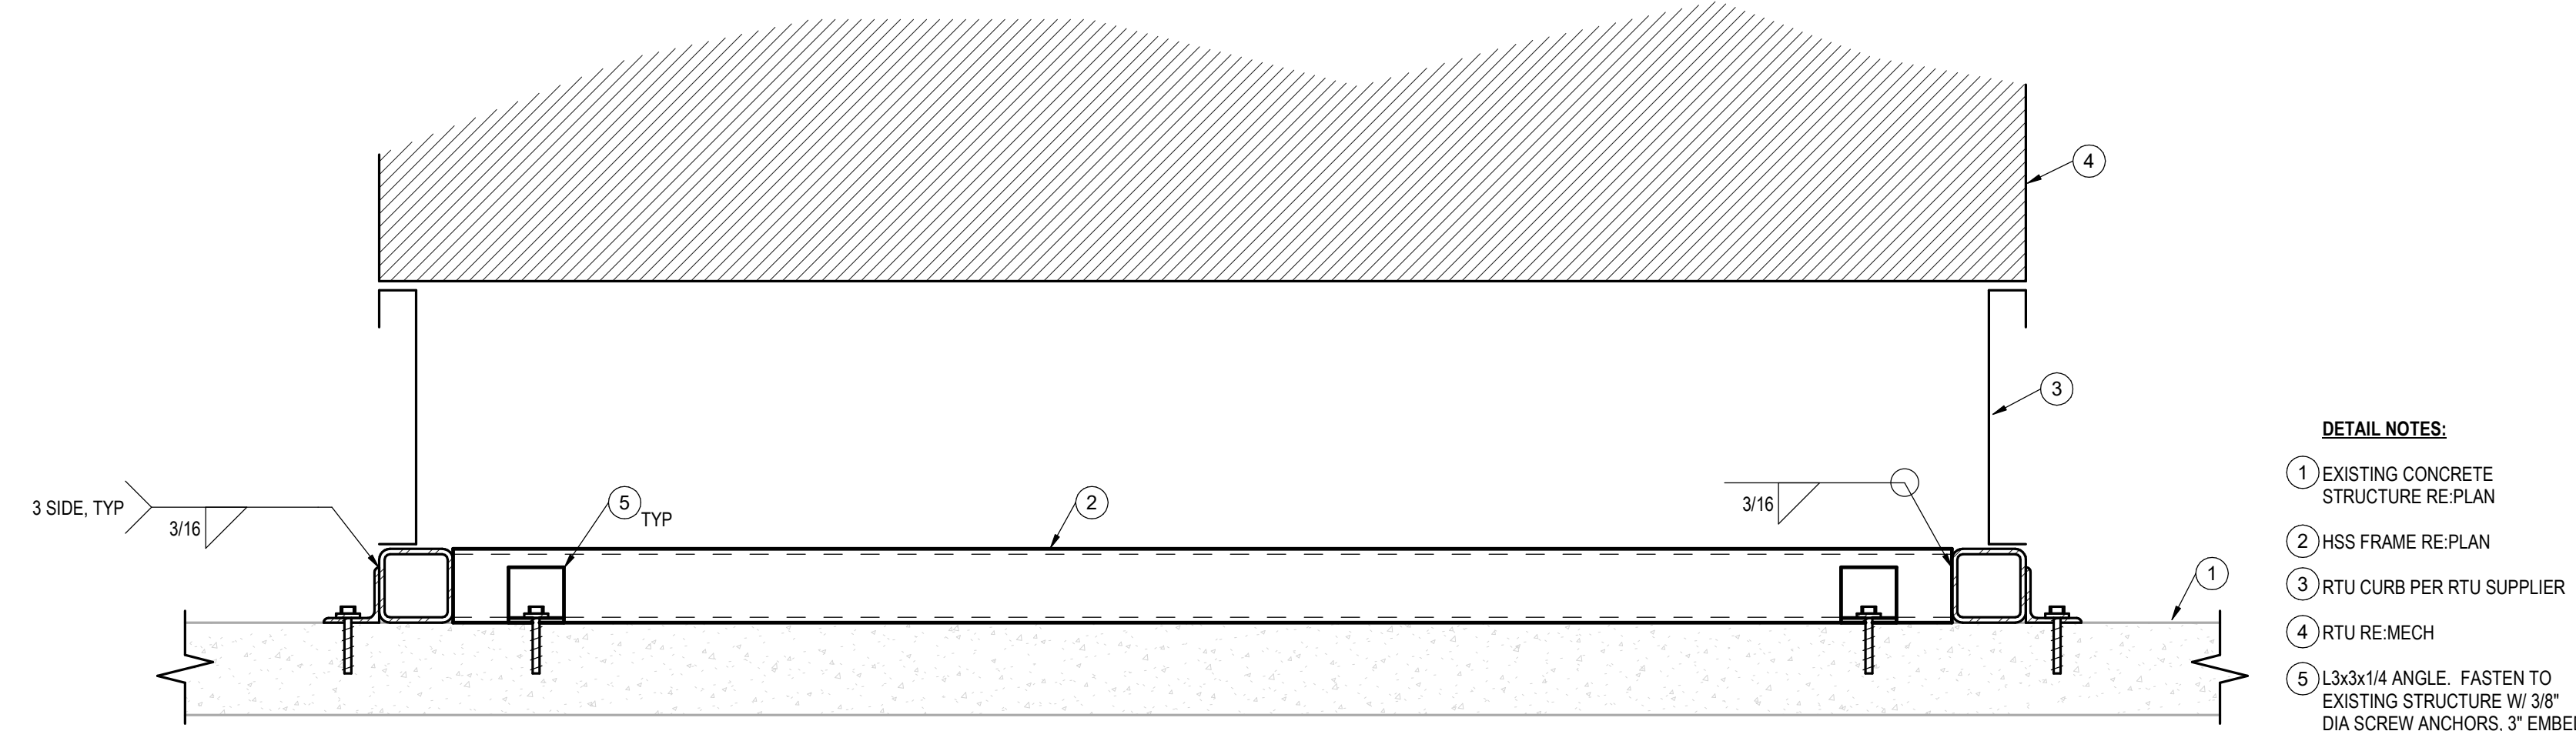

- DETAIL NOTES:**
- EXISTING CONCRETE STRUCTURE RE-PLAN
 - HSS FRAME RE-PLAN
 - RTU CURB PER RTU SUPPLIER
 - RTU RE-MECH
 - L3x3x1/4 ANGLE, FASTEN TO EXISTING STRUCTURE W/ 3/8" DIA SCREW ANCHORS, 3" EMBED


3 RTU SUPPORT
1 1/2" = 1'-0"

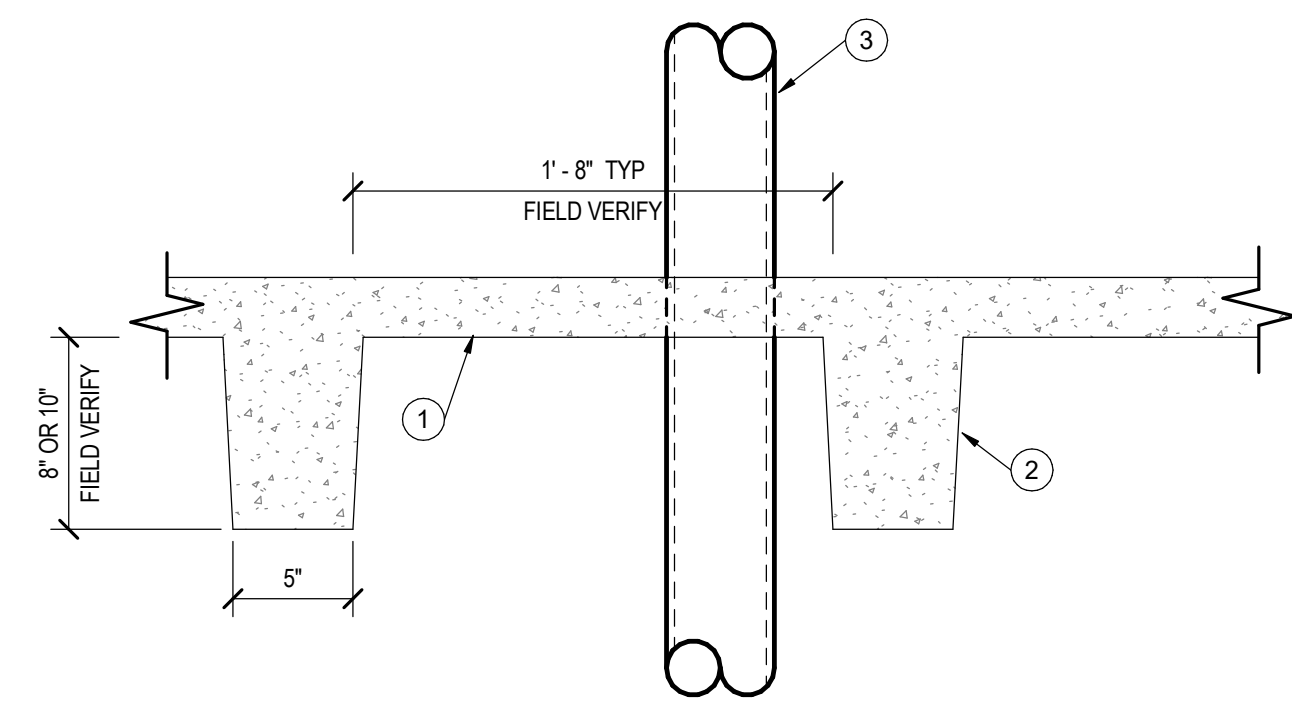


NOTE: WHERE POSSIBLE, LOCATE PIPE PENETRATIONS TO AVOID DAMAGING EXISTING CONCRETE JOISTS

CONDITION 1: PENETRATION BETWEEN CONCRETE JOISTS

- DETAIL NOTES:**
- EXISTING 2 1/2" CONCRETE SLAB
 - EXISTING CONCRETE JOIST
 - NEW PIPE SLEEVE PENETRATION UP TO 8" DIA, NEATLY CORE THROUGH EXISTING CONCRETE
 - NEW C8x11.5 EXTEND LENGTH OF CHANNEL 6'-0" BEYOND THE CUT JOIST LOCATION TOWARDS JOIST MIDSPAN
 - 1/4" PL CONT ALONG LENGTH OF CHANNEL
 - 5/8" DIA x 3" EMBED SCREW ANCHORS @ 12" O.C. (STAGGER SPACING WHEN CHANNELS ON BOTH SIDES)
 - END-PLATE 3/4x6x8 (LLH) BOLTED TO FACE OF CONCRETE GIRDER BEYOND W/ (2) 5/8" DIA x 4" SCREW OR EXPANSION ANCHORS

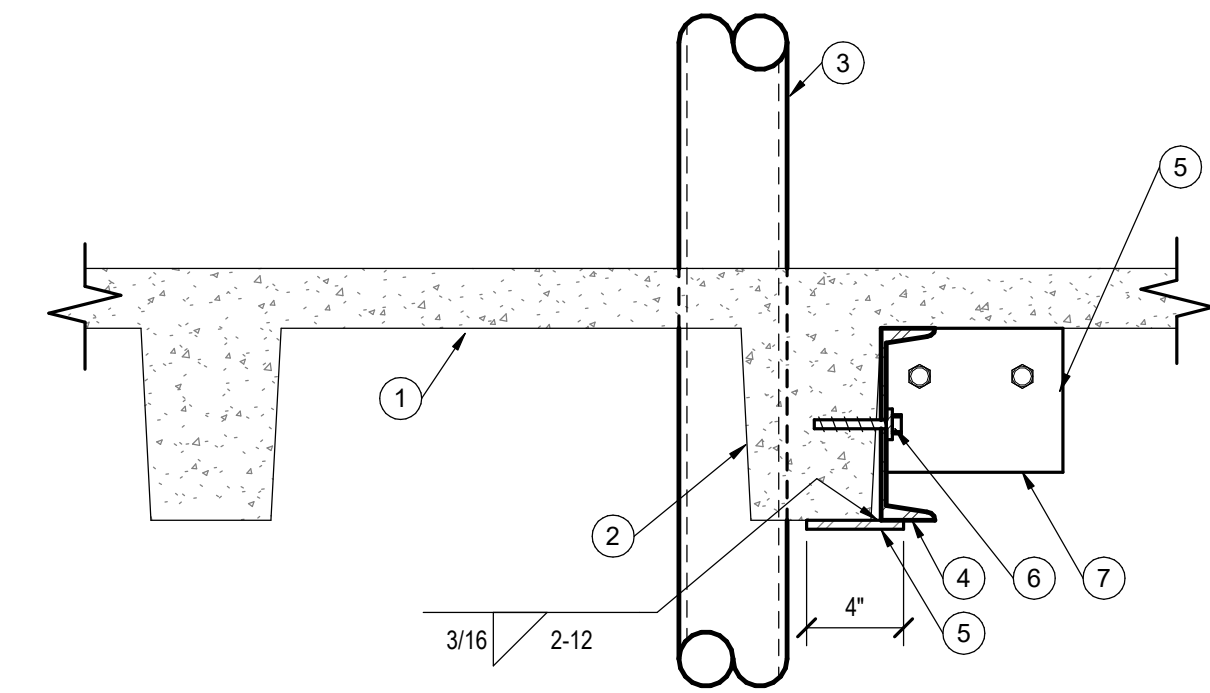

CONDITION 2: LESS THAN HALF OF JOIST WIDTH IS CUT

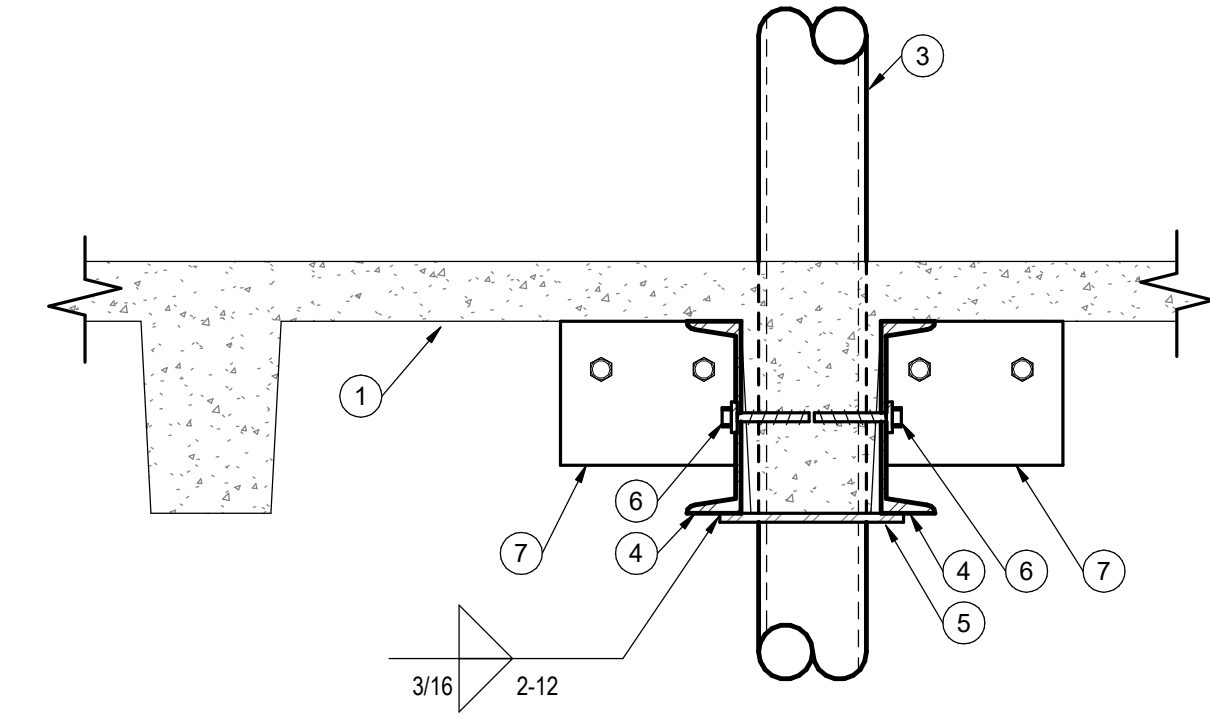


CONDITION 3: MORE THAN HALF OF JOIST WIDTH CUT

2 PIPE PENETRATION DETAILS
1 1/2" = 1'-0"


4" CMU STEEL LINTEL SCHEDULE

MARK	OPENING SIZE	LINTEL SIZE	BRG LEN
L1	UP TO 1'-8"	1/4" PL X WALL WIDTH - 1/2"	4"
L2	1'-9" TO 4'-5"	WT4x6.5	4"
L3	4'-6" TO 6'-3"	WT5x8.5	4"
L4	6'-4" TO 8'-0"	WT6x9.5	8"


- STEEL NOTES:**
- HEIGHT OF MASONRY ABOVE LINTEL MUST BE MINIMUM OF 1/2 THE OPENING WIDTH
 - EQUIVALENT WELDED TWO-PLATE "T" LINTEL MAY BE USED IN LIEU OF WT
 - LINTELS SPECIFICALLY CALLED OUT ON DRAWINGS SHALL GOVERN OVER THIS SCHEDULE

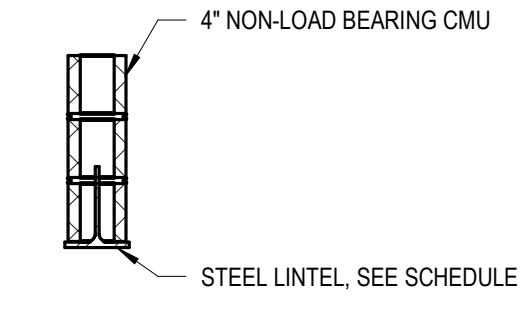

ALTERNATIVE CAST CONCRETE LINTEL
FOR OPENINGS UP TO 6'-0"
PROVIDE 4" BEARING EA END

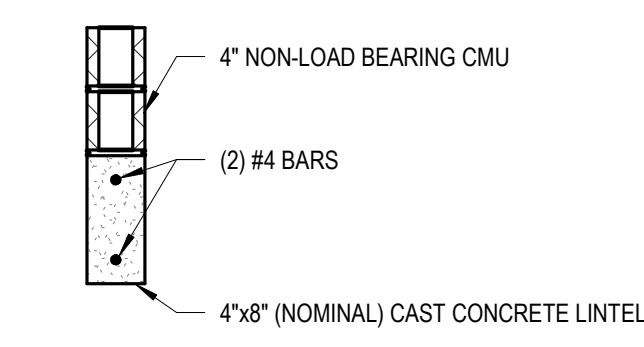

1 4" CMU LINTEL SCHEDULE
1" = 1'-0"

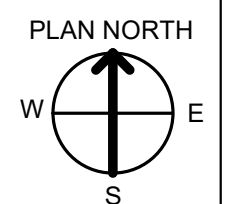

<p>CONSULTANT INFORMATION</p> <p>STRUCTURAL / CIVIL ENGINEER: STAND STRUCTURAL ENGINEERING, 8234 ROBINSON ST, OVERLAND PARK, KS 66204, (913) 214-2169</p> <p>MECHANICAL / ELECTRICAL / PLUMBING / TECHNICAL ENGINEER: SPUR DESIGN, 11020 KING STREET, SUITE 350, OVERLAND PARK, KS 66210, (405) 842-6100</p> <p>FIRE PROTECTION ENGINEER: POOLE FIRE PROTECTION, INC., 19910 W. 161ST STREET, OLATH, KS 66062, (913) 829-8650</p>			<p>ARCHITECT</p> <p>SPUR DESIGN</p> <p>312 5th Street, Overland Park, KS 66209, (913) 214-2169</p> <p>11020 King Street, Suite 350, Overland Park, KS 66210, (405) 842-6100</p> <p>KS ARCH REG. NO. A-1139, EXP. 12/31/2019 KS ENGR REG. NO. E-2586, EXP. 12/31/2019</p>		<p>Office of Construction and Facilities Management</p> <p>VA U.S. Department of Veteran Affairs</p>		<p>SHEET TITLE: STRUCTURAL DETAILS</p> <p>APPROVED: PROJECT DIRECTOR</p>		<p>PROJECT PHASE: BID DOCUMENTS</p> <p>FULLY SPRINKLERED</p>		<p>PROJECT TITLE: RENOVATE A & B WING BUILDING 6</p> <p>PROJECT LOCATION: 2200 SW GAGE BLVD. TOPEKA, KS 66622</p> <p>DATE: 07/10/2019</p> <p>CHECKED BY: MJE</p> <p>DRAWN BY: CRG</p>		<p>VA PROJECT NUMBER: 589A5-19-116</p> <p>BUILDING NUMBER: 6</p> <p>DRAWING NUMBER: 6-SS-200</p> <p>Dwg. 45 OF 160</p>	
--	--	--	--	--	---	--	--	--	--	--	---	--	--	--

GENERAL INFORMATION:

PROPERTY NAME & PHYSICAL ADDRESS: TOPEKA, VA BUILDING 6
RENOVATE A AND B WINGS
TOPEKA, KANSAS

PROJECT CONSTRUCTION PURPOSE: RENOVATION

REASON FOR SUBMITTAL: CODE COMPLIANCE OF FACILITY

CRITERIA USED: VA PROGRAM GUIDE PG-08-15 VOLUME C
INTERNATIONAL BUILDING CODE (IBC), 2018 EDITION
NFPA 1: NATIONAL FIRE CODE, 2018 EDITION
NFPA 10: STANDARD FOR PORTABLE FIRE EXTINGUISHERS, 2018 EDITION
NFPA 13: STANDARD FOR THE INSTALLATION OF SPRINKLER SYSTEMS, 2019 EDITION
NFPA 70: NATIONAL ELECTRICAL CODE, 2017 EDITION
NFPA 72: NATIONAL FIRE ALARM AND SIGNALING CODE, 2019 EDITION
NFPA 80: STANDARD FOR FIRE DOORS AND OTHER OPENING PROTECTIVES, 2019 EDITION
NFPA 90A: STANDARD FOR THE INSTALLATION OF AIR-CONDITIONING AND VENTILATING SYSTEMS, 2018 EDITION
NFPA 101: LIFE SAFETY CODE, 2018 EDITION
NFPA 170: STANDARD FOR FIRE SAFETY AND EMERGENCY SYMBOLS, 2018 EDITION
VA FIRE PROTECTION DESIGN MANUAL SEVENTH EDITION - DECEMBER 2015

ANTICIPATED ADDITIONS: NONE

DATE DEVELOPED: MAY 3, 2019

DATE MODIFIED: 5/3/2019

OWNER INFORMATION: US DEPARTMENT OF VETERANS AFFAIRS

CODE CONSULTANT INFORMATION: POOLE FIRE PROTECTION, INC.
19910 WEST 161ST STREET
OLATHE, KS 66062
913.829.8650 (TELEPHONE)
913.829.8690 (TELEFAX)

DESIGNER'S SEAL: SEE TITLE BLOCK

FIRE SERVICE: TOPEKA FIRE DEPARTMENT

LOCAL BUILDING INSPECTOR: VISN SAFETY OFFICER

AUTHORITY HAVING JURISDICTION: US DEPARTMENT OF VETERANS AFFAIRS

OCCUPANCY GROUP AND TYPE:

IBC OCCUPANCY:
MIXED-USE NON-SEPARATED (IBC, SECTION 508.3.3)
BUSINESS (GROUP B) (IBC, SECTION 304)
RESIDENTIAL GROUP R-4 (IBC, SECTION 310.2)
INSTITUTIONAL (GROUP I-2) (IBC, SECTION 308.3)

NFPA 101 OCCUPANCY:
MIXED OCCUPANCIES (NFPA 101, SECTION 6.1.14.3)
NEW BUSINESS (NFPA 101, SECTION 6.1.11)
NEW RESIDENTIAL BOARD & CARE (NFPA 101, SECTION 6.1.9)
HEALTH CARE (NFPA 101, SECTION 6.1.5)

TYPE OF CONSTRUCTION: TYPE II (000) (NFPA 220, TABLE 4.1.1), TYPE IIB IBC

STRUCTURAL CODE REQUIREMENTS:

HEIGHT LIMITATION (IBC, TABLE 504.3, 504.4)*	
ALLOWABLE HEIGHT INSTITUTIONAL (GROUP I-2)	1 STORY, 55 FT
ACTUAL HEIGHT	1 STORY, 17 FT - COMPLIANT

AREA LIMITATION (IBC, TABLE 506.2)*	
ALLOWABLE AREA INSTITUTIONAL (GROUP I-2)	48,180 SQ FT
ACTUAL AREA	34,527 SQ FT - COMPLIANT

* BASED ON THE MOST RESTRICTIVE WHICH IS I-2

AHJ APPROVED EQUIVALENCIES: NOT APPLICABLE

FIRE DEPARTMENT NEEDS:

FIRE DEPARTMENT ACCESS: AT LEAST ONE MEANS OF ALL-WEATHER GROUND ACCESS NO FARTHER THAN 50 FT FROM THE BUILDING REQUIRED (NFPA 1 AND VA STANDARDS) - PROVIDED (EXISTING)

FIRE DEPARTMENT ACCESS ROADS SUCH THAT ANY PORTION OF THE FACILITY OR ANY PORTION OF AN EXTERIOR WALL OF THE FIRST STORY OF THE BUILDING IS LOCATED NOT MORE THAN 450 FT FROM FIRE DEPARTMENT ACCESS ROADS REQUIRED (NFPA 1, SECTION 18.2.3.2.2.1) - PROVIDED (EXISTING)

FIRE APPARATUS ACCESS ROADS MUST HAVE AN UNOBSTRUCTED WIDTH OF NOT LESS THAN 20 FT AND AN UNOBSTRUCTED VERTICAL CLEARANCE OF NOT LESS THAN 13.5 FT REQUIRED (NFPA 1, SECTIONS 18.2.3.4.1.1 & 18.2.3.4.1.2) - PROVIDED (EXISTING)

FIRE HYDRANTS: FIRE HYDRANT SPACING SUCH THAT ALL PARTS OF THE BUILDING EXTERIOR ARE WITHIN 400 FT OF A FIRE HYDRANT REQUIRED (NFPA 1, SECTION 18.5) - PROVIDED (EXISTING)

FIRE HYDRANT SPACING SUCH THAT ALL FIRE DEPARTMENT CONNECTIONS ARE WITHIN 50 FEET OF A FIRE HYDRANT REQUIRED (VAFPDM, SECTION 5.6.B) - PROVIDED (EXISTING)

FIRE SAFETY AND EVACUATION PLANS: NOT REQUIRED (NFPA 101) - NOT PROVIDED

FIRE COMMAND CENTER: NOT REQUIRED (NFPA 101) - NOT PROVIDED

WATER SUPPLY REQUIREMENTS:

FIRE HYDRANT FLOW TEST (HISTORICAL): 60 PSI STATIC, 57 PSI RESIDUAL, FLOWING 853 GPM

FIRE FLOW: 1000 GPM AT 20 PSI

FIRE WATER DEMAND: 300 GPM AT 50 PSI

ACTIVE FIRE SAFETY FEATURES:

AUTOMATIC SPRINKLER SYSTEMS: REQUIRED (NFPA 101) - PROVIDED

LOCATION OF FIRE DEPARTMENT CONNECTIONS: FIRE DEPARTMENT CONNECTIONS PROVIDED WITH A FIRE HYDRANT WITHIN 50 FT OF THE FIRE DEPARTMENT CONNECTION REQUIRED (VA FIRE PROTECTION DESIGN MANUAL 5.6.B) - PROVIDED

FIRE DEPARTMENT CONNECTIONS WITH 150 FT OF ALL-WEATHER GROUND ACCESS SURFACE REQUIRED - PROVIDED

ANALYSIS OF AUTOMATIC SPRINKLER AND SUPPRESSION SYSTEMS AND PROTECTED AREAS: 300 GPM AT 50 PSI FOR 60 MINUTES REQUIRED (NFPA 13, FIGURE 19.3.3.1.1 - PROVIDED

FIRE PUMP: NOT REQUIRED - NOT PROVIDED

STANDPIPE SYSTEMS: NOT REQUIRED (IBC) - NOT PROVIDED

PORTABLE FIRE EXTINGUISHERS: REQUIRED (NFPA 101, SECTION 32.3.3.5.7) - PROVIDED

FIRE ALARM SYSTEM: REQUIRED (NFPA 101, SECTION 32.3.3.4) - PROVIDED

CONNECTION TO AND DESCRIPTION OF FIRE ALARM REPORTING SYSTEM: REQUIRED (VA DESIGN MANUAL TABLE 7.3) - PROVIDED

SMOKE DETECTION: REQUIRED (NFPA 101, SECTION 32.3.3.4) - PROVIDED
SMOKE DETECTOR ABOVE FIRE ALARM CONTROL UNIT, NOTIFICATION APPLIANCE CIRCUIT POWER EXTENDERS, AND SUPERVISING STATION TRANSMITTING EQUIPMENT REQUIRED (NFPA 72, SECTION 10.4.4) AND IN SLEEPING ROOMS (NFPA 101) - PROVIDED

CARBON MONOXIDE DETECTION: NOT REQUIRED (NFPA 101, SECTION 32.3.3.4.9) - NOT PROVIDED
NO FUEL FIRED EQUIPMENT PRESET IN BUILDING

SMOKE MANAGEMENT OR CONTROL METHODS: NOT REQUIRED - NOT PROVIDED

ILLUMINATION OF MEANS OF EGRESS: REQUIRED (NFPA 101, SECTIONS 38.2.8 AND 7.8) - PROVIDED

EMERGENCY LIGHTING: REQUIRED (NFPA 101, SECTION 38.2.9.1) - PROVIDED

MARKING OF MEANS OF EGRESS: REQUIRED (NFPA 101, SECTIONS 7.10, 32.2.10 AND 38.2.10 - PROVIDED
EVACUATION DIAGRAM REQUIRED (NFPA 101, SECTIONS 7.10.8.5 AND 12.2.10.3) - PROVIDED

PASSIVE FIRE SAFETY FEATURES:

FIRE BARRIER AND OCCUPANCY SEPARATION: REQUIRED (NFPA 101, TABLE 6.2.4.1.1.A) - PROVIDED
BOARD AND CARE OCCUPANCIES ARE REQUIRED TO BE SEPARATED FROM HEALTH CARE OCCUPANCIES AND HEALTH CARE OCCUPANCIES BY 2-HR RATED CONSTRUCTION - PROVIDED

PROTECTION OF HORIZONTAL AND VERTICAL PENETRATIONS: THROUGH PENETRATIONS OF FIRE RESISTANCE RATED CONSTRUCTION PROTECTED BY AN APPROVED FIRE STOP SYSTEM INSTALLED AS TESTED IN ACCORDANCE WITH ASTM 814 OR UL 1479 REQUIRED (IBC, SECTION 714.4.1.2 AND NFPA 101, SECTION 8.3.4.2) - PROVIDED

PROTECTION OF HAZARDOUS AREAS: 1-HOUR FIRE BARRIER REQUIRED (NFPA 101, 18.3.2 AND TABLE 32.3.3.2.2) - PROVIDED

BUILDING SEPARATION AND EXPOSURE PROTECTION: NOT REQUIRED (IBC, TABLE 602) - NOT PROVIDED AS BUILDING SEPARATION DISTANCE EXCEEDS 30 FEET

EXIT ACCESS CORRIDORS: REQUIRED (NFPA 101, 32.2.3.6) - PROVIDED 1/2 HOUR RATING REQUIRED AS BUILDING IS PROVIDED WITH AN AUTOMATIC SPRINKLER SYSTEM IN THE RESIDENTIAL BOARD AND CARE. CORRIDOR WALLS SHALL FORM A BARRIER TO LIMIT THE TRANSFER OF SMOKE IN HEALTH CARE (NFPA 101, 18.3.6.2.3)


FIRE RESISTIVE REQUIREMENTS: FIRE-RESISTANCE RATING REQUIREMENTS FOR BUILDING ELEMENTS (IBC, TABLES 601 & 602)
PRIMARY STRUCTURAL FRAME 0-HOUR REQUIRED - PROVIDED
BEARING WALLS - EXTERIOR 0-HOUR REQUIRED - PROVIDED
BEARING WALLS - INTERIOR 0-HOUR REQUIRED - PROVIDED
NON BEARING WALLS - EXTERIOR 0-HOUR REQUIRED - PROVIDED
NON BEARING WALLS - INTERIOR 0-HOUR REQUIRED - PROVIDED
FLOOR CONSTRUCTION AND SECONDARY MEMBERS 0-HOUR REQUIRED - PROVIDED
ROOF CONSTRUCTION AND SECONDARY MEMBERS 0-HOUR REQUIRED - PROVIDED

INTERIOR FINISH: INTERIOR FINISH REQUIREMENTS PER OCCUPANCY CLASSIFICATION (NFPA 101, SECTIONS 32.3.3 AND 38.3.3) - PROVIDED

OCCUPANCY TYPE	INTERIOR WALL AND CEILING FINISHES IN EXITS AND EXIT ACCESS CORRIDORS	INTERIOR WALL AND CEILING FINISHES IN OTHER AREAS	INTERIOR FLOOR FINISHES IN EXIT ENCLOSURES	INTERIOR FLOOR FINISHES IN OTHER AREAS
RESIDENTIAL BOARD AND CARE	CLASS A	CLASS A OR B	CLASS I OR II	CLASS I, II, OR III
BUSINESS	CLASS A OR B	CLASS A, B, OR C	CLASS I OR II	CLASS I, II, OR III



Poole Fire Protection
19910 West 161st Street
Olathe, KS 66062
www.poolefire.com
913.829.8650 office • 913.829.8690 fax

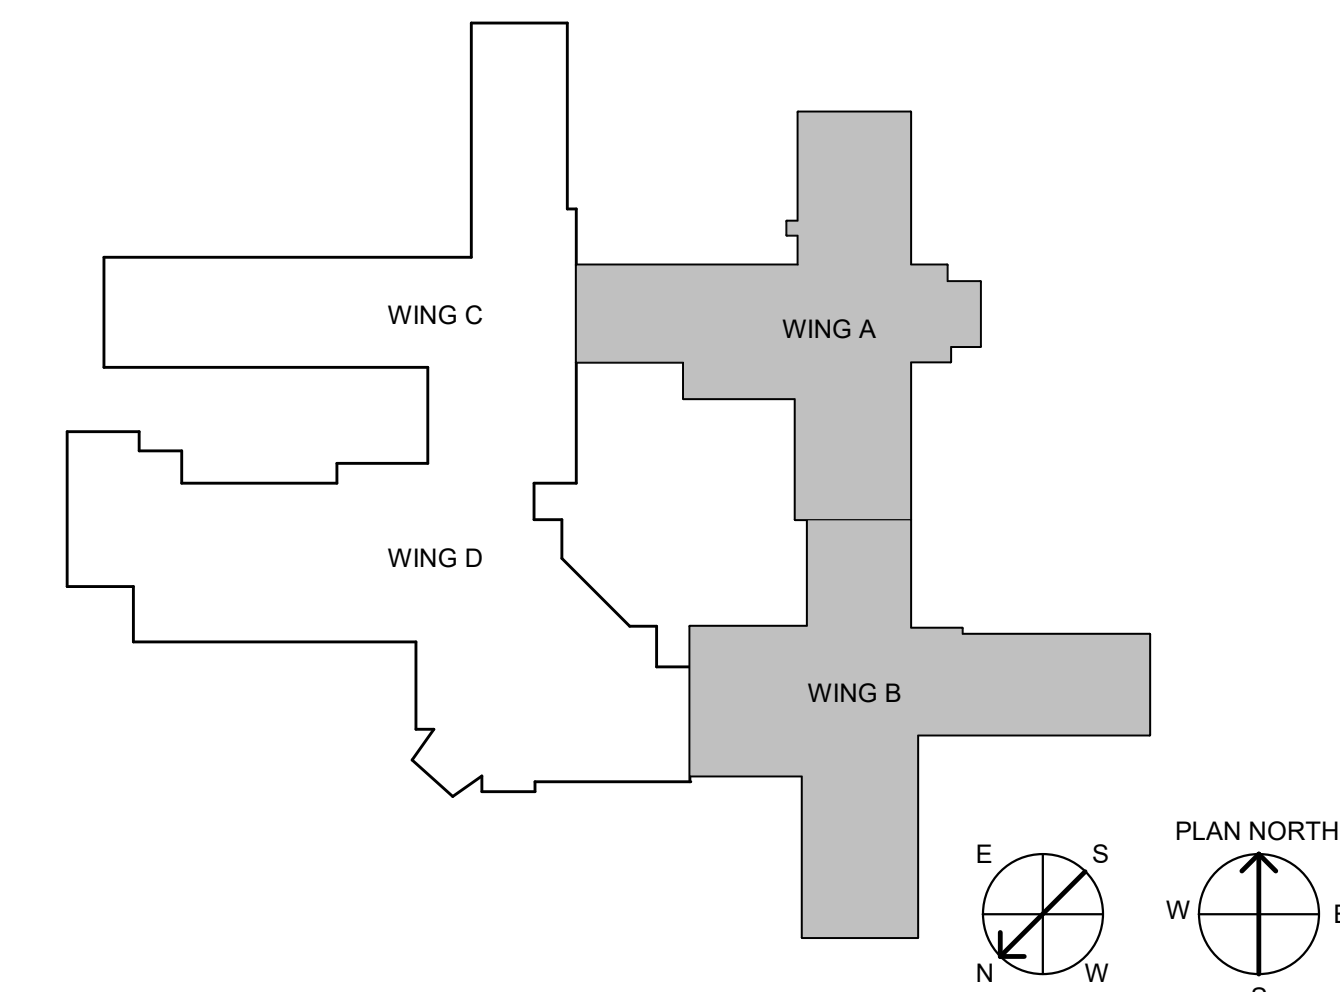

		CONSULTANT INFORMATION		ARCHITECT		Office of Construction and Facilities Management		SHEET TITLE LIFE SAFETY CODE NARRATIVE		PROJECT PHASE BID DOCUMENTS		PROJECT TITLE RENOVATE A & B WING BLDG 6		VA PROJECT NUMBER 589A5-19-116			
		STRUCTURAL / CIVIL ENGINEER STAND STRUCTURAL ENGINEERING 11827 W. 112TH STREET, SUITE 200 OVERLAND PARK, KS 66210 (913) 214-2169		MECHANICAL / ELECTRICAL / PLUMBING / TECHNICAL ENGINEER SPUR DESIGN 11020 KING STREET, SUITE 350 OVERLAND PARK, KS 66210 (405) 842-6100		FIRE PROTECTION ENGINEER POOLE FIRE PROTECTION, INC. 19910 W. 161ST STREET OLATH, KS 66062 (913) 829-8650		332 5th Street Overland Park, KS 66101 spur-design.com		11020 King Street, Suite 350 Overland Park, KS 66101 spur-design.com		APPROVED: PROJECT DIRECTOR		PROJECT LOCATION 2200 SW GAGE BLVD. TOPEKA, KS 66622		BUILDING NUMBER 6	
Revision #		Date		KS ARCH REG. NO. A-1139, EXP. 12/31/2019 KS ENGR REG. NO. E-2586, EXP. 12/31/2019		VA U.S. Department of Veteran Affairs		FULLY SPRINKLERED		DATE 07/10/2019		CHECKED BY KAB		DRAWN BY SAB		DRAWING NUMBER 6-F-001	
																Dwg. 46 OF 160	

MEANS OF EGRESS:

OCCUPANT LOAD:

CALCULATED OCCUPANT LOAD PER OCCUPANCY CLASSIFICATION AND USE (NFPA 101, TABLE 7.3.1.2) - PROVIDED

USE	OCCUPANT LOAD FACTOR	GROSS OR NET AREA
ASSEMBLY - LESS CONCENTRATED	15 SQ FT PER PERSON	NET
RESIDENTIAL BOARD AND CARE	200 SQ FT PER PERSON	GROSS
BUSINESS - UNCONCENTRATED	150 SQ FT PER PERSON	GROSS

NA: NOT APPLICABLE. THE OCCUPANT LOAD IS THE MAXIMUM PROBABLE NUMBER OF OCCUPANTS PRESENT AT ANY TIME.

TOTAL BUILDING OCCUPANT LOAD:
FIRST FLOOR OCCUPANT LOAD:

NUMBER OF EXITS:

TWO BUILDING EXIT REQUIRED (NFPA 101, SECTION 18.2.4.2, 32.2.4.1, AND 7.4.1.2(1)) - SIX (6) PROVIDED FROM WINGS A AND B

ARRANGEMENT OF EXITS:

WHERE TWO EXITS OR EXIT ACCESS DOORWAYS ARE REQUIRED, EXITS OR EXIT ACCESS DOORWAYS SEPARATED BY NOT LESS THAN ONE-THIRD THE LENGTH OF THE MAXIMUM OVERALL DIAGONAL DIMENSION OF THE AREA SERVED REQUIRED (NFPA 101, SECTION 7.5.1.3.3) - PROVIDED

MEANS OF EGRESS SIZING:

CALCULATED MEANS OF EGRESS COMPONENTS SIZING REQUIREMENTS PER COMPONENT REQUIRED (NFPA 101, TABLES 7.3.3.1, 7.2.5.3(A), AND 7.2.2.2.1(B) AND SECTIONS 7.2.1.2.3.2, 7.2.2.2.1.2(F), 7.2.6.4.2, AND 7.3.4) - PROVIDED

COMPONENT	SIZING FACTOR - LOW/ORDINARY HAZARD	MINIMUM SIZE
STAIRWAYS	0.3 INCHES PER PERSON	44 INCHES
RAMPS	0.2 INCHES PER PERSON	44 INCHES
CORRIDORS	0.2 INCHES PER PERSON	36 INCHES
CORRIDORS (50 OCCUPANTS OR MORE)		44 INCHES
PASSAGEWAYS	0.2 INCHES PER PERSON	36 INCHES
DOORS	0.2 INCHES PER PERSON	32 INCHES

STAIRWAY DIMENSIONAL REQUIREMENTS:

WIDTH: SEE TABLE ABOVE

HEADROOM: 6.8 INCHES REQUIRED (NFPA 101, TABLE 7.2.2.2.1.1(A)) - PROVIDED

STAIR TREADS AND RISERS: 4 INCHES TO 7 INCHES RISE REQUIRED (NFPA 101, TABLE 7.2.2.2.1.1(A)) - PROVIDED
11 INCHES MINIMUM RUN REQUIRED (NFPA 101, TABLE 7.2.2.2.1.1(A)) - PROVIDED
UNIFORM SIZE AND SHAPE REQUIRED (NFPA 101, SECTION 7.2.2.3.6) - PROVIDED

RADIUS OF CURVATURE: CURVED STAIRS AS A COMPONENT IN A MEANS OF EGRESS, PROVIDED THAT THE DEPTH OF TREAD IS NOT LESS THAN 11 INCHES AT A POINT 12 INCHES FROM THE NARROWER END OF THE TREAD AND THE SMALLEST RADIUS IS NOT LESS THAN TWICE THE STAIR WIDTH PERMITTED (NFPA 101, SECTION 7.2.2.2.1) - PROVIDED

NOSING PROJECTION SIZE: LESS THAN OR EQUAL TO 1.5 INCHES REQUIRED (NFPA 101, SECTION 7.2.2.3.3.4) - PROVIDED

NOSING PROJECTION UNIFORMITY: THE VARIATION IN THE HORIZONTAL PROJECTION OF ALL NOSINGS, INCLUDING THE PROJECTION OF THE LANDING NOSING, SHALL NOT EXCEED 3/8 INCH WITHIN EACH STAIR FLIGHT AND SHALL NOT EXCEED 3/16 INCH BETWEEN ADJACENT NOSINGS REQUIRED (NFPA 101, SECTION 7.2.2.3.6.6) - PROVIDED

SOLID RISERS: STAIR TREADS AND LANDINGS SHALL BE SOLID, WITHOUT PERFORATIONS, REQUIRED (NFPA 101, SECTION 7.2.2.3.3.1) - PROVIDED

STAIRWAY LANDINGS: LANDINGS SHALL HAVE A DIMENSION, MEASURED IN THE DIRECTION OF TRAVEL THAT IS NOT LESS THAN THE WIDTH OF THE STAIR REQUIRED (NFPA 101, SECTION 7.2.2.3.2.3) - PROVIDED

VERTICAL RISE: LESS THAN OR EQUAL TO 12 FEET PER LANDING REQUIRED (NFPA 101, TABLE 7.2.2.2.1.1(A)) - PROVIDED

HANDRAILS: ON EACH SIDE REQUIRED (NFPA 101, SECTION 7.2.2.4.1.1) - PROVIDED

RAMP REQUIREMENTS: NOT APPLICABLE

HANDRAIL REQUIREMENTS:

HEIGHT: 34 INCHES - 38 INCHES REQUIRED (NFPA 101, SECTION 7.2.2.4.5.1) - PROVIDED

GRASPABILITY: OUTSIDE DIAMETER OF 1.25 INCHES - 2 INCHES OR PERIMETER OF 4 INCHES - 6.25 INCHES WITH A MAXIMUM CROSS-SECTIONAL DIMENSION OF 2.25 INCHES, EDGE RADIUS GREATER THAN OR EQUAL TO 1/8 INCH REQUIRED (NFPA 101, SECTION 7.2.2.4.5.6) - PROVIDED

CONTINUITY: CONTINUOUS REQUIRED (NFPA 101, SECTION 7.2.2.4.2) - PROVIDED

EXTENSIONS: HANDRAILS THAT ARE NOT CONTINUOUS BETWEEN FLIGHTS SHALL EXTEND HORIZONTALLY, AT THE REQUIRED HEIGHT, NOT LESS THAN 12 INCHES BEYOND THE TOP RISER AND CONTINUE TO SLOPE FOR A DEPTH OF ONE TREAD BEYOND THE BOTTOM RISER REQUIRED (NFPA 101, SECTION 7.2.2.4.5.10) - PROVIDED

CLEARANCE: HANDRAILS INSTALLED TO PROVIDE A CLEARANCE OF NOT LESS THAN 2.25 INCHES BETWEEN THE HANDRAIL AND THE WALL TO WHICH IT IS FASTENED REQUIRED (NFPA 101, SECTION 7.2.2.4.5.5) - PROVIDED

INTERMEDIATE HANDRAILS: 20 INCHES MINIMUM CLEAR WIDTH BETWEEN HANDRAILS AND INTERMEDIATE HANDRAILS REQUIRED (NFPA 101, SECTION 7.2.2.4.1.3) - PROVIDED

MEANS OF EGRESS (CONT'D):

GUARD REQUIREMENTS:

LOCATION:

GUARDS PROVIDED AT THE OPEN SIDES OF MEANS OF EGRESS THAT EXCEED 30 INCHES ABOVE THE FLOOR OR THE FINISHED GROUND LEVEL BELOW REQUIRED (NFPA 101, SECTION 7.1.8) - PROVIDED

HEIGHT:

GREATER THAN OR EQUAL TOO 42 INCHES REQUIRED (NFPA 101, SECTION 7.2.2.4.6.2) - PROVIDED

OPENING LIMITATIONS:

LESS THAN OR EQUAL TO 4 INCHES SPHERE REQUIRED (NFPA 101, SECTION 7.2.2.4.6.3) - PROVIDED

MAXIMUM TRAVEL DISTANCE:

ALLOWABLE TRAVEL DISTANCE

HEALTH CARE 200 FT (NFPA 101, SECTION 38.2.6.3)
BOARD & CARE 250 FT (NFPA 101, SECTION 32.2.6)

ACTUAL

HEALTH CARE REFER TO LIFE SAFETY PLANS
BOARD & CARE REFER TO LIFE SAFETY PLANS

COMMON PATH OF TRAVEL:

ALLOWABLE COMMON PATH OF TRAVEL

HEALTH CARE 100 FT (NFPA 101, SECTION 38.2.5.3.1)
BOARD & CARE 75 FT (NFPA 101, TABLE 32.3.2.5.2)

ACTUAL

HEALTH CARE REFER TO LIFE SAFETY PLANS
BOARD & CARE REFER TO LIFE SAFETY PLANS


DEAD-END CORRIDORS:

ALLOWABLE DEAD-END CORRIDORS

HEALTH CARE 30 FT (NFPA 101, SECTION 38.2.5.2)
BOARD & CARE 30 FT (NFPA 101, TABLE 32.3.2.5.4)

ACTUAL

HEALTH CARE REFER TO LIFE SAFETY PLANS
BOARD & CARE REFER TO LIFE SAFETY PLANS

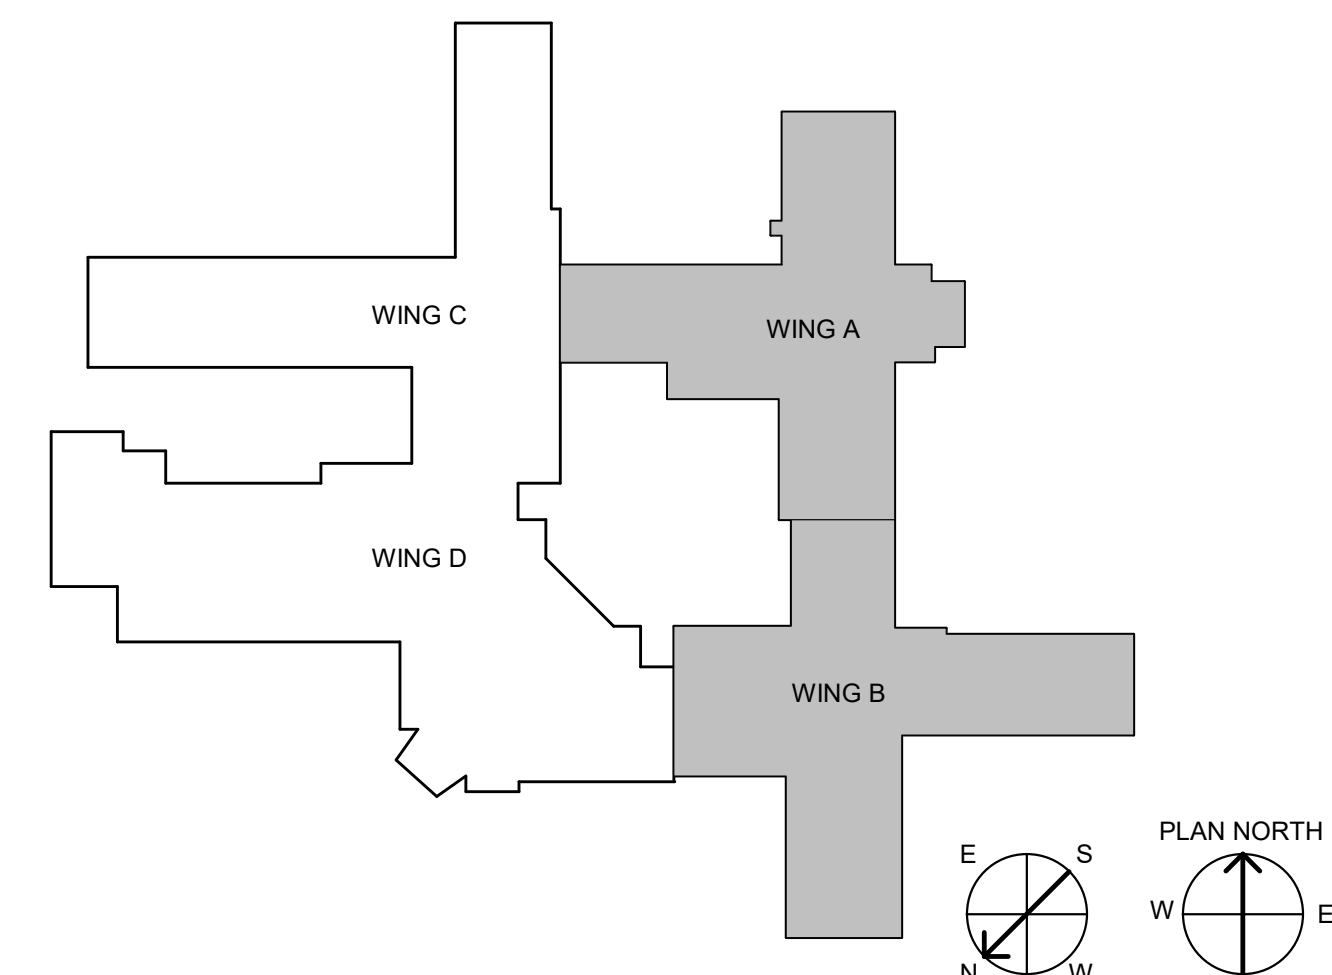

Poole Fire Protection
19910 West 161st Street
Olathe, KS 66062
www.poolefire.com
913.829.8650 office • 913.829.8690 fax

<p>CONSULTANT INFORMATION</p> <p>STRUCTURAL / CIVIL ENGINEER: STAND STRUCTURAL ENGINEERING, 11827 W. 112TH STREET, SUITE 200, OVERLAND PARK, KS 66210 (913) 214-2169</p> <p>MECHANICAL / ELECTRICAL / PLUMBING / TECHNICAL ENGINEER: SPUR DESIGN, 11020 KING STREET, SUITE 350, OVERLAND PARK, KS 66210 (405) 842-6100</p> <p>FIRE PROTECTION ENGINEER: POOLE FIRE PROTECTION, INC., 19910 W. 161ST STREET, OLATH, KS 66062 (913) 829-8650</p>		<p>ARCHITECT</p> <p>SPUR DESIGN</p> <p>312 SW 20th Street, Overland Park, KS 66150 10000 Eng Street, Suite 300, Overland Park, KS 66150</p> <p>KS ARCH REG. NO. A-1139, EXP. 12/31/2019 KS ENGR REG. NO. E-2586, EXP. 12/31/2019</p>		<p>Office of Construction and Facilities Management</p> <p>VA U.S. Department of Veteran Affairs</p>		<p>SHEET TITLE: LIFE SAFETY CODE NARRATIVE</p> <p>APPROVED: PROJECT DIRECTOR</p>		<p>PROJECT PHASE: BID DOCUMENTS</p> <p>FULLY SPRINKLERED</p>		<p>PROJECT TITLE: RENOVATE A & B WING BLDG 6</p> <p>PROJECT LOCATION: 2200 SW GAGE BLVD. TOPEKA, KS 66622</p> <p>DATE: 07/10/2019</p> <p>CHECKED BY: KAB</p> <p>DRAWN BY: SAB</p>		<p>VA PROJECT NUMBER: 589A5-19-116</p> <p>BUILDING NUMBER: 6</p> <p>DRAWING NUMBER: 6-F-002</p> <p>Dwg. 47 OF 160</p>	
---	--	--	--	---	--	--	--	--	--	---	--	---	--

EGRESS PATH SCHEDULE

TAG ABBREVIATIONS:
 CPT: COMMON PATH OF TRAVEL
 MTD: MAXIMUM TRAVEL DISTANCE
 DEC: DEAD-END CORRIDOR

TAG	ACTUAL LENGTH	OCCUPANCY	MAXIMUM ALLOWABLE LENGTH
CPT1.1	43' - 6"	HC	100' - 0"
CPT1.2	33' - 8"	R	75' - 0"
CPT1.3	73' - 4"	R	75' - 0"
CPT1.4	32' - 4"	R	75' - 0"
MTD1.1	107' - 0"	HC	300' - 0"
MTD1.2	80' - 3"	HC	300' - 0"
MTD1.3	173' - 8"	R	250' - 0"
MTD1.4	108' - 3"	R	250' - 0"



LIFE SAFETY LEGEND

SYMBOL	DESCRIPTION
	PATH OF EGRESS
	PATH OF EGRESS IDENTIFIER
	1/2-HOUR RATED FIRE PARTITION
	1-HOUR RATED FIRE BARRIER
	2-HOUR RATED FIRE BARRIER
	1-HOUR RATED FIRE/SMOKE BARRIER
	2-HOUR RATED FIRE/SMOKE BARRIER

OCCUPANCY CLASSIFICATION LEGEND

	HEALTH CARE
	RESIDENTIAL - BOARD AND CARE


ROOM INDEX		ROOM INDEX	
Room Number	Room Name	Room Number	Room Name
A134	TESTING	B107	CLEAN LINEN
A135	EXAM	B105	STORAGE
A136	EXAM	B104	CLEAN SUPPLY
A137	NURSE MED	BCDR1	CORRIDOR B
A138	EXAM, BARIATRIC	B137	RESIDENT
A139	ED SUPPLY ROOM	B137A	TOILET
A102	FAMILY TLT	B136A	TOILET
A101	RECEPTION	B136	RESIDENT
ACDR1	CORRIDOR A	B135	RESIDENT
ACDR2	CORRIDOR	BCDR2	CORRIDOR B
A133	TOILET, BARIATRIC, SHOWER	B133	REC THERAPY
A132	BREAK ROOM	B132	REC THERAPY OFFICE
A131	LEARNER OFFICE	B131	RESIDENT
A135	STAIR	B131A	TOILET
A130	CONFERENCE	B130A	TOILET
A129	GEC PHYSICIAN	BCDR3	CORRIDOR B
A103	BARIATRIC TLT	B130	RESIDENT
A104	STORAGE	B129	SHARED OFFICE / REPORT
A105	STAFF TOILET	B109	KITCHEN
A106	STAFF TOILET	B128	HAC
A107	MDS / RESTOR OFFICE	B127	LAUNDRY
A108	TESTING / INTERN	B126	RESIDENT
A109	GEROPSYCH	B126A	TOILET
B114	CLINICAL NURSE LEADER	B125A	TOILET
B113	SOCIAL WORKER	B125	RESIDENT
ACDR3	CORRIDOR A	B124	RESIDENT
A110	PT / OT	B124A	TOILET
A114	IT	B123A	TOILET
A114.1	EXISTING IT	B123	RESIDENT
A115	REC THERAPY	BCDR4	CORRIDOR B
A127	HAC	B122	RESIDENT
A126	EXAM	B122A	TOILET
A125	REC THERAPY OFFICE	B121A	TOILET
A124	PHARM D	B121	RESIDENT
A123	SOCIAL WORK	B120	RESIDENT
A122	LACTATION / PUMP	B120A	TOILET
A121	DIETICIAN	B119A	TOILET [BARIATRIC]
A120	STORAGE	B119	RESIDENT [BARIATRIC]
A119	REPORT ROOM	B118	COMPUTER LOUNGE
A118	HOSPICE APRN	B117	EXAM ROOM
A117	ACNS	B116	STAFF TOILET
A116	ASST NURSE MNGR	B102	NURSE STATION
B112	NURSE MNGR	B100	MEDS
B115	STAFF BREAK	B101	ELEC
BCDR5	CORRIDOR B	A113	ENG SERV
B111	GERIATRIC PSYCHIATRIST	A111	ELEC
B110	APRN	A128	PT/OT STOR
B108	DINING & DAY ROOM	B134	SNOEZELEN
B106	SOILED HOLDING	B135A	TOILET
		A112	STOR
		A100	VESTIBULE

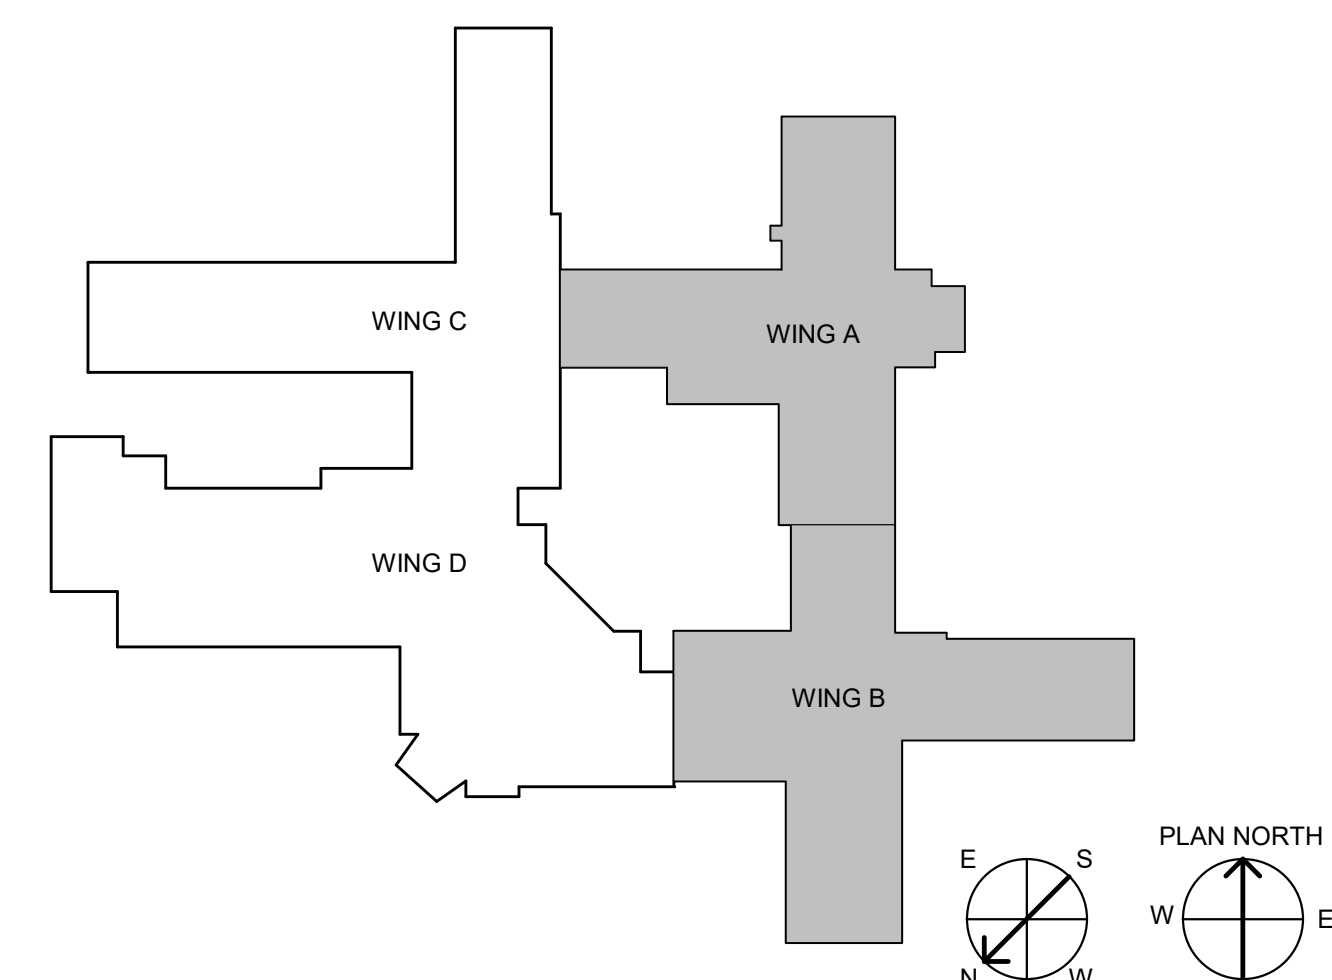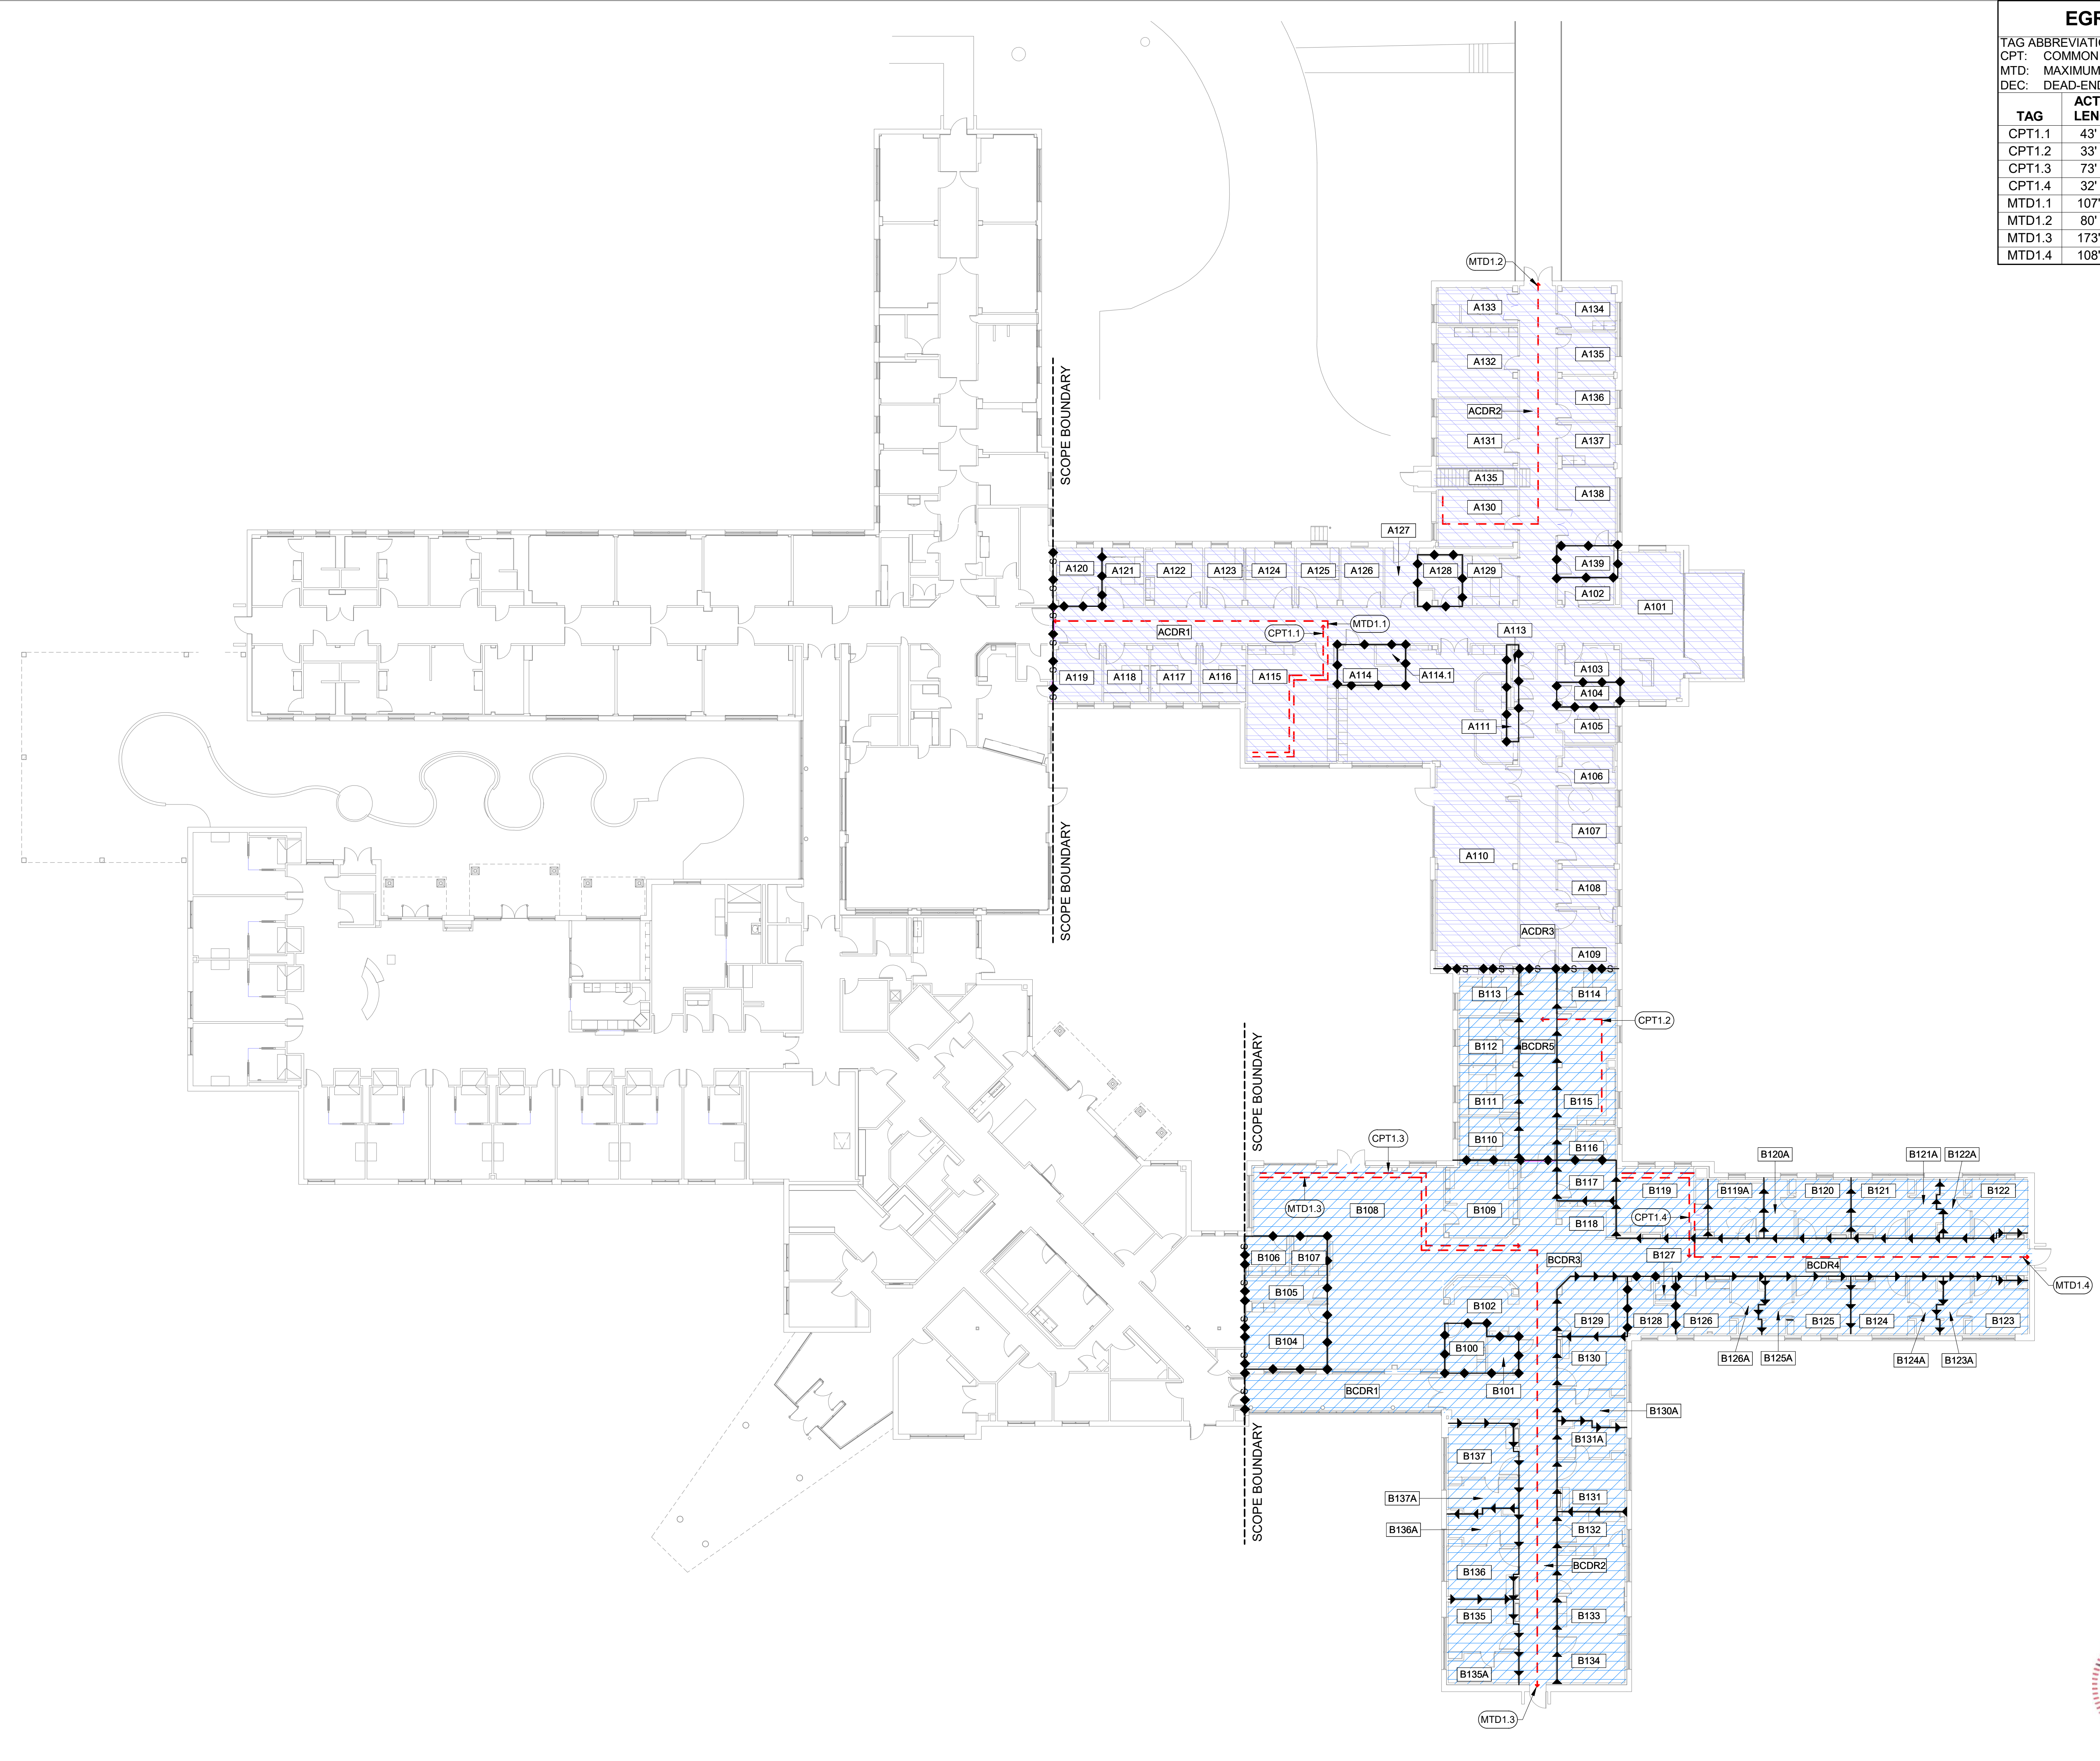

Poole Fire Protection
 19910 West 161st Street
 Olathe, KS 66062
 www.poolefire.com
 913.829.8650 office • 913.829.8690 fax

1 LIFE SAFETY OCCUPANCY CLASSIFICATION FLOOR PLAN
 SCALE = 1/16" = 1'-0"

CONSULTANT INFORMATION STRUCTURAL / CIVIL ENGINEER: STAND STRUCTURAL ENGINEERING, 11827 W. 112TH STREET, SUITE 200, OVERLAND PARK, KS 66210 (913) 214-2169 MECHANICAL / ELECTRICAL / PLUMBING / TECHNICAL ENGINEER: SPUR DESIGN, 11020 KING STREET, SUITE 350, OVERLAND PARK, KS 66210 (405) 842-6100 FIRE PROTECTION ENGINEER: POOLE FIRE PROTECTION, INC., 19910 W. 161ST STREET, OLATH, KS 66062 (913) 829-8650		ARCHITECT 333 SW 20th Street, Overland Park, KS 66209 (913) 214-2169 11020 King Street, Suite 350, Overland Park, KS 66210 (913) 842-6100		Office of Construction and Facilities Management VA U.S. Department of Veteran Affairs		SHEET TITLE: LIFE SAFETY OCCUPANCY CLASSIFICATION FLOOR PLAN APPROVED: PROJECT DIRECTOR		PROJECT PHASE: BID DOCUMENTS FULLY SPRINKLERED		PROJECT TITLE: RENOVATE A & B WING BLDG 6 PROJECT LOCATION: 2200 SW GAGE BLVD., TOPEKA, KS 66622		VA PROJECT NUMBER: 589A5-19-116 BUILDING NUMBER: 6 DRAWING NUMBER: 6-F-101 Dwg. 48 OF 160	
Revision #	Date							DATE: 07/10/2019		CHECKED BY: KAB		DRAWN BY: SAB	

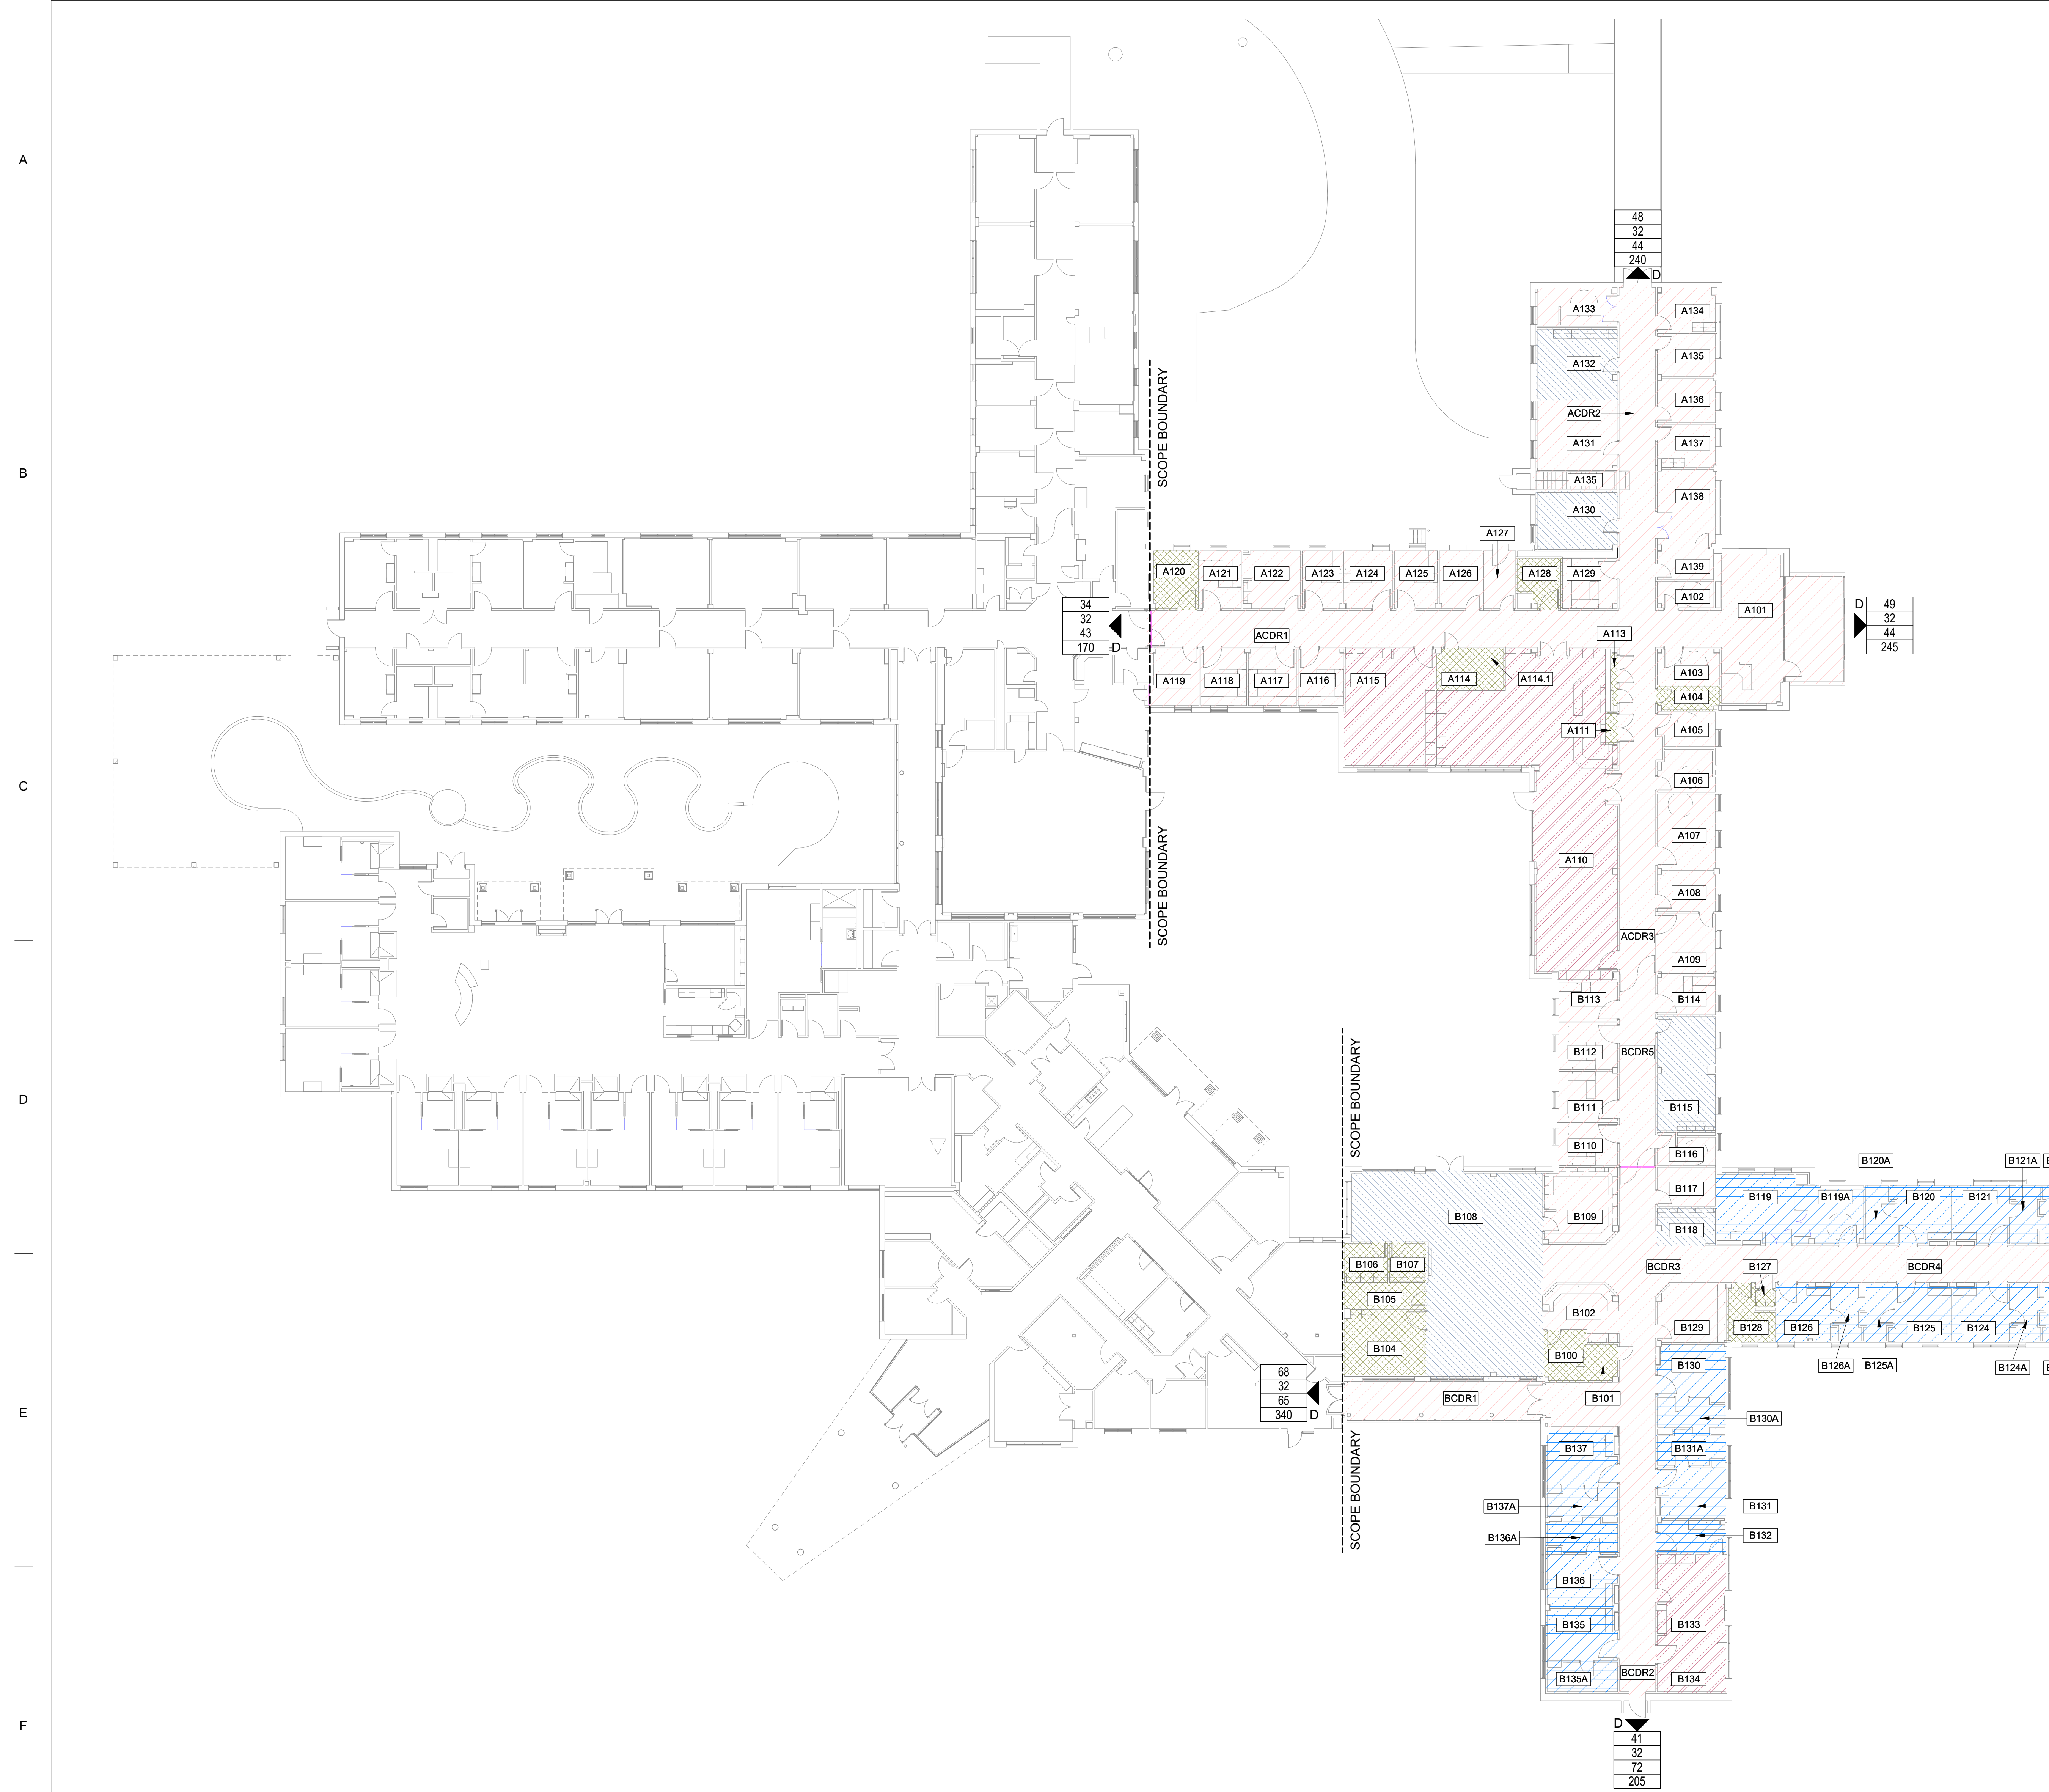

OCCUPANT LOAD SCHEDULE - WING B

NUMBER	NAME	AREA	LOAD FACTOR	OCCUPANT LOAD
B100	MEDS	96 ft²	500 ft²	1
B101	ELEC	52 ft²	500 ft²	1
B102	NURSE STATION	184 ft²	150 ft²	2
B104	CLEAN SUPPLY	248 ft²	500 ft²	1
B105	STORAGE	93 ft²	500 ft²	1
B106	SOILED HOLDING	81 ft²	500 ft²	1
B107	CLEAN LINEN	66 ft²	500 ft²	1
B108	DINING & DAY ROOM	1392 ft²	15 ft ft²	93
B109	KITCHEN	254 ft²	150 ft²	2
B110	APRN	121 ft²	150 ft²	1
B111	GERIATRIC PSYCHIATRIST	139 ft²	150 ft²	1
B112	NURSE MNGR	131 ft²	150 ft²	1
B113	SOCIAL WORKER	109 ft²	150 ft²	1
B114	CLINICAL NURSE LEADER	108 ft²	150 ft²	1
B115	STAFF BREAK	312 ft²	15 ft ft²	21
B116	STAFF TOILET	82 ft²	150 ft²	1
B117	EXAM ROOM	109 ft²	150 ft²	1
B118	COMPUTER LOUNGE	103 ft²	15 ft ft²	7
B119	RESIDENT [BARIATRIC]	247 ft²	200 ft²	2
B119A	TOILET [BARIATRIC]	178 ft²	200 ft²	1
B120	RESIDENT	151 ft²	200 ft²	1
B120A	TOILET	78 ft²	200 ft²	1
B121	RESIDENT	157 ft²	200 ft²	1
B121A	TOILET	75 ft²	200 ft²	1
B122	RESIDENT	156 ft²	200 ft²	1
B122A	TOILET	75 ft²	200 ft²	1
B123	RESIDENT	153 ft²	200 ft²	1
B123A	TOILET	73 ft²	200 ft²	1
B124	RESIDENT	154 ft²	200 ft²	1
B124A	TOILET	73 ft²	200 ft²	1
B125	RESIDENT	154 ft²	200 ft²	1
B125A	TOILET	73 ft²	200 ft²	1
B126	RESIDENT	145 ft²	200 ft²	1
B126A	TOILET	73 ft²	200 ft²	1
B127	LAUNDRY	15 ft²	500 ft²	1
B128	HAC	98 ft²	500 ft²	1
B129	SHARED OFFICE / REPORT	189 ft²	150 ft²	2
B130	RESIDENT	166 ft²	200 ft²	1
B130A	TOILET	96 ft²	200 ft²	1
B131	RESIDENT	167 ft²	200 ft²	1
B131A	TOILET	96 ft²	200 ft²	1
B132	REC THERAPY OFFICE	102 ft²	200 ft²	1
B133	REC THERAPY	295 ft²	50 ft ft²	6
B134	SNOEZELEN	144 ft²	50 ft ft²	3
B135	RESIDENT	173 ft²	200 ft²	1
B135A	TOILET	95 ft²	200 ft²	1
B136	RESIDENT	175 ft²	200 ft²	1
B136A	TOILET	99 ft²	200 ft²	1
B137	RESIDENT	167 ft²	200 ft²	1
B137A	TOILET	97 ft²	200 ft²	1
BCDR1	CORRIDOR B	344 ft²	150 ft²	3
BCDR2	CORRIDOR B	613 ft²	150 ft²	5
BCDR3	CORRIDOR B	568 ft²	150 ft²	4
BCDR4	CORRIDOR B	738 ft²	150 ft²	5
BCDR5	CORRIDOR B	335 ft²	150 ft²	3
TOTAL OCCUPANT LOAD				199

OCCUPANT LOAD SCHEDULE - WING A


NUMBER	NAME	AREA	LOAD FACTOR	OCCUPANT LOAD
A100	VESTIBULE	294 ft²	150 ft²	2
A101	RECEPTION	435 ft²	150 ft²	3
A102	FAMILY TLT	71 ft²	150 ft²	1
A103	BARIATRIC TLT	106 ft²	150 ft²	1
A104	STORAGE	67 ft²	500 ft²	1
A105	STAFF TOILET	93 ft²	150 ft²	1
A106	STAFF TOILET	106 ft²	150 ft²	1
A107	MDS / RESTOR OFFICE	212 ft²	150 ft²	2
A108	TESTING / INTERN	109 ft²	150 ft²	1
A109	GEROPSYCH	164 ft²	150 ft²	2
A110	PT / OT	1620 ft²	50 ft ft²	33
A111	ELEC	14 ft²	500 ft²	1
A112	STOR	3 ft²	500 ft²	1
A113	ENG SERV	8 ft²	500 ft²	1
A114	IT	96 ft²	500 ft²	1
A114.1	EXISTING IT	27 ft²	500 ft²	1
A115	REC THERAPY	502 ft²	50 ft ft²	11
A116	ASST NURSE MNGR	124 ft²	150 ft²	1
A117	ACNS	131 ft²	150 ft²	1
A118	HOSPICE APRN	124 ft²	150 ft²	1
A119	REPORT ROOM	131 ft²	150 ft²	1
A120	STORAGE	124 ft²	500 ft²	1
A121	DIETICIAN	115 ft²	150 ft²	1
A122	LACTATION / PUMP	157 ft²	150 ft²	2
A123	SOCIAL WORK	110 ft²	150 ft²	1
A124	PHARM D	136 ft²	150 ft²	1
A125	REC THERAPY OFFICE	119 ft²	150 ft²	1
A126	EXAM	118 ft²	150 ft²	1
A127	HAC	91 ft²	150 ft²	1
A128	PT/OT STOR	89 ft²	500 ft²	1
A129	GEC PHYSICIAN	131 ft²	150 ft²	1
A130	CONFERENCE	218 ft²	15 ft ft²	15
A131	LEARNER OFFICE	259 ft²	150 ft²	2
A132	BREAK ROOM	268 ft²	15 ft ft²	18
A133	TOILET, BARIATRIC, SHOWER	137 ft²	150 ft²	1
A134	TESTING	117 ft²	150 ft²	1
A135	EXAM	119 ft²	150 ft²	1
A135	STAIR	76 ft²	150 ft²	1
A136	EXAM	121 ft²	150 ft²	1
A137	NURSE MED	118 ft²	150 ft²	1
A138	EXAM, BARIATRIC	215 ft²	150 ft²	2
A139	ED SUPPLY ROOM	83 ft²	150 ft²	1
ACDR1	CORRIDOR A	1023 ft²	150 ft²	7
ACDR2	CORRIDOR A	568 ft²	150 ft²	4
ACDR3	CORRIDOR A	600 ft²	150 ft²	4
TOTAL OCCUPANT LOAD				138

LIFE SAFETY LEGEND

SYMBOL	DESCRIPTION
34	ACTUAL CLEAR WIDTH
32	REQUIRED CLEAR WIDTH
11	ACTUAL EGRESS
170	MAXIMUM EGRESS CAPACITY
D	EGRESS COMPONENT
(D)DOOR	(S)STAIRWAY

OCCUPANCY USE LEGEND

HATCH	USE	DESCRIPTION
A	ASSEMBLY - LESS CONCENTRATED	15ft²/PERSON, NET
B	BUSINESS	150ft²/PERSON, GROSS
EE	EXERCISE ROOMS WITH EQUIPMENT	50ft²/PERSON, GROSS
R	RESIDENTIAL - BOARD AND CARE	200ft²/PERSON, GROSS
S	STORAGE	500ft²/PERSON, GROSS

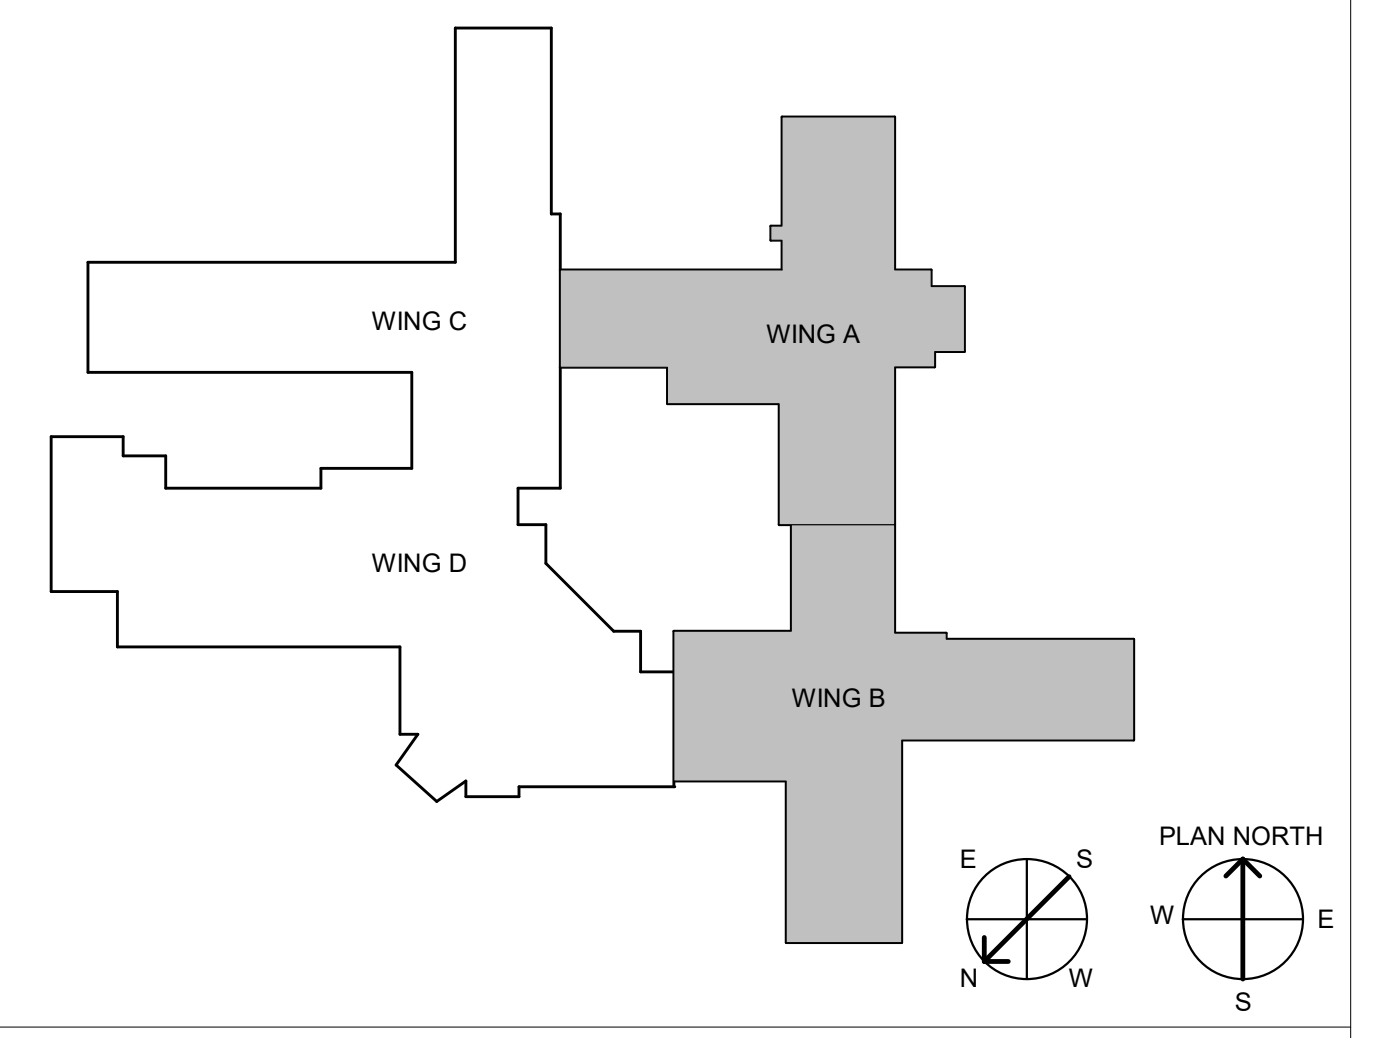

1 LIFE SAFETY FLOOR PLAN
SCALE = 1/16" = 1'-0"

CONSULTANT INFORMATION STRUCTURAL / CIVIL ENGINEER: STAND STRUCTURAL ENGINEERING, 11827 W. 112TH STREET, SUITE 200, OVERLAND PARK, KS 66210 (913) 214-2169 MECHANICAL / ELECTRICAL / PLUMBING / TECHNICAL ENGINEER: SPUR DESIGN, 11020 KING STREET, SUITE 350, OVERLAND PARK, KS 66210 (405) 842-6100 FIRE PROTECTION ENGINEER: POOLE FIRE PROTECTION, INC., 19910 W. 161ST STREET, OLATH, KS 66062 (913) 829-8650		ARCHITECT 333 SW 20th Street, Overland Park, KS 66209 11020 King Street, Suite 350, Overland Park, KS 66210 KS ARCH REG. NO. A-1139, EXP. 12/31/2019 KS ENGR REG. NO. E-2586, EXP. 12/31/2019		Office of Construction and Facilities Management VA U.S. Department of Veteran Affairs		SHEET TITLE: LIFE SAFETY FLOOR PLAN APPROVED: PROJECT DIRECTOR		PROJECT PHASE: BID DOCUMENTS FULLY SPRINKLERED		PROJECT TITLE: RENOVATE A & B WING BLDG 6 PROJECT LOCATION: 2200 SW GAGE BLVD., TOPEKA, KS 66622		VA PROJECT NUMBER: 589A5-19-116 BUILDING NUMBER: 6 DRAWING NUMBER: 6-F-102 Dwg. 49 OF 160	
Revision #	Date												