

FIRE ALARM GENERAL NOTES

- GENERAL:
- THE CONTRACTOR SHALL CAREFULLY REVIEW ALL APPLICABLE DESIGN CRITERIA, THESE DRAWINGS, AND THE PROJECT SPECIFICATIONS FOR IMPORTANT QUALIFICATION, DEFINITION, SUBMITTAL, PRODUCT, INSTALLATION, AND TESTING REQUIREMENTS.
 - ALL SUBMITTALS, INSTALLATION, AND TESTING SHALL BE COMPLETED IN A NEAT, WORKMAN-LIKE MANNER.
 - PRODUCT, DESIGN, INSTALLATION, AND TESTING ALTERNATE APPROACHES AND/OR SUBSTITUTIONS WILL BE CONSIDERED BY THE ENGINEER IF THE CONTRACTOR PROVIDES WRITTEN, WELL-DOCUMENTED, ENGINEERING-BASED SUBSTANTIATION FOR PROPOSED ALTERNATIVE.

- APPLICABLE CODES AND STANDARDS:
- INTERNATIONAL BUILDING CODE (2018)
 - NFPA 70 NATIONAL ELECTRIC CODE (2017)
 - NFPA 72 NATIONAL FIRE ALARM AND SIGNALING CODE (2019)

- AUDIBILITY DESIGN:
- BECAUSE OF UNPREDICTABLE BACKGROUND NOISES AND PROJECT CONDITIONS, THE AUDIBILITY DESIGN GOALS SHALL BE CONFIRMED BY MEASUREMENT WITH CALIBRATED TEST EQUIPMENT. IF RESULTS INDICATE THAT ADDITIONAL NOTIFICATION APPLIANCES, THE CONTRACTOR SHALL ADD THEM AT NO ADDITIONAL COST.
 - THE EXPECTED AMBIENT SOUND PRESSURE LEVELS ARE AS FOLLOWS:
 - OFFICES, RESTROOMS, RESIDENT ROOMS, CIRCULATION AREAS: 55 dBA
 - MECHANICAL EQUIPMENT AREAS: 85 dBA
 - THE DESIGN GOAL IS FOR THE ALERT TONE PRECEDING THE VOICE MESSAGE TO REACH THE FOLLOWING SOUND PRESSURE LEVELS (PUBLIC MODE):
 - OFFICES, RESTROOMS, RESIDENT ROOMS, CIRCULATION AREAS: 70 dBA
 - MECHANICAL EQUIPMENT AREAS: 100 dBA
 - SPEAKERS MAY BE FIELD-LOCATED WITHIN 6 FT OF THE LOCATION INDICATED ON THE APPROVED DESIGN WITHOUT CONSULTING THE ENGINEER.

- VISUAL NOTIFICATION DESIGN:
- CLEAR STROBES SHALL BE PROVIDED WHERE INDICATED ON THE APPROVED DESIGN.
 - STROBES MAY BE FIELD-LOCATED WITHIN 3 FT OF THE LOCATION INDICATED ON THE APPROVED DESIGN WITHOUT CONSULTING THE ENGINEER. CONSULT WITH ENGINEER PRIOR TO RELOCATING STROBES MORE THAN 3 FT.

- INITIATING DEVICES:
- INITIATING DEVICES MAY BE FIELD-LOCATED WITHIN 3 FT OF THE LOCATION INDICATED ON THE APPROVED DESIGN WITHOUT CONSULTING THE ENGINEER. CONSULT WITH ENGINEER PRIOR TO RELOCATING INITIATING DEVICES MORE THAN 3 FT.

- CIRCUITS AND CONDUIT:
- ALL CIRCUITS SHALL BE PROVIDED IN CONDUIT IN ACCORDANCE WITH NFPA 70 AND THE CONDUIT LISTING.
 - NEW SIGNALING LINE CIRCUITS AND NOTIFICATION APPLIANCE CIRCUITS SHALL BE ARRANGED SO THAT A SINGLE FAULT DOES NOT CAUSE THE LOSS OF ADDRESSABLE DEVICES ON MORE THAN ONE SMOKE COMPARTMENT.

- INSTALLATION:
- ALL EQUIPMENT SHALL BE INSTALLED TIGHT TO THE BUILDING STRUCTURE AND SHALL BE INSTALLED PARALLEL OR PERPENDICULAR TO THE BUILDING STRUCTURE UNLESS NOTED OTHERWISE.
 - THE CONTRACTOR SHALL NOT APPRECIABLY DEVIATE FROM THE APPROVED DESIGN WITHOUT WRITTEN APPROVAL FROM THE ENGINEER.

- TESTING:
- UNLESS SPECIFICALLY NOTED OTHERWISE, THE CONTRACTOR SHALL PERFORM ALL ACCEPTANCE TESTING IN ACCORDANCE WITH THE APPLICABLE DESIGN CRITERIA AND THE EQUIPMENT MANUFACTURER'S INSTRUCTIONS.
 - UNLESS SPECIFICALLY NOTED OTHERWISE, THE CONTRACTOR SHALL PERFORM TESTING AND PROVIDE DOCUMENTATION PRIOR TO REQUESTING ENGINEER'S PRESENCE TO WITNESS TESTING.


FIRE ALARM LEGEND	
	EXISTING SIMPLEX 4100ES FIRE ALARM CONTROL PANEL
	SURGE PROTECTIVE DEVICE
	FIRE ALARM PULL STATION
	ADDRESSABLE INPUT MODULE
	ADDRESSABLE OUTPUT MODULE
	WATERFLOW SWITCH
	VALVE SUPERVISORY SWITCH
	WALL MOUNTED STROBE
	DOOR HOLDERS
	SPEAKER
	SPEAKER STROBE
	SMOKE DETECTOR - SPOT TYPE
SYMBOL MODIFIERS	
C	CEILING MOUNTED
ncd	CANDELA RATING
rW	WATT TAP
LF	LOW FREQUENCY SPEAKER
LFSB	LOW FREQUENCY SOUNDER BASE
DH	DOOR HOLD RELEASE
WP	WEATHER PROOF

	OUTPUTS															
	NOTIFICATION											INTERFACE				
	A	B	C	D	E	F	G	H	I	J	K	L	M	N	O	P
ACTIVATE CLEAR STROBES THROUGHOUT BUILDING																
ACTIVATE PRE-RECORDED FIRE EVACUATION MESSAGE THROUGHOUT BUILDING																
ACTIVATE ALARM CONDITION AT FIRE ALARM CONTROL UNIT																
DISPLAY ALARM CONDITION AT FIRE ALARM ANNUNCIATOR PANEL																
TRANSMIT ALARM SIGNAL TO SUPERVISING STATION																
DISPLAY SUPERVISORY CONDITION AT FIRE ALARM ANNUNCIATOR PANEL																
TRANSMIT SUPERVISORY SIGNAL TO SUPERVISING STATION																
DISPLAY TROUBLE CONDITION AT FIRE ALARM ANNUNCIATOR PANEL																
TRANSMIT TROUBLE CONDITION AT FIRE ALARM ANNUNCIATOR PANEL																
RELEASE MAGNETICALLY HELD DOORS																
ACTIVATE INDIVIDUAL ROOM SMOKE DETECTOR SOUNDER BASE																
SHUTDOWN ASSOCIATED AIR HANDLING UNIT																
ACTIVATE SPEAKERS THROUGHOUT BUILDING																
ACTIVATE STROBES THROUGHOUT BUILDING																

	INPUTS															
	A	B	C	D	E	F	G	H	I	J	K	L	M	N	O	P
MANUAL PULL STATION																
SPRINKLER WATERFLOW SWITCH																
SMOKE DETECTOR - SPOT TYPE (OTHER THAN SPECIFIC DETECTORS BELOW)																
RESIDENT ROOM SMOKE DETECTORS (ANY TYPE)																
SMOKE DETECTOR - DUCT TYPE																
VALVE SUPERVISORY SWITCH																
FACU AC POWER FAILURE																
FACU LOW BATTERY																
OPEN CIRCUIT																
GROUND FAULT																
NOTIFICATION APPLIANCE CIRCUIT SHORT																
ALL OTHER TROUBLES																


NOTE: THIS MATRIX IS ONLY INTENDED TO SHOW THE MAJOR SYSTEM FUNCTIONS. SYSTEM SHALL ALSO PERFORM INPUTS/OUTPUTS REQUIRED BY NFPA 72 AND THE PRODUCTS' LISTING.

1 FIRE ALARM INPUT/OUTPUT MATRIX
SCALE: NONE

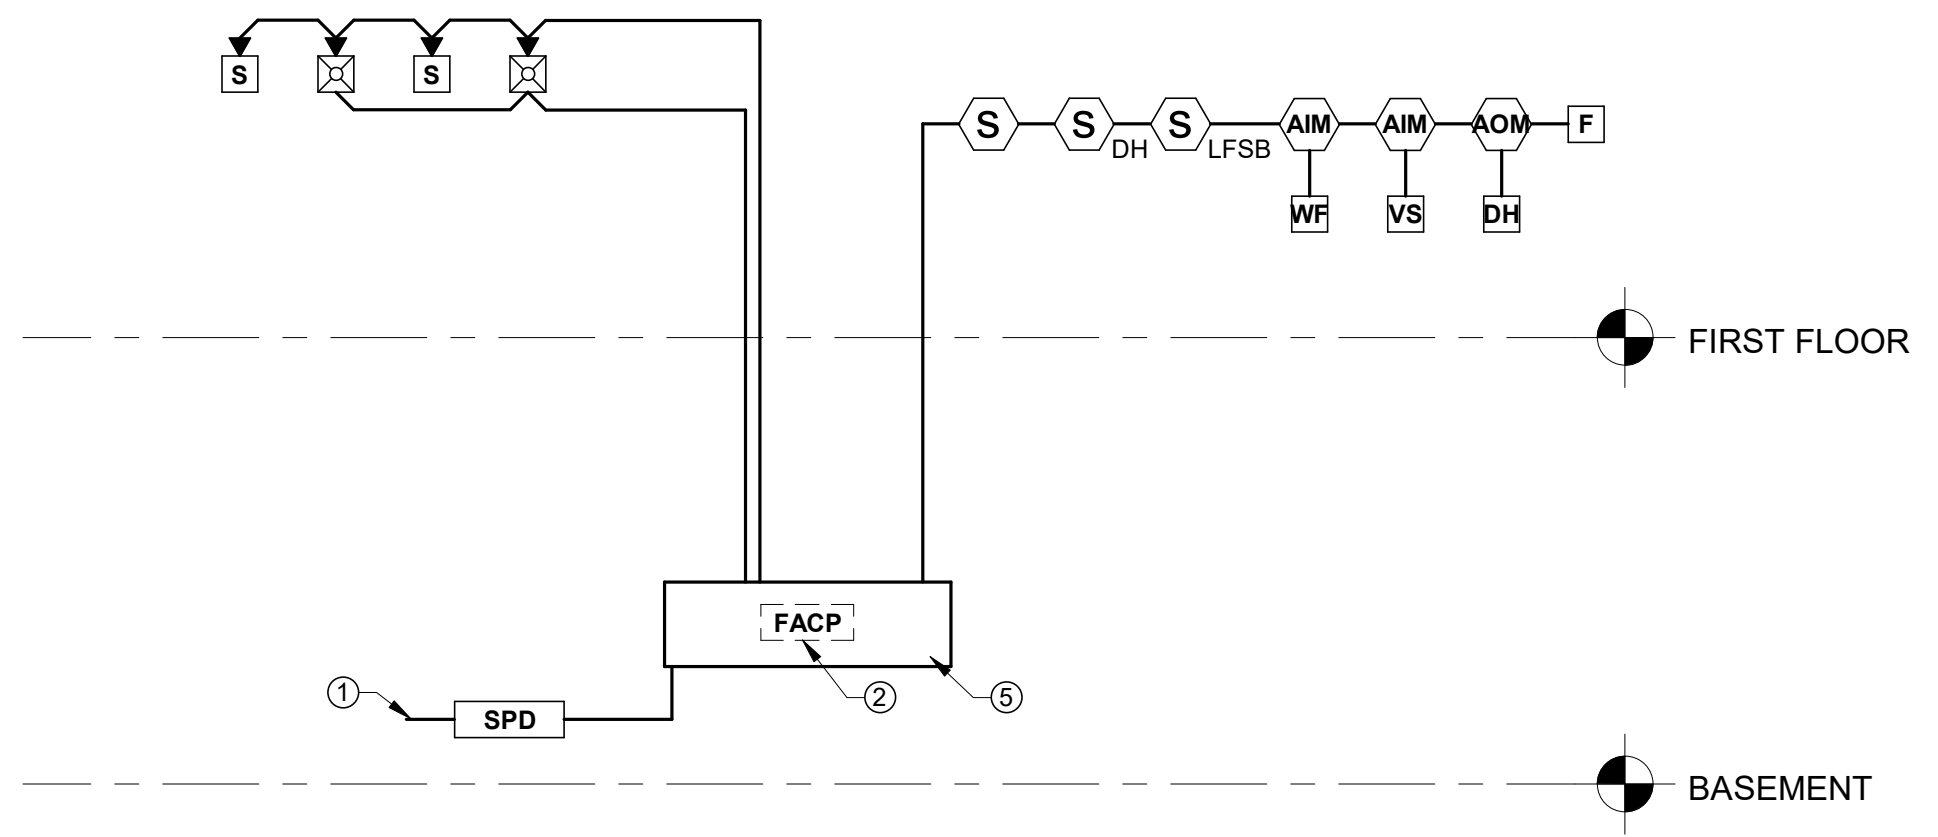


- NOTES:
- TO DEDICATED 120VAC BRANCH CIRCUIT
 - EXISTING SIMPLEX 4100ES FIRE ALARM CONTROL PANEL IS LOCATED IN BASEMENT EQUIPMENT ROOM A175B.
 - THIS RISER DIAGRAM IS INTENDED ONLY TO CAPTURE THE SYSTEM DESIGN INTENT, PANEL CONNECTIONS, AND GENERAL CIRCUIT ROUTING REQUIREMENTS. EXACT QUANTITIES AND TYPES OF DEVICES NECESSARY TO ACCOMPLISH THE DESIGN GOALS ARE NOT INDICATED. THE INTENT OF THIS RISER DIAGRAM IS TO INDICATE THE GENERAL SYSTEM CONFIGURATION AFTER SUCCESSFUL COMPLETION OF THE PROJECT.

2 FIRE ALARM RISER DIAGRAM
SCALE: NONE

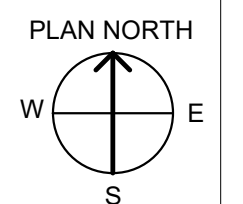


CONSULTANT INFORMATION STRUCTURAL / CIVIL ENGINEER: STAND STRUCTURAL ENGINEERING, 11827 W. 112TH STREET, SUITE 200, OVERLAND PARK, KS 66210 (913) 214-2169 MECHANICAL / ELECTRICAL / PLUMBING / TECHNICAL ENGINEER: SPUR DESIGN, 11020 KING STREET, SUITE 350, OVERLAND PARK, KS 66210 (405) 842-6100 FIRE PROTECTION ENGINEER: POOLE FIRE PROTECTION, INC., 19910 W. 161ST STREET, OLATH, KS 66062 (913) 829-8650		ARCHITECT 332 SW 20th Street, Overland Park, KS 66150 spur-design.com 11020 King Street, Suite 350, Overland Park, KS 66210 spur-design.com		Office of Construction and Facilities Management VA U.S. Department of Veteran Affairs		SHEET TITLE: FIRE ALARM GENERAL NOTES, LEGEND AND MATRIX APPROVED: PROJECT DIRECTOR		PROJECT PHASE: BID DOCUMENTS FULLY SPRINKLERED		PROJECT TITLE: RENOVATE A & B WING BLDG 6 PROJECT LOCATION: 2200 SW GAGE BLVD. TOPEKA, KS 66622		VA PROJECT NUMBER: 589A5-19-116 BUILDING NUMBER: 6 DRAWING NUMBER: 6-FA001 Dwg: 50 OF 160	
Revision # Date								DATE: 07/10/2019 CHECKED BY: KAB DRAWN BY: SAB					

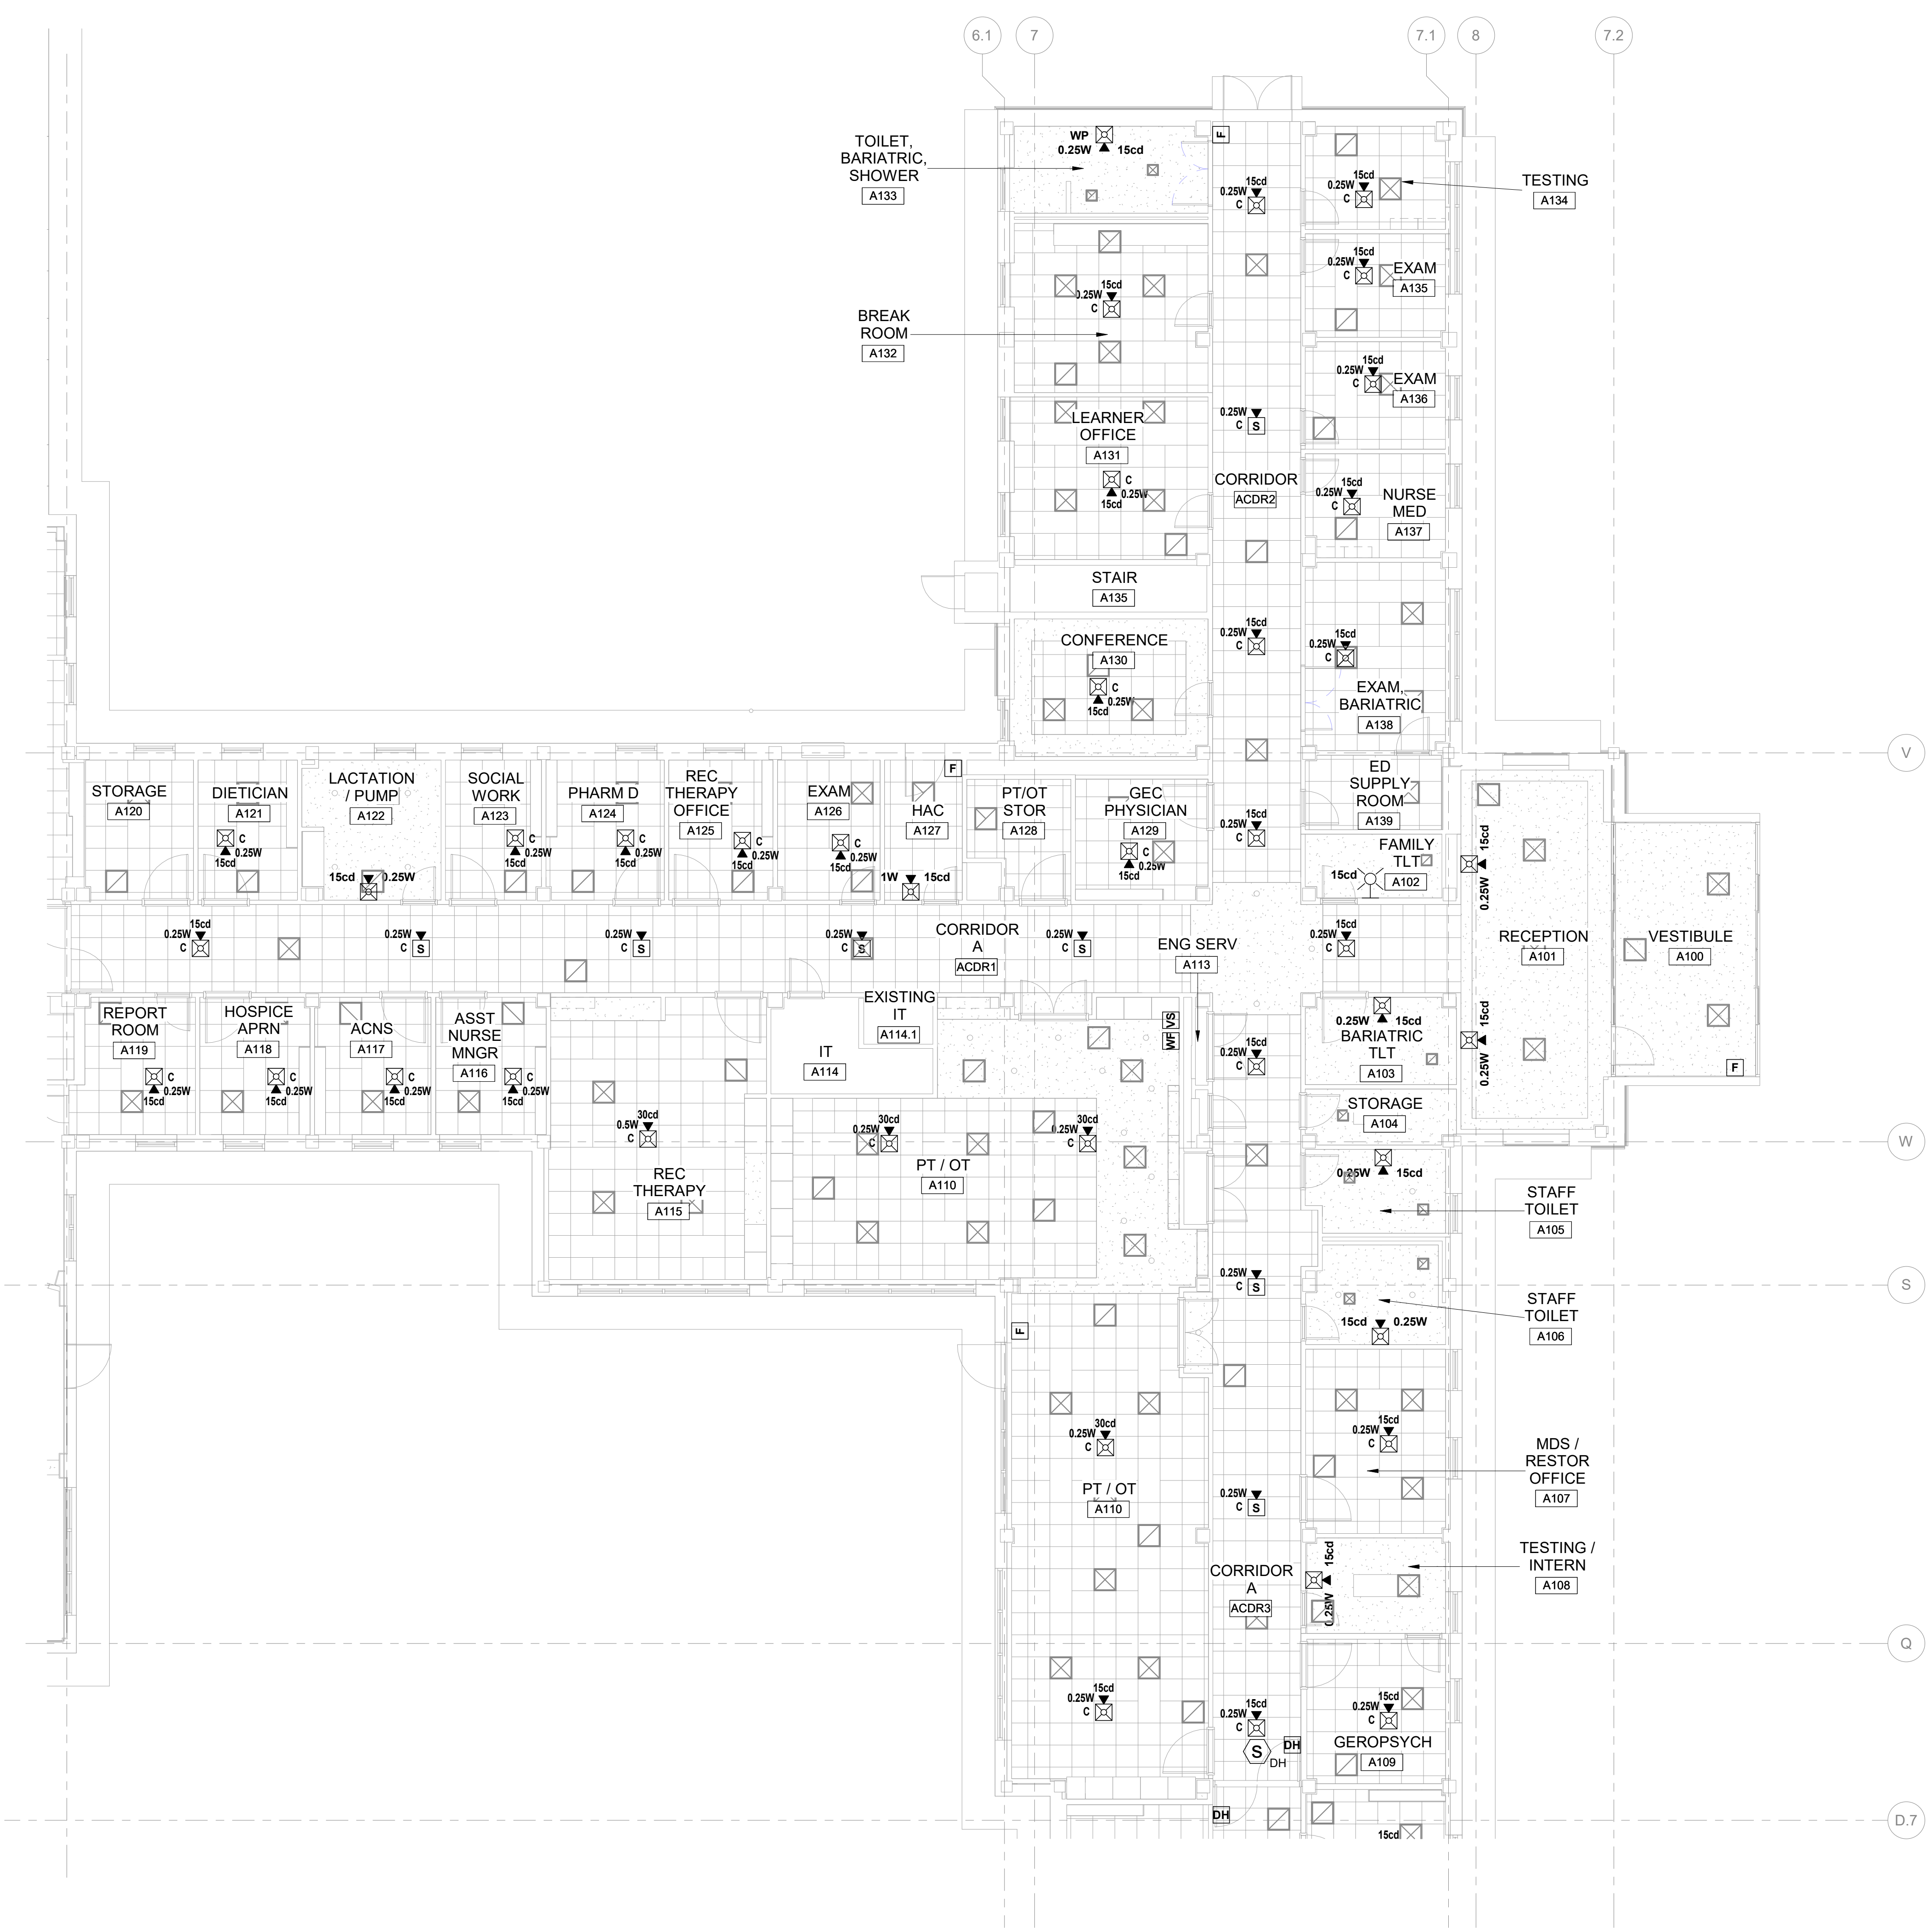


1 FIRE ALARM FLOOR PLAN - WING A
SCALE = 1/8" = 1'-0"




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Revision # Date										DATE 07/10/2019		CHECKED BY KAB		DRAWN BY SAB			

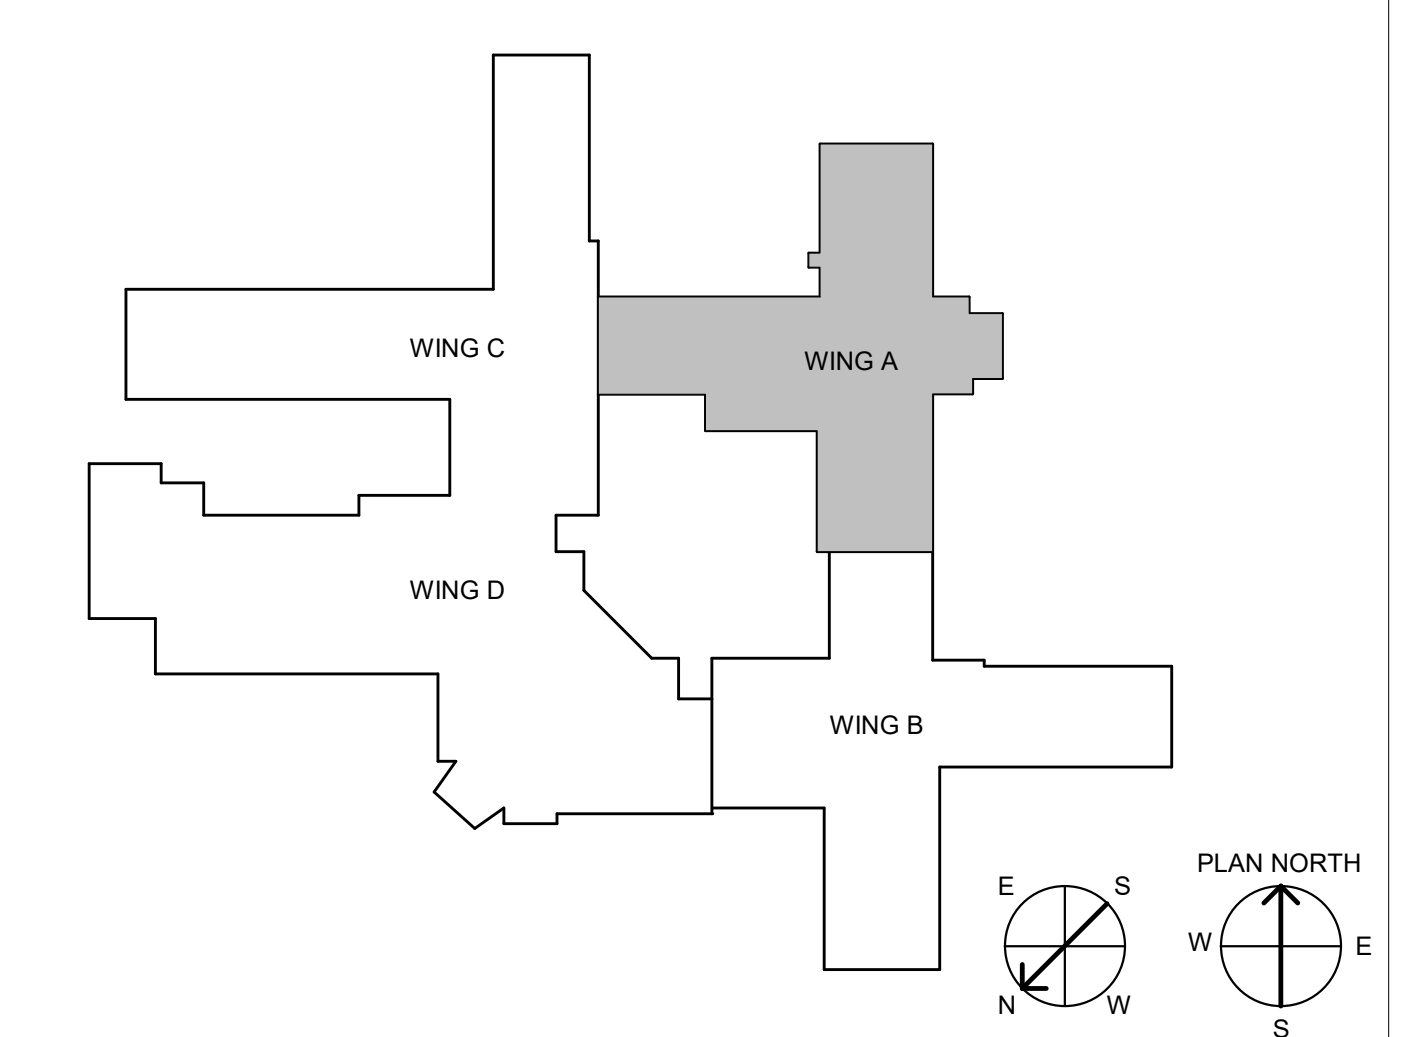


1 FIRE ALARM FLOOR PLAN - WING B
SCALE = 1/8" = 1'-0"

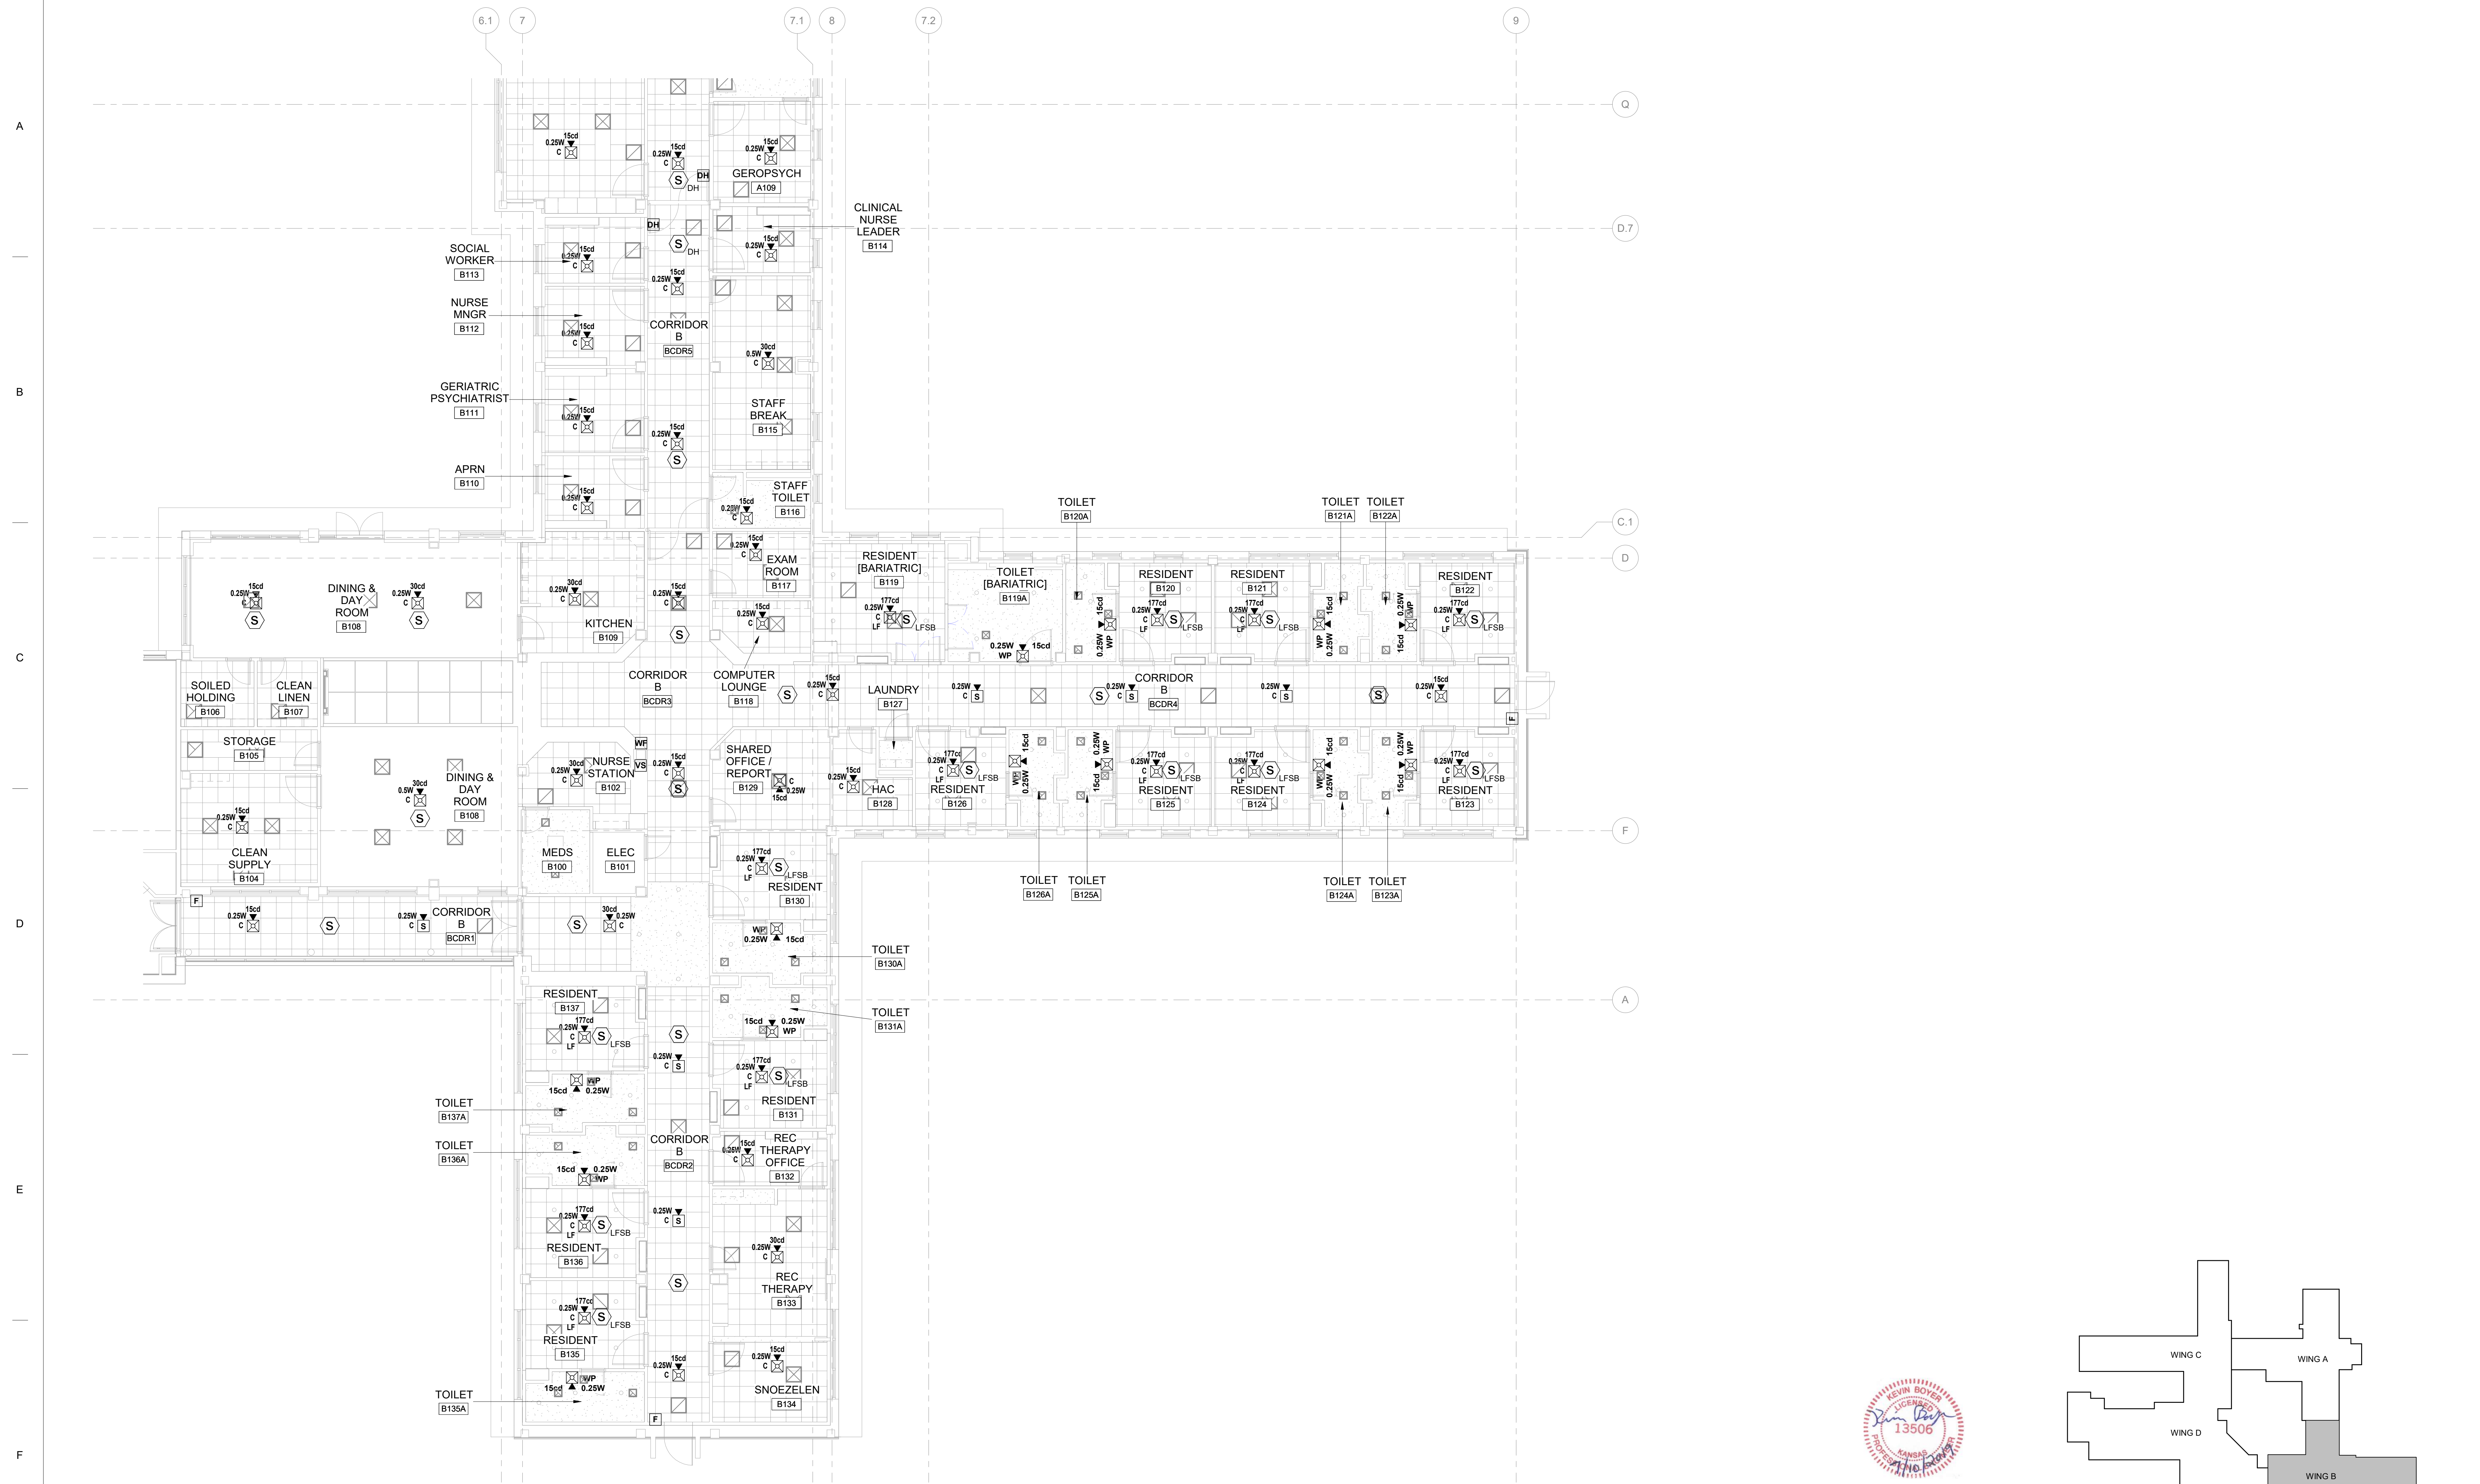


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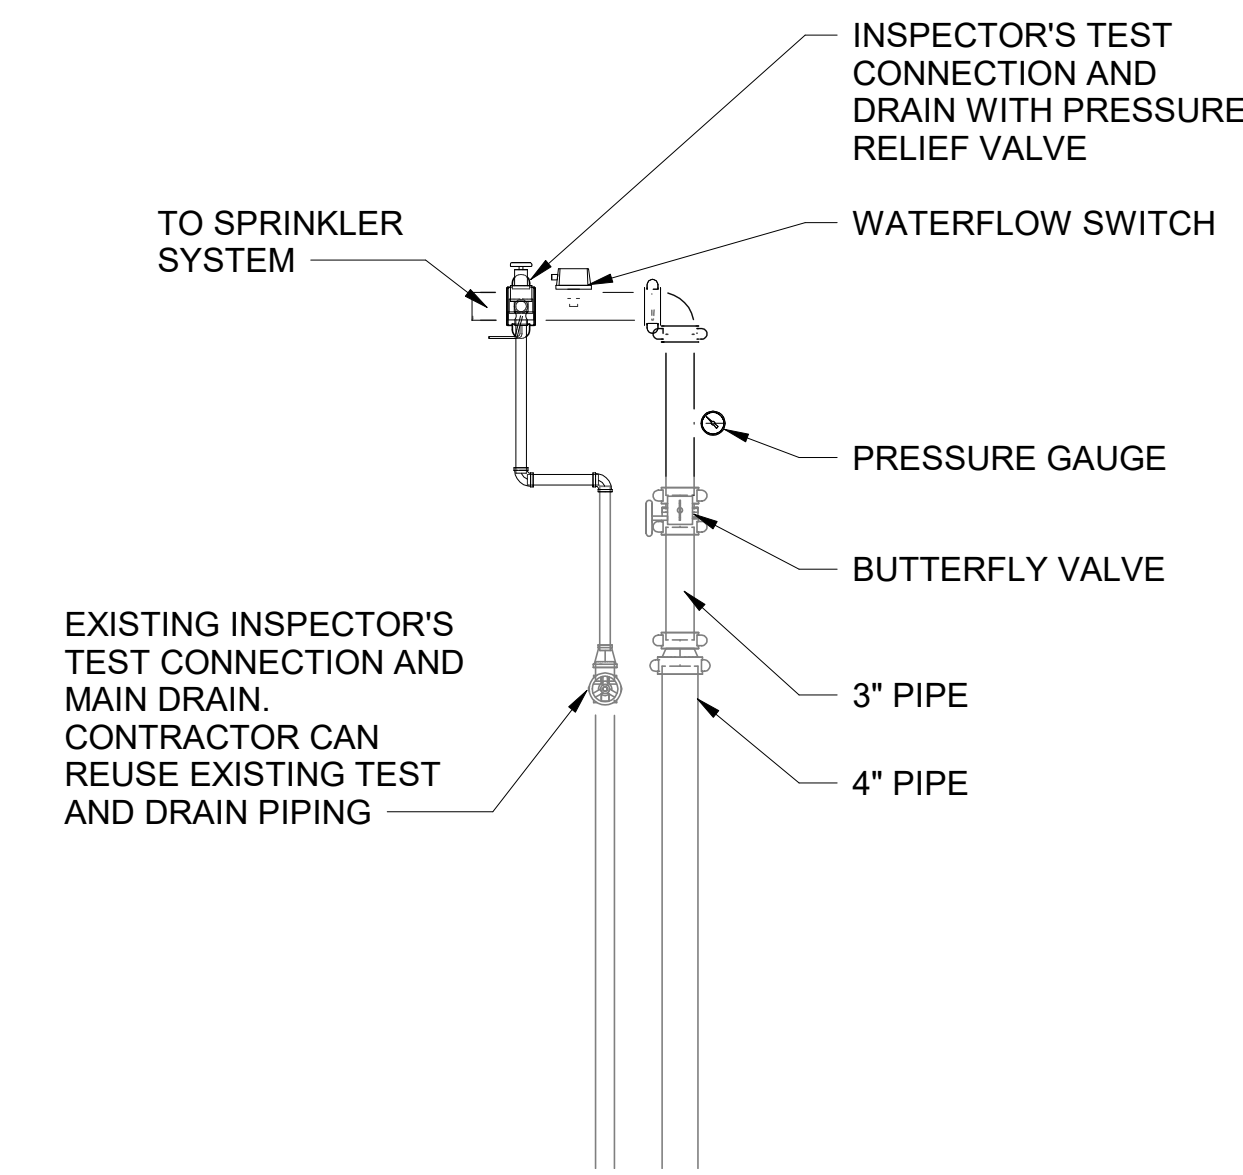
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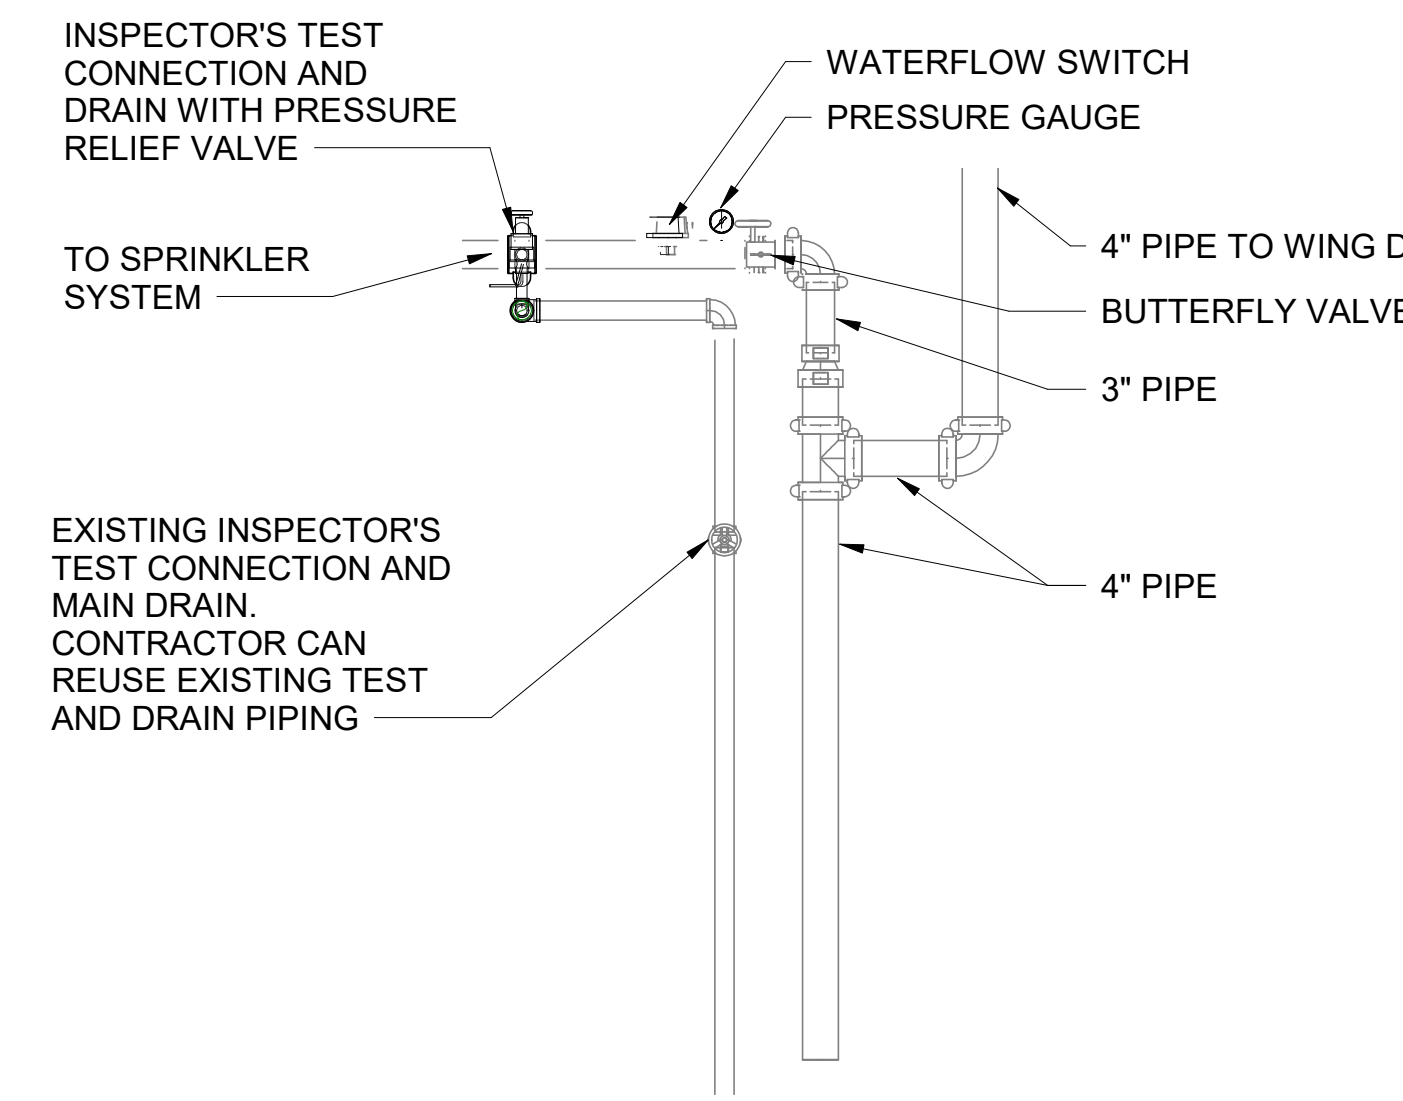
1,3 EXISTING SPRINKLER RISER ROOM A110
SCALE = 1/2" = 1'-0"

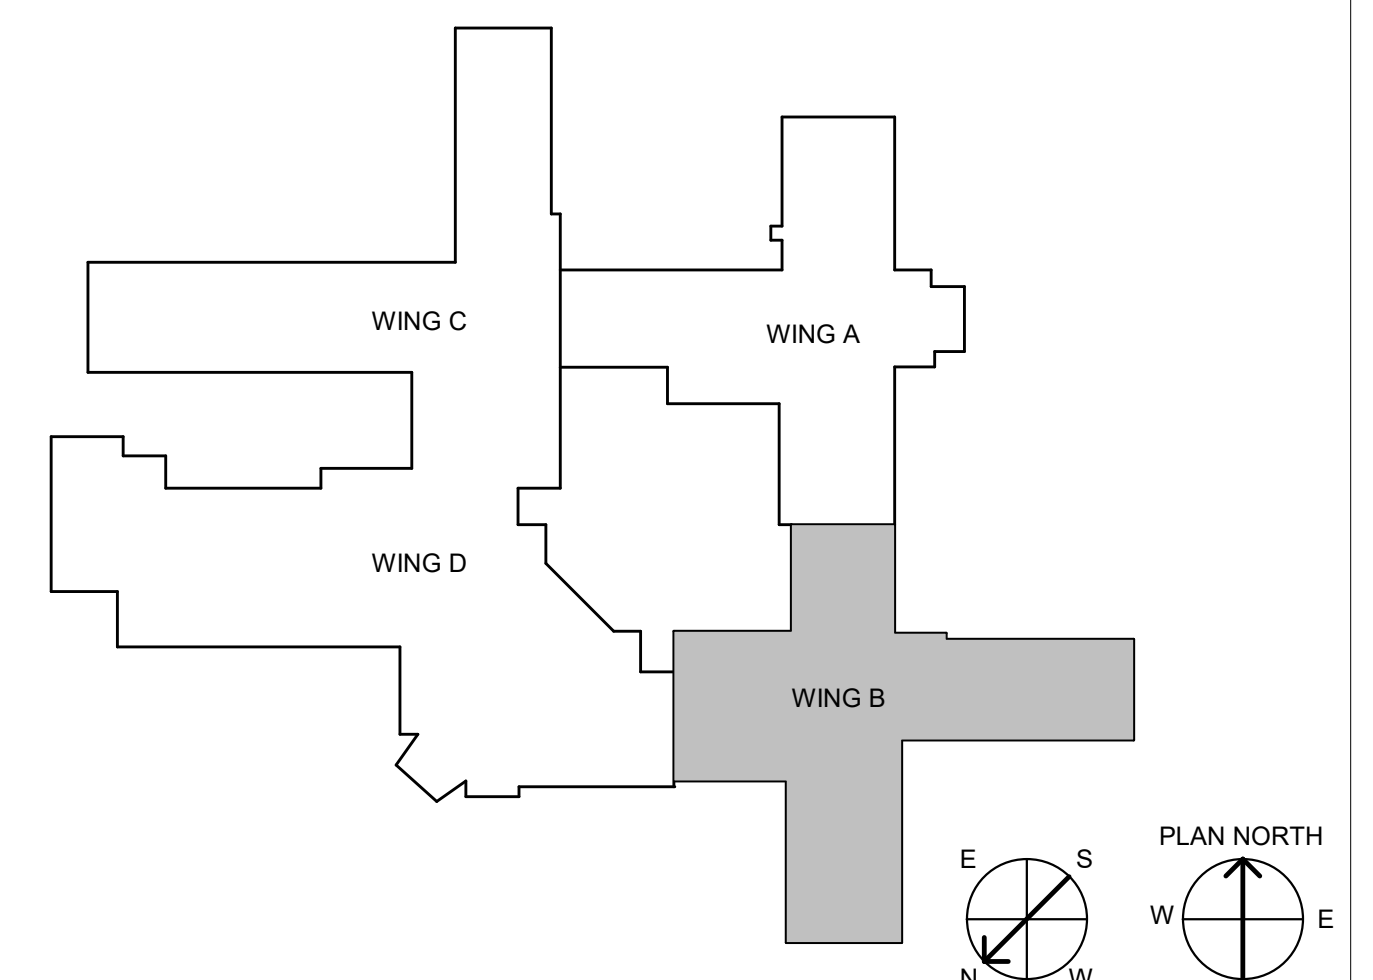

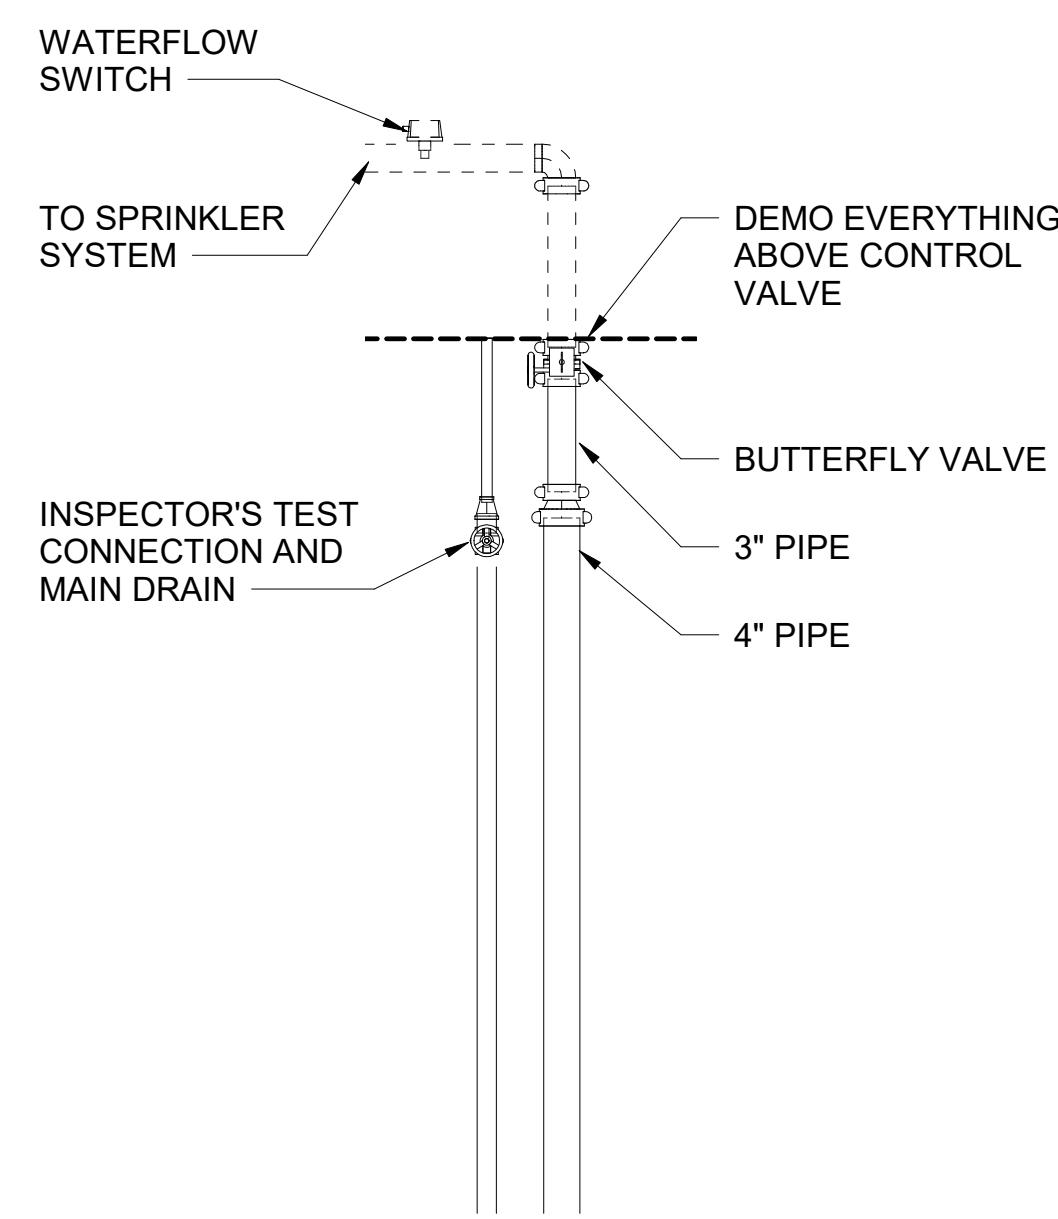2,4 EXISTING SPRINKLER RISER ROOM B102
SCALE = 1/2" = 1'-0"

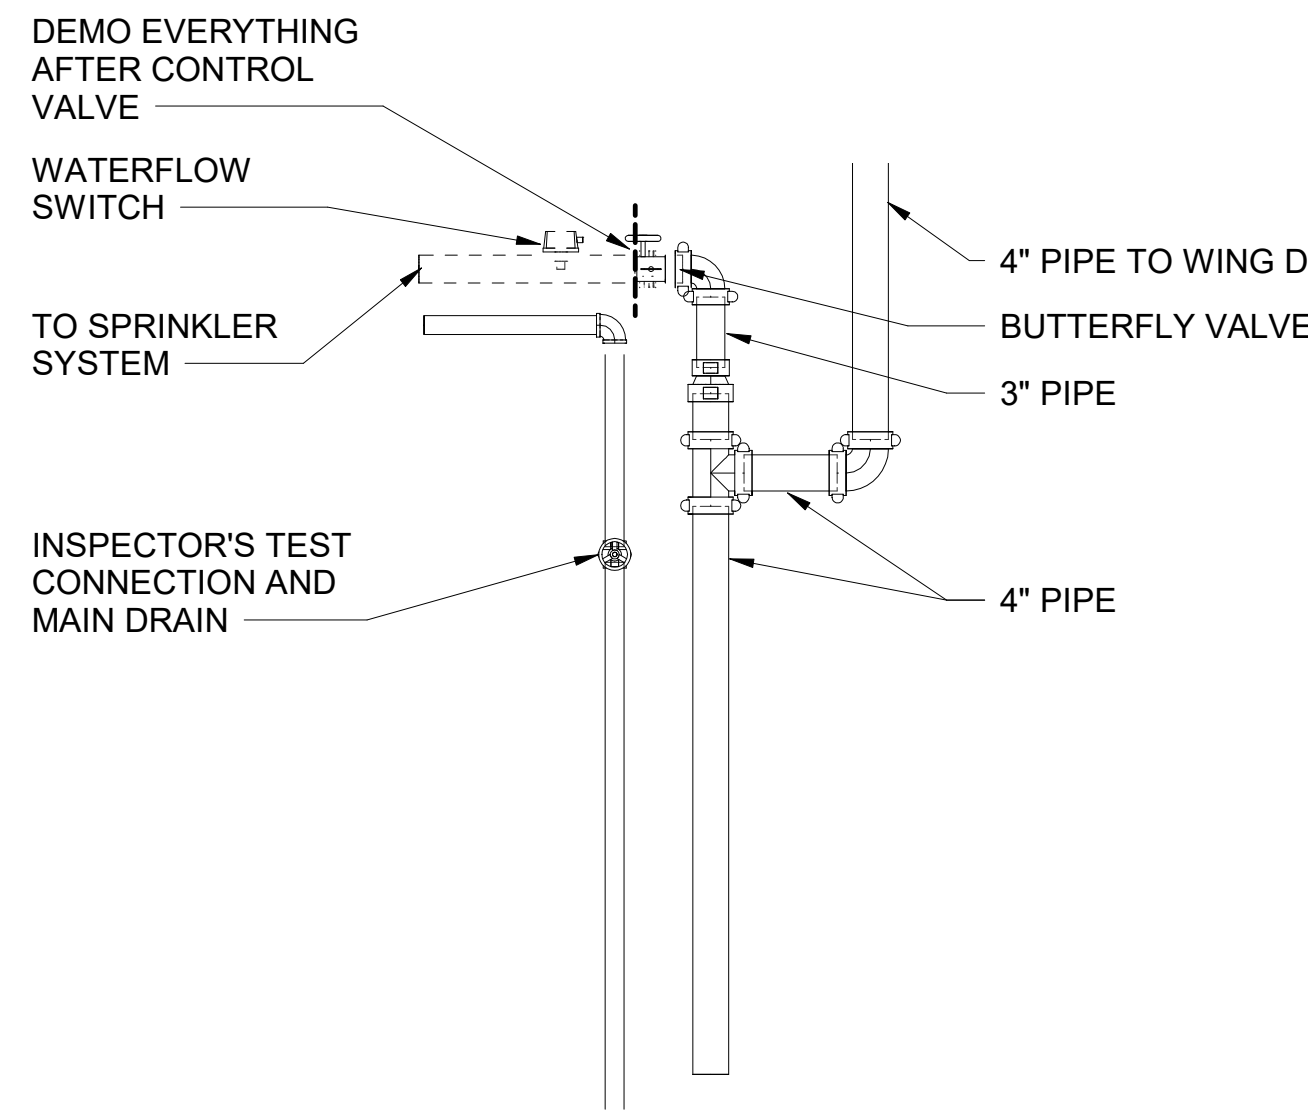

3 NEW SPRINKLER RISER ROOM A110
SCALE = 1/2" = 1'-0"




4 NEW SPRINKLER RISER ROOM B102
SCALE = 1/2" = 1'-0"

FIRE SUPPRESSION GENERAL NOTES

- THE DESIGN AND INSTALLATION OF THE FIRE PROTECTION, FIRE SUPPRESSION SYSTEM MUST BE IN ACCORDANCE WITH U.S. DEPARTMENT OF VETERANS AFFAIRS FIRE PROTECTION DESIGN MANUAL, SEVENTH EDITION, DECEMBER 2015; NFPA 13: STANDARD FOR THE INSTALLATION OF SPRINKLER SYSTEMS, 2019 EDITION; AND NFPA 291: RECOMMENDED PRACTICE FOR FIRE FLOW TESTING AND MARKING OF HYDRANTS, 2019 EDITION.
- THIS INFORMATION HAS BEEN PREPARED TO PROVIDE GUIDANCE FOR BIDDING. THE CONTRACTOR SHALL BE THE ENGINEER OF RECORD. THE FIRE PROTECTION CONTRACTOR SHALL BE FULLY RESPONSIBLE FOR PROVIDING A COMPLETE AND FULLY OPERABLE SYSTEM WHICH SHALL BE IN STRICT ACCORDANCE WITH PROJECT SPECIFICATIONS AND APPLICABLE CODES AND STANDARDS. THE WORK THAT IS INDICATED IN THIS DOCUMENT IS AN OVERVIEW OF THE PROJECT, INTENDED TO ESTABLISH THE MINIMUM SCOPE REQUIREMENTS FOR THE PROJECT AS WELL AS THE CONTRACTOR'S RESPONSIBILITIES. THE CONTRACTOR SHALL SUBMIT A COMPLETE SET OF WORKING DRAWINGS, EQUIPMENT, AND CALCULATIONS TO THE OWNER'S REPRESENTATIVE AND AHJ FOR REVIEW AND APPROVAL PRIOR TO FABRICATION AND INSTALLATION WITH THEIR ENGINEERS SEAL.
- PRIOR TO BEGINNING ANY CONSTRUCTION, THE CONTRACTOR SHALL BE RESPONSIBLE FOR VERIFICATION OF ALL DIMENSIONS, MEASUREMENTS AND LOCATIONS OF EXISTING FACILITIES, UTILITIES, EQUIPMENT AND OTHER EXISTING CONDITIONS WHICH MAY AFFECT CONSTRUCTION. BASED ON THE INFORMATION PROVIDED, THE CONTRACTOR HAS MADE EVERY ATTEMPT TO VERIFY THIS INFORMATION. HOWEVER, IN THE EVENT OF DISCREPANCIES BETWEEN THE DRAWINGS AND ACTUAL FIELD CONDITIONS, CONTACT THE CONTRACTING OFFICER IMMEDIATELY.
- SPRINKLER CONTRACTOR SHALL COORDINATE LOCATIONS OF FIRE PROTECTION COMPONENTS INCLUDING PIPING, ALARMS, DRAINS, SPRINKLERS, TEST POINTS, ETC., WITH ALL ARCHITECTURAL, STRUCTURAL, MECHANICAL, AND ELECTRICAL COMPONENTS. OBSTRUCTIONS TO SPRINKLER DISCHARGE SHALL BE CONSIDERED DURING INSTALLATION. DO NOT INSTALL SPRINKLER PIPING BELOW EQUIPMENT OR WITHIN CLEARANCE SPACES FOR MECHANICAL AND ELECTRICAL EQUIPMENT. SPRINKLERS SHALL BE INSTALLED UNDER OBSTRUCTIONS IN ACCORDANCE WITH NFPA 13.
- THE SPRINKLER SYSTEM MUST BE ZONED BY SMOKE COMPARTMENT. THE SPRINKLER RISER LOCATED IN WING A MUST ONLY FEED WING A AND THE SPRINKLER RISER LOCATED IN WING B MUST ONLY FEED WING B.
- THE EXISTING 4-INCH FEED MAIN THAT SUPPLIES WING D MUST REMAIN IN SERVICE DURING THIS CONSTRUCTION PROJECT.
- MATERIALS AND ACCESSORIES NECESSARY MUST BE INSTALLED IN ACCORDANCE WITH THE APPLICABLE NFPA CODES AND STANDARDS, PROJECT SPECIFICATIONS, AND BE UL LISTED OR FM APPROVED FOR FIRE PROTECTION USE, UNLESS OTHERWISE NOTED.
- ALL VALVES INSIDE TO BE PROVIDED WITH ELECTRONIC TAMPER SWITCHES WIRED TO THE FACU. VALVES IN NORMAL CLOSED POSITION SHALL BE PROVIDED WITH TAMPER TO ACTIVATE IN THREE TURNS OR LESS. ALL VALVES OUTSIDE TO BE SUPERVISED WITH LOCK AND CHAIN.
- ALL HANGERS MUST BE PROVIDED AND INSTALLED IN ACCORDANCE WITH NFPA 13 AND PROJECT SPECIFICATIONS.
- LOCATION AND INSTALLATION OF PIPE SUPPORTS (HANGERS, VERTICAL RESTRAINTS, AND GUIDES) SHALL MEET THE REQUIREMENTS OF NFPA 13 AND THE SPECIAL LISTING REQUIREMENTS (IF APPLICABLE) OF THE PIPE AND SUPPORTS.
- THE INSPECTOR'S TEST VALVES MUST BE LOCATED NO MORE THAN 7 FEET AFF.
- APPLICABLE UL CONSTRUCTION DETAILS AND SYSTEMS SHALL BE USED WHERE FIRE RATED BARRIERS ARE PENETRATED BY SPRINKLER PIPING.
- ALL VALVES (DRAINS, INSPECTOR'S TEST, CONTROL) MUST BE IDENTIFIED AS REQUIRED BY NFPA 13.
- PIPING MUST BE ARRANGED FOR FLUSHING, READILY REMOVABLE FITTINGS MUST BE PROVIDED AT THE END OF ALL CROSS MAINS.
- ALL PENDENT SPRINKLERS MUST BE INSTALLED IN THE CENTER OF THE CEILING TILES.
- DRAINS MUST BE LOCATED TO PROVIDE DRAINAGE IN ACCORDANCE WITH NFPA 13. ALL DRAINS AND TEST CONNECTIONS MUST DISCHARGE TO THE EXTERIOR OF THE BUILDING ON TO A SPLASH BLOCK OR PAVEMENT, AND SHALL NOT DISCHARGE ACROSS PATHS OF EGRESS.
- ALL SPRINKLER SYSTEM ALARM INITIATING AND SUPERVISORY DEVICES MUST BE CONNECTED TO THE FIRE ALARM SYSTEM.
- ADDITIONAL SPRINKLERS MAY BE REQUIRED UNDER DUCT WORK TO PROVIDE ADEQUATE COVERAGE PER NFPA 13.
- A LISTED RELIEF VALVE MUST BE PROVIDED IN ACCORDANCE WITH NFPA 13, SECTION 8.1.2 FOR THE SPRINKLER SYSTEM.
- AN AIR VENT MUST BE PROVIDED IN ACCORDANCE WITH NFPA 13, SECTION 8.1.5 AND SECTION 16.7 FOR THE SPRINKLER SYSTEM.
- THIS BUILDING WILL HAVE A WET PIPE AUTOMATIC SPRINKLER SYSTEM WHICH WILL REQUIRE ALL AREAS OF THE BUILDING TO BE MAINTAINED ABOVE 40 DEGREES F.
- PROVIDE SPRINKLER PROTECTION WITHIN ALL COMBUSTIBLE CONCEALED SPACES.
- DEMOLISH THE SPRINKLER SYSTEM IN ALL AREAS OF WING A AND B FROM THE SPRINKLERS BACK TO THE SPRINKLER RISER BUTTERFLY VALVES. ALL DEMOLISHED EQUIPMENT AND MATERIALS MUST BE PROPERLY DISPOSED OF BY THE CONTRACTOR.
- INSTALL NEW CHECK VALVES, WATERFLOW SWITCHES, AND INSPECTOR'S TEST CONNECTIONS WITH PRESSURE RELIEF VALVE.




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HAZARD CLASSIFICATION LEGEND	
	LIGHT HAZARD (0.10 GPM/FT² OVER 1,500 FT² WITH 100 GPM EXTERIOR HOSE DEMAND)
	ORDINARY HAZARD GROUP 1 (0.15 GPM/FT² OVER 1,500 FT² WITH 250 GPM EXTERIOR HOSE DEMAND)
	ORDINARY HAZARD GROUP 2 (0.20 GPM/FT² OVER 1,500 FT² WITH 250 GPM EXTERIOR HOSE DEMAND)

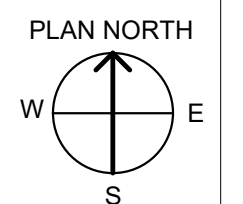FIRE SUPPRESSION LEGEND	
	EXISTING FIRE SUPPRESSION RISER



1 FIRE SUPPRESSION HAZARD CLASSIFICATION FLOOR PLAN - WING A
SCALE = 1/8" = 1'-0"

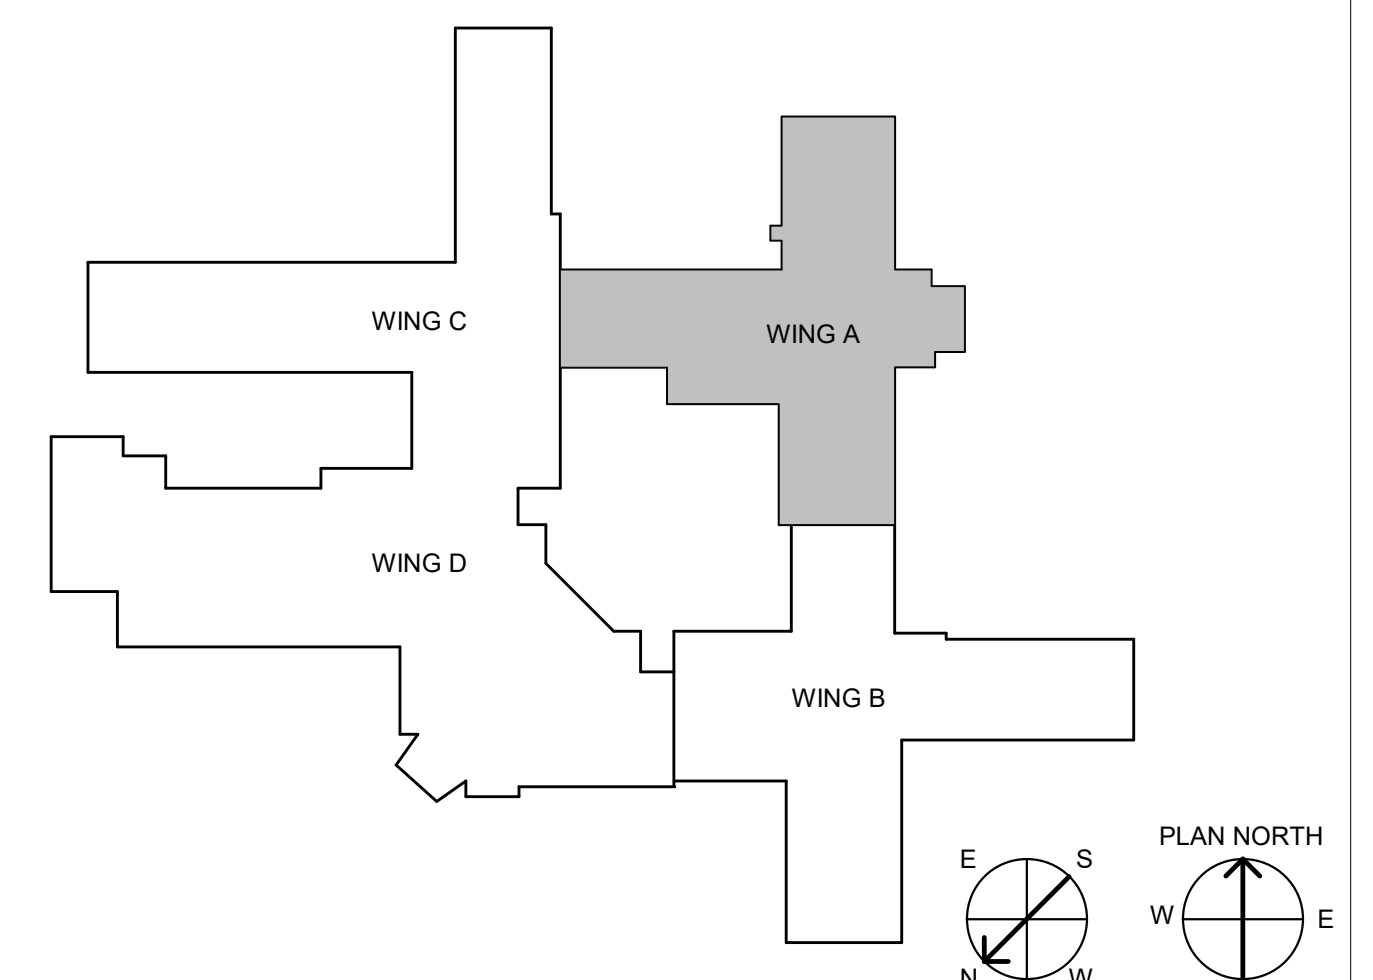

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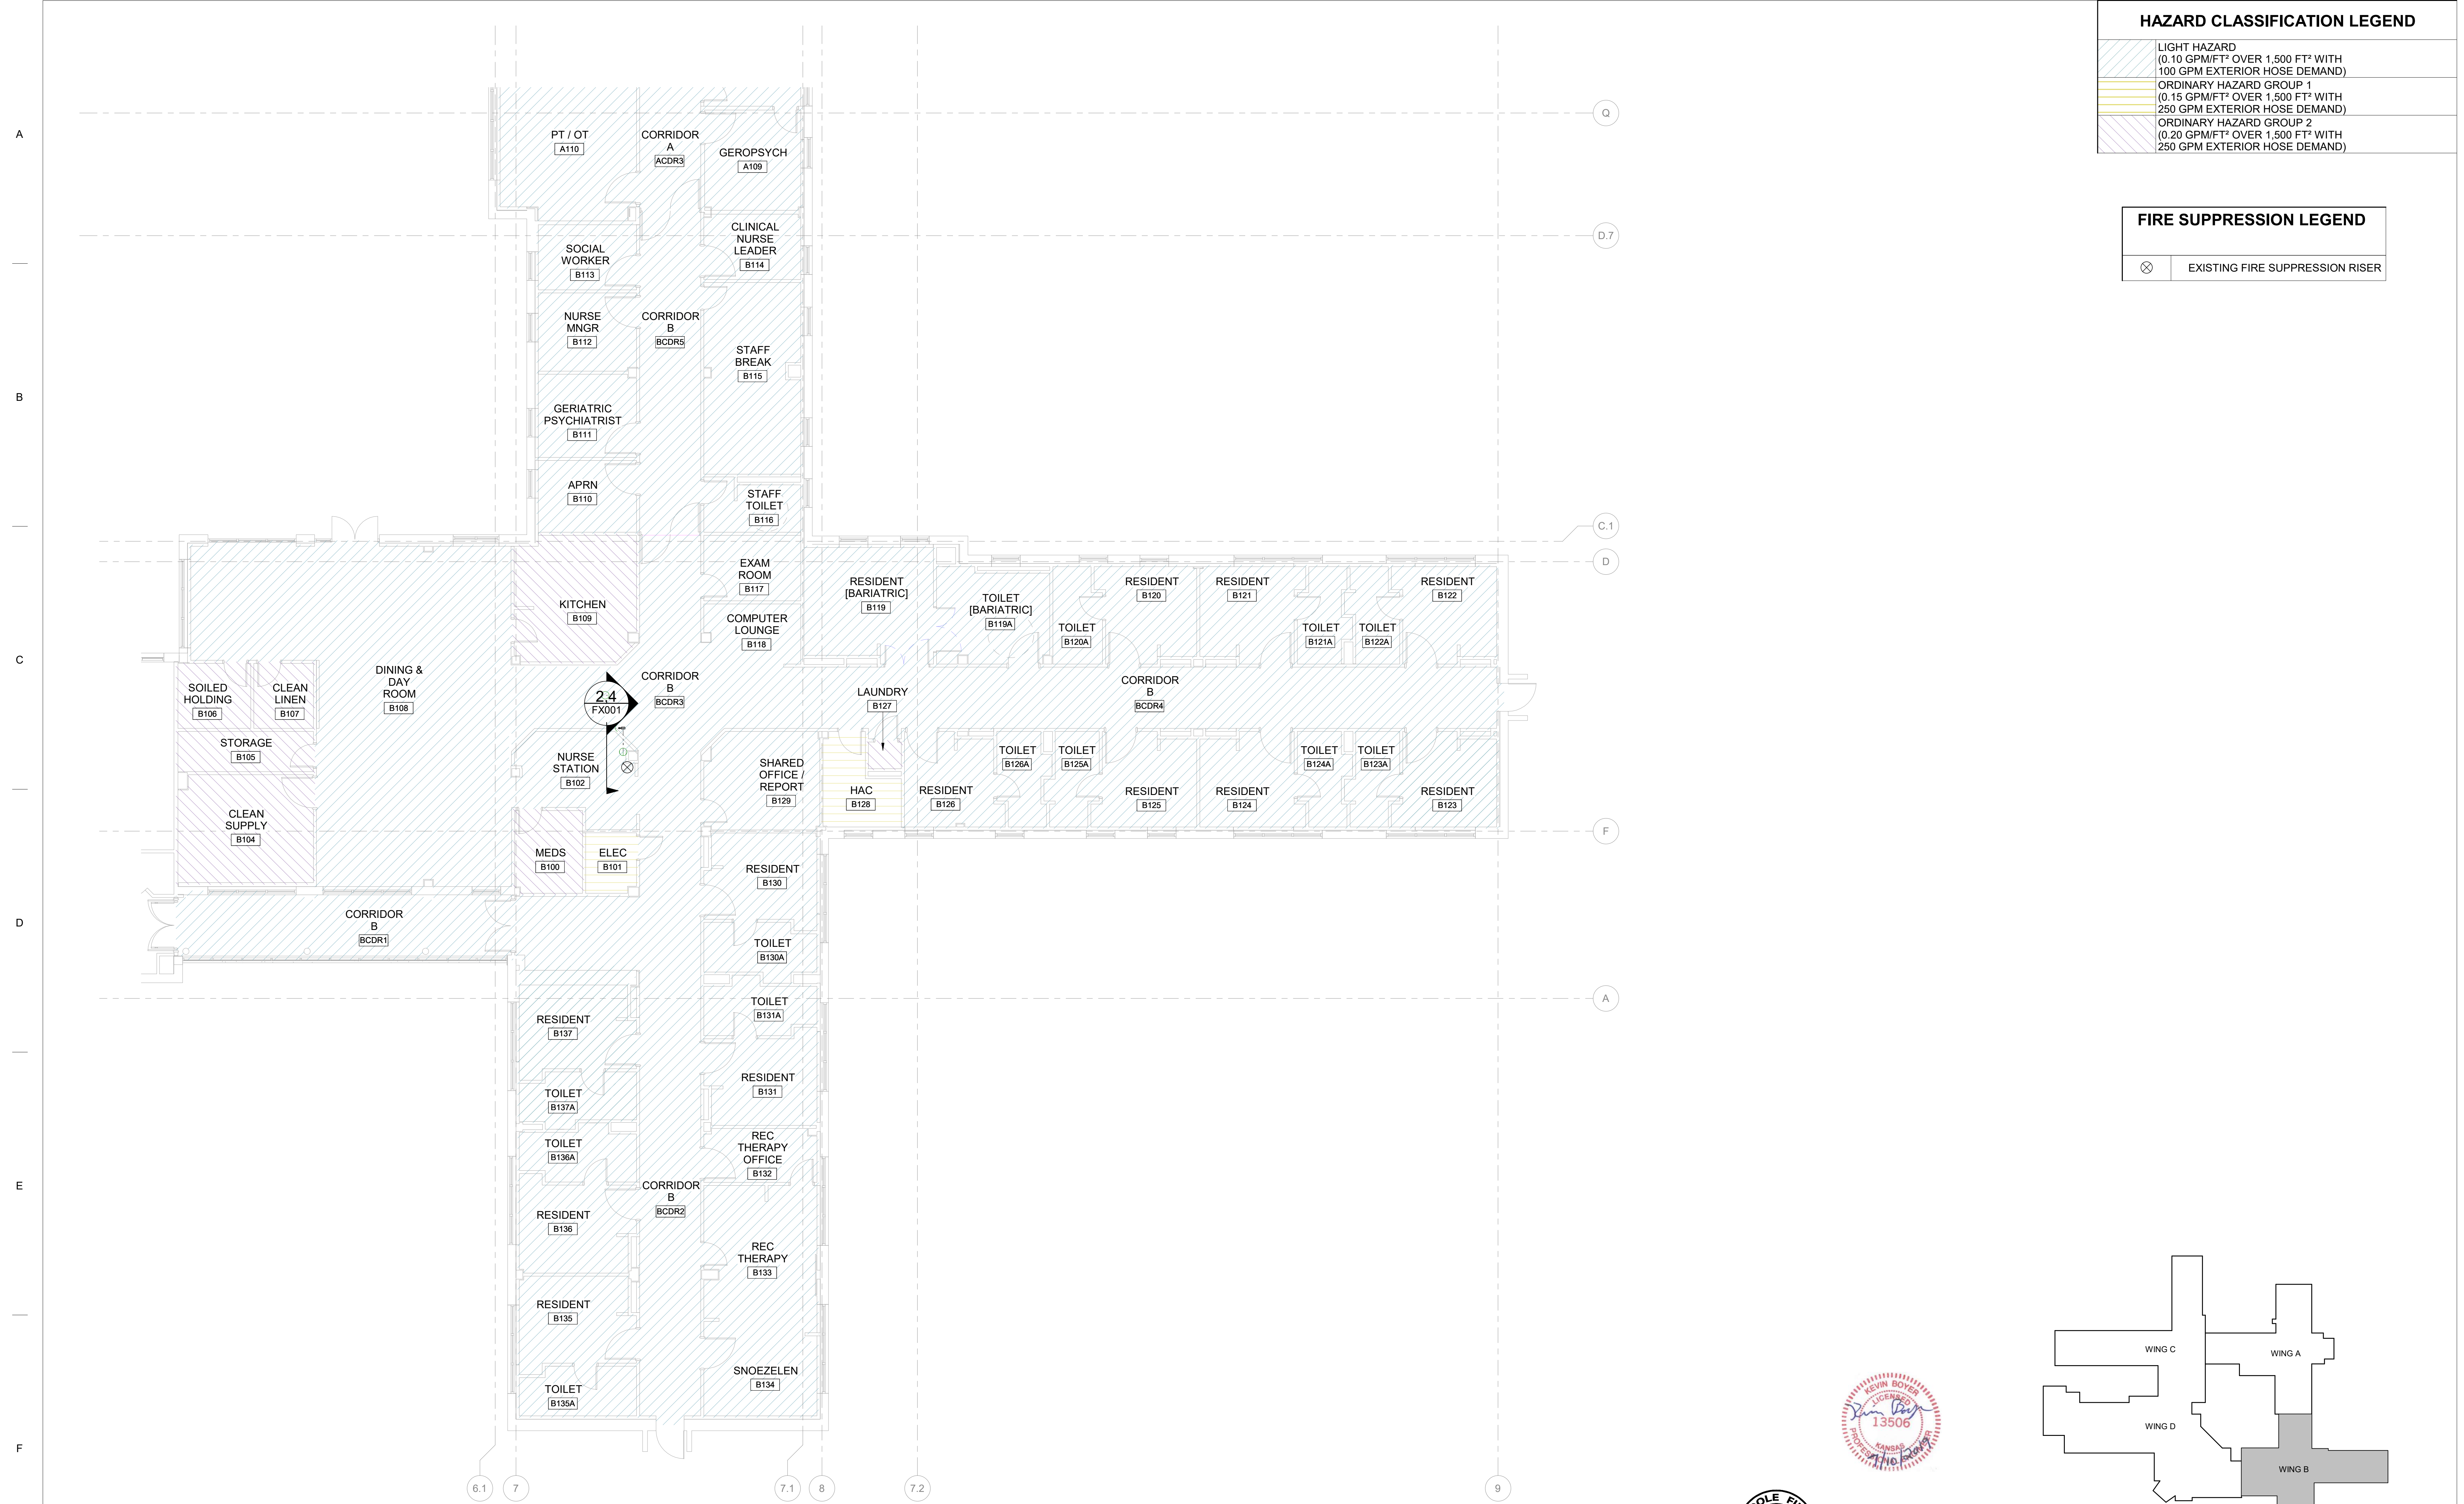
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HAZARD CLASSIFICATION LEGEND

	LIGHT HAZARD (0.10 GPM/FT² OVER 1,500 FT² WITH 100 GPM EXTERIOR HOSE DEMAND)
	ORDINARY HAZARD GROUP 1 (0.15 GPM/FT² OVER 1,500 FT² WITH 250 GPM EXTERIOR HOSE DEMAND)
	ORDINARY HAZARD GROUP 2 (0.20 GPM/FT² OVER 1,500 FT² WITH 250 GPM EXTERIOR HOSE DEMAND)

FIRE SUPPRESSION LEGEND


	EXISTING FIRE SUPPRESSION RISER
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1 FIRE SUPPRESSION HAZARD CLASSIFICATION FLOOR PLAN - WING B
SCALE = 1/8" = 1'-0"



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<p>Revision # Date</p>		<p>CONSULTANT INFORMATION</p> <p>STRUCTURAL / CIVIL ENGINEER: STAND STRUCTURAL ENGINEERING, 11827 W. 112TH STREET, SUITE 200, OVERLAND PARK, KS 66210, (913) 214-2169</p> <p>MECHANICAL / ELECTRICAL / PLUMBING / TECHNICAL ENGINEER: SPUR DESIGN, 11020 KING STREET, SUITE 350, OVERLAND PARK, KS 66210, (405) 842-6100</p> <p>FIRE PROTECTION ENGINEER: POOLE FIRE PROTECTION, INC., 19910 W. 161ST STREET, OLATH, KS 66062, (913) 829-8650</p>		<p>ARCHITECT</p> <p>SPUR DESIGN</p> <p>332 SW 20th Street, Overland Park, KS 66150, spur-design.com</p> <p>11020 King Street, Suite 350, Overland Park, KS 66150, spur-design.com</p> <p>KS ARCH REG. NO. A-1139, EXP. 12/31/2019 KS ENGR REG. NO. E-2586, EXP. 12/31/2019</p>		<p>Office of Construction and Facilities Management</p> <p>VA U.S. Department of Veteran Affairs</p>		<p>SHEET TITLE: FIRE SUPPRESSION HAZARD CLASSIFICATION FLOOR PLAN - WING B</p> <p>APPROVED: PROJECT DIRECTOR</p>		<p>PROJECT PHASE: BID DOCUMENTS</p> <p>FULLY SPRINKLERED</p>		<p>PROJECT TITLE: RENOVATE A & B WING BLDG 6</p> <p>PROJECT LOCATION: 2200 SW GAGE BLVD. TOPEKA, KS 66622</p> <p>DATE: 07/10/2019</p> <p>CHECKED BY: KAB</p> <p>DRAWN BY: DRF</p>		<p>VA PROJECT NUMBER: 589A5-19-116</p> <p>BUILDING NUMBER: 6</p> <p>DRAWING NUMBER: 6-FX102</p> <p>Dwg. 55 OF 160</p>	
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three-eighths inch = one foot
one-eighth inch = one foot
one-quarter inch = one foot
one-half inch = one foot
one and one-half inches = one foot
three inches = one foot

ABBREVIATIONS, GENERAL PLUMBING SYMBOLS, VALVE SYMBOLS, PIPING SYMBOLS. Includes symbols for cleanouts, drains, equipment, fittings, valves, piping, and waste lines with their respective abbreviations and descriptions.

CONSULTANT INFORMATION (Structural, Mechanical, Fire Protection), ARCHITECT (SPUR DESIGN), Office of Construction and Facilities Management (U.S. Department of Veteran Affairs), SHEET TITLE (PLUMBING LEGEND), PROJECT PHASE (BID DOCUMENTS), PROJECT TITLE (RENOVATE A & B WING BUILDING 6), PROJECT LOCATION (2200 SW GAGE BLVD TOPEKA, KS 66622), DATE (07/10/2019), CHECKED BY (JES), DRAWN BY (RLC), VA PROJECT NUMBER (589-A5-19-116), BUILDING NUMBER (6), DRAWING NUMBER (6-P-000), Dwg. 56 OF 160.

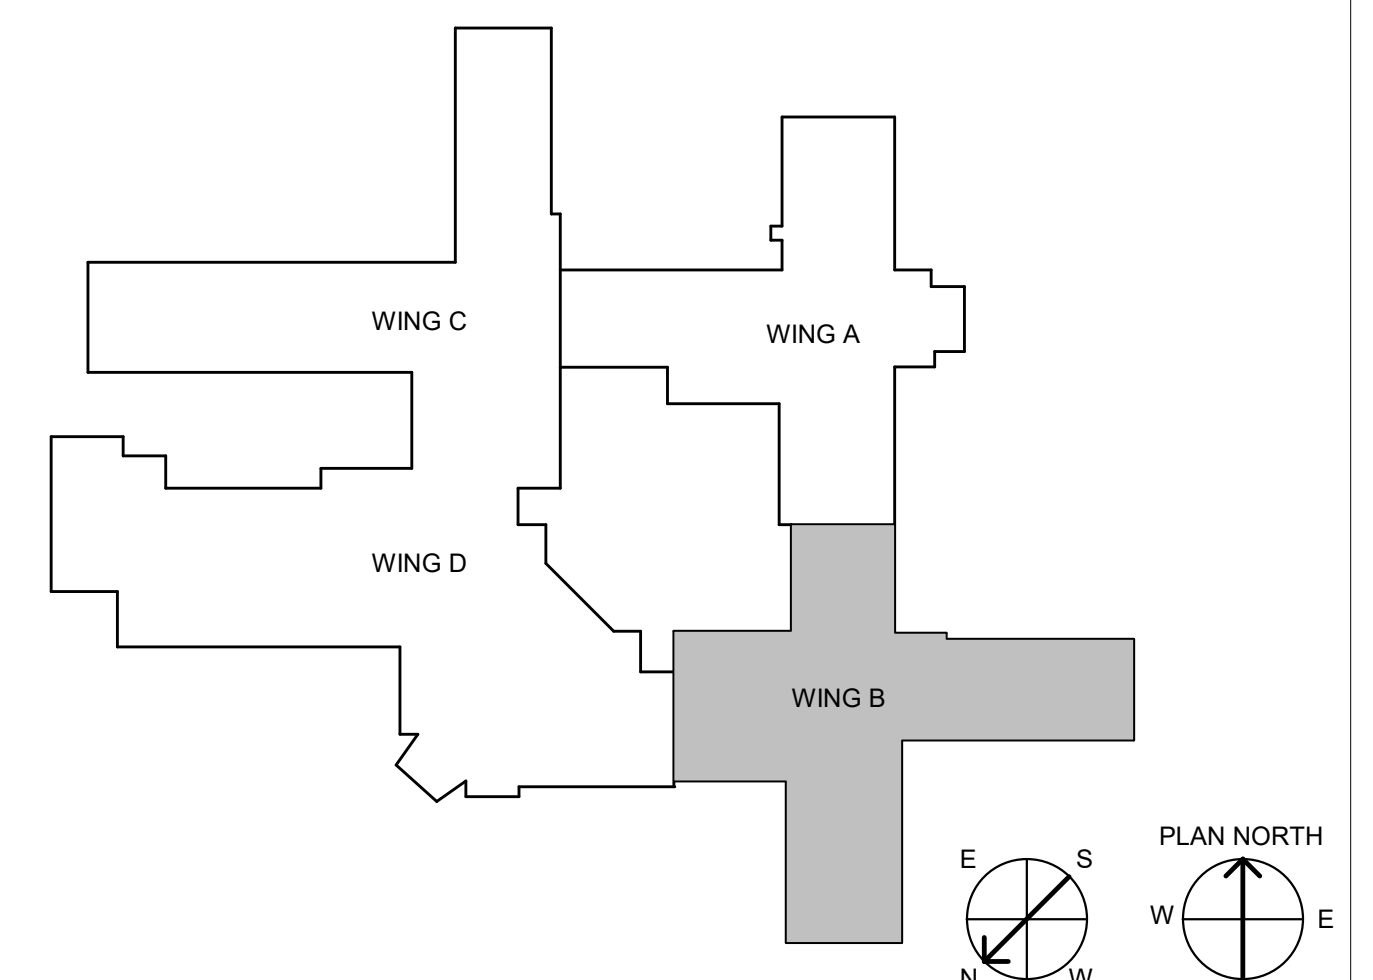
- GENERAL NOTES:**
1. THE AREA OF WORK SHOWN IS ASSOCIATED WITH AN OPERATING FACILITY THAT MUST REMAIN IN SERVICE 24/7.
 2. SEE SHEET 6I-001 FOR ADDITIONAL INFORMATION REGARDING SCHEDULE AND PHASING REQUIREMENTS. SCHEDULE WORK TO MINIMIZE DISRUPTION OF SERVICES.
 3. COORDINATE WORK SCHEDULE WITH THE CONTRACTING OFFICER'S REPRESENTATIVE (COR) BEFORE THE START OF WORK.
 4. COORDINATE PLUMBING WORK WITH OTHER TRADES AND CONTRACTORS. VERIFY ALL EXISTING CONDITIONS BEFORE THE START OF WORK.
 5. COORDINATE TEMPORARY ROOF DRAINAGE DURING CONSTRUCTION AND REPLACEMENT OF STORM PIPE.
 6. THE DEMOLITION DRAWINGS ARE DEEMED SCHEMATIC. CONTRACTOR RESPONSIBLE FOR FIELD VERIFYING EXISTING DEMOLITION WORK PRIOR TO SUBMISSION OF PROPOSAL.
 7. ALL PLUMBING FIXTURES SHOWN ON THIS SHEET ARE EXISTING TO BE DEMOLISHED UNLESS NOTED OTHERWISE.

DEDUCT ALTERNATE & PHASING:


ALL PLAN WORK SHOWN ON THIS SHEET IS SUBJECT TO THE OVERALL PROJECT PHASING SEQUENCE OUTLINED ON ARCHITECTURAL SHEET 6-GI-102.

IN ADDITION, IF THE DEDUCT ALTERNATE IS ELECTED, ALL PLAN WORK ON THIS SHEET IS ALSO SUBJECT TO THE REDUCED AREAS OF WORK AS DEFINED ON ARCHITECTURAL SHEET 6-GI-105.

- PLUMBING DEMO PLAN NOTES:**
- 1 DEMOLISH EXISTING STORM PIPING TO DEMARCATION POINT SHOWN.
- DEDUCT ALTERNATE NOTES:**
- A1: IF DEDUCT ALTERNATE IS ACCEPTED, DO NOT DEMOLISH EXISTING STORM PIPING.

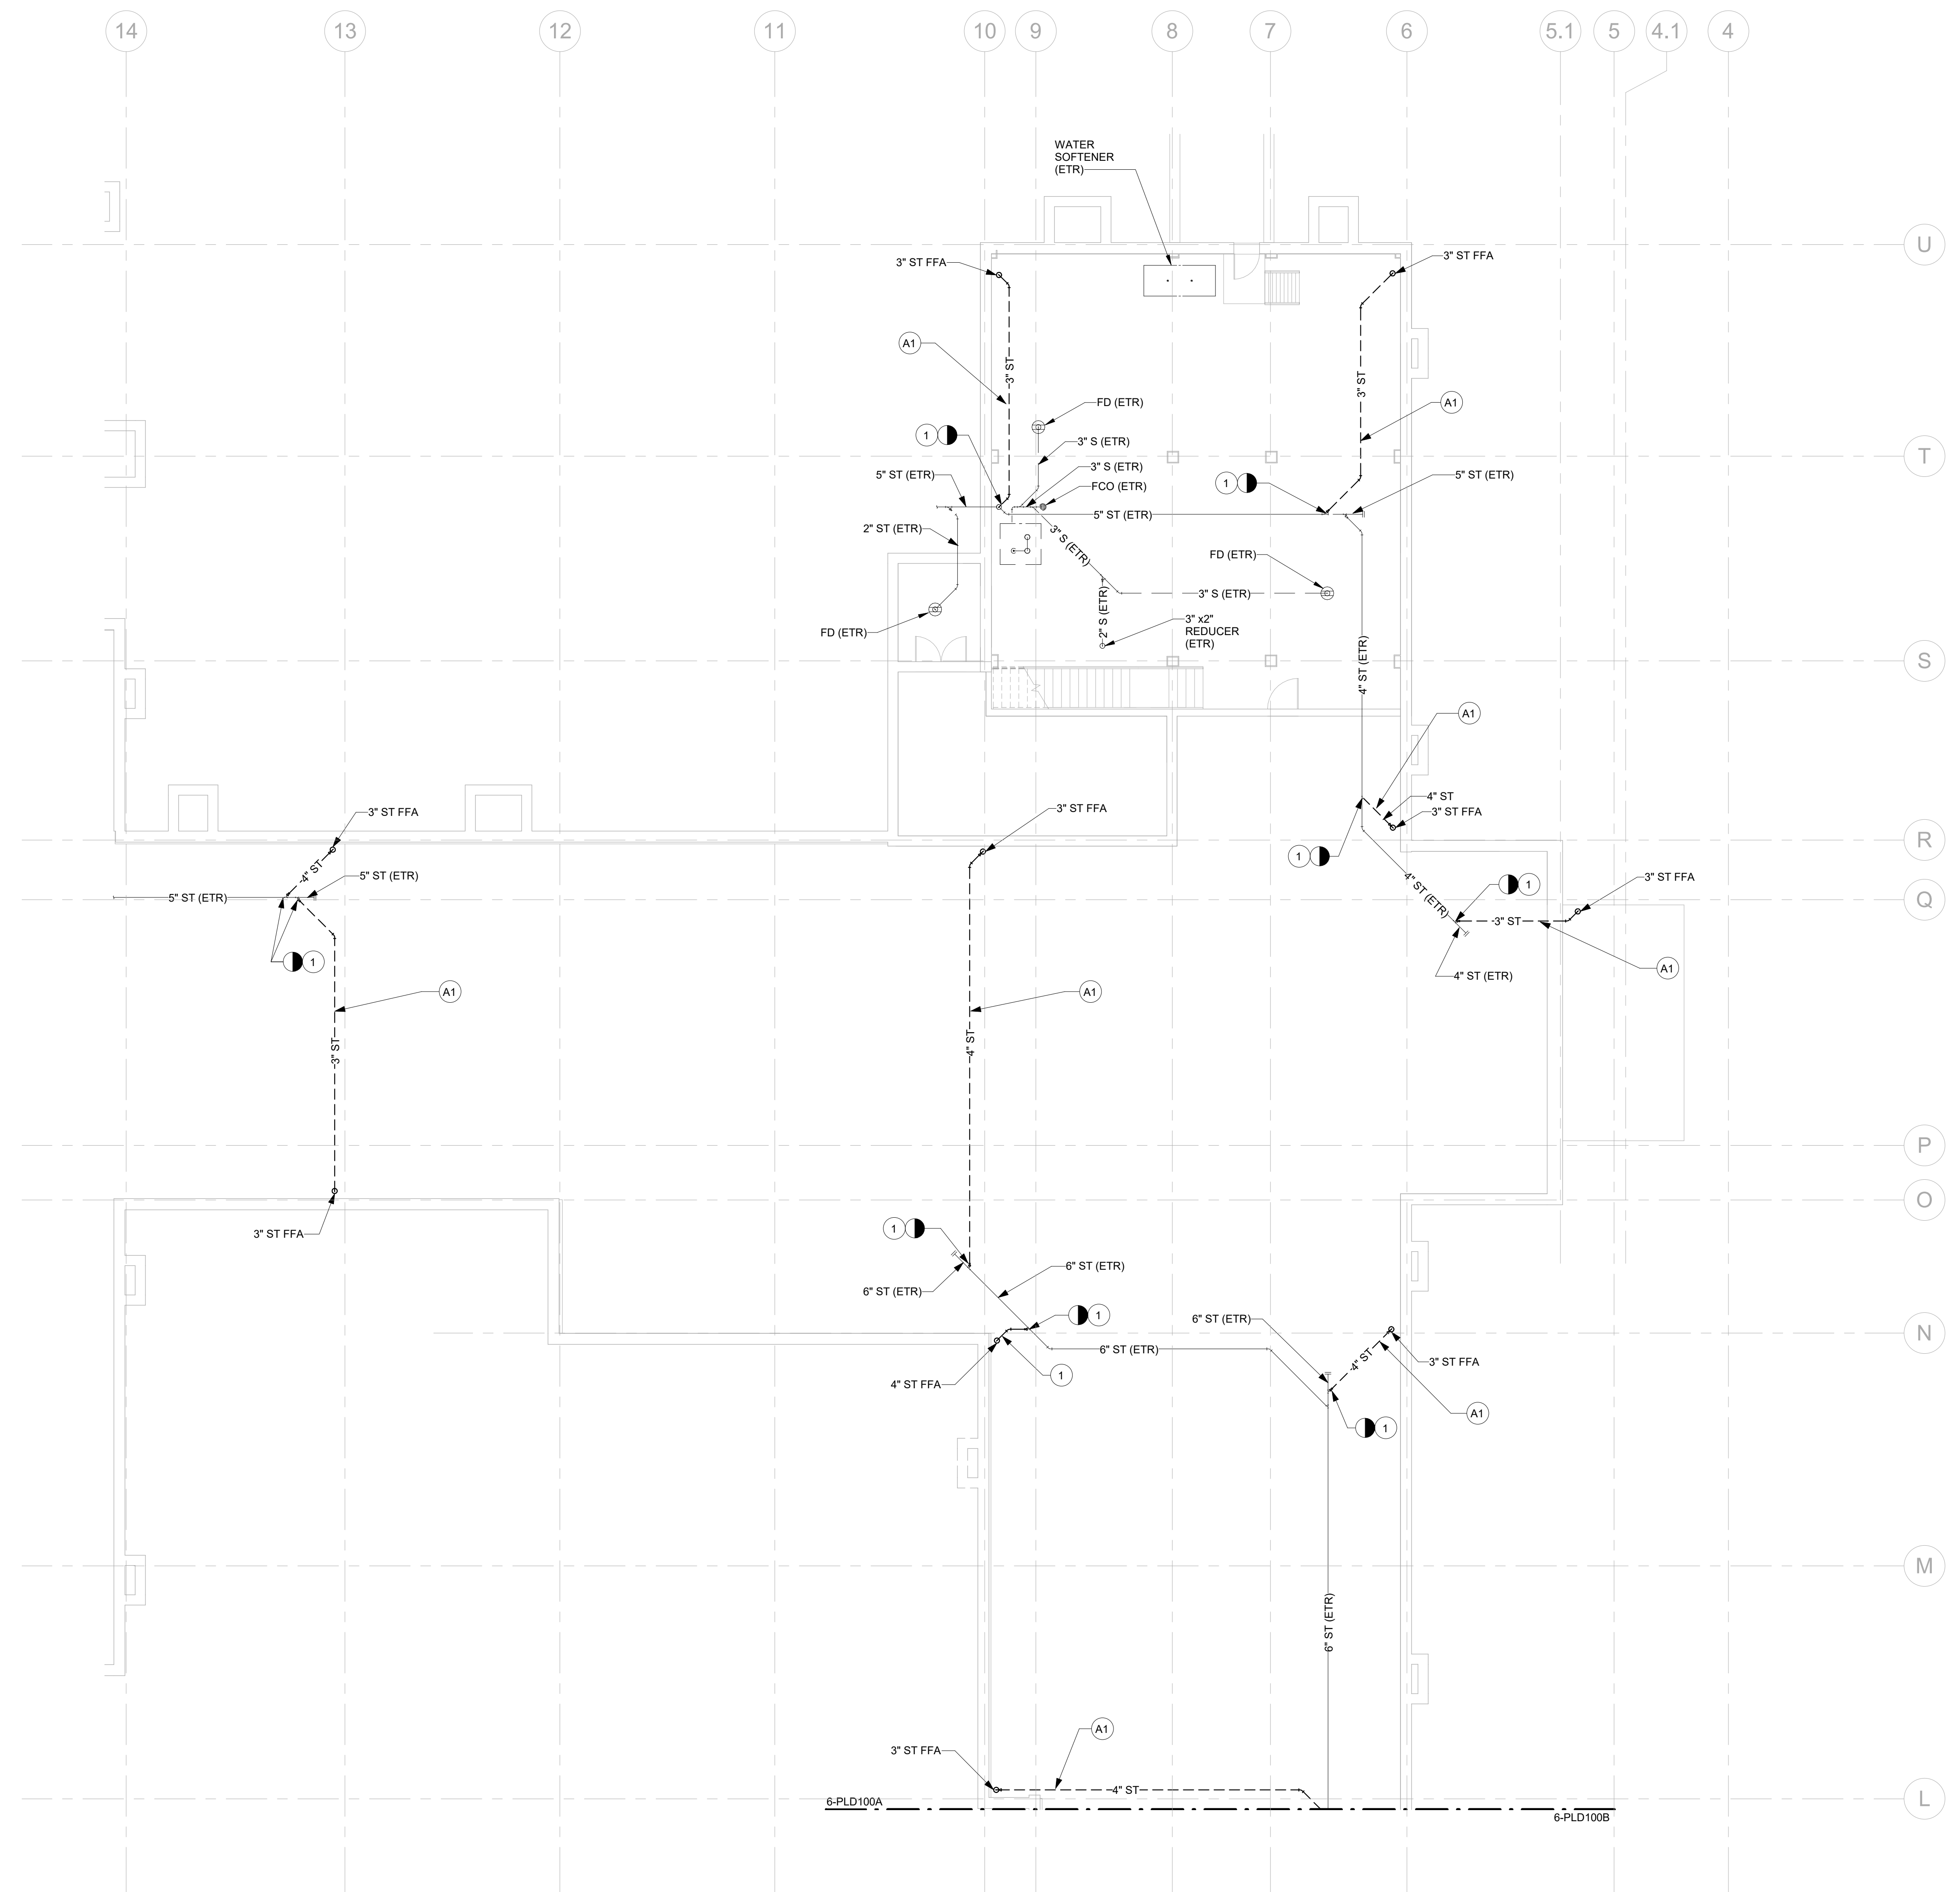

1 PLUMBING WASTE DEMO PLAN - BASEMENT WING A FLOOR PLAN
1/8" = 1'-0"

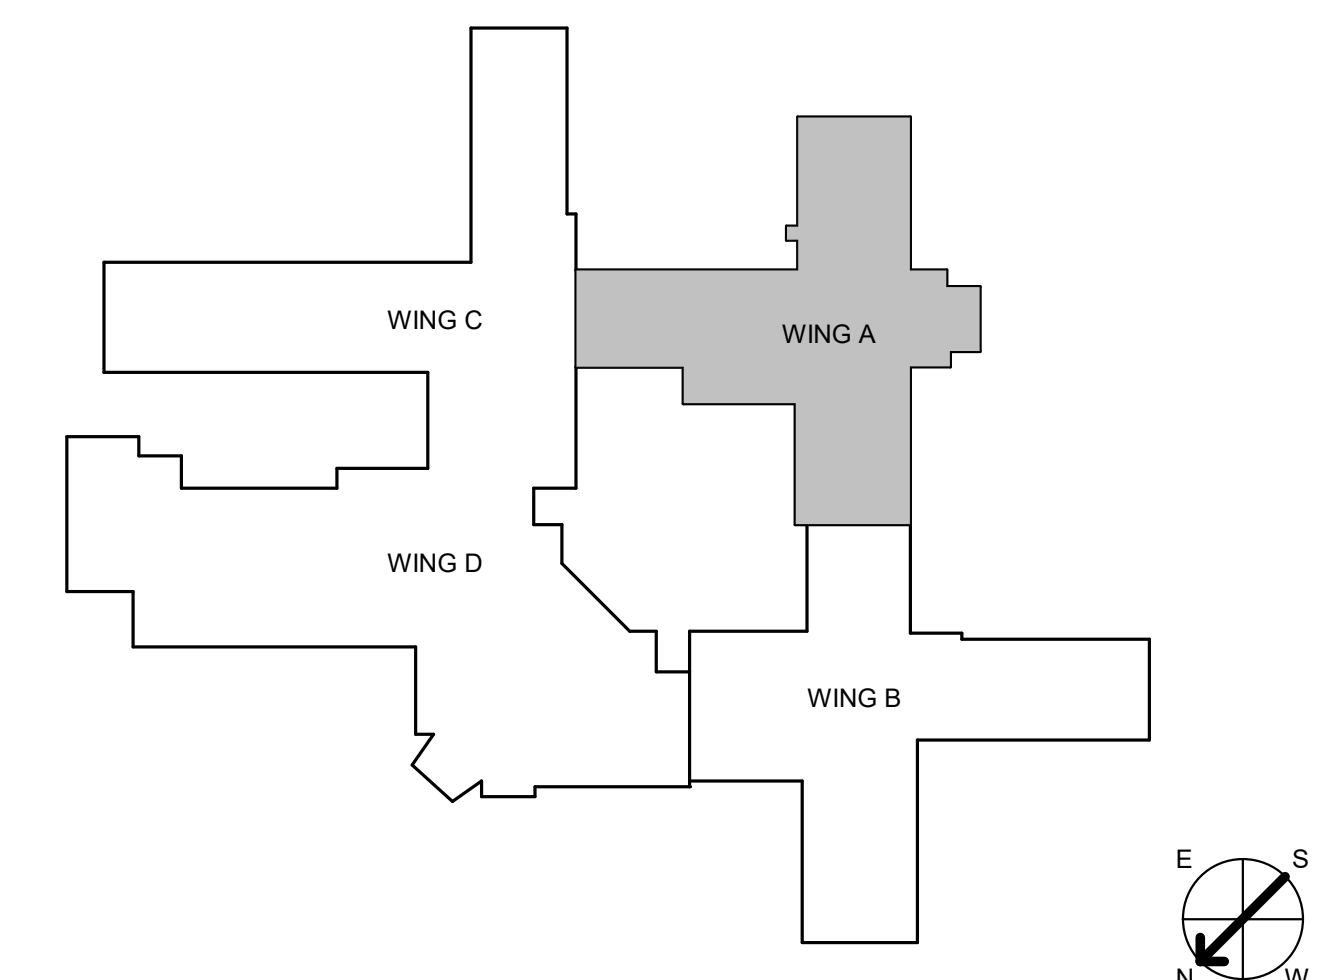

CONSULTANT INFORMATION

STRUCTURAL / CIVIL ENGINEER	MECHANICAL / ELECTRICAL / PLUMBING / TECHNICAL ENGINEER	FIRE PROTECTION ENGINEER
STAND STRUCTURAL ENGINEERING 11927 W. 112TH STREET, SUITE 200 OVERLAND PARK, KS 66210 (913) 214-2169	SPUR DESIGN 11020 KING STREET, SUITE 350 OVERLAND PARK, KS 66210 (405) 842-6100	POOLE FIRE PROTECTION, INC. 19910 W. 161ST STREET OLATH, KS 66062 (913) 829-8650


ARCHITECT

SPUR DESIGN

313 SW 23th Street
Overland Park, KS 66150
913-214-2169
spur-design.com

11020 King Street, Suite 350
Overland Park, KS 66210
405-842-6100
spur-design.com

KS ARCH REG. NO. A-1139, EXP. 12/31/2019
KS ENGR REG. NO. E-2586, EXP. 12/31/2019

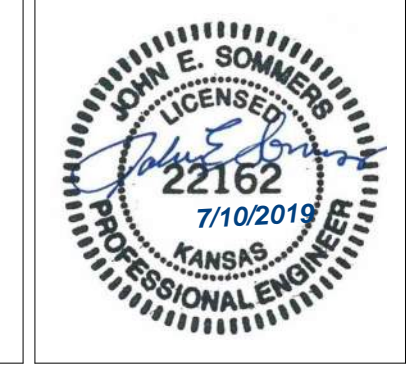

Office of Construction and Facilities Management

VA U.S. Department of Veteran Affairs

SHEET TITLE
PLUMBING WASTE DEMO PLAN - BASEMENT WING A FLOOR PLAN

APPROVED: PROJECT DIRECTOR

PROJECT PHASE
BID DOCUMENTS

FULLY SPRINKLERED

PROJECT TITLE
RENOVATE A & B WING BUILDING 6

PROJECT LOCATION
**2200 SW GAGE BLVD
TOPEKA, KS 66622**


DATE 07/10/2019	CHECKED BY JES	DRAWN BY RLC
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VA PROJECT NUMBER
589-A5-19-116

BUILDING NUMBER
6


DRAWING NUMBER
6-PLD100A

Dwg. 57 OF 160

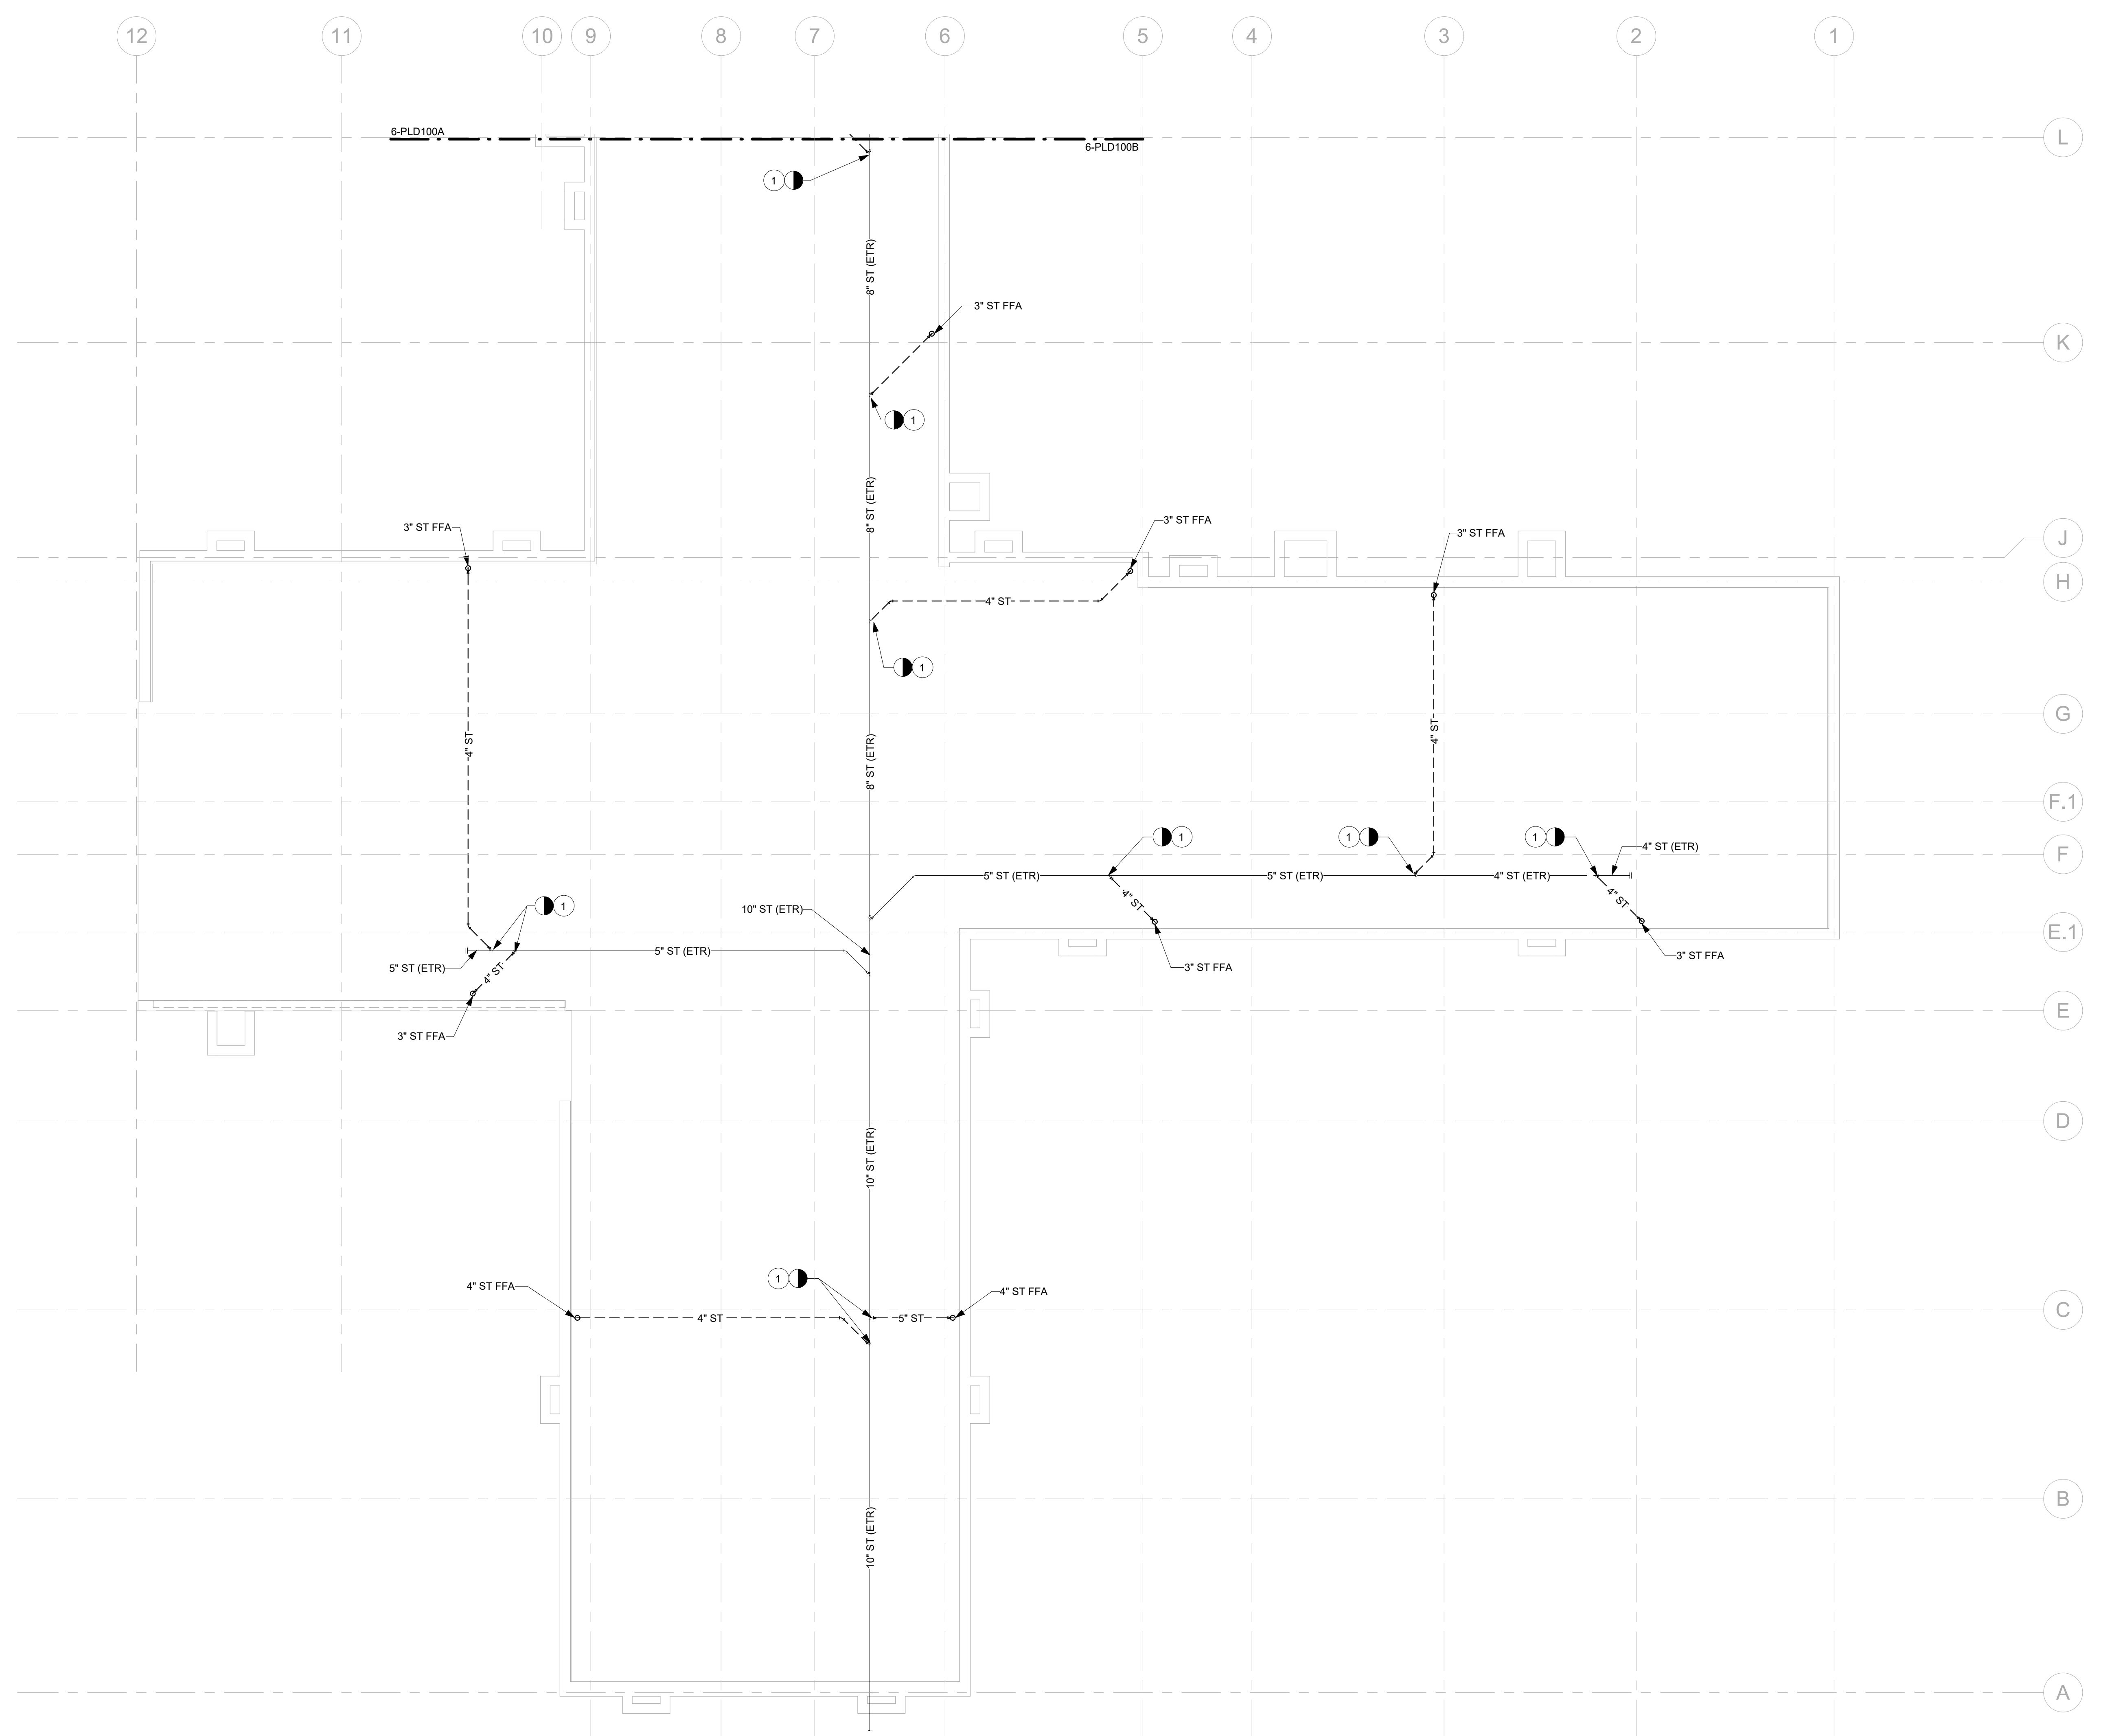


- GENERAL NOTES:**
1. THE AREA OF WORK SHOWN IS ASSOCIATED WITH AN OPERATING FACILITY THAT MUST REMAIN IN SERVICE 24/7.
 2. SEE SHEET 6I-001 FOR ADDITIONAL INFORMATION REGARDING SCHEDULE AND PHASING REQUIREMENTS. SCHEDULE WORK TO MINIMIZE DISRUPTION OF SERVICES.
 3. COORDINATE WORK SCHEDULE WITH THE CONTRACTING OFFICER'S REPRESENTATIVE (COR) BEFORE THE START OF WORK.
 4. COORDINATE PLUMBING WORK WITH OTHER TRADES AND CONTRACTORS. VERIFY ALL EXISTING CONDITIONS BEFORE THE START OF WORK.
 5. COORDINATE TEMPORARY ROOF DRAINAGE DURING CONSTRUCTION AND REPLACEMENT OF STORM PIPE.
 6. THE DEMOLITION DRAWINGS ARE DEEMED SCHEMATIC. CONTRACTOR RESPONSIBLE FOR FIELD VERIFYING EXISTING DEMOLITION WORK PRIOR TO SUBMISSION OF PROPOSAL.
 7. ALL PLUMBING FIXTURES SHOWN ON THIS SHEET ARE EXISTING TO BE DEMOLISHED UNLESS NOTED OTHERWISE.
- DEDUCT ALTERNATE & PHASING:**
- ALL PLAN WORK SHOWN ON THIS SHEET IS SUBJECT TO THE OVERALL PROJECT PHASING SEQUENCE OUTLINED ON ARCHITECTURAL SHEET 6-GI-102.
- IN ADDITION, IF THE DEDUCT ALTERNATE IS ELECTED, ALL PLAN WORK ON THIS SHEET IS ALSO SUBJECT TO THE REDUCED AREAS OF WORK AS DEFINED ON ARCHITECTURAL SHEET 6-GI-105.


- PLUMBING DEMO PLAN NOTES:**
- 1 DEMOLISH EXISTING STORM PIPING TO DEMARCATION POINT SHOWN.

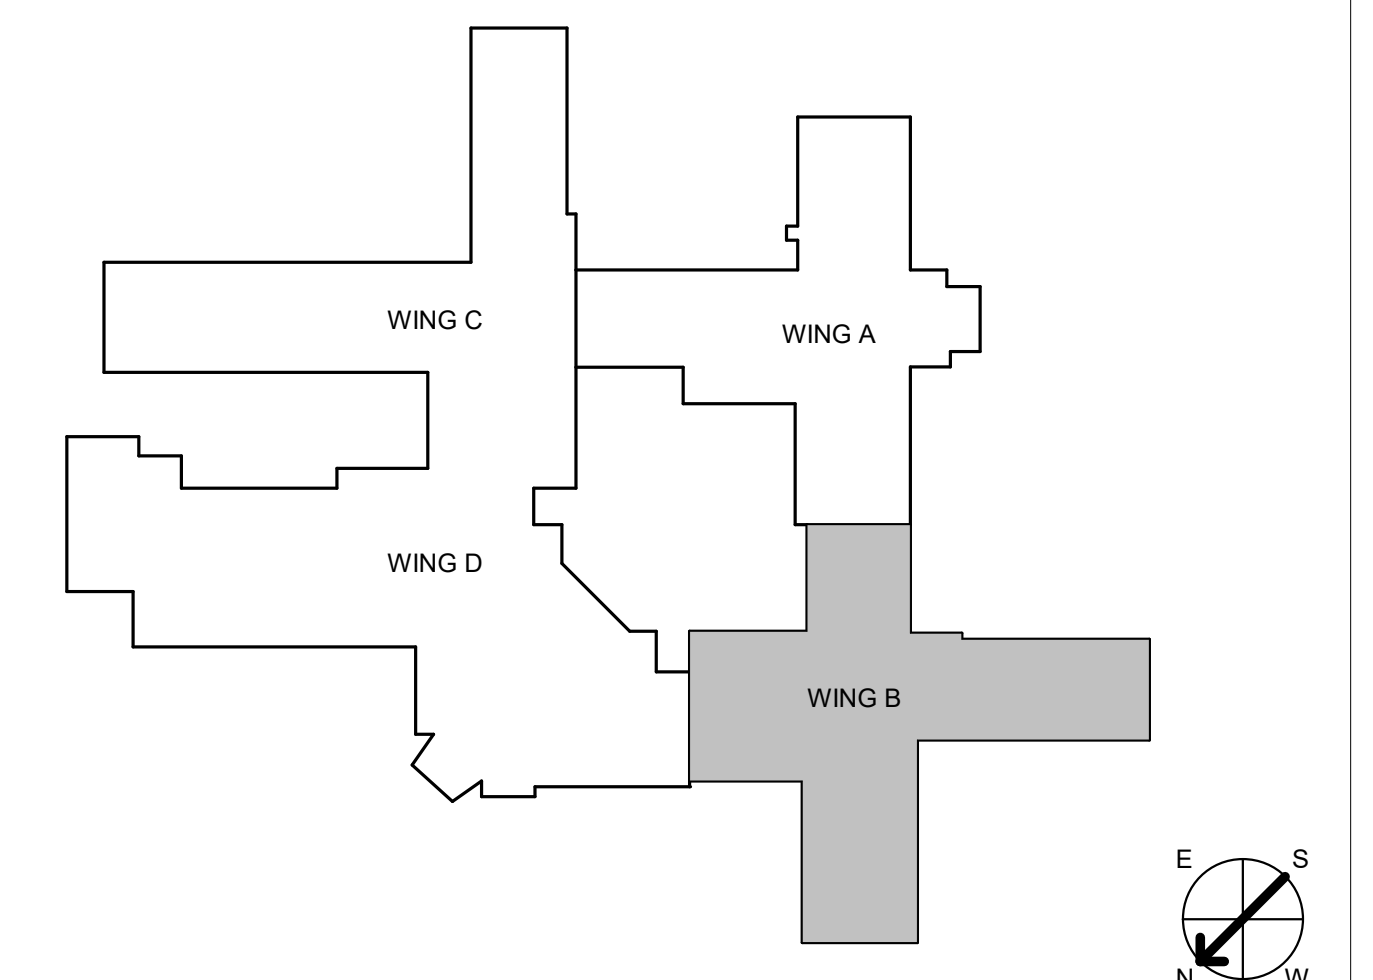

1 PLUMBING WASTE DEMO PLAN - BASEMENT WING B FLOOR PLAN
1/8" = 1'-0"

CONSULTANT INFORMATION STRUCTURAL / CIVIL ENGINEER STAND STRUCTURAL ENGINEERING 11627 W. 112TH STREET, SUITE 200 OVERLAND PARK, KS 66210 (913) 214-2169		MECHANICAL / ELECTRICAL / PLUMBING / TECHNICAL ENGINEER SPUR DESIGN 11020 KING STREET, SUITE 350 OVERLAND PARK, KS 66210 (405) 842-6100		FIRE PROTECTION ENGINEER POOLE FIRE PROTECTION, INC. 19910 W. 161ST STREET OLATH, KS 66062 (913) 829-8650		ARCHITECT  513 SW 23th Street Overland Park, KS 66159 spur-design.com 11020 King Street, Suite 300 Overland Park, KS 66159 913-842-6100 ks arch reg. no. A-1139, exp. 12/31/2019 ks engr reg. no. E-2586, exp. 12/31/2019		Office of Construction and Facilities Management VA U.S. Department of Veteran Affairs		SHEET TITLE PLUMBING WASTE DEMO PLAN - BASEMENT WING B FLOOR PLAN APPROVED: PROJECT DIRECTOR		PROJECT PHASE BID DOCUMENTS FULLY SPRINKLERED		PROJECT TITLE RENOVATE A & B WING BUILDING 6		VA PROJECT NUMBER 589-A5-19-116	
Revision #		Date		PROJECT LOCATION 2200 SW GAGE BLVD TOPEKA, KS 66622		BUILDING NUMBER 6		DRAWING NUMBER 6-PLD100B		DATE 07/10/2019		CHECKED BY JES		DRAWN BY RLC			
												Dwg. 58 OF 160					

three inches = one foot
 one and one-half inches = one foot
 one inch = one foot
 three-quarters inch = one foot
 one-half inch = one foot
 three-eighths inch = one foot
 one-quarter inch = one foot
 one-eighth inch = one foot

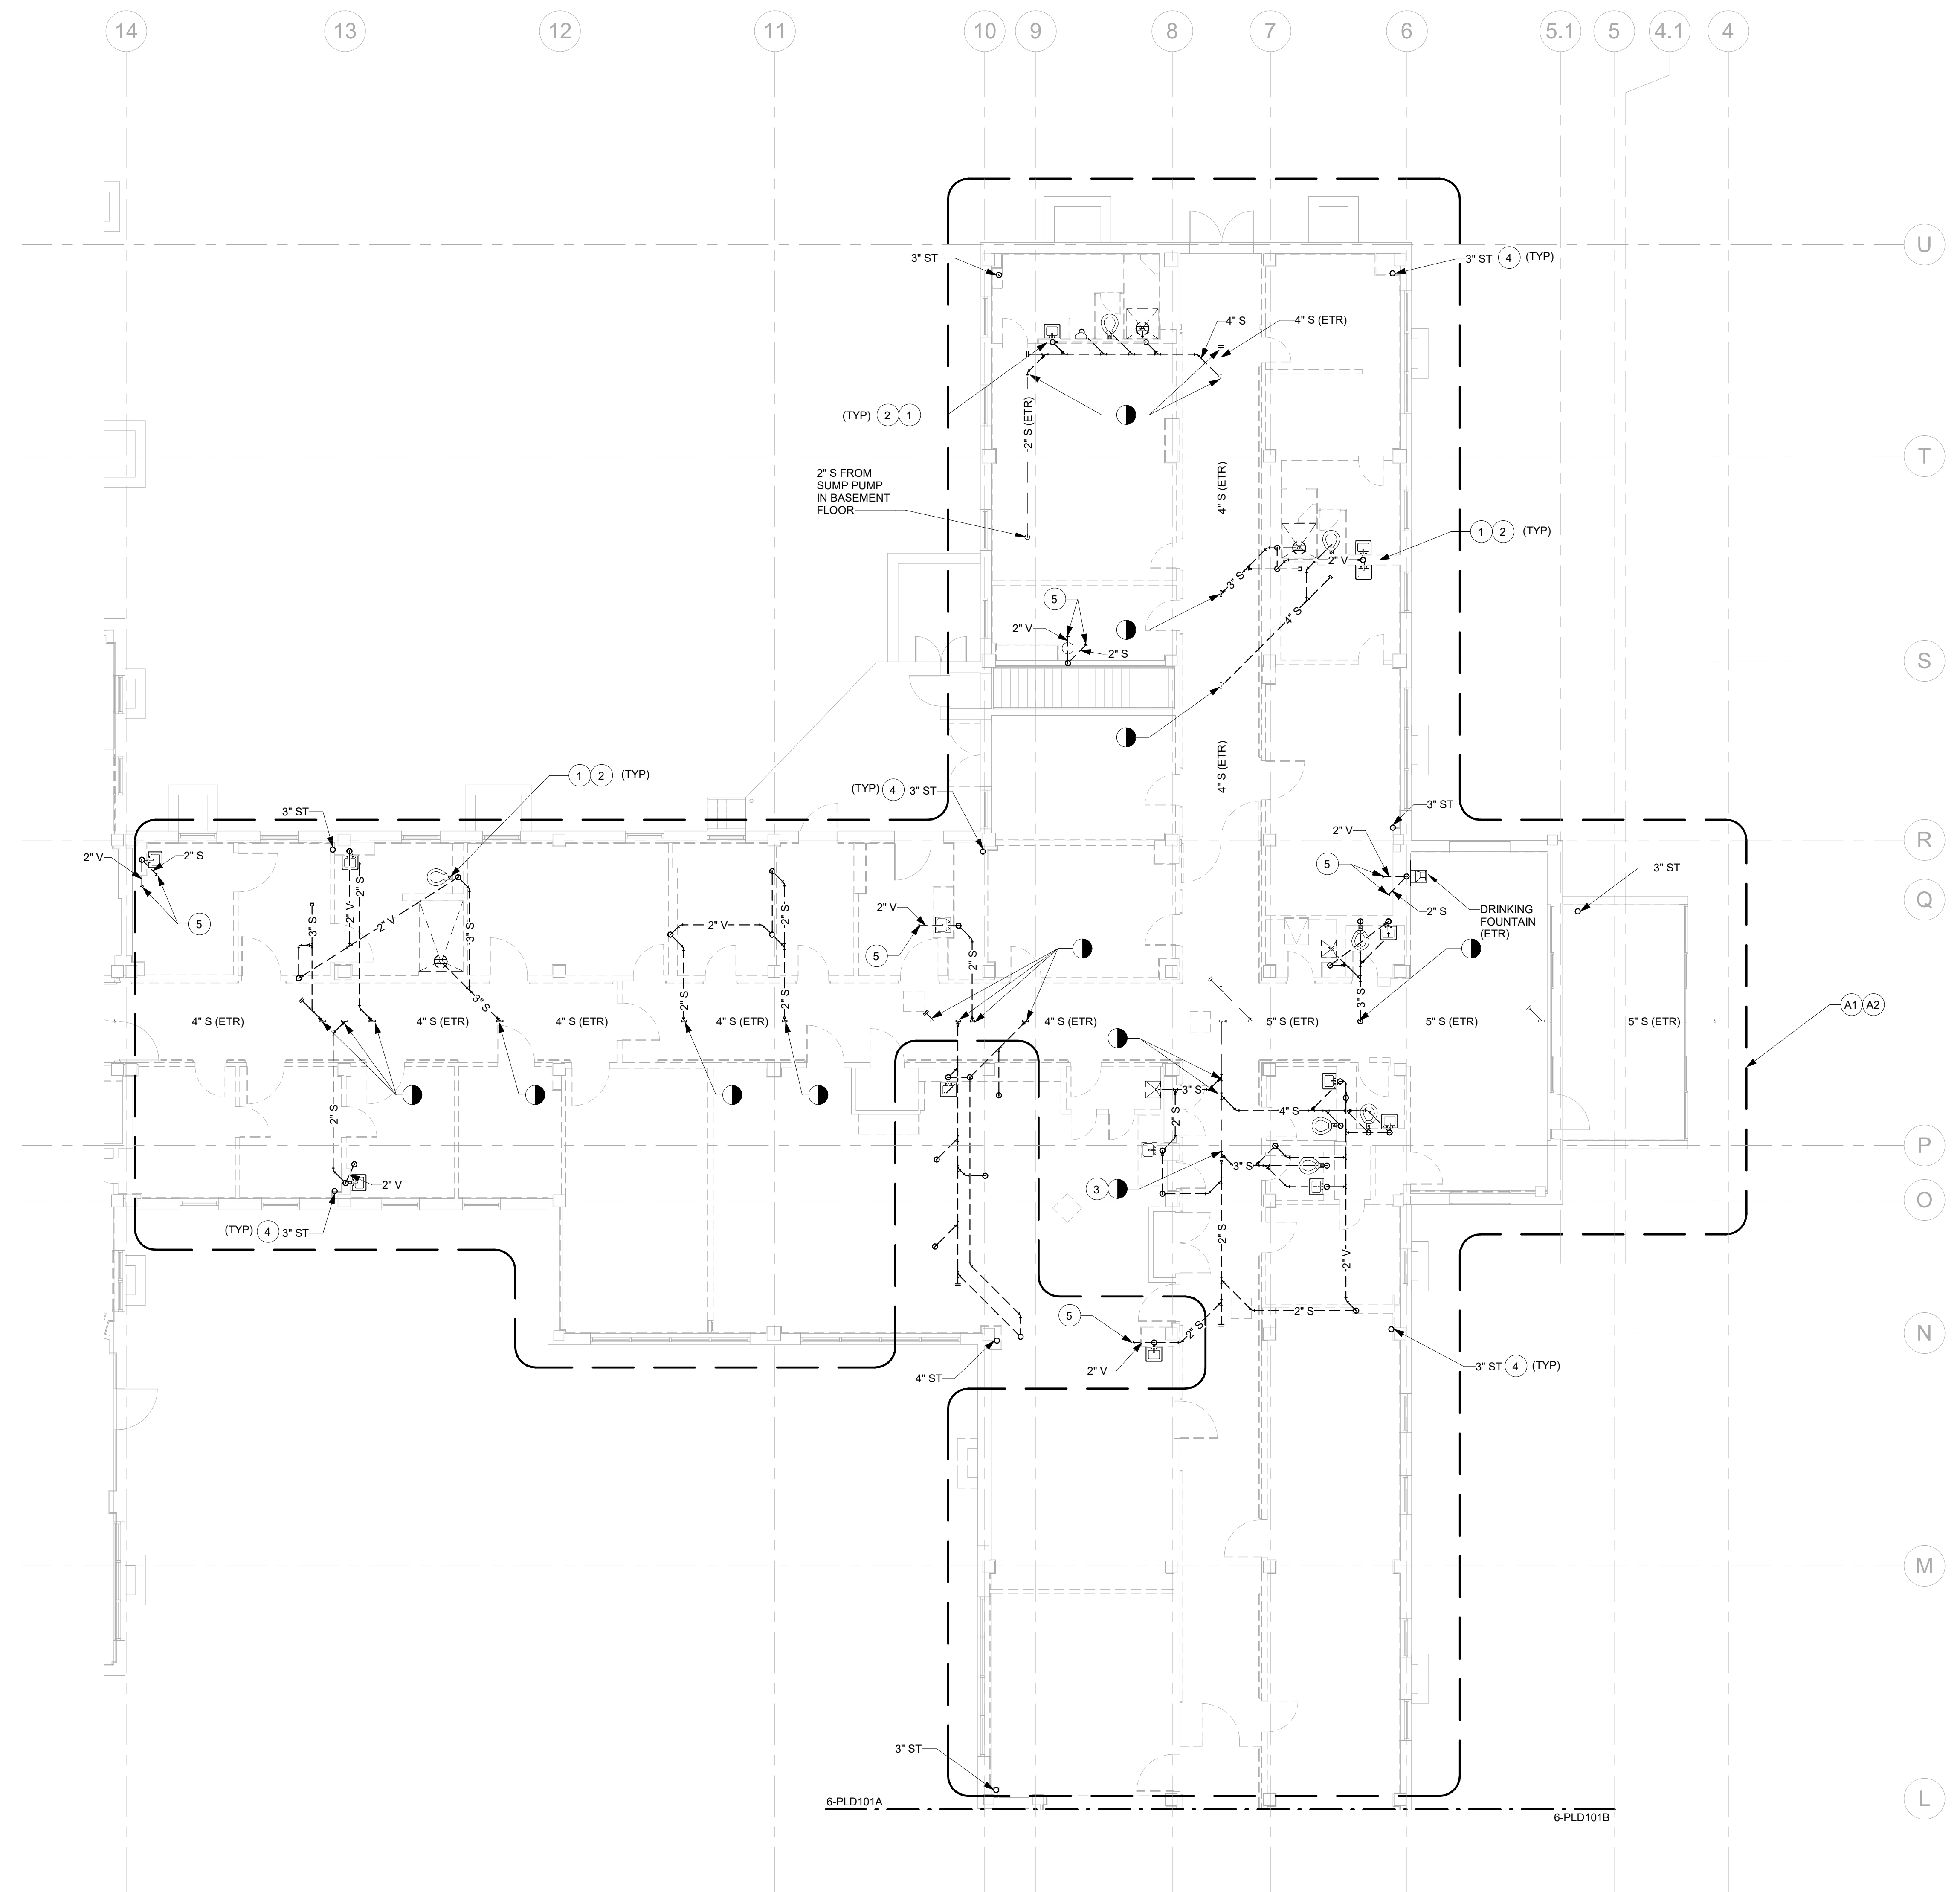

- GENERAL NOTES:**
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 7. ALL PLUMBING FIXTURES SHOWN ON THIS SHEET ARE EXISTING TO BE DEMOLISHED UNLESS NOTED OTHERWISE.


DEDUCT ALTERNATE & PHASING:

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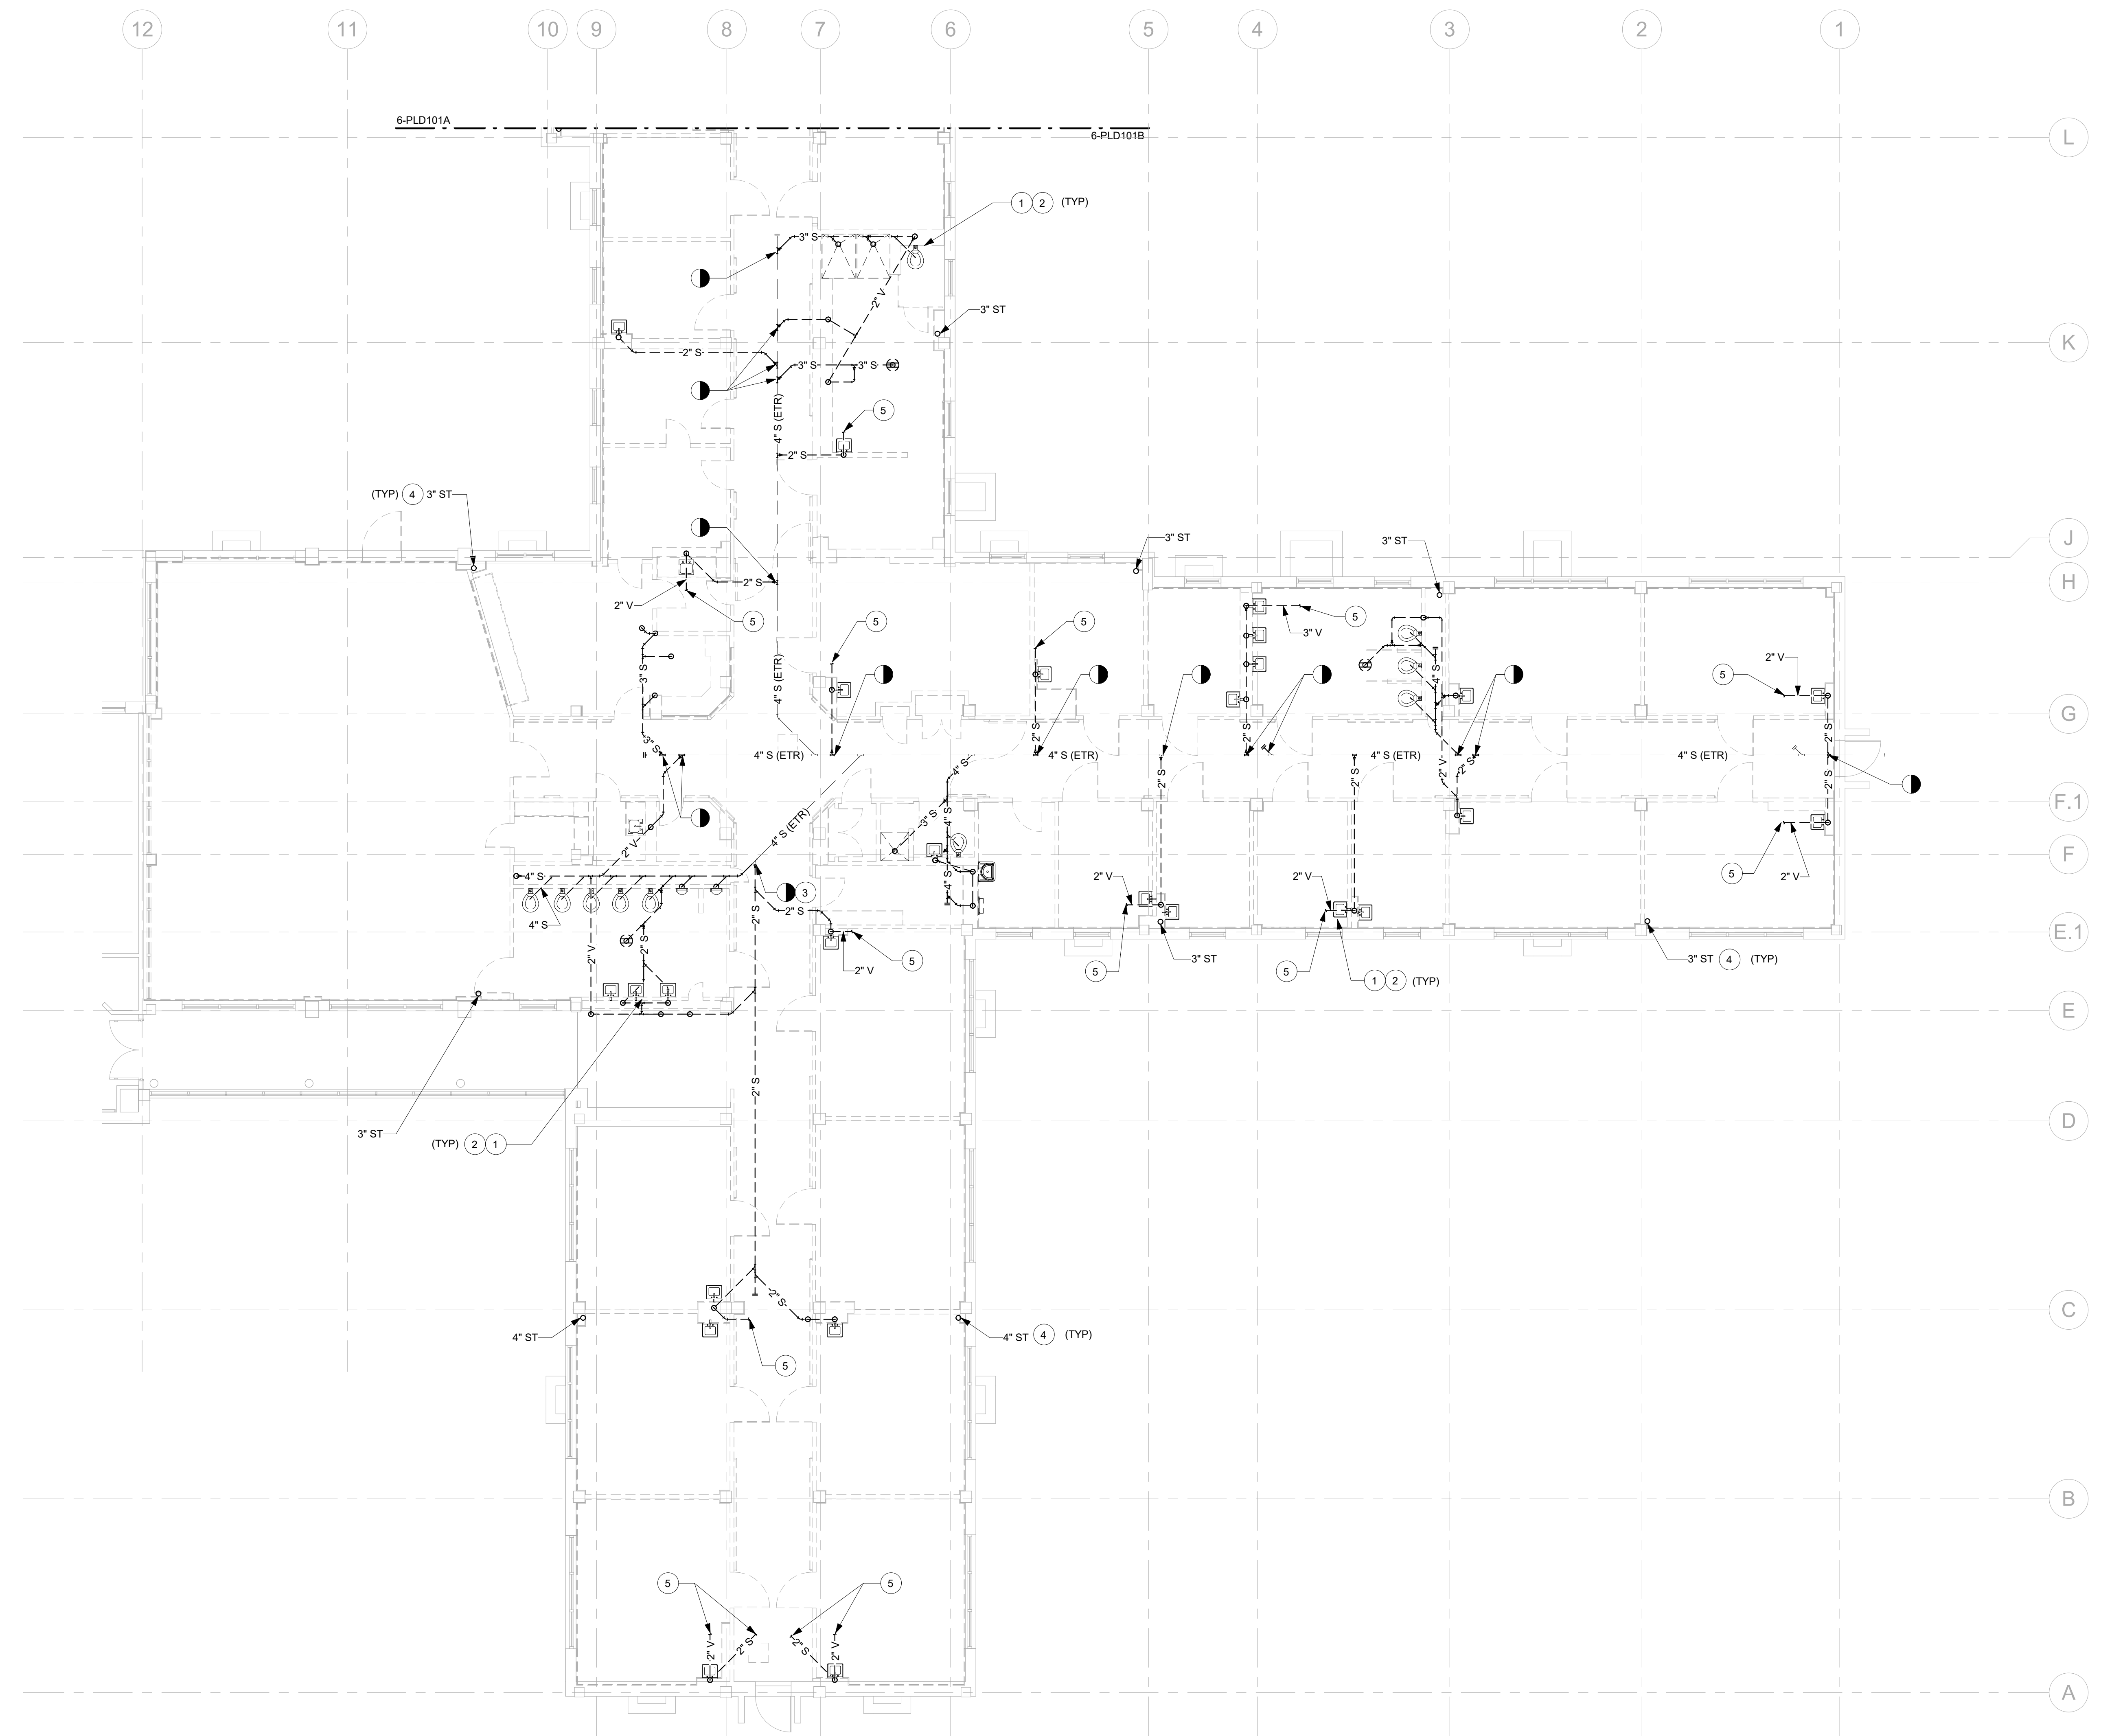
- PLUMBING DEMO PLAN NOTES:**
1. DEMOLISH EXISTING FIXTURES AND ASSOCIATED SANITARY WASTE PIPING BACK TO MAIN IN CRAWL SPACE. ALL PLUMBING FIXTURES SHOWN ON THIS SHEET ARE EXISTING TO BE DEMOLISHED UNLESS NOTED OTHERWISE.
 2. DEMOLISH EXISTING SANITARY VENT PIPING BACK TO VENT THROUGH ROOF (VTR). VTR TO REMAIN UNLESS NOTED OTHERWISE.
 3. DEMOLISH EXISTING SANITARY WASTE PIPING TO DEMARCATION POINT SHOWN.
 4. DEMOLISH EXISTING STORM PIPING FROM CONNECTION AT ROOF DRAIN TO MAIN IN CRAWL SPACE.
 5. CONTRACTOR TO FIELD VERIFY EXISTING CONDITIONS.

- DEDUCT ALTERNATE NOTES:**
- A1. IF DEDUCT ALTERNATE IS ACCEPTED, DO NOT DEMOLISH EXISTING STORM PIPING.
 - A2. IF DEDUCT ALTERNATE IS ACCEPTED, DO NOT DEMOLISH EXISTING PLUMBING FIXTURES AND ASSOCIATED SANITARY WASTE AND VENT PIPING.



1 PLUMBING WASTE DEMO PLAN - LEVEL 1 WING A FLOOR PLAN
 1/8" = 1'-0"

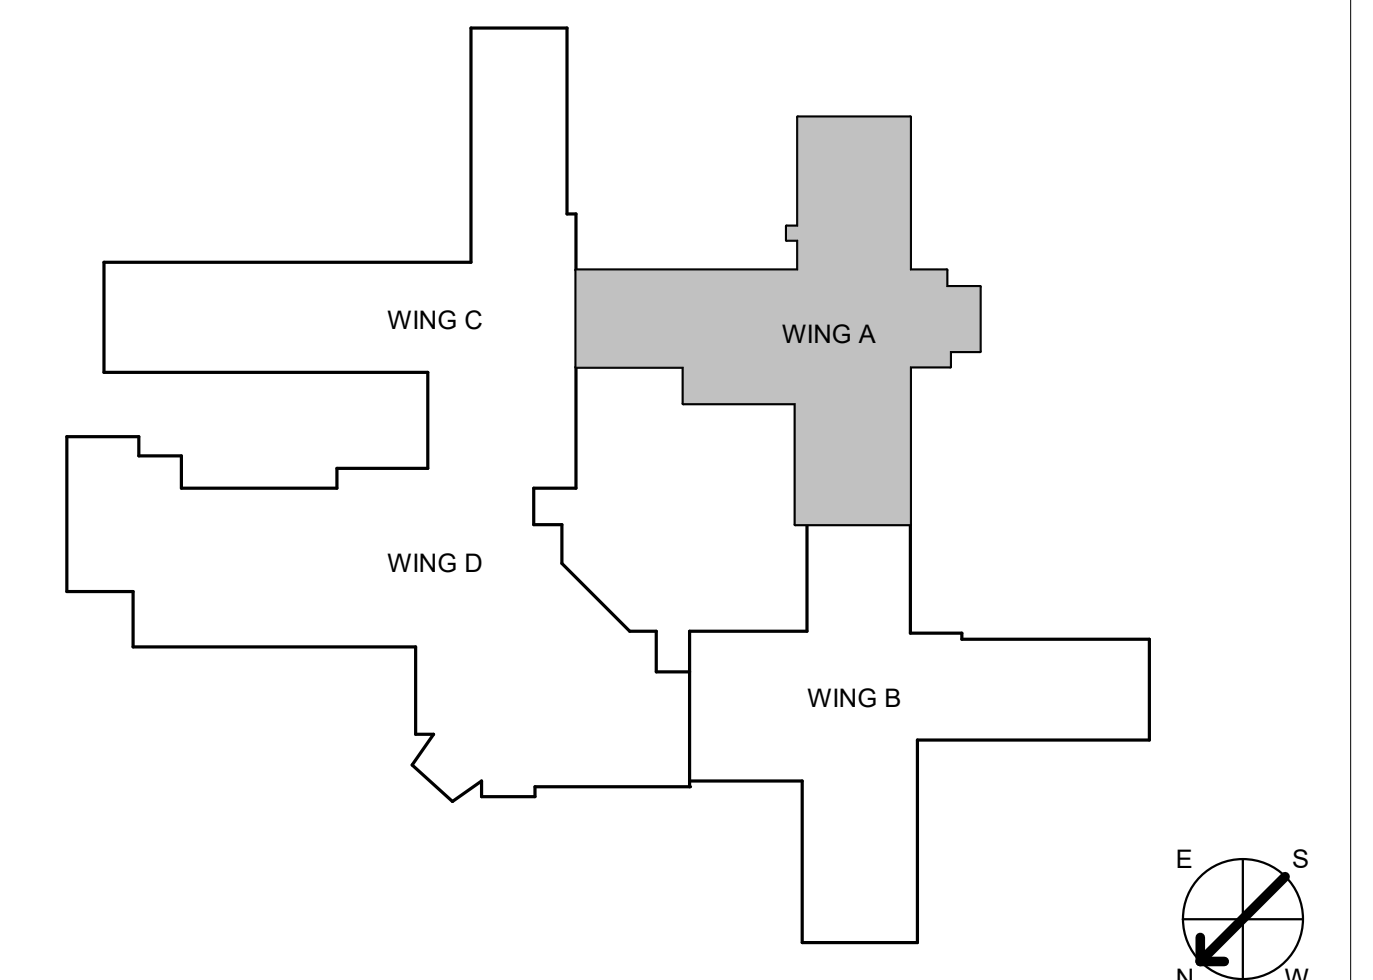CONSULTANT INFORMATION STRUCTURAL / CIVIL ENGINEER: STAND STRUCTURAL ENGINEERING, 11927 W. 112TH STREET, SUITE 200, OVERLAND PARK, KS 66210 (913) 214-2169 MECHANICAL / ELECTRICAL / PLUMBING / TECHNICAL ENGINEER: SPUR DESIGN, 11020 KING STREET, SUITE 350, OVERLAND PARK, KS 66210 (405) 842-6100 FIRE PROTECTION ENGINEER: POOLE FIRE PROTECTION, INC., 19910 W. 161ST STREET, OLATH, KS 66062 (913) 829-8650			ARCHITECT 513 SW 23th Street, Overland Park, KS 66150 11020 King Street, Suite 350, Overland Park, KS 66210 KS ARCH REG. NO. A-1139, EXP. 12/31/2019 KS ENGR REG. NO. E-2586, EXP. 12/31/2019		Office of Construction and Facilities Management VA U.S. Department of Veteran Affairs		SHEET TITLE: PLUMBING WASTE DEMO PLAN - LEVEL 1 WING A FLOOR PLAN APPROVED: PROJECT DIRECTOR		PROJECT PHASE: BID DOCUMENTS FULLY SPRINKLERED		PROJECT TITLE: RENOVATE A & B WING BUILDING 6 PROJECT LOCATION: 2200 SW GAGE BLVD, TOPEKA, KS 66622 DATE: 07/10/2019 CHECKED BY: JES DRAWN BY: RLC		VA PROJECT NUMBER: 589-A5-19-116 BUILDING NUMBER: 6 DRAWING NUMBER: 6-PLD101A Dwg. 59 OF 160	
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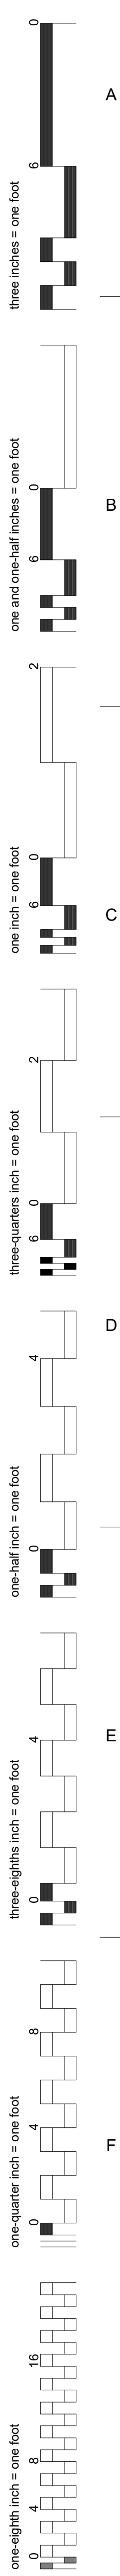
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DEDUCT ALTERNATE & PHASING:


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IN ADDITION, IF THE DEDUCT ALTERNATE IS ELECTED, ALL PLAN WORK ON THIS SHEET IS ALSO SUBJECT TO THE REDUCED AREAS OF WORK AS DEFINED ON ARCHITECTURAL SHEET 6-GI-105.

- PLUMBING DEMO PLAN NOTES:**
1. DEMOLISH EXISTING FIXTURES AND ASSOCIATED SANITARY WASTE PIPING BACK TO MAIN IN CRAWL SPACE. ALL PLUMBING FIXTURES SHOWN ON THIS SHEET ARE EXISTING TO BE DEMOLISHED UNLESS NOTED OTHERWISE.
 2. DEMOLISH EXISTING SANITARY VENT PIPING BACK TO VENT THROUGH ROOF (VTR). VTR TO REMAIN UNLESS NOTED OTHERWISE.
 3. DEMOLISH EXISTING SANITARY WASTE PIPING TO DEMARCATION POINT SHOWN.
 4. DEMOLISH EXISTING STORM PIPING FROM CONNECTION AT ROOF DRAIN TO MAIN IN CRAWL SPACE.
 5. CONTRACTOR TO FIELD VERIFY EXISTING CONDITIONS.



1 PLUMBING WASTE DEMO PLAN - LEVEL 1 WING B FLOOR PLAN
1/8" = 1'-0"

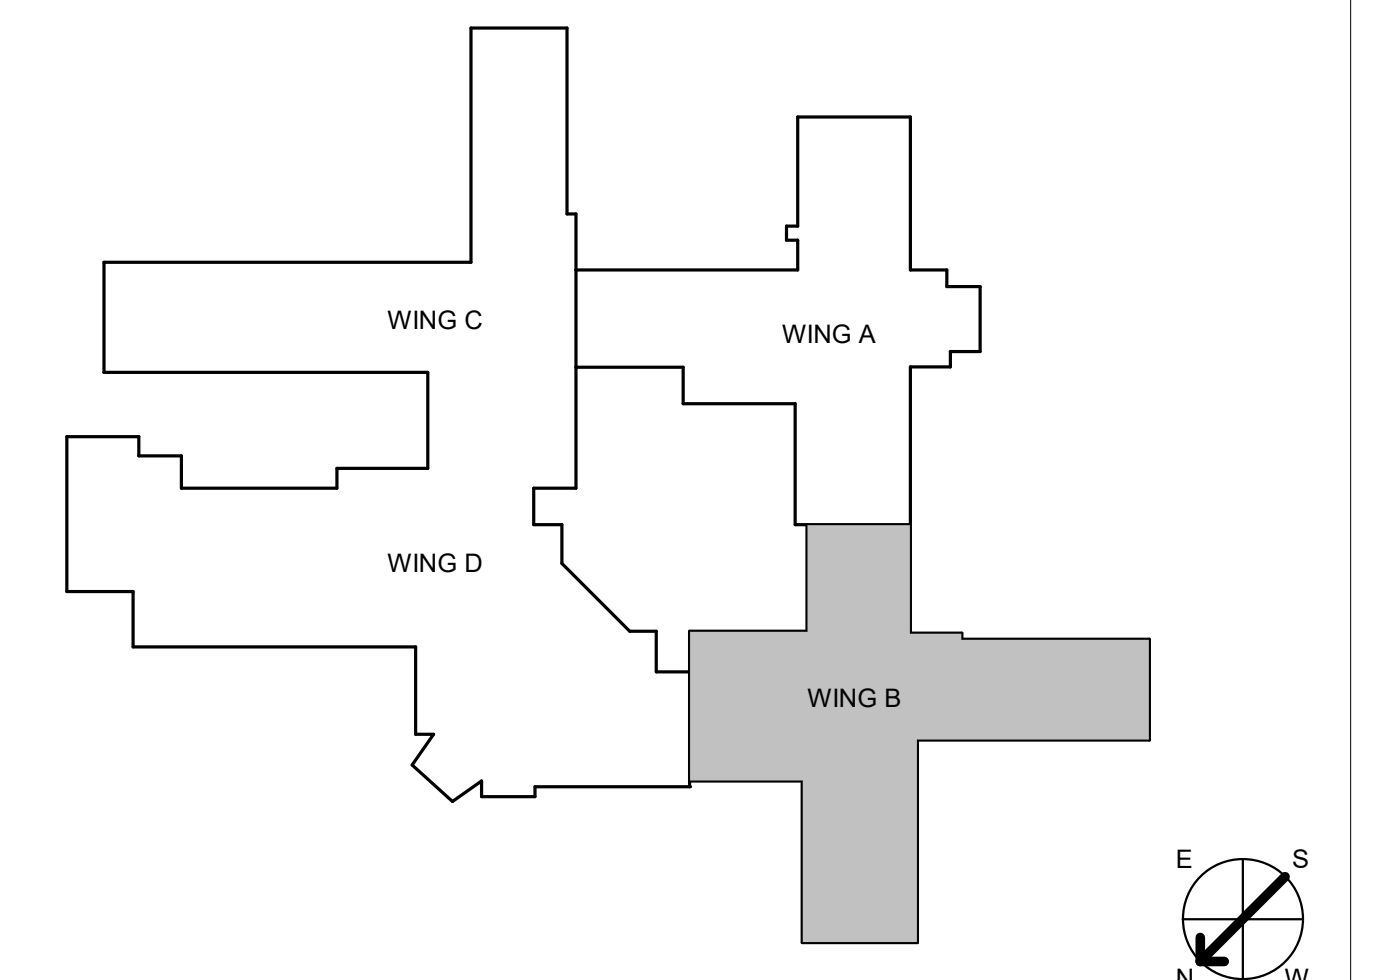

CONSULTANT INFORMATION STRUCTURAL / CIVIL ENGINEER: STAND STRUCTURAL ENGINEERING, 11227 W. 112TH STREET, SUITE 200, OVERLAND PARK, KS 66210 (913) 214-2169 MECHANICAL / ELECTRICAL / PLUMBING / TECHNICAL ENGINEER: SPUR DESIGN, 11020 KING STREET, SUITE 350, OVERLAND PARK, KS 66210 (405) 842-6100 FIRE PROTECTION ENGINEER: POOLE FIRE PROTECTION, INC., 19910 W. 161ST STREET, OLATH, KS 66062 (913) 829-8650			ARCHITECT 333 SW 23th Street, Overland Park, KS 66209 10202 King Street, Suite 300, Overland Park, KS 66209 KS ARCH REG. NO. A-1139, EXP. 12/31/2019 KS ENGR REG. NO. E-2586, EXP. 12/31/2019		Office of Construction and Facilities Management VA U.S. Department of Veteran Affairs		SHEET TITLE: PLUMBING WASTE DEMO PLAN - LEVEL 1 WING B FLOOR PLAN APPROVED: PROJECT DIRECTOR		PROJECT PHASE: BID DOCUMENTS FULLY SPRINKLERED		PROJECT TITLE: RENOVATE A & B WING BUILDING 6 PROJECT LOCATION: 2200 SW GAGE BLVD, TOPEKA, KS 66622 DATE: 07/10/2019 CHECKED BY: JES DRAWN BY: RLC		VA PROJECT NUMBER: 589-A5-19-116 BUILDING NUMBER: 6 DRAWING NUMBER: 6-PLD101B Dwg. 60 OF 160	
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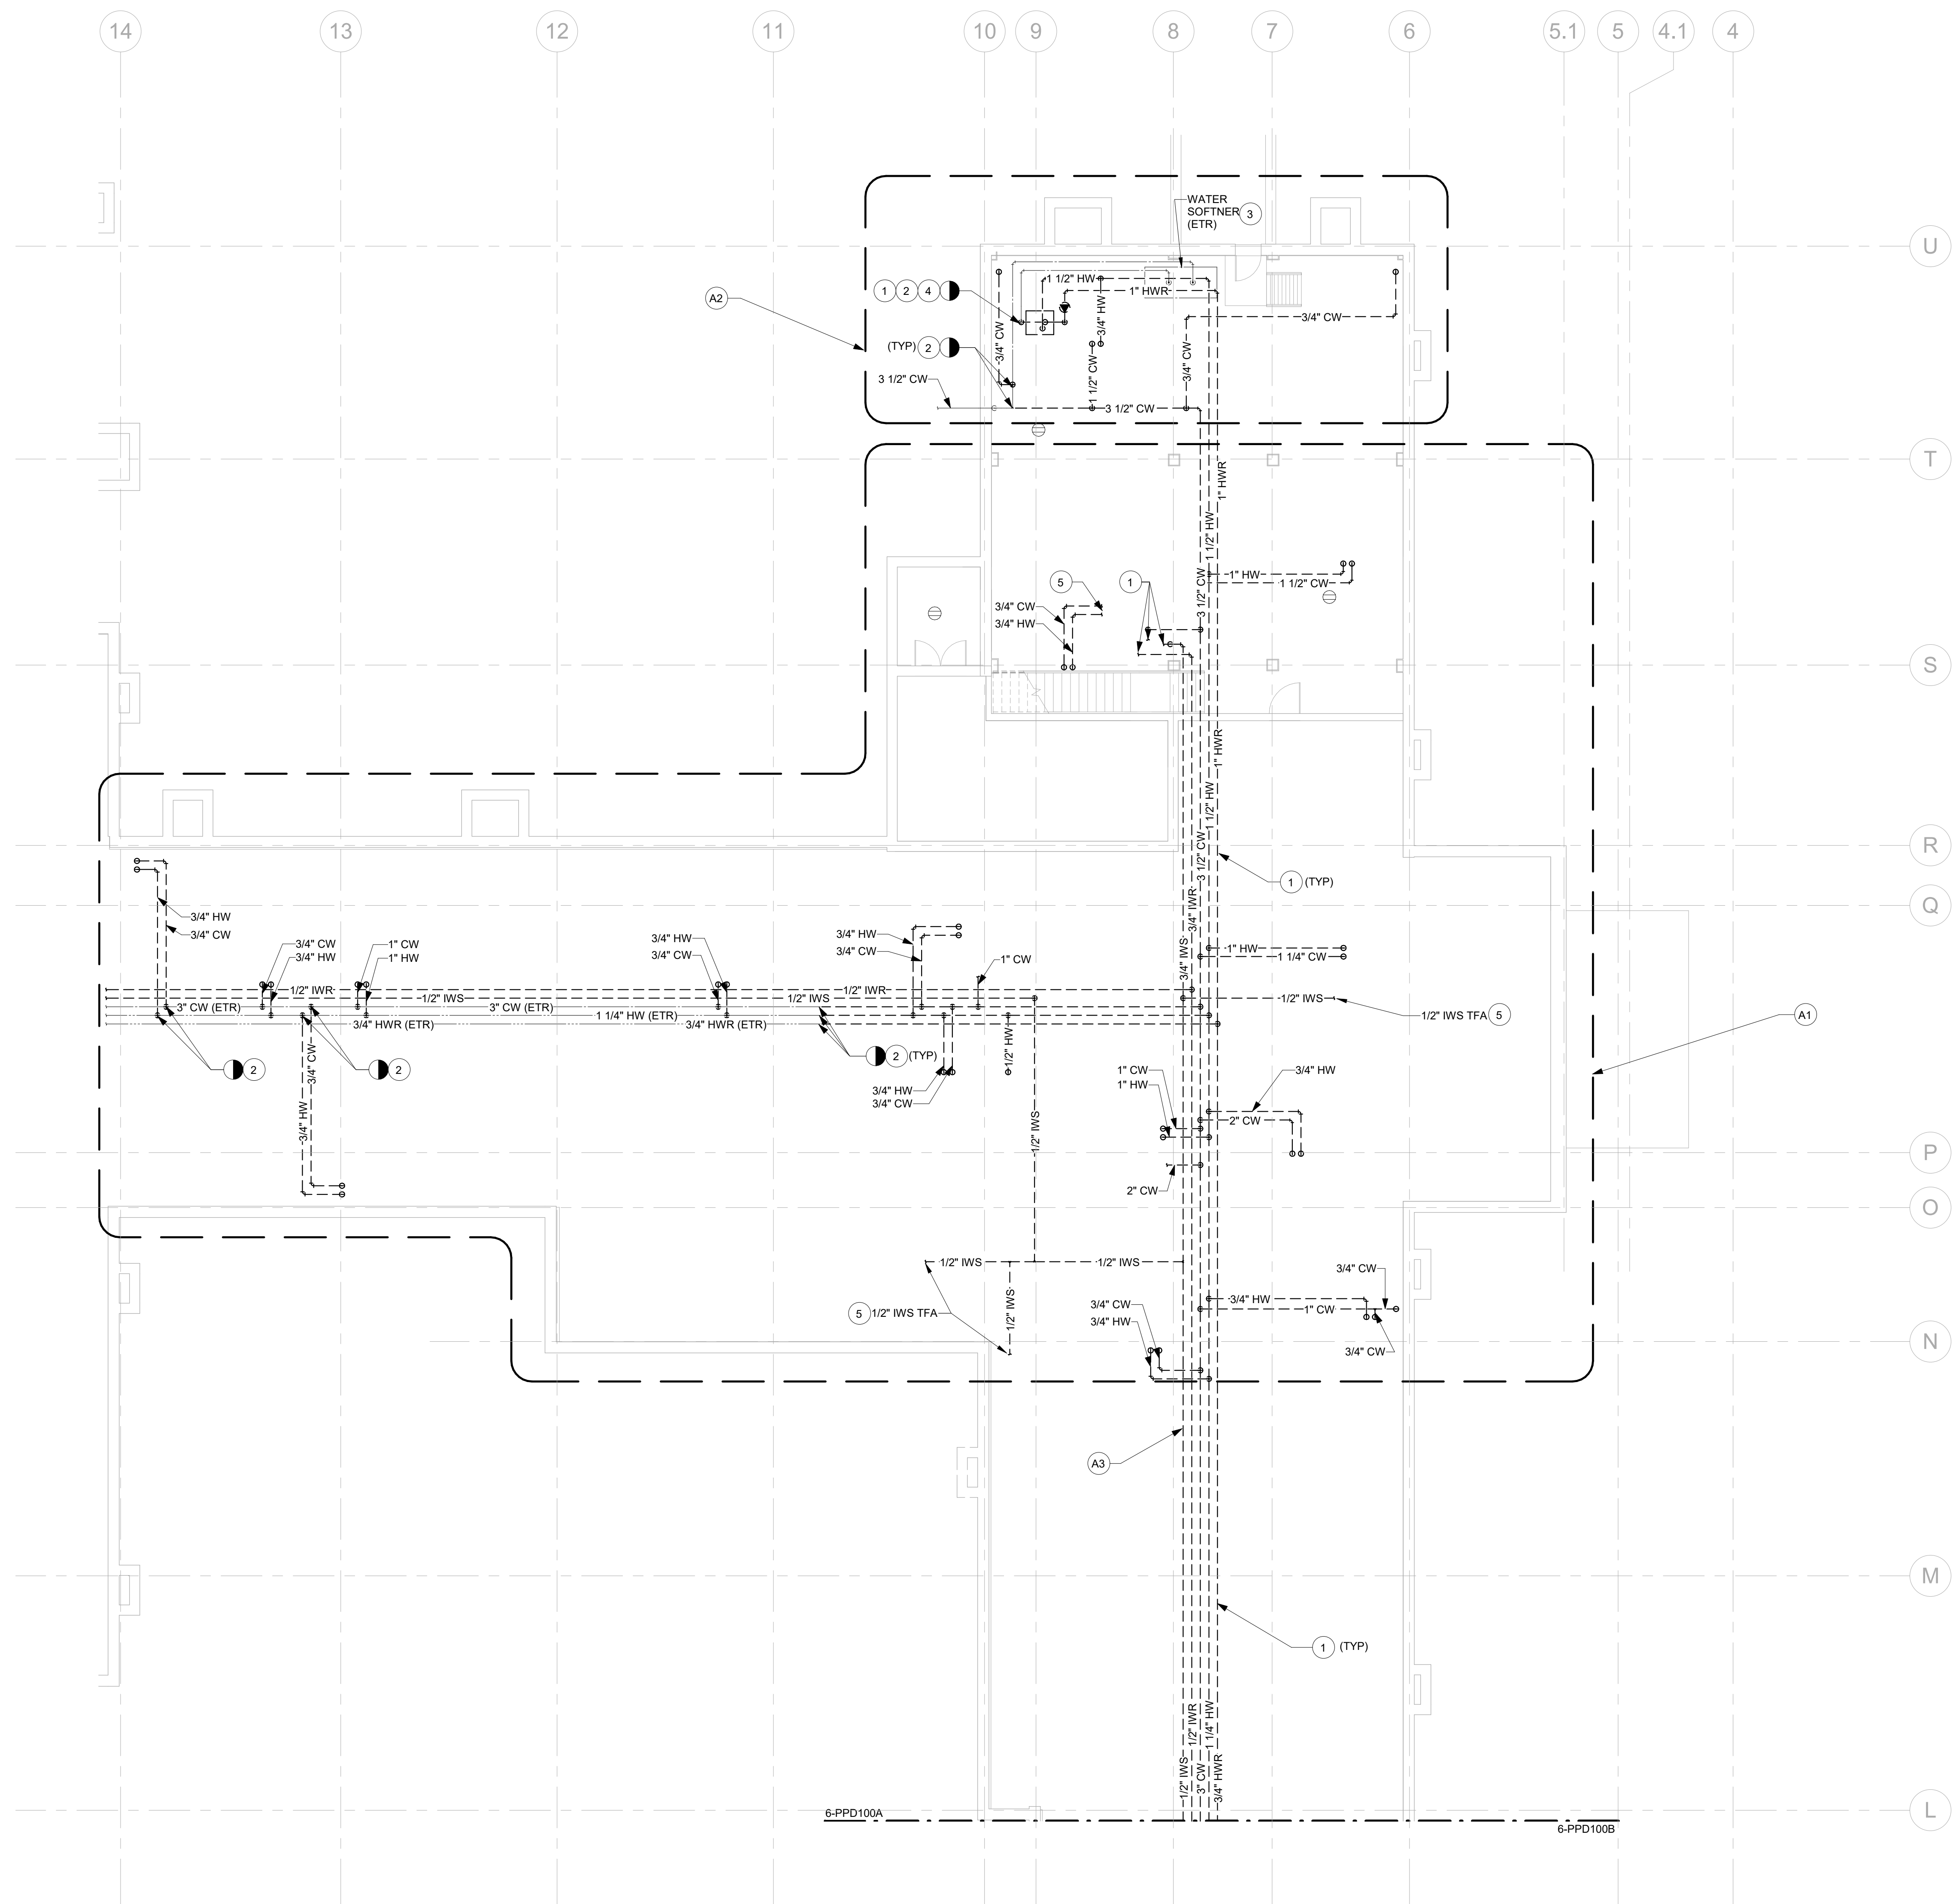
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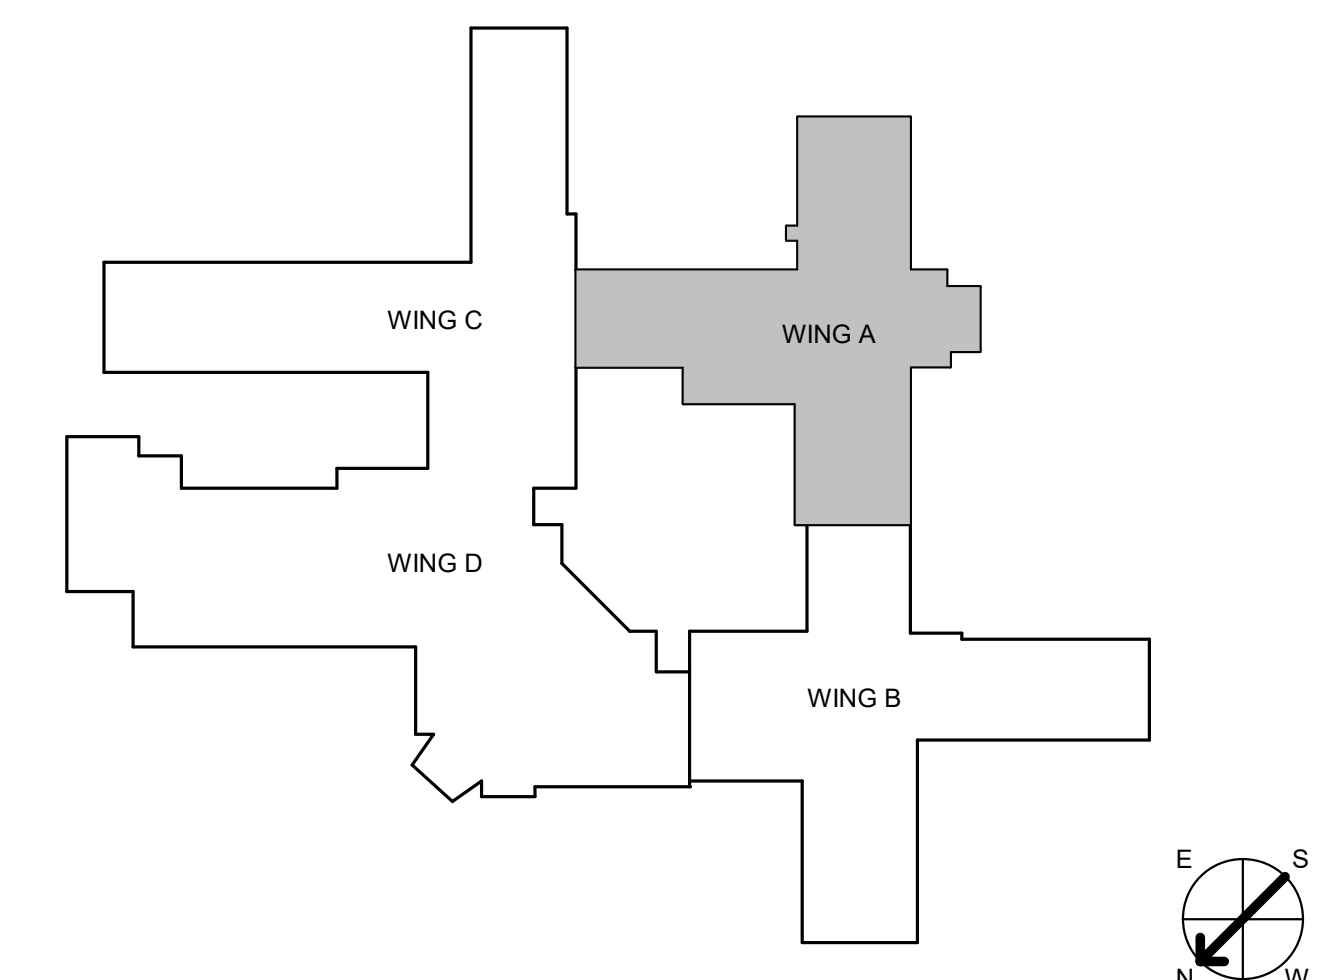
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- PLUMBING DEMO PLAN NOTES:**
1. DEMOLISH EXISTING DOMESTIC WATER PIPING AND ASSOCIATED ACCESSORIES.
 2. DEMOLISH EXISTING DOMESTIC WATER PIPING BACK TO DEMARCATION POINT SHOWN.
 3. WATER SOFTENER SHOWN IS EXISTING TO REMAIN (ETR).
 4. DEMOLISH EXISTING DOMESTIC WATER HEATER AND ASSOCIATED ACCESSORIES.
 5. CONTRACTOR TO FIELD VERIFY EXISTING CONDITIONS.


- DEDUCT ALTERNATE NOTES:**
- A1. IF DEDUCT ALTERNATE IS ACCEPTED, DO NOT DEMOLISH EXISTING DOMESTIC WATER PIPING.
 - A2. BID DEDUCT ALTERNATE # 1: IF DEDUCT ALTERNATE IS CHOSEN, DISCONNECT EXISTING BRANCH PIPING AS REQUIRED FOR NEW WORK. RECONNECT EXISTING BRANCH PIPING AFTER INSTALLATION OF NEW WATER MAINS. SEE 6-PP-100A FOR RELATED WORK.
 - A3. BID DEDUCT ALTERNATE # 1: IF DEDUCT ALTERNATE IS CHOSEN, DEMOLISH EXISTING DOMESTIC WATER PIPING AFTER THE LAST FIXTURE SERVED IN WING A.



1 PLUMBING SUPPLY DEMO PLAN - BASEMENT WING A FLOOR PLAN
1/8" = 1'-0"




CONSULTANT INFORMATION STRUCTURAL / CIVIL ENGINEER: STAND STRUCTURAL ENGINEERING, 11627 W. 112TH STREET, SUITE 200, OVERLAND PARK, KS 66210 (913) 214-2169 MECHANICAL / ELECTRICAL / PLUMBING / TECHNICAL ENGINEER: SPUR DESIGN, 11020 KING STREET, SUITE 350, OVERLAND PARK, KS 66210 (405) 842-6100 FIRE PROTECTION ENGINEER: POOLE FIRE PROTECTION, INC., 19910 W. 161ST STREET, OLATH, KS 66062 (913) 829-8650			ARCHITECT 513 5th Street, Overland Park, KS 66209 11020 King Street, Suite 300, Overland Park, KS 66209 KS ARCH REG. NO. A-1139, EXP. 12/31/2019 KS ENGR REG. NO. E-2586, EXP. 12/31/2019		Office of Construction and Facilities Management VA U.S. Department of Veteran Affairs SHEET TITLE: PLUMBING SUPPLY DEMO PLAN - BASEMENT WING A FLOOR PLAN APPROVED: PROJECT DIRECTOR		PROJECT PHASE: BID DOCUMENTS FULLY SPRINKLERED		PROJECT TITLE: RENOVATE A & B WING BUILDING 6 PROJECT LOCATION: 2200 SW GAGE BLVD, TOPEKA, KS 66622 DATE: 07/10/2019 CHECKED BY: JES DRAWN BY: RLC		VA PROJECT NUMBER: 589-A5-19-116 BUILDING NUMBER: 6 DRAWING NUMBER: 6-PPD100A Dwg. 61 OF 160	
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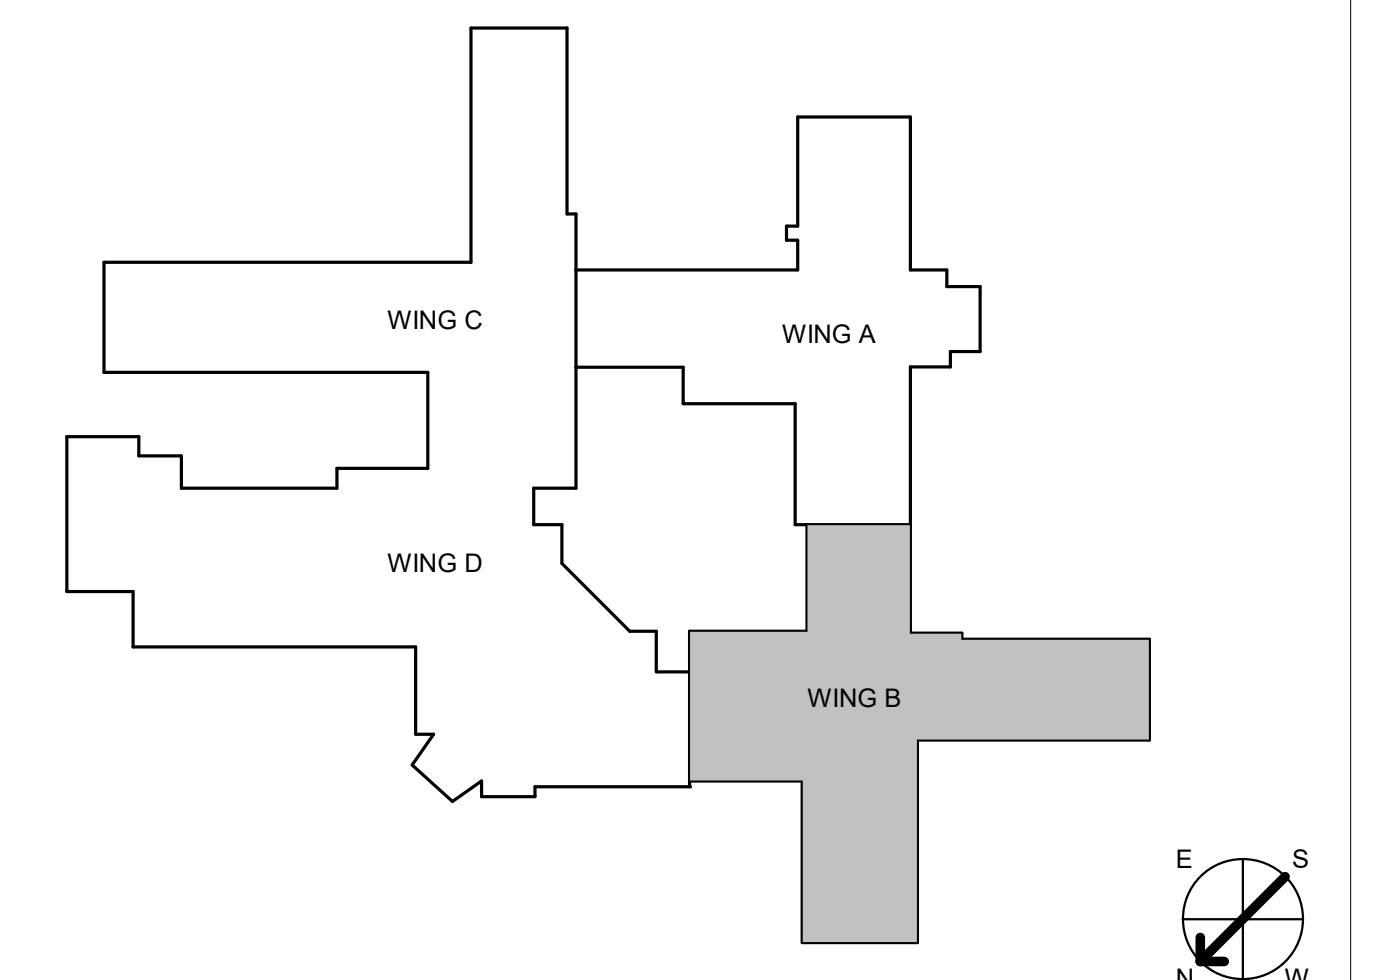

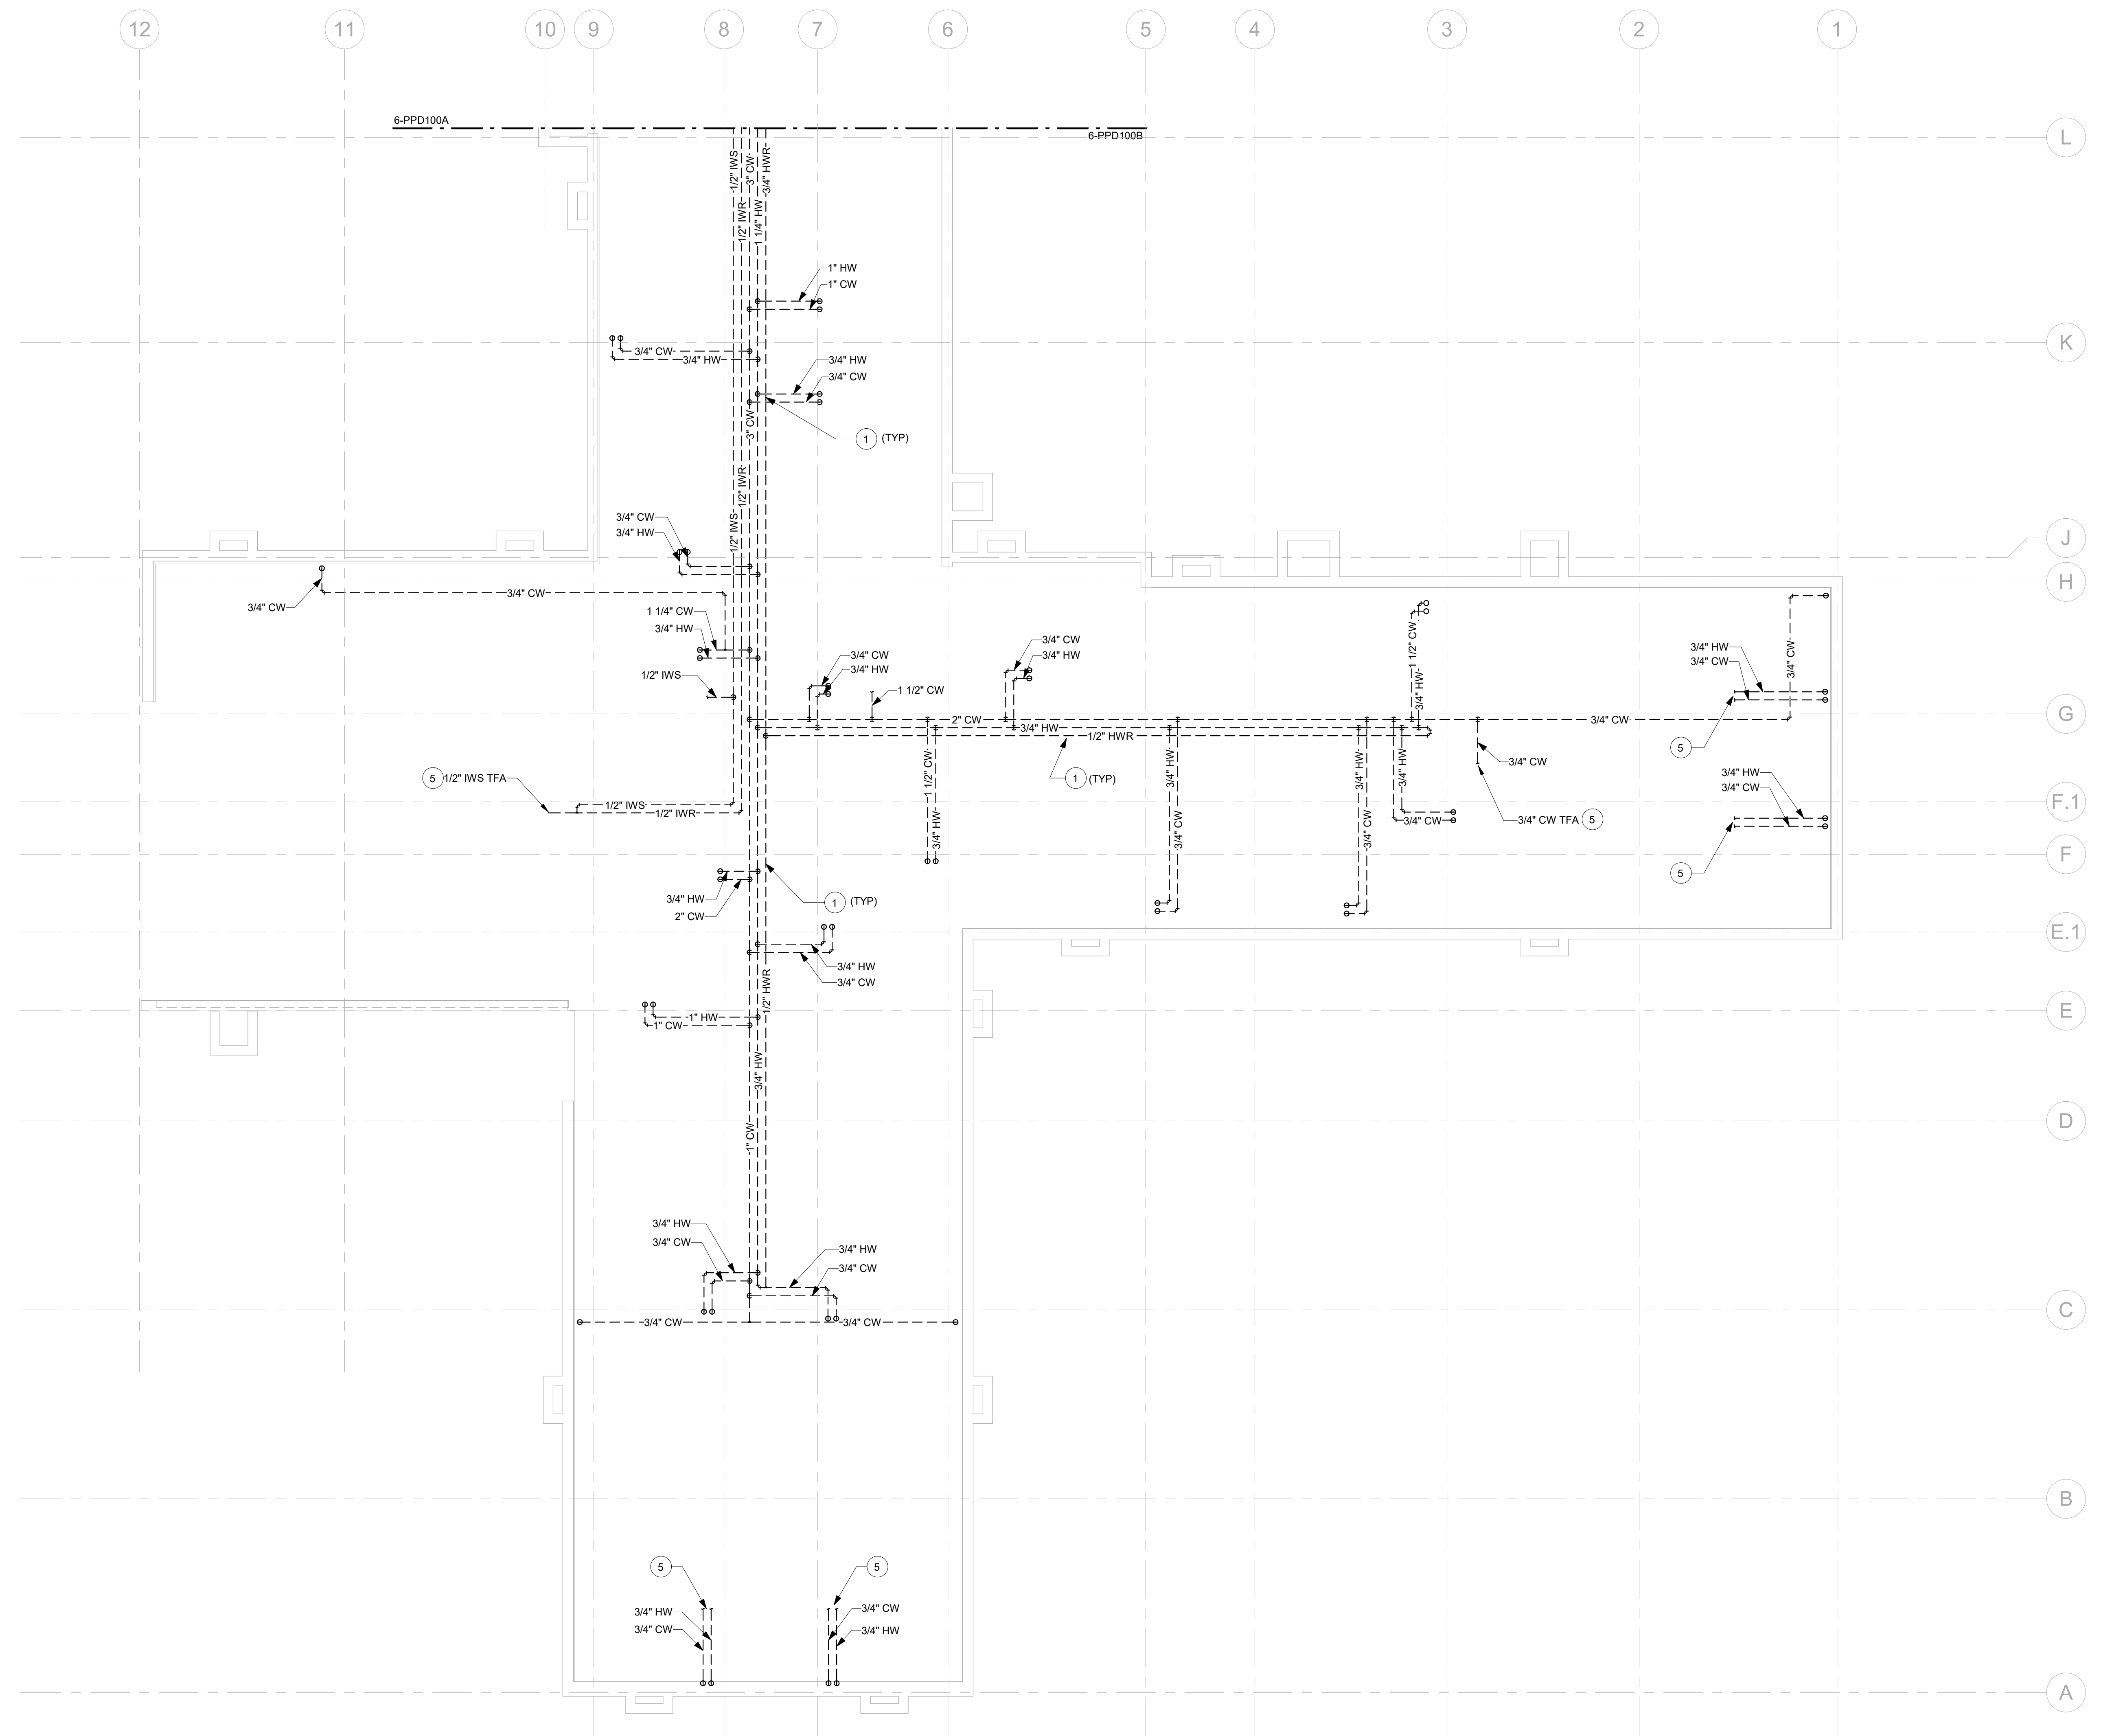
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- IN ADDITION, IF THE DEDUCT ALTERNATE IS ELECTED, ALL PLAN WORK ON THIS SHEET IS ALSO SUBJECT TO THE REDUCED AREAS OF WORK AS DEFINED ON ARCHITECTURAL SHEET 6-GI-105.

- PLUMBING DEMO PLAN NOTES:**
1. DEMOLISH EXISTING DOMESTIC WATER PIPING AND ASSOCIATED ACCESSORIES.
 5. CONTRACTOR TO FIELD VERIFY EXISTING CONDITIONS.

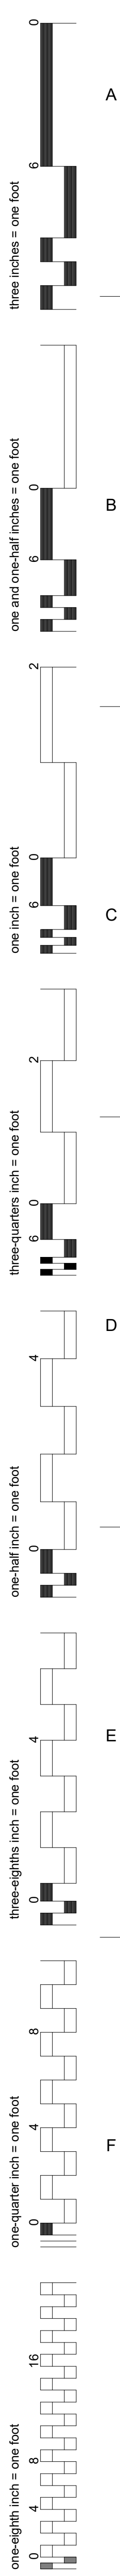


1 PLUMBING SUPPLY DEMO PLAN - BASEMENT WING B FLOOR PLAN
1/8" = 1'-0"




CONSULTANT INFORMATION STRUCTURAL / CIVIL ENGINEER: STAND STRUCTURAL ENGINEERING, 11627 W. 112TH STREET, SUITE 200, OVERLAND PARK, KS 66210 (913) 214-2169 MECHANICAL / ELECTRICAL / PLUMBING / TECHNICAL ENGINEER: SPUR DESIGN, 11020 KING STREET, SUITE 350, OVERLAND PARK, KS 66210 (405) 842-6100 FIRE PROTECTION ENGINEER: POOLE FIRE PROTECTION, INC., 19910 W. 161ST STREET, OLATH, KS 66062 (913) 829-8650			ARCHITECT 312 5th Street, Overland Park, KS 66209 10020 King Street, Suite 300, Overland Park, KS 66209 KS ARCH REG. NO. A-1139, EXP. 12/31/2019 KS ENGR REG. NO. E-2586, EXP. 12/31/2019		Office of Construction and Facilities Management VA U.S. Department of Veteran Affairs		SHEET TITLE: PLUMBING SUPPLY DEMO PLAN - BASEMENT WING B FLOOR PLAN APPROVED: PROJECT DIRECTOR		PROJECT PHASE: BID DOCUMENTS FULLY SPRINKLERED		PROJECT TITLE: RENOVATE A & B WING BUILDING 6 PROJECT LOCATION: 2200 SW GAGE BLVD, TOPEKA, KS 66622 DATE: 07/10/2019 CHECKED BY: JES DRAWN BY: RLC		VA PROJECT NUMBER: 589-A5-19-116 BUILDING NUMBER: 6 DRAWING NUMBER: 6-PPD100B Dwg. 62 OF 160	
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

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 one and one-half inches = one foot
 one inch = one foot
 three-quarters inch = one foot
 one-half inch = one foot
 three-eighths inch = one foot
 one-quarter inch = one foot
 one-eighth inch = one foot

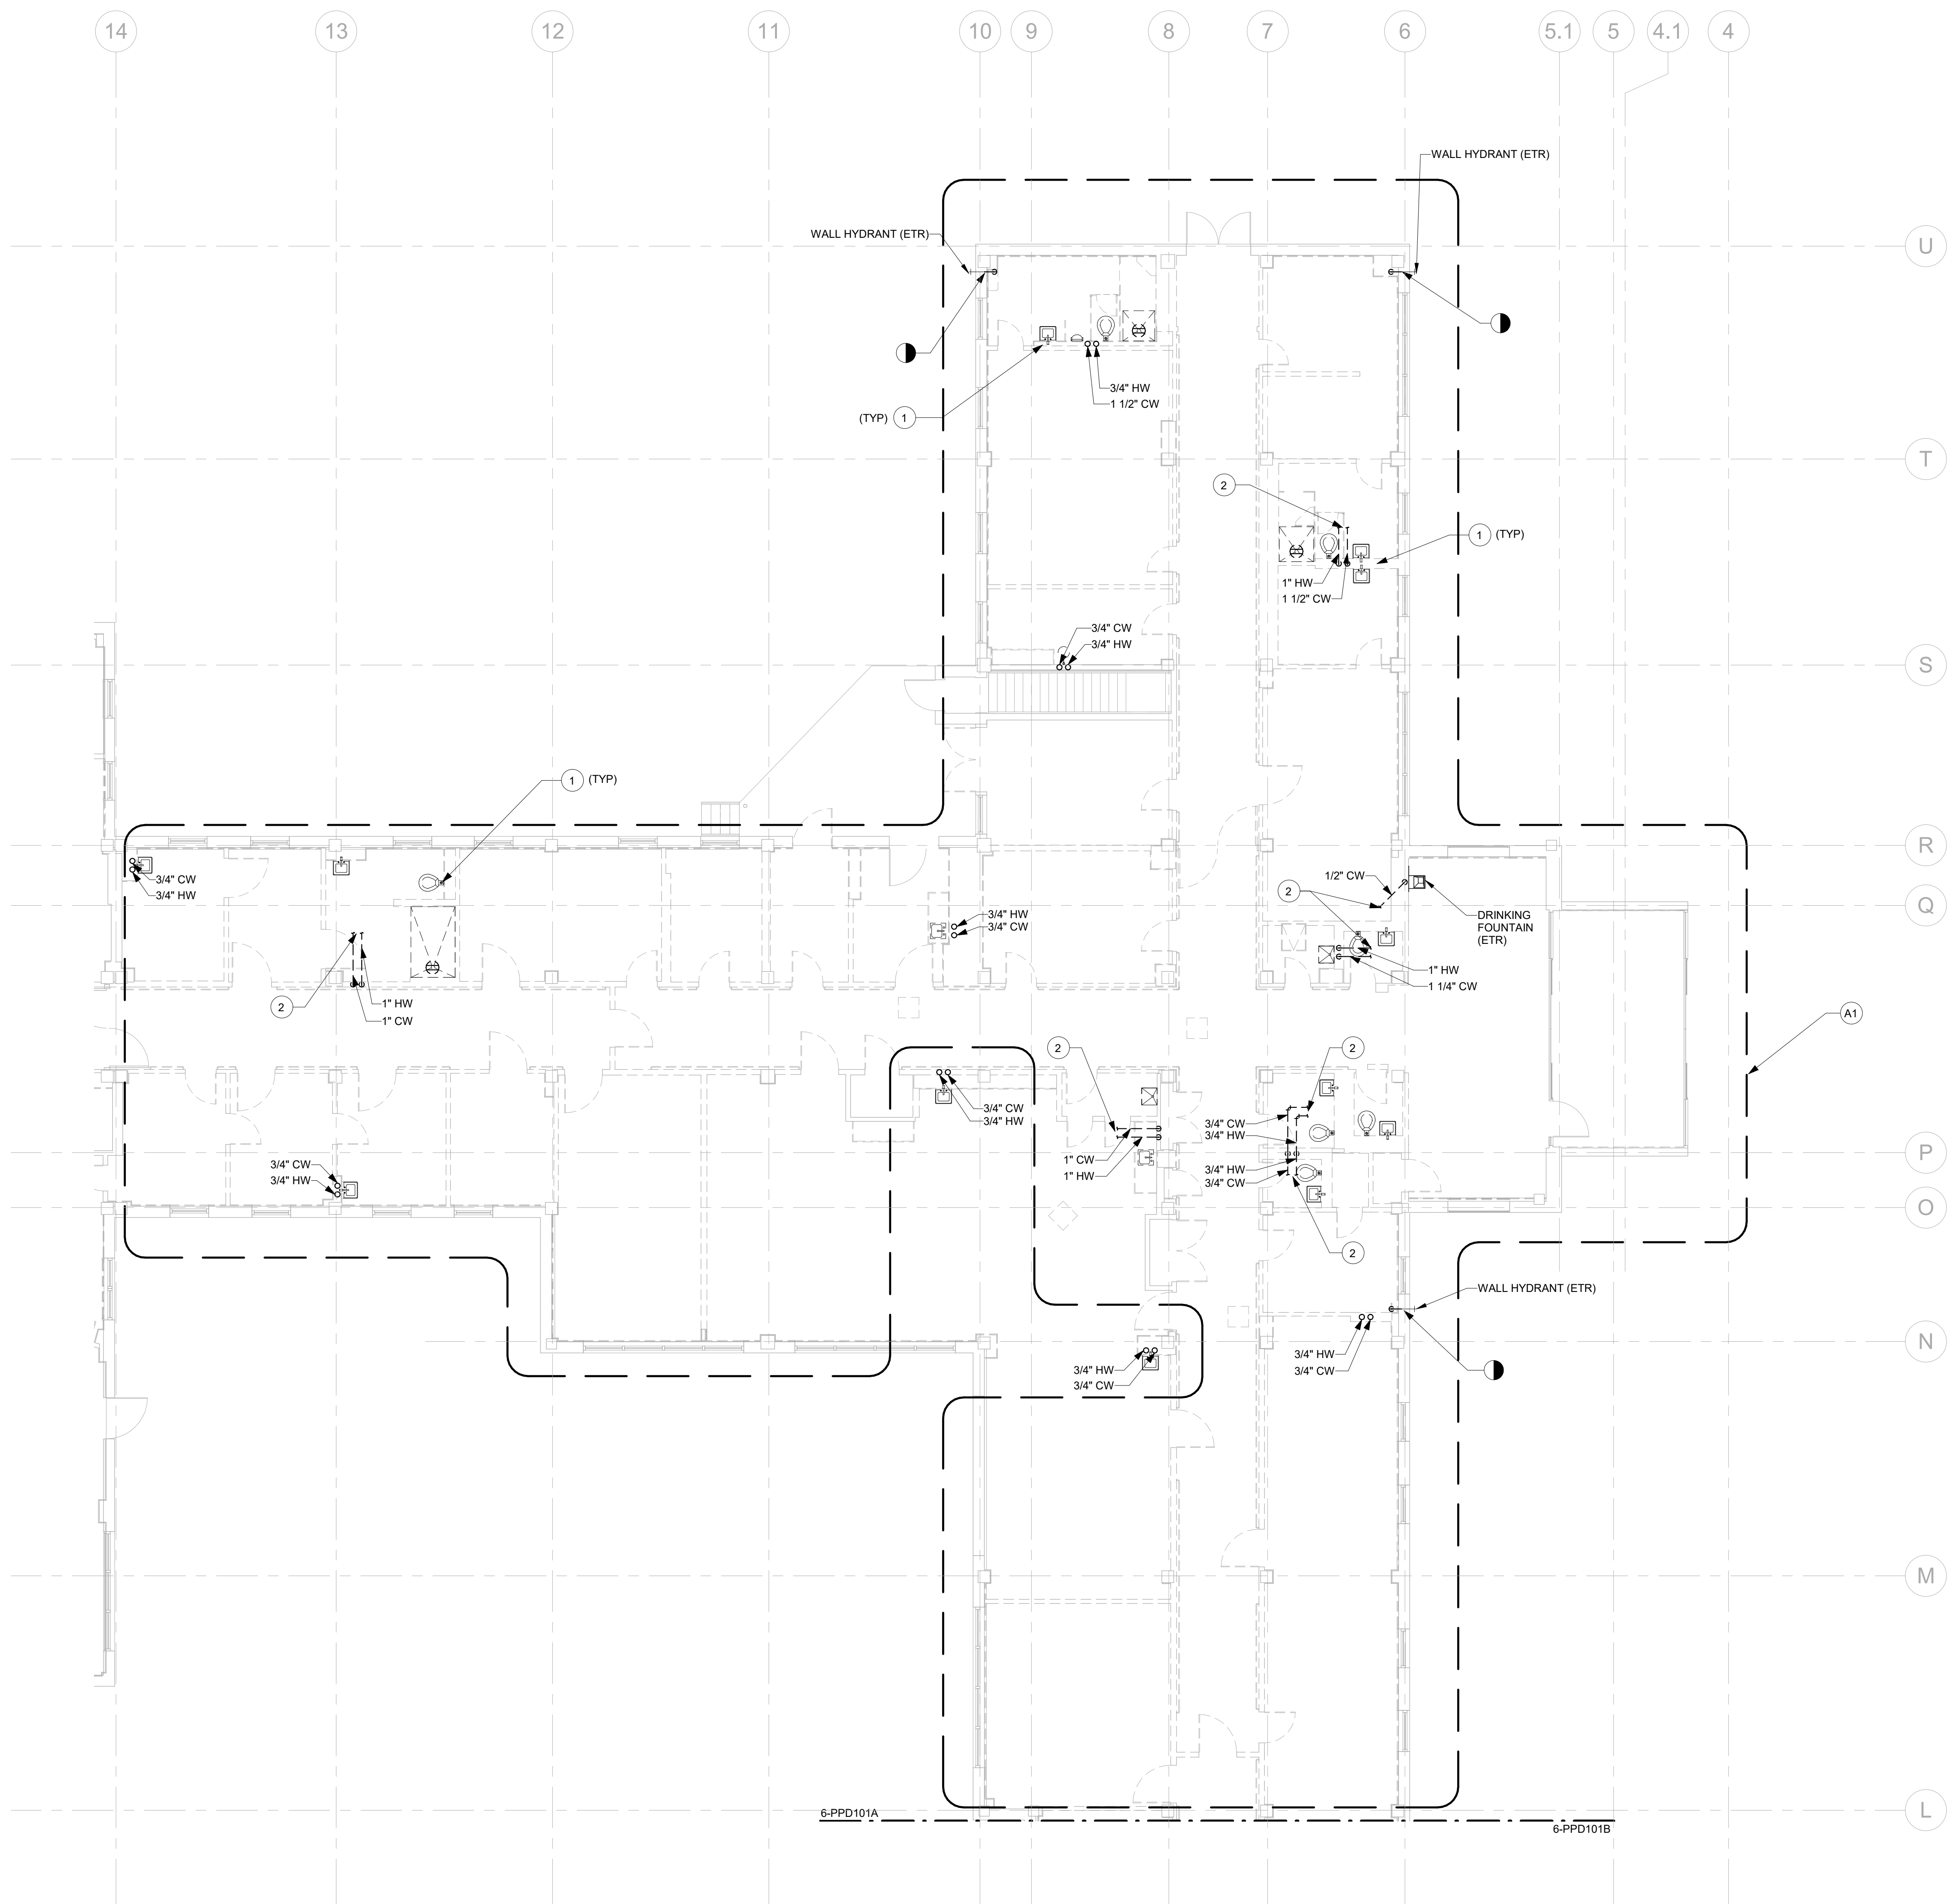


- GENERAL NOTES:**
1. THE AREA OF WORK SHOWN IS ASSOCIATED WITH AN OPERATING FACILITY THAT MUST REMAIN IN SERVICE 24/7.
 2. SEE SHEET 6I-001 FOR ADDITIONAL INFORMATION REGARDING SCHEDULE AND PHASING REQUIREMENTS. SCHEDULE WORK TO MINIMIZE DISRUPTION OF SERVICES.
 3. COORDINATE WORK SCHEDULE WITH THE CONTRACTING OFFICER'S REPRESENTATIVE (COR) BEFORE THE START OF WORK.
 4. COORDINATE PLUMBING WORK WITH OTHER TRADES AND CONTRACTORS. VERIFY ALL EXISTING CONDITIONS BEFORE THE START OF WORK.
 5. COORDINATE TEMPORARY ROOF DRAINAGE DURING CONSTRUCTION AND REPLACEMENT OF STORM PIPE.
 6. THE DEMOLITION DRAWINGS ARE DEEMED SCHEMATIC. CONTRACTOR RESPONSIBLE FOR FIELD VERIFYING EXISTING DEMOLITION WORK PRIOR TO SUBMISSION OF PROPOSAL.
 7. ALL PLUMBING FIXTURES SHOWN ON THIS SHEET ARE EXISTING TO BE DEMOLISHED UNLESS NOTED OTHERWISE.
- DEDUCT ALTERNATE & PHASING:**
- ALL PLAN WORK SHOWN ON THIS SHEET IS SUBJECT TO THE OVERALL PROJECT PHASING SEQUENCE OUTLINED ON ARCHITECTURAL SHEET 6-GI-102.
- IN ADDITION, IF THE DEDUCT ALTERNATE IS ELECTED, ALL PLAN WORK ON THIS SHEET IS ALSO SUBJECT TO THE REDUCED AREAS OF WORK AS DEFINED ON ARCHITECTURAL SHEET 6-GI-105.
- # **PLUMBING DEMO PLAN NOTES:**
1. DEMOLISH EXISTING FIXTURES AND ASSOCIATED DOMESTIC WATER PIPING BACK TO MAIN IN CRAWL SPACE. SEE SHEET 6-PPD100A FOR RELATED WORK. ALL PLUMBING FIXTURES SHOWN ON THIS SHEET ARE EXISTING TO BE DEMOLISHED UNLESS NOTED OTHERWISE.
 2. CONTRACTOR TO FIELD VERIFY EXISTING CONDITIONS.
- # **DEDUCT ALTERNATE NOTES:**
- A1. IF DEDUCT ALTERNATE IS ACCEPTED, DO NOT DEMOLISH EXISTING PLUMBING FIXTURES AND ASSOCIATED DOMESTIC WATER PIPING.

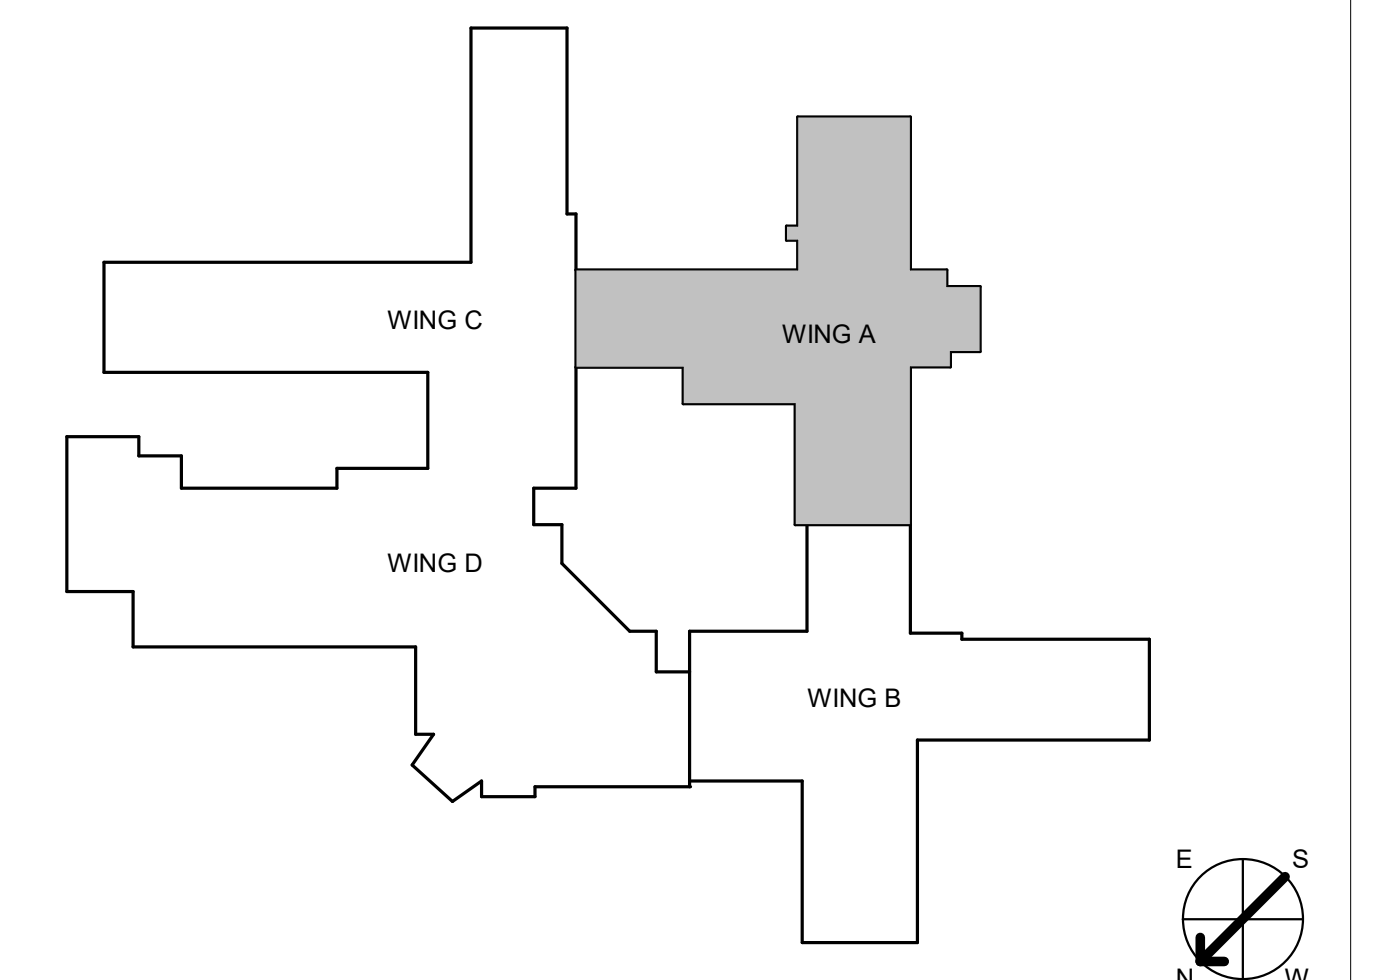

1 PLUMBING SUPPLY DEMO PLAN - LEVEL 1 WING A FLOOR PLAN
 1/8" = 1'-0"

CONSULTANT INFORMATION STRUCTURAL / CIVIL ENGINEER STAND STRUCTURAL ENGINEERING 11627 W. 112TH STREET, SUITE 200 OVERLAND PARK, KS 66210 (913) 214-2169		MECHANICAL / ELECTRICAL / PLUMBING / TECHNICAL ENGINEER SPUR DESIGN 11020 KING STREET, SUITE 350 OVERLAND PARK, KS 66210 (405) 842-6100		FIRE PROTECTION ENGINEER POOLE FIRE PROTECTION, INC. 19910 W. 161ST STREET OLATH, KS 66062 (913) 829-8650		ARCHITECT  512 SW 23th Street Overland Park, KS 66150 spur-design.com 11020 King Street, Suite 350 Overland Park, KS 66210 spur-design.com		Office of Construction and Facilities Management VA U.S. Department of Veteran Affairs 		SHEET TITLE PLUMBING SUPPLY DEMO PLAN - LEVEL 1 WING A FLOOR PLAN APPROVED: PROJECT DIRECTOR		PROJECT PHASE BID DOCUMENTS FULLY SPRINKLERED		PROJECT TITLE RENOVATE A & B WING BUILDING 6 PROJECT LOCATION 2200 SW GAGE BLVD TOPEKA, KS 66622		VA PROJECT NUMBER 589-A5-19-116 BUILDING NUMBER 6 DRAWING NUMBER 6-PPD101A Dwg. 63 OF 160	
Revision # Date																	

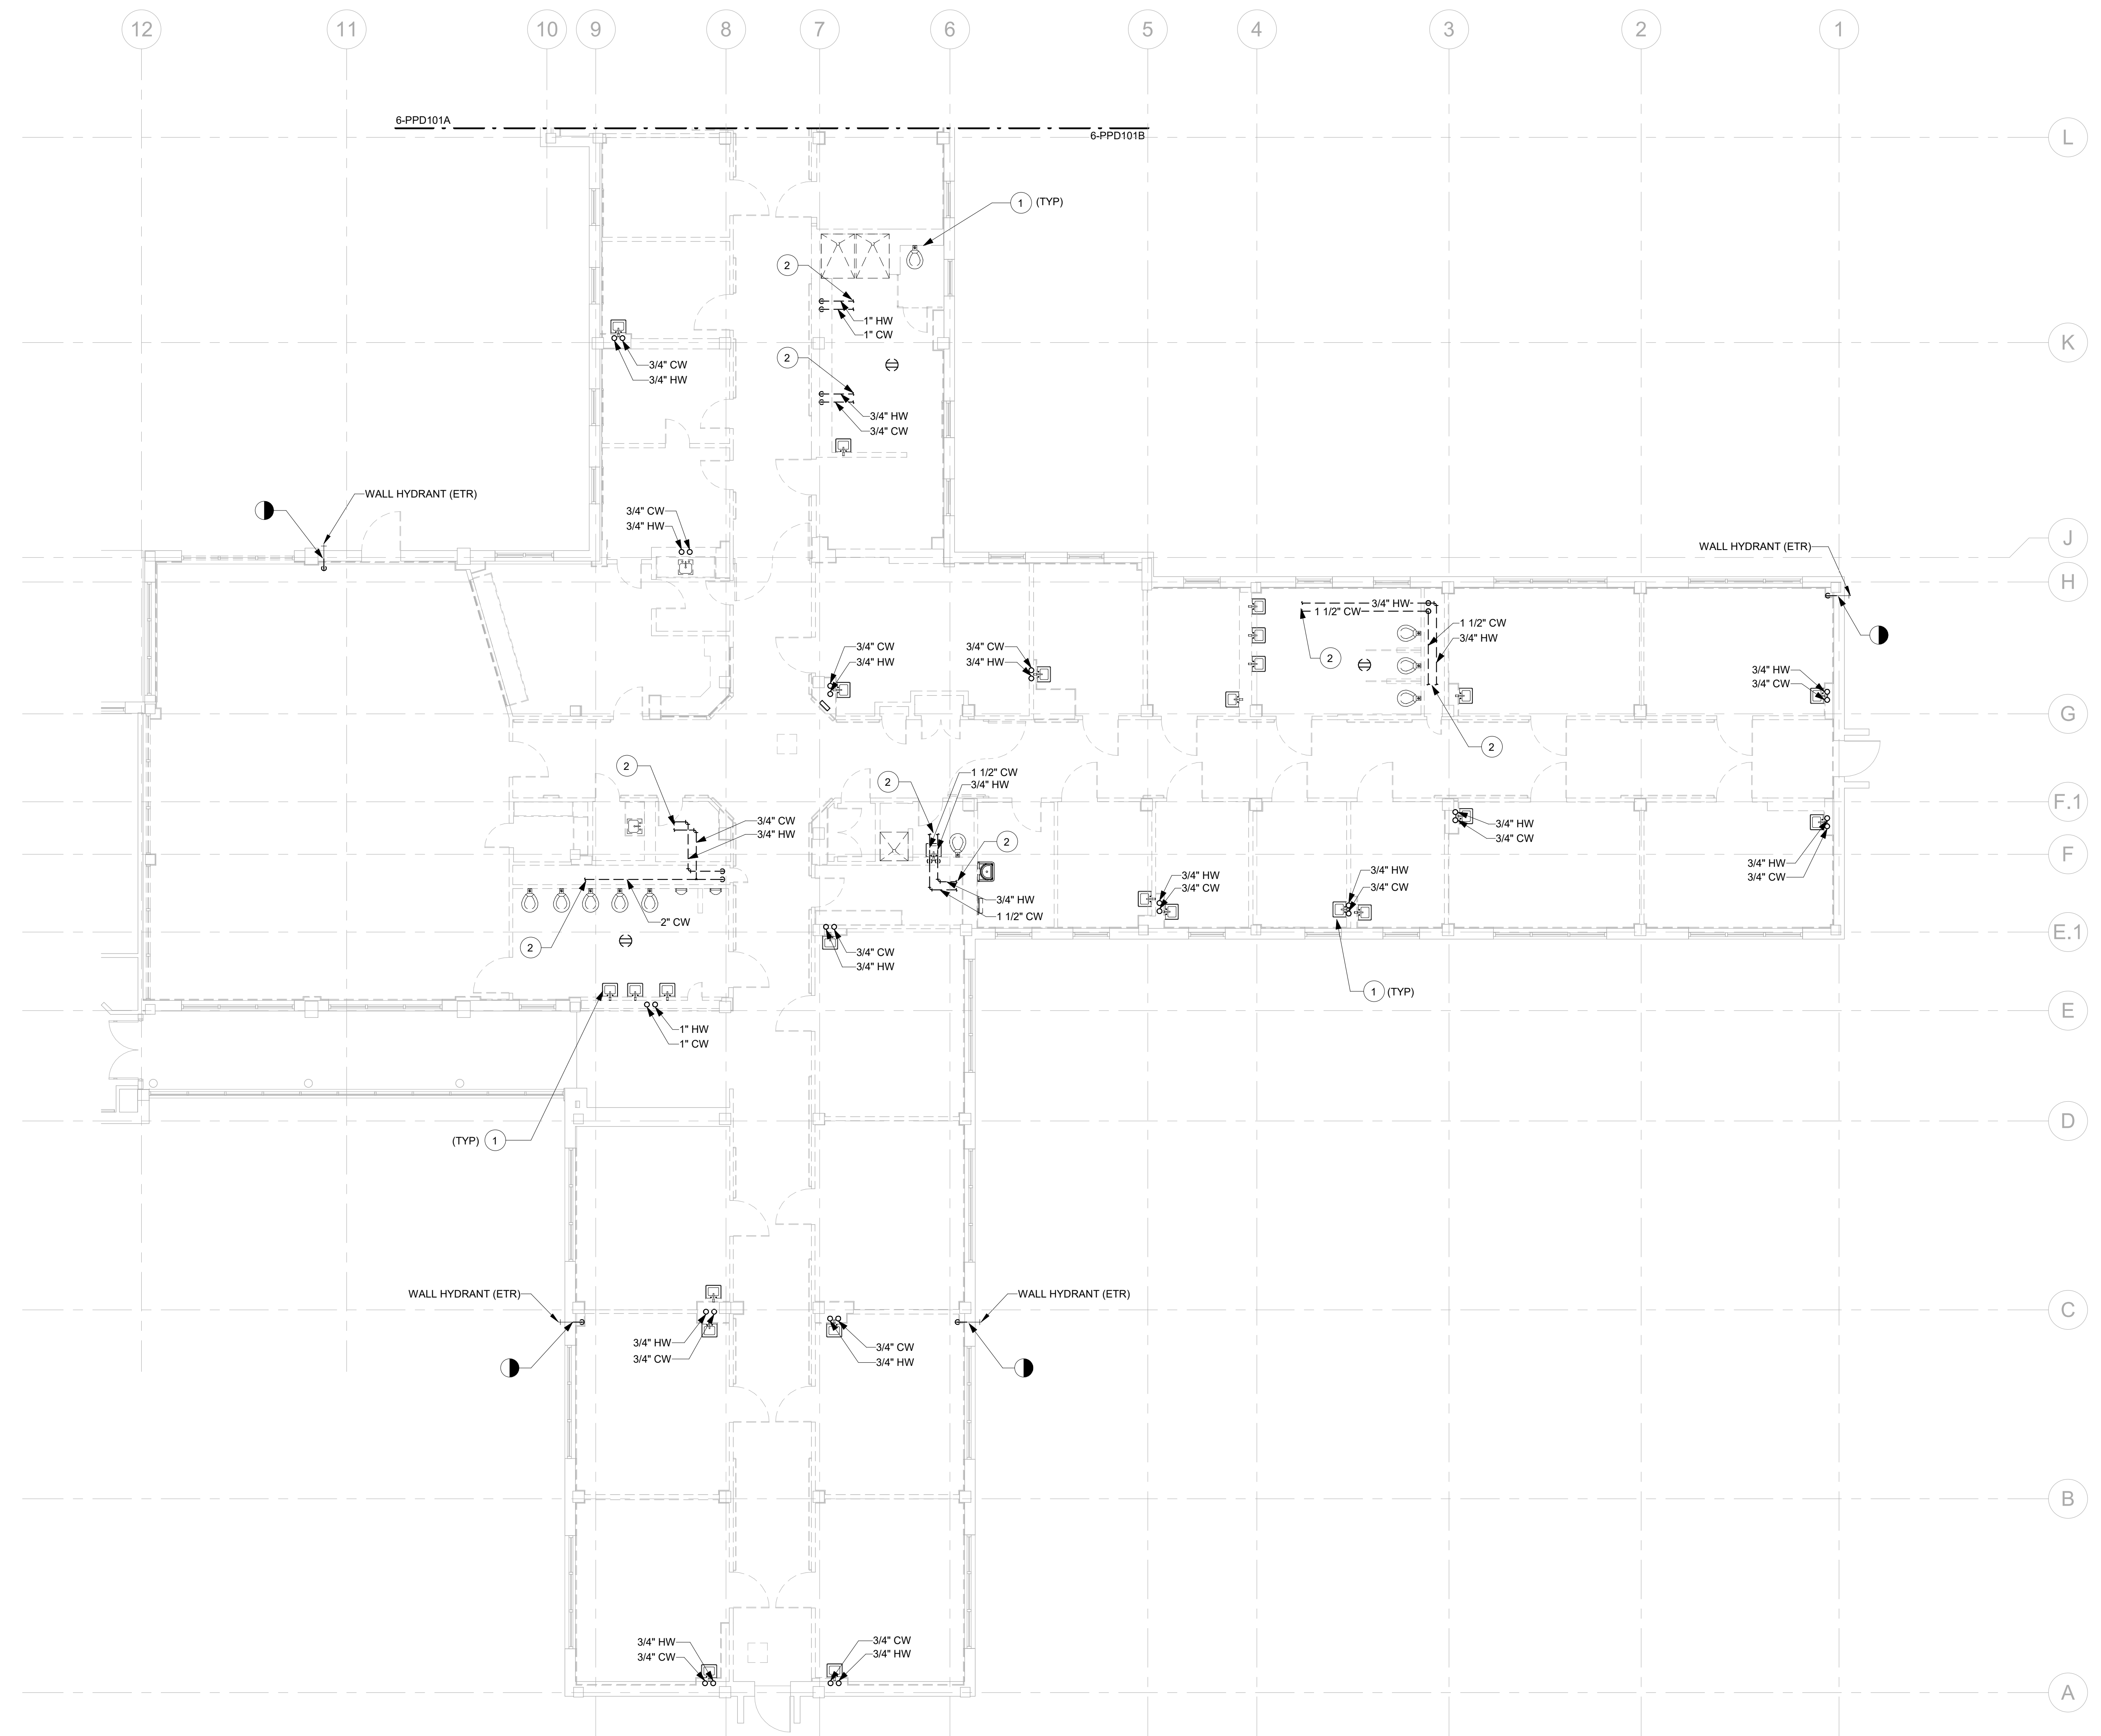

GENERAL NOTES:

1. THE AREA OF WORK SHOWN IS ASSOCIATED WITH AN OPERATING FACILITY THAT MUST REMAIN IN SERVICE 24/7.
2. SEE SHEET 6I-001 FOR ADDITIONAL INFORMATION REGARDING SCHEDULE AND PHASING REQUIREMENTS. SCHEDULE WORK TO MINIMIZE DISRUPTION OF SERVICES.
3. COORDINATE WORK SCHEDULE WITH THE CONTRACTING OFFICER'S REPRESENTATIVE (COR) BEFORE THE START OF WORK.
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6. THE DEMOLITION DRAWINGS ARE DEEMED SCHEMATIC. CONTRACTOR RESPONSIBLE FOR FIELD VERIFYING EXISTING DEMOLITION WORK PRIOR TO SUBMISSION OF PROPOSAL.
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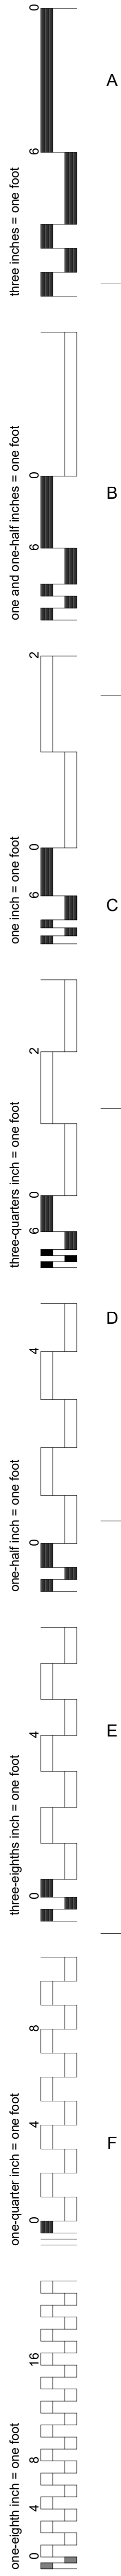
DEDUCT ALTERNATE & PHASING:

ALL PLAN WORK SHOWN ON THIS SHEET IS SUBJECT TO THE OVERALL PROJECT PHASING SEQUENCE OUTLINED ON ARCHITECTURAL SHEET 6-GI-102.


IN ADDITION, IF THE DEDUCT ALTERNATE IS ELECTED, ALL PLAN WORK ON THIS SHEET IS ALSO SUBJECT TO THE REDUCED AREAS OF WORK AS DEFINED ON ARCHITECTURAL SHEET 6-GI-105.

PLUMBING DEMO PLAN NOTES:


1. DEMOLISH EXISTING FIXTURES AND ASSOCIATED DOMESTIC WATER PIPING BACK TO MAIN IN CRAWL SPACE. SEE SHEET 6-PPD100A FOR RELATED WORK. ALL PLUMBING FIXTURES SHOWN ON THIS SHEET ARE EXISTING TO BE DEMOLISHED UNLESS NOTED OTHERWISE.
2. CONTRACTOR TO FIELD VERIFY EXISTING CONDITIONS.



1 PLUMBING SUPPLY DEMO PLAN - LEVEL 1 WING B FLOOR PLAN
1/8" = 1'-0"

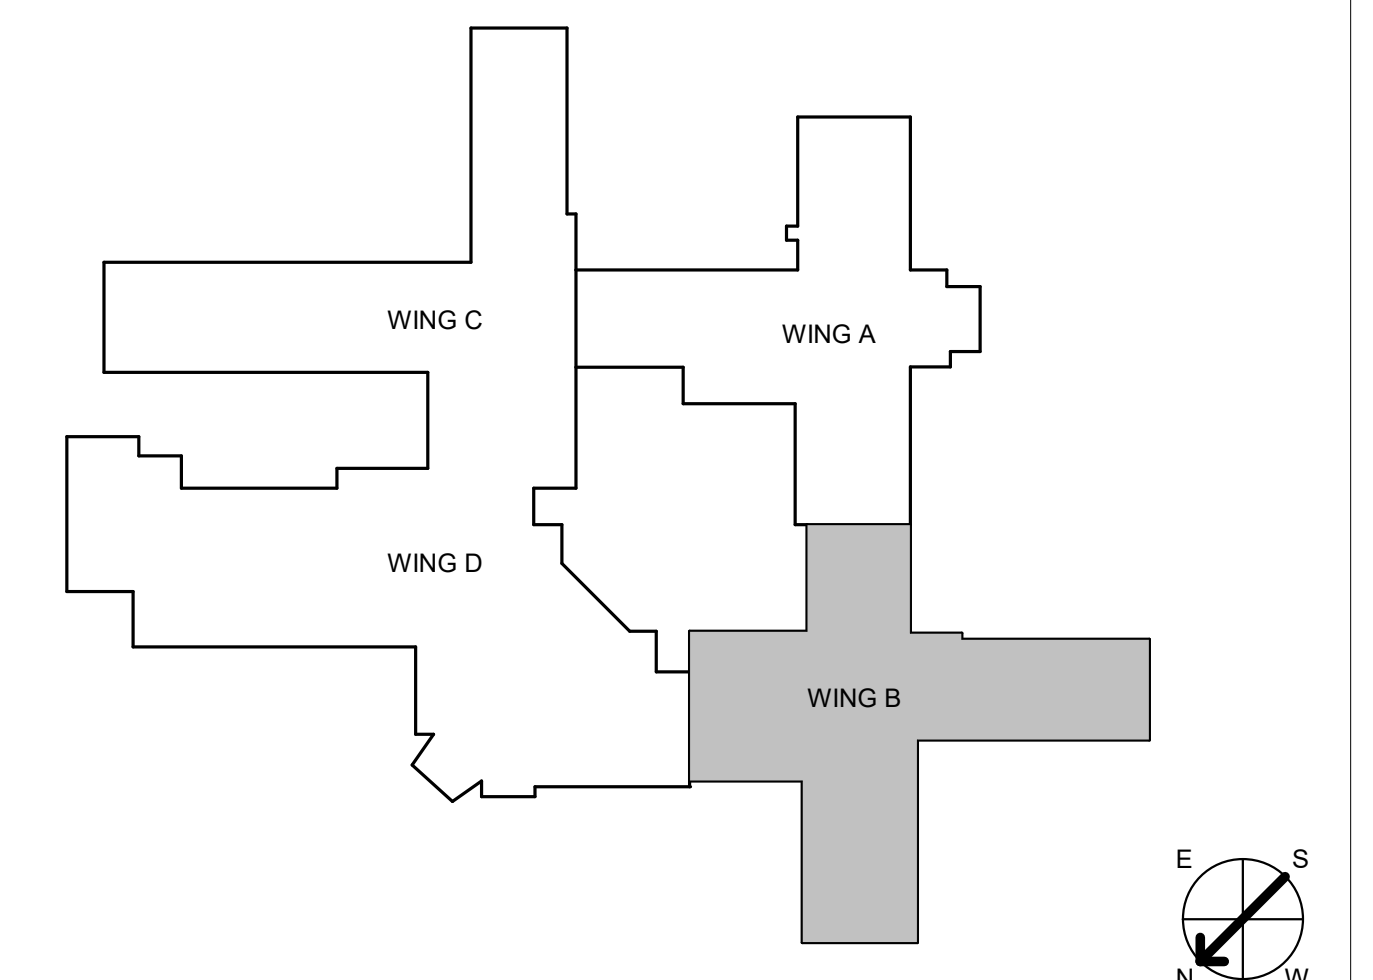


CONSULTANT INFORMATION STRUCTURAL / CIVIL ENGINEER: STAND STRUCTURAL ENGINEERING, 11627 W. 112TH STREET, SUITE 200, OVERLAND PARK, KS 66210, (913) 214-2169 MECHANICAL / ELECTRICAL / PLUMBING / TECHNICAL ENGINEER: SPUR DESIGN, 11020 KING STREET, SUITE 350, OVERLAND PARK, KS 66210, (405) 842-6100 FIRE PROTECTION ENGINEER: POOLE FIRE PROTECTION, INC., 19910 W. 161ST STREET, OLATH, KS 66062, (913) 829-8650			ARCHITECT 312 SW 23rd Street, Overland Park, KS 66150, spur-design.com 10202 King Street, Suite 300, Overland Park, KS 66150, spur-design.com		Office of Construction and Facilities Management VA U.S. Department of Veteran Affairs		SHEET TITLE: PLUMBING SUPPLY DEMO PLAN - LEVEL 1 WING B FLOOR PLAN APPROVED: PROJECT DIRECTOR		PROJECT PHASE: BID DOCUMENTS FULLY SPRINKLERED		PROJECT TITLE: RENOVATE A & B WING BUILDING 6 PROJECT LOCATION: 2200 SW GAGE BLVD, TOPEKA, KS 66622 DATE: 07/10/2019 CHECKED BY: JES DRAWN BY: RLC		VA PROJECT NUMBER: 589-A5-19-116 BUILDING NUMBER: 6 DRAWING NUMBER: 6-PPD101B Dwg. 64 OF 160	
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

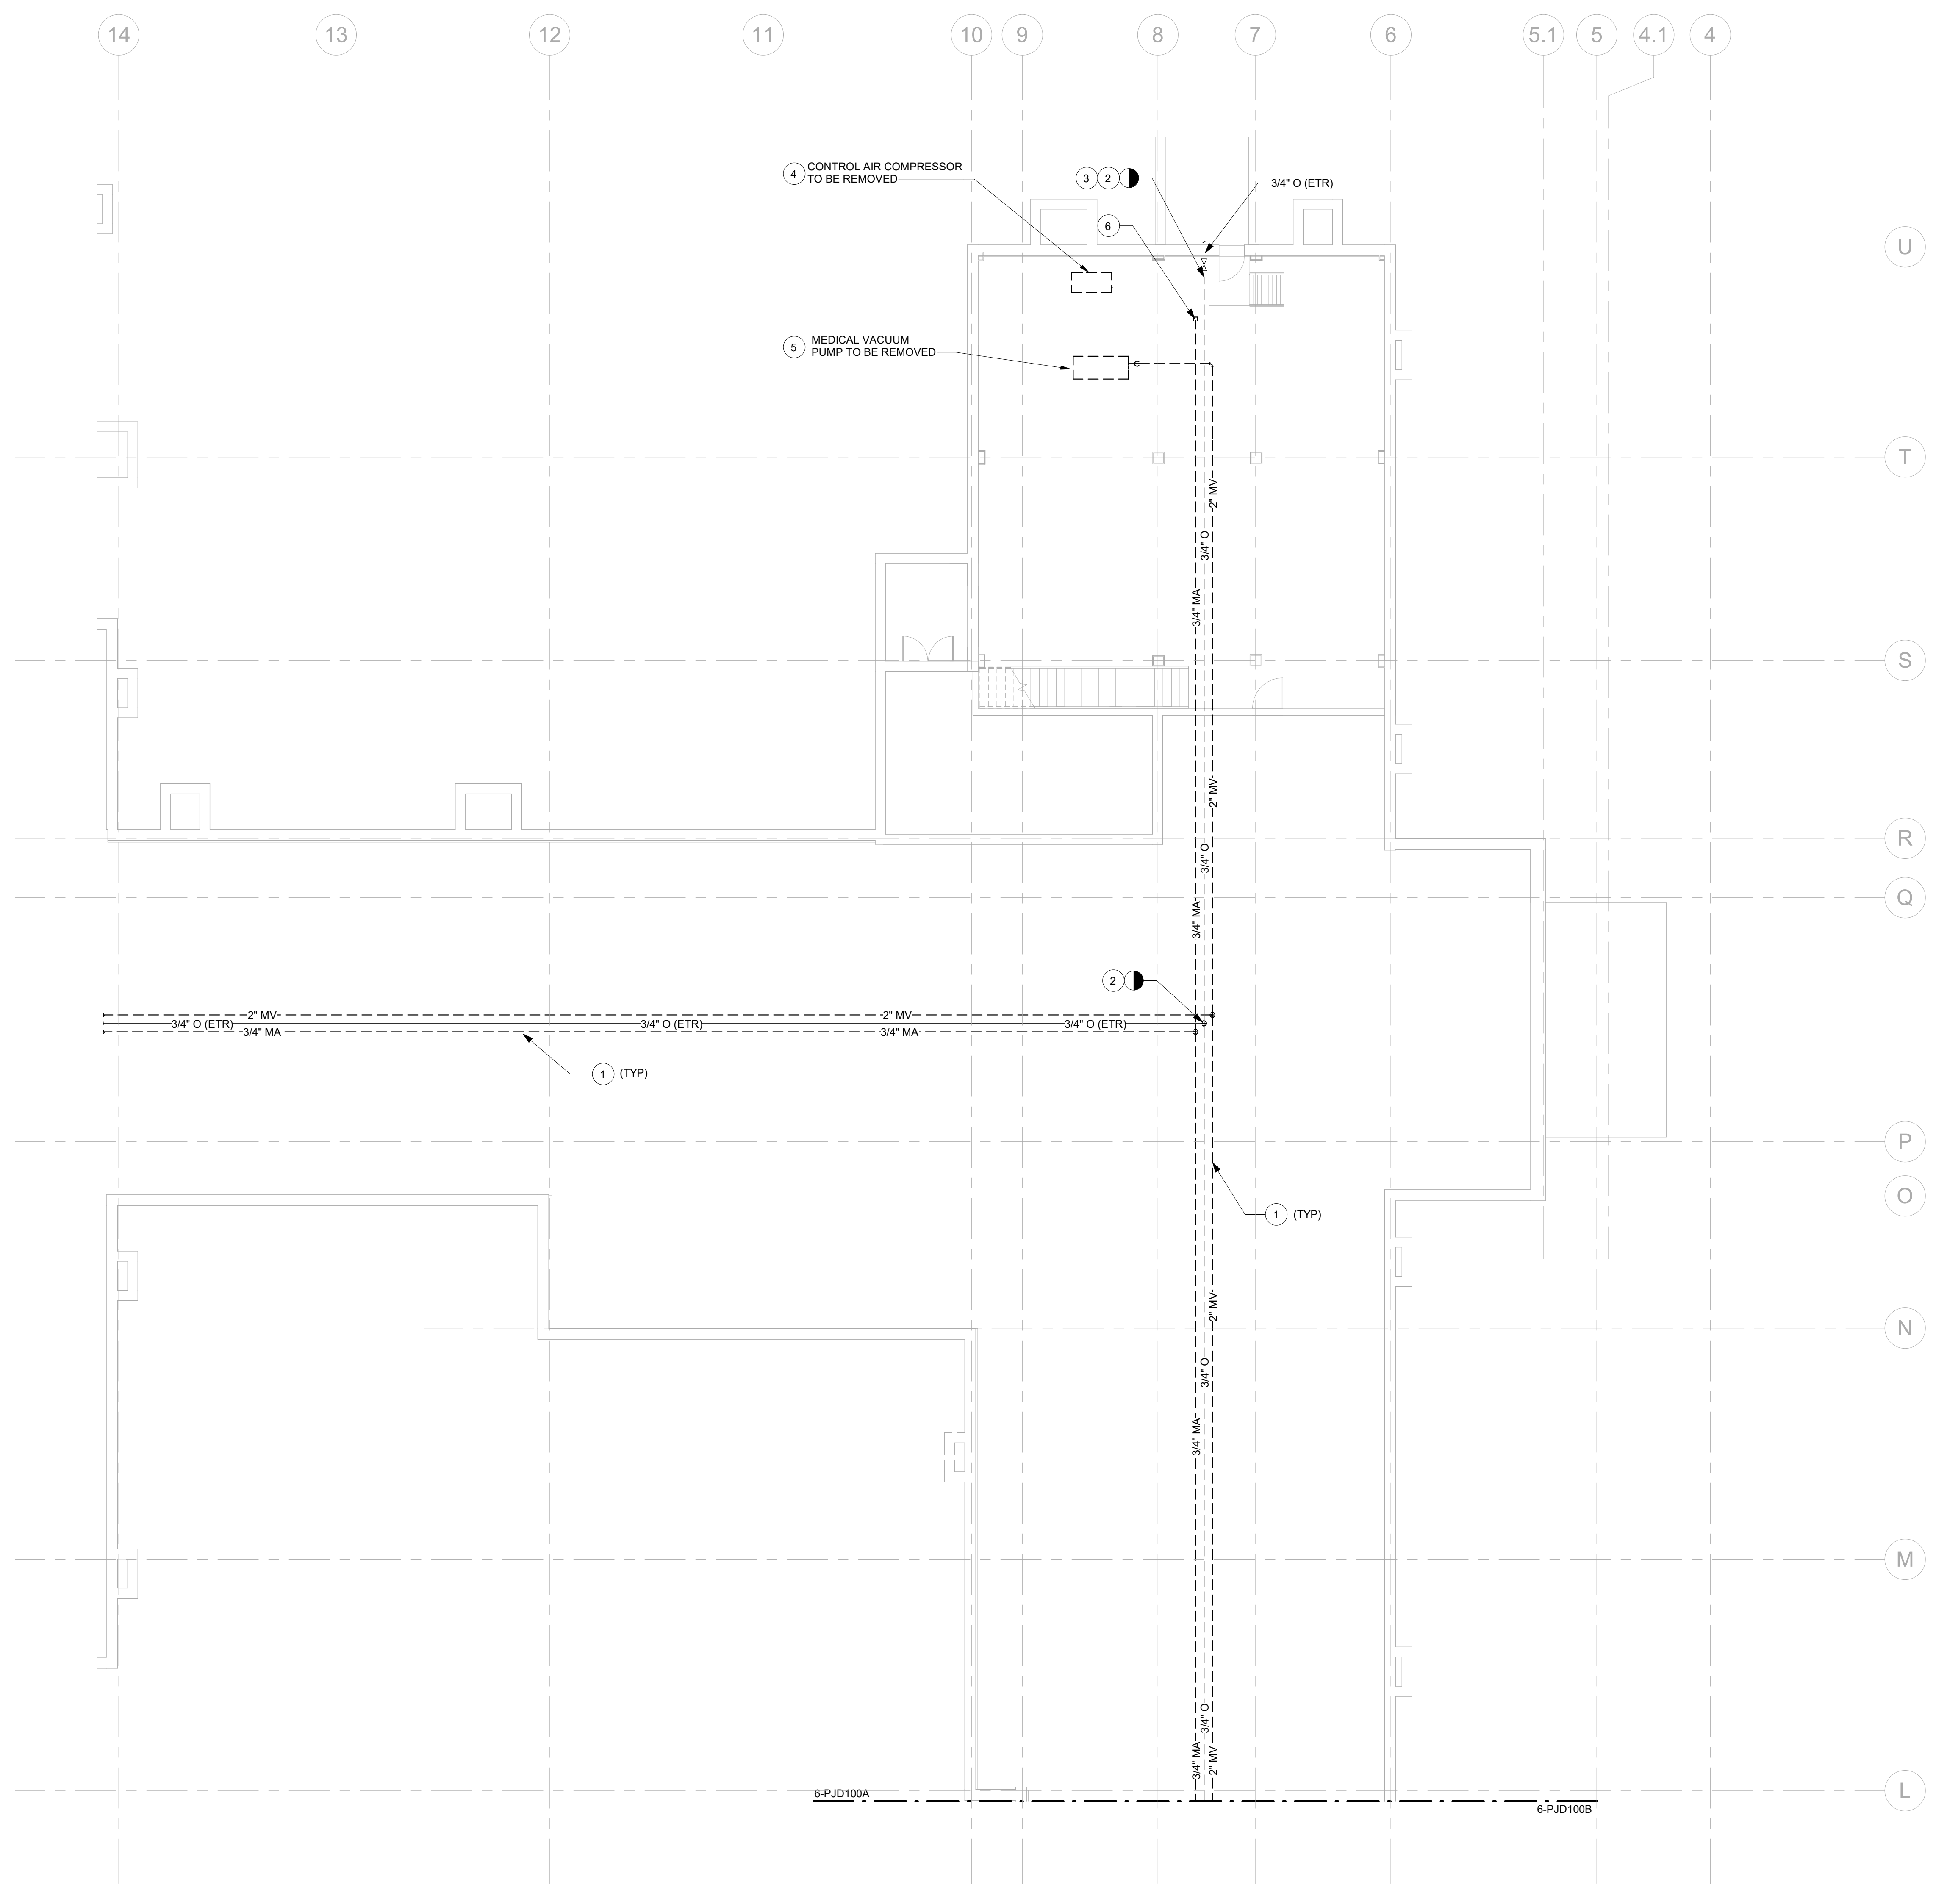

- GENERAL DEMO NOTES:**
1. THE AREA OF WORK SHOWN IS ASSOCIATED WITH AN OPERATING FACILITY THAT MUST REMAIN IN SERVICE 24/7.
 2. SEE SHEET 6I-001 FOR ADDITIONAL INFORMATION REGARDING SCHEDULE AND PHASING REQUIREMENTS. SCHEDULE WORK TO MINIMIZE DISRUPTION OF SERVICES.
 3. COORDINATE WORK SCHEDULE WITH THE CONTRACTING OFFICER'S REPRESENTATIVE (COR) BEFORE THE START OF WORK.
 4. COORDINATE PLUMBING WORK WITH OTHER TRADES AND CONTRACTORS. VERIFY ALL EXISTING CONDITIONS BEFORE THE START OF WORK.
 5. COORDINATE WITH THE COR THE EQUIPMENT TO BE SALVAGED AND THE LOCATION FOR STORAGE.
 6. POSITIVE PRESSURE PATIENT MEDICAL GAS PIPING SHALL NOT BE BREACHED OR PENETRATED BY ANY MEANS OR PROCESS THAT WILL RESULT IN RESIDUAL COPPER PARTICLES OR OTHER DEBRIS REMAINING IN THE PIPING, OR THAT AFFECTS THE OXYGEN-CLEAN INTERIOR OF THE PIPING. IF BREACHING OR PENETRATING THE MEDICAL GAS PIPING IS REQUIRED, THE PROCESS SHALL ENSURE THAT ANY DEBRIS CREATED BY THE PROCESS REMAINS CONTAINED WITHIN THE WORK AREA.
 7. HOT TAPS OR SIMILAR VALVE ASSEMBLIES ARE NOT PERMITTED IN MEDICAL GAS PIPING SYSTEMS.
 8. THE DEMOLITION DRAWINGS ARE DEEMED SCHEMATIC. CONTRACTOR RESPONSIBLE FOR FIELD VERIFYING EXISTING DEMOLITION WORK PRIOR TO SUBMISSION OF PROPOSAL.
- DEDUCT ALTERNATE & PHASING:**
- ALL PLAN WORK SHOWN ON THIS SHEET IS SUBJECT TO THE OVERALL PROJECT PHASING SEQUENCE OUTLINED ON ARCHITECTURAL SHEET 6-GI-102.
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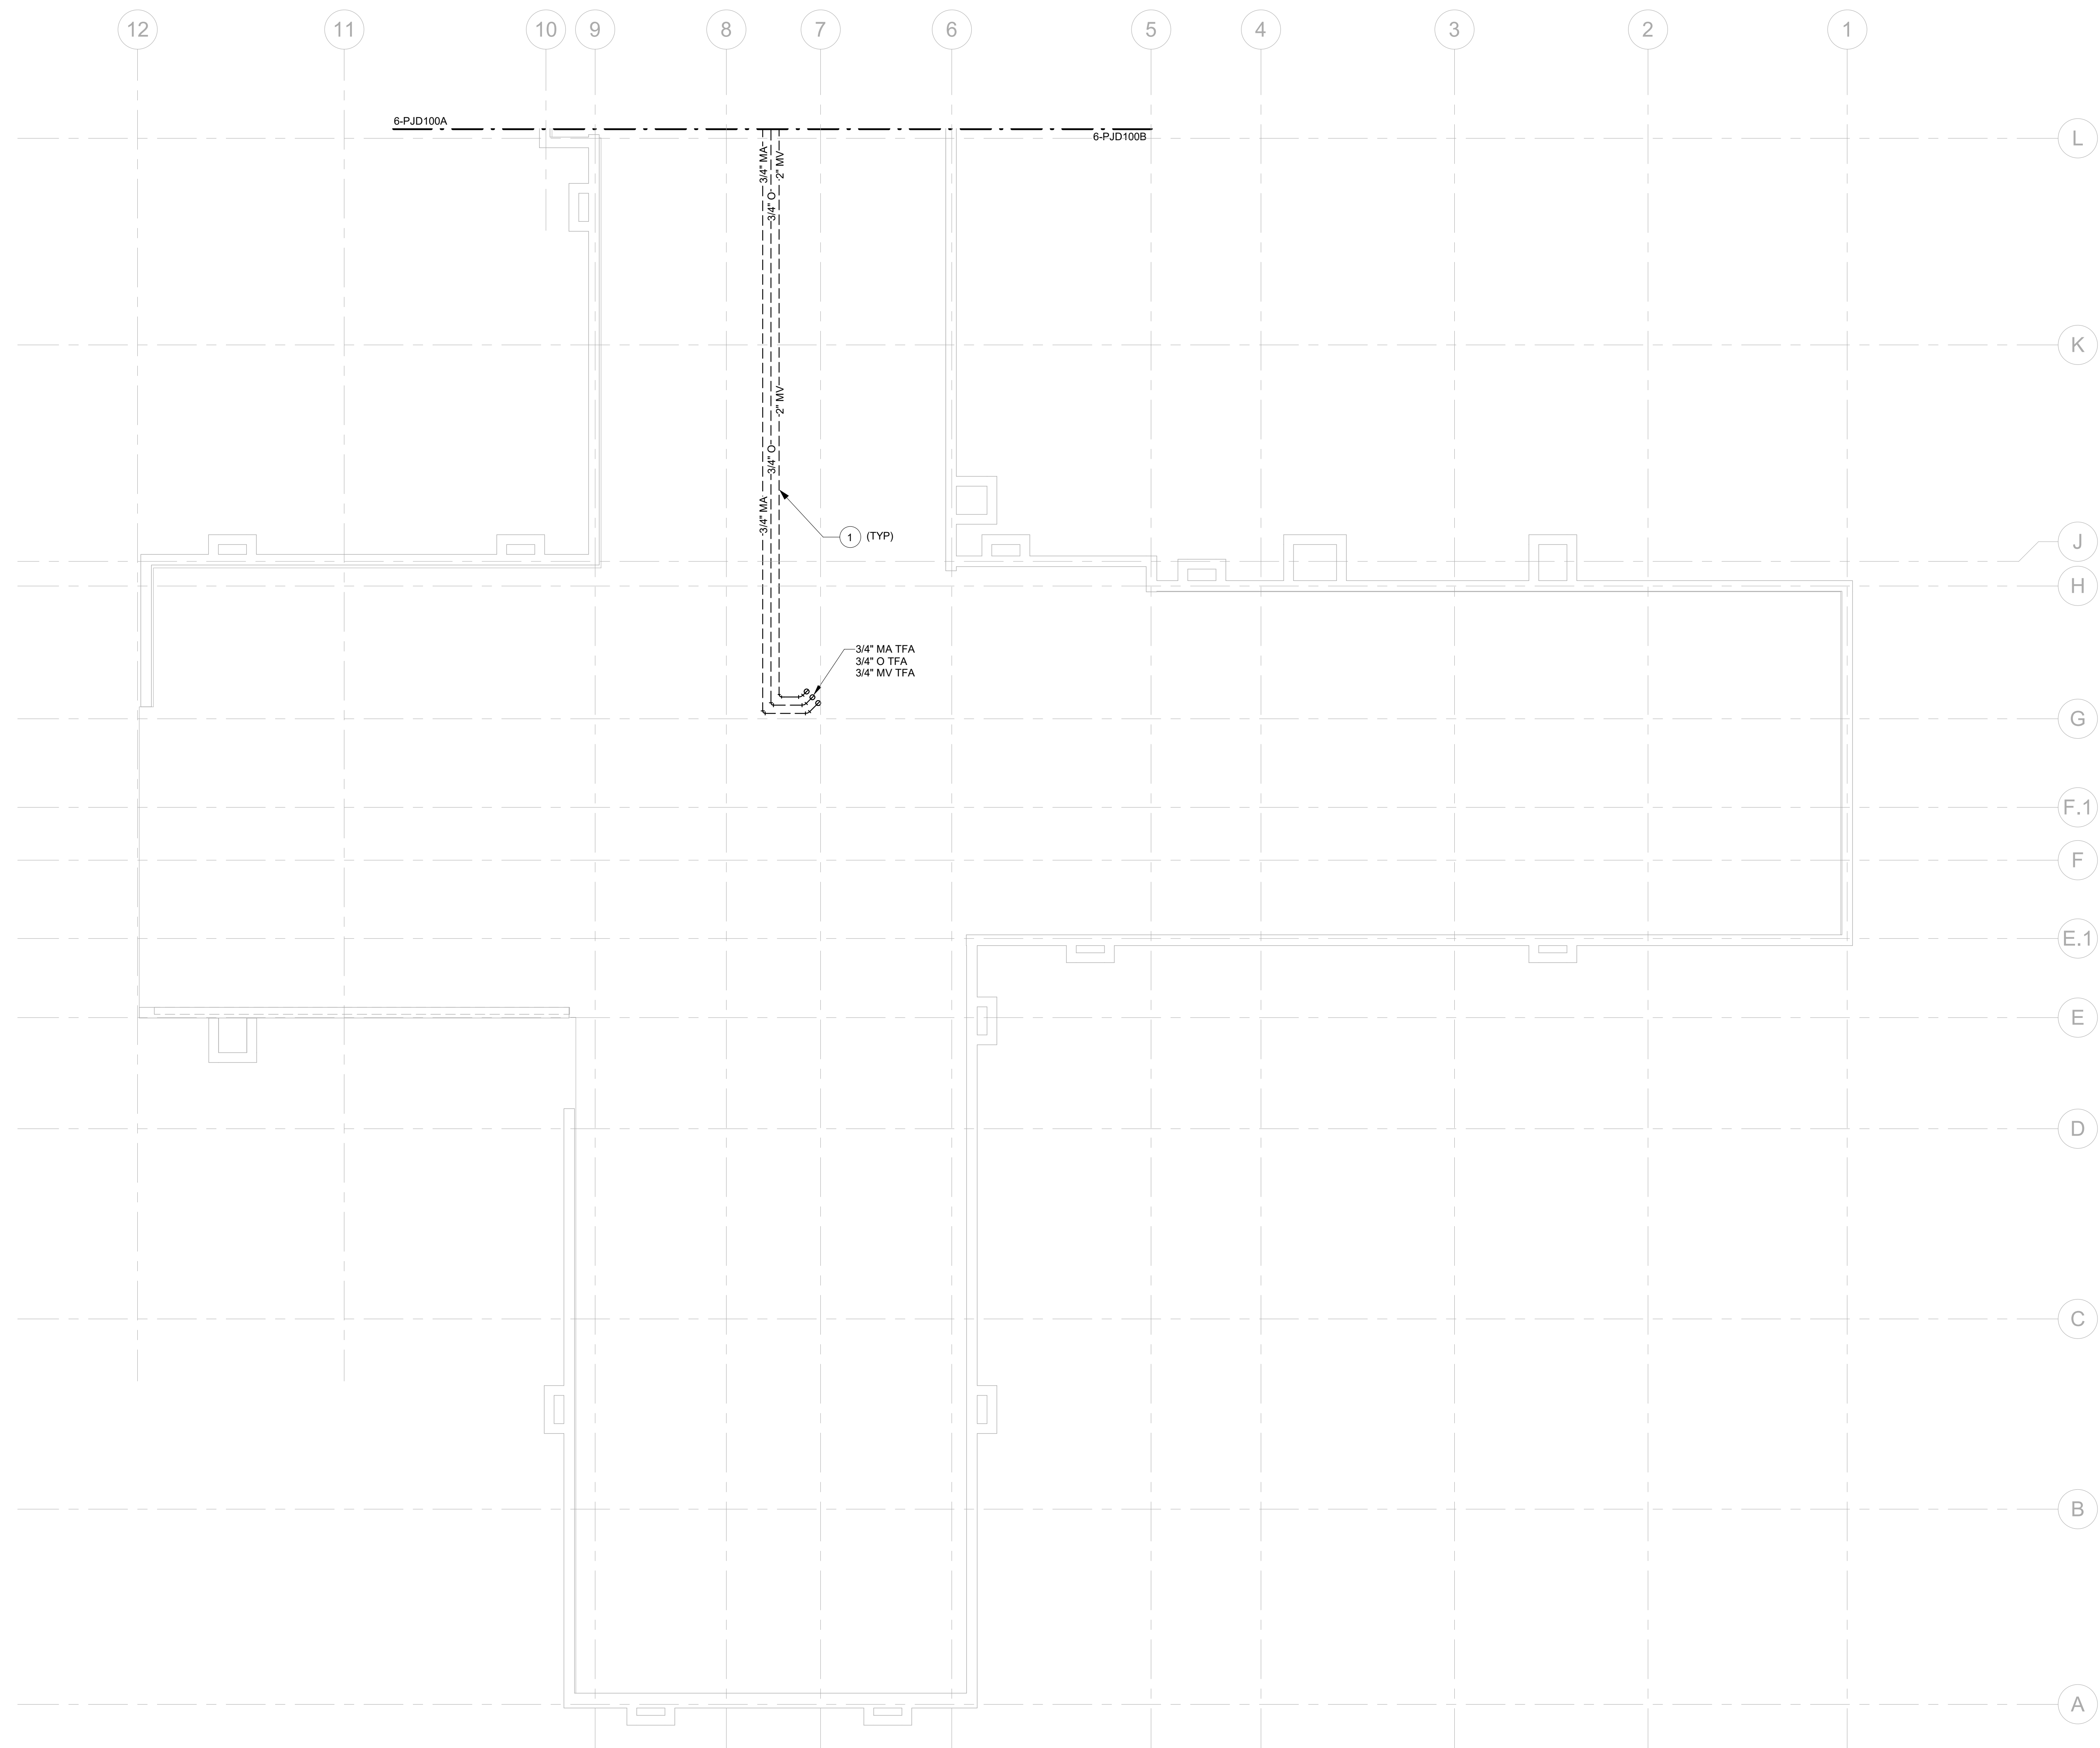
- PLUMBING DEMO PLAN NOTES:**
1. DEMOLISH EXISTING MEDICAL GAS PIPING AND ASSOCIATED ACCESSORIES.
 2. DEMOLISH EXISTING MEDICAL GAS PIPING BACK TO DEMARCATION POINT SHOWN.
 3. DEMOLISH EXISTING MEDICAL GAS PIPING BACK TO TWO (2) FEET FROM WALL.
 4. REMOVE EXISTING CONTROL AIR COMPRESSOR AND ASSOCIATED PIPING AND ACCESSORIES. SALVAGE CONTROL AIR COMPRESSOR TO OWNER. COORDINATE WITH COR FOR DELIVERY.
 5. REMOVE EXISTING MEDICAL VACUUM PUMP. SALVAGE TO OWNER. COORDINATE WITH COR FOR DELIVERY.
 6. EXISTING MEDICAL AIR LINE DISCONNECTED IN CEILING. FIELD VERIFY EXACT LOCATION.

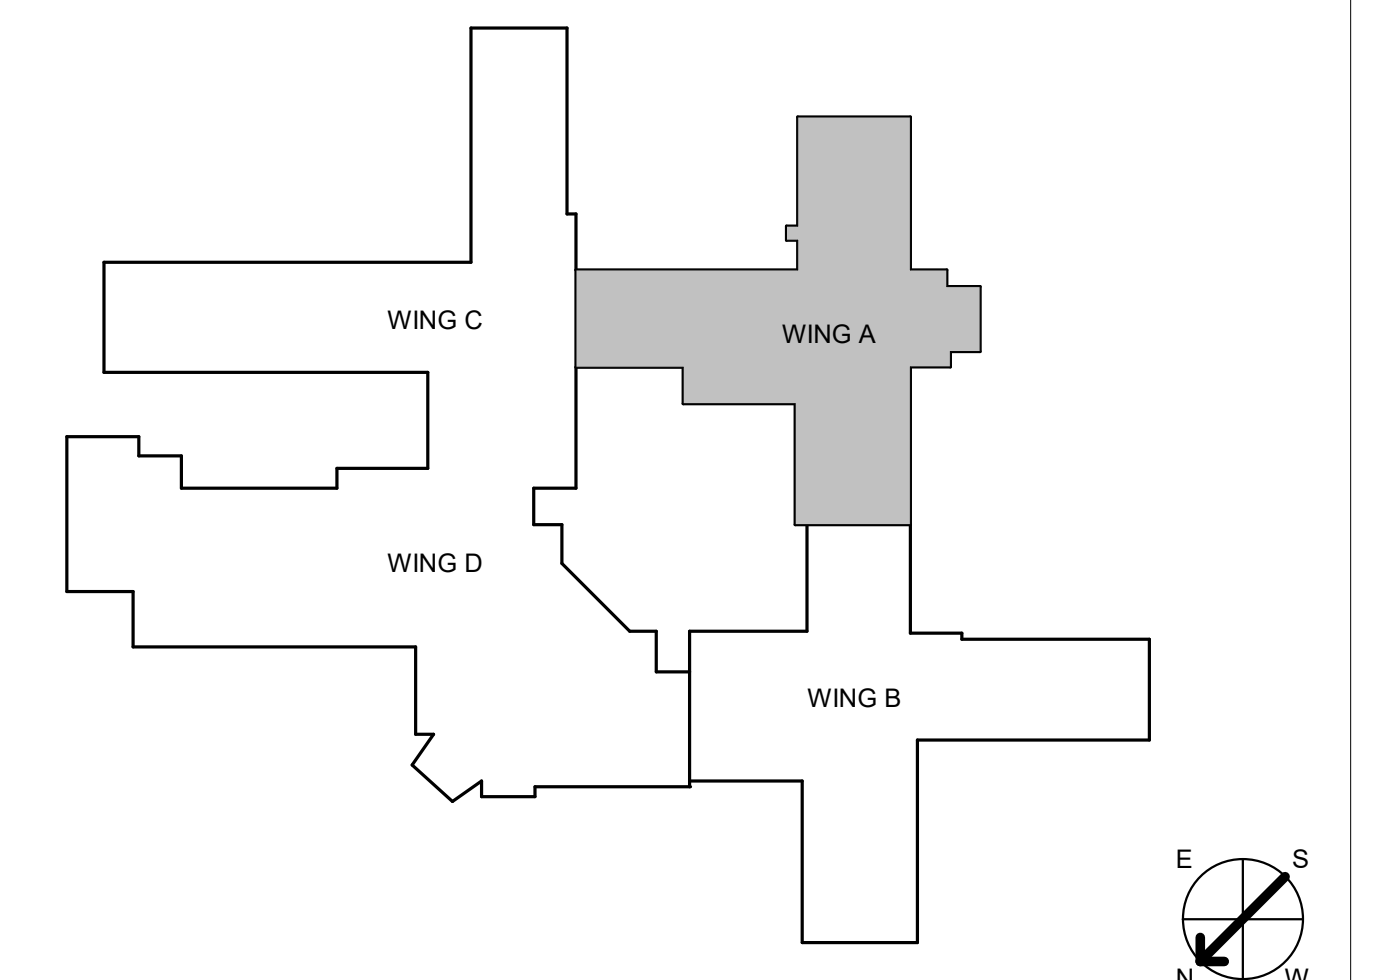

1 MEDICAL GAS DEMO PLAN - BASEMENT WING A FLOOR PLAN
1/8" = 1'-0"

CONSULTANT INFORMATION STRUCTURAL / CIVIL ENGINEER: STAND STRUCTURAL ENGINEERING, 11827 W. 112TH STREET, SUITE 200, OVERLAND PARK, KS 66210 (913) 214-2169 MECHANICAL / ELECTRICAL / PLUMBING / TECHNICAL ENGINEER: SPUR DESIGN, 11020 KING STREET, SUITE 350, OVERLAND PARK, KS 66210 (405) 842-6100 FIRE PROTECTION ENGINEER: POOLE FIRE PROTECTION, INC., 19910 W. 161ST STREET, OLATH, KS 66062 (913) 829-8650			ARCHITECT  513 SW 23th Street, Overland Park, KS 66150 spur-design.com 11020 King Street, Suite 350, Overland Park, KS 66210 spur-design.com 7/10/2019 		Office of Construction and Facilities Management VA U.S. Department of Veteran Affairs		SHEET TITLE: MEDICAL GAS DEMO PLAN - BASEMENT WING A FLOOR PLAN APPROVED: PROJECT DIRECTOR		PROJECT PHASE: BID DOCUMENTS FULLY SPRINKLERED		PROJECT TITLE: RENOVATE A & B WING BUILDING 6 PROJECT LOCATION: 2200 SW GAGE BLVD, TOPEKA, KS 66622 DATE: 07/10/2019 CHECKED BY: JES DRAWN BY: RLC		VA PROJECT NUMBER: 589-A5-19-116 BUILDING NUMBER: 6 DRAWING NUMBER: 6-PJD100A Dwg. 65 OF 160	
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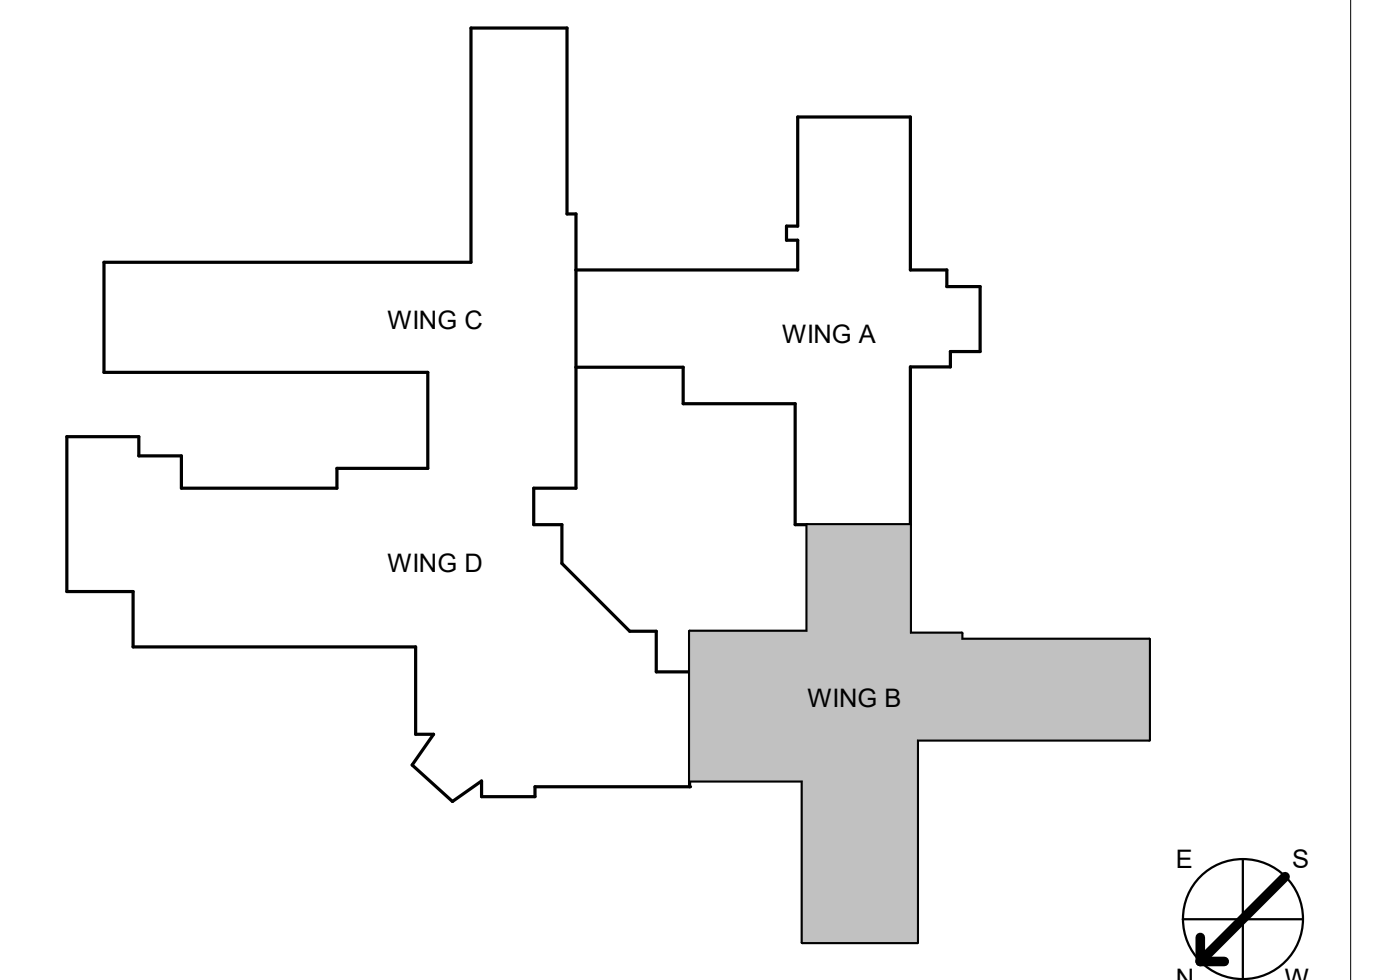
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

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- # PLUMBING DEMO PLAN NOTES:**
1. DEMOLISH EXISTING MEDICAL GAS PIPING AND ASSOCIATED ACCESSORIES.



1 MEDICAL GAS DEMO PLAN - BASEMENT WING B FLOOR PLAN
 1/8" = 1'-0"

CONSULTANT INFORMATION STRUCTURAL / CIVIL ENGINEER STAND STRUCTURAL ENGINEERING 11627 W. 112TH STREET, SUITE 200 OVERLAND PARK, KS 66210 (913) 214-2169		MECHANICAL / ELECTRICAL / PLUMBING / TECHNICAL ENGINEER SPUR DESIGN 11020 KING STREET, SUITE 350 OVERLAND PARK, KS 66210 (405) 842-6100		FIRE PROTECTION ENGINEER POOLE FIRE PROTECTION, INC. 19910 W. 161ST STREET OLATH, KS 66062 (913) 829-8650		ARCHITECT  312 SW 23th Street Overland Park, KS 66209 spur-design.com 11020 King Street, Suite 300 Overland Park, KS 66209 spur-design.com		Office of Construction and Facilities Management VA U.S. Department of Veteran Affairs		SHEET TITLE MEDICAL GAS DEMO PLAN - BASEMENT WING B FLOOR PLAN APPROVED: PROJECT DIRECTOR		PROJECT PHASE BID DOCUMENTS FULLY SPRINKLERED		PROJECT TITLE RENOVATE A & B WING BUILDING 6 PROJECT LOCATION 2200 SW GAGE BLVD TOPEKA, KS 66622		VA PROJECT NUMBER 589-A5-19-116 BUILDING NUMBER 6 DRAWING NUMBER 6-PJD100B Dwg. 66 OF 160	
Revision # Date		KS ARCH REG. NO. A-1139, EXP. 12/31/2019 KS ENGR REG. NO. E-2586, EXP. 12/31/2019				DATE 07/10/2019		CHECKED BY JES		DRAWN BY RLC							

GENERAL DEMO NOTES:



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PLUMBING DEMO PLAN NOTES:

1. DEMOLISH EXISTING MEDICAL GAS PIPING AND ASSOCIATED ACCESSORIES.
2. DEMOLISH EXISTING ZONE VALVE BOX.
3. DEMOLISH EXISTING AREA ALARM PANEL. FIELD VERIFY EXACT LOCATION.



1 MEDICAL GAS DEMO PLAN - LEVEL 1 WING B FLOOR PLAN
 1/8" = 1'-0"

CONSULTANT INFORMATION		
STRUCTURAL / CIVIL ENGINEER	MECHANICAL / ELECTRICAL / PLUMBING / TECHNICAL ENGINEER	FIRE PROTECTION ENGINEER
STAND STRUCTURAL ENGINEERING 11627 W. 112TH STREET, SUITE 200 OVERLAND PARK, KS 66210 (913) 214-2169	SPUR DESIGN 11020 KING STREET, SUITE 350 OVERLAND PARK, KS 66210 (405) 842-6100	POOLE FIRE PROTECTION, INC. 19910 W. 161ST STREET OLATH, KS 66062 (913) 829-8650

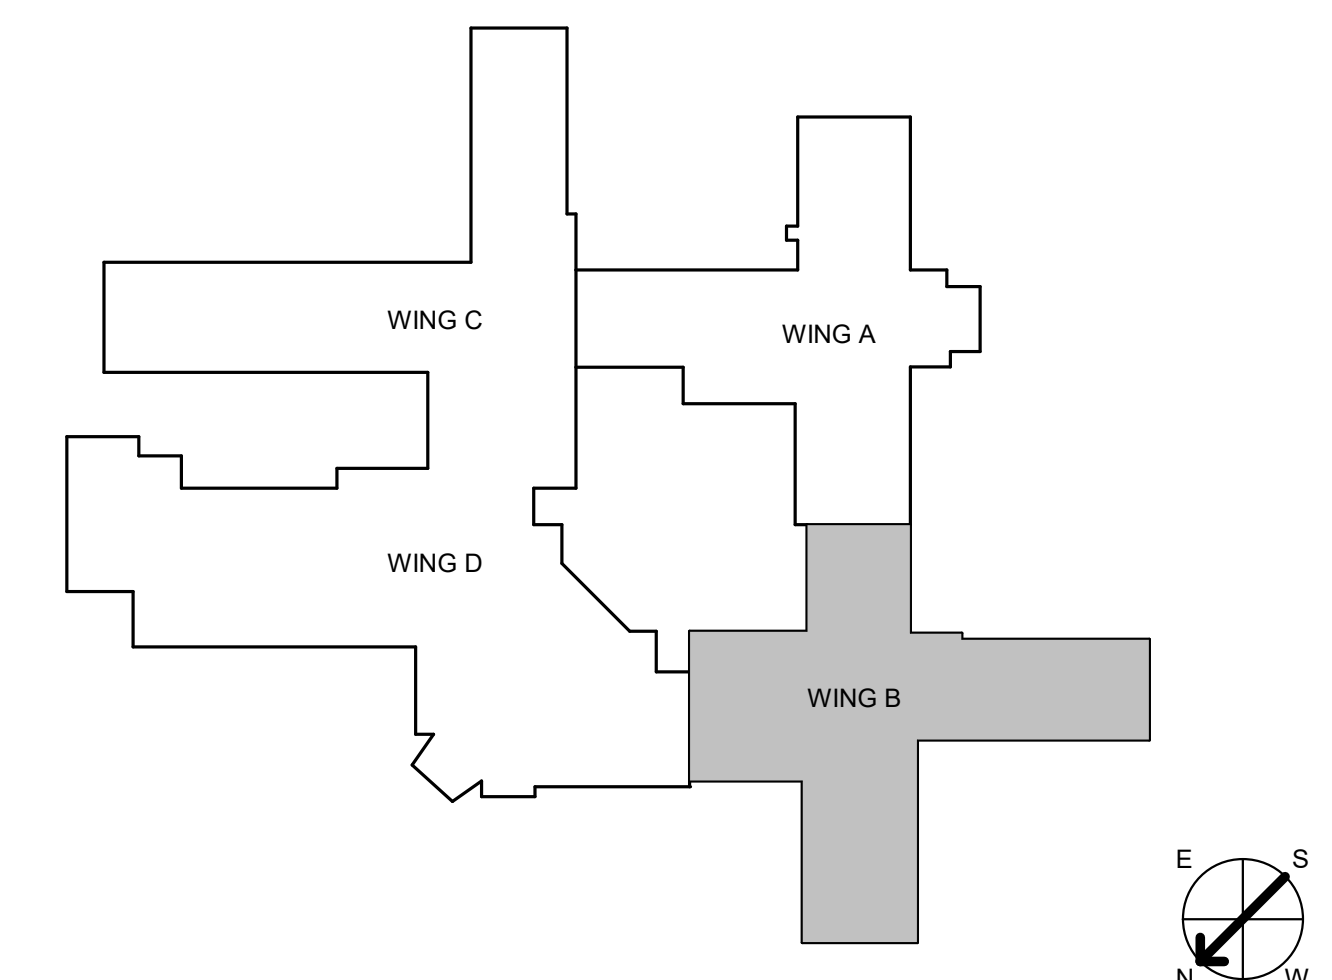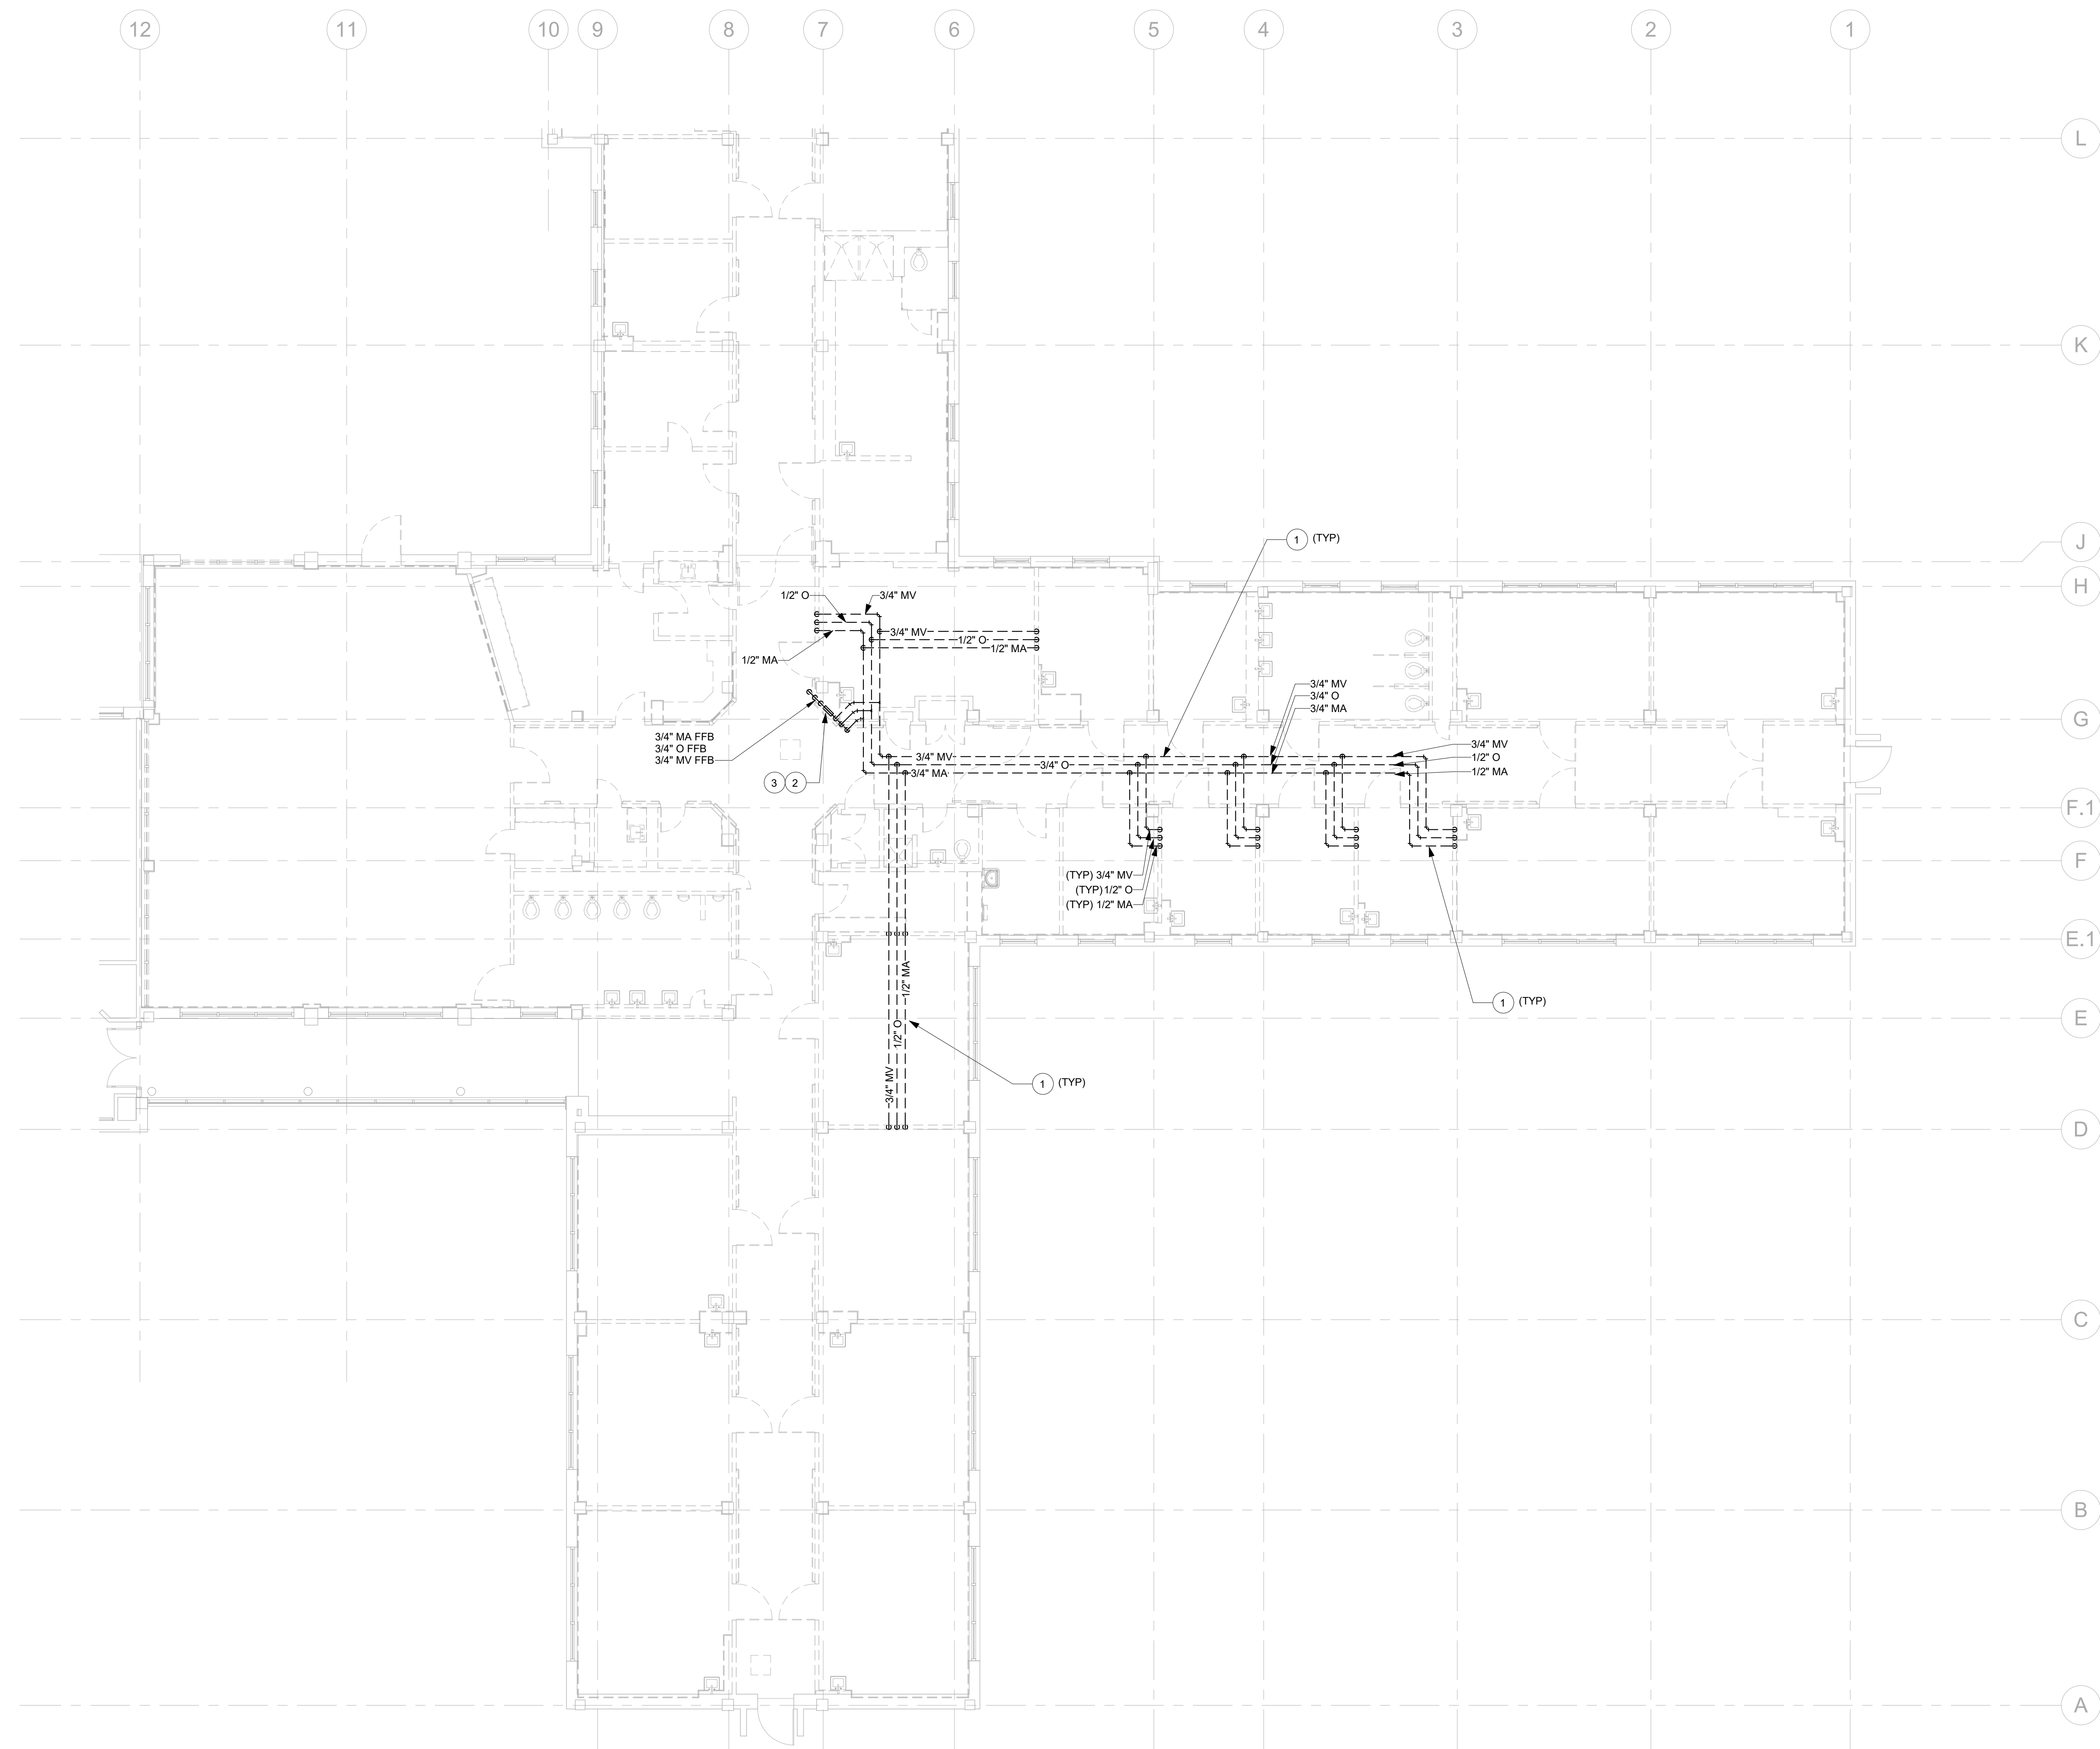ARCHITECT

312 SW 23rd Street
Overland Park, KS 66150
spur-design.com

11020 King Street, Suite 350
Overland Park, KS 66150
spur-design.com

KS ARCH REG. NO. A-1139, EXP. 12/31/2019
KS ENGR REG. NO. E-2586, EXP. 12/31/2019



Office of Construction and Facilities Management


VA U.S. Department of Veteran Affairs

SHEET TITLE MEDICAL GAS DEMO PLAN - LEVEL 1 WING B FLOOR PLAN
APPROVED: PROJECT DIRECTOR

PROJECT PHASE BID DOCUMENTS
FULLY SPRINKLERED

PROJECT TITLE RENOVATE A & B WING BUILDING 6	VA PROJECT NUMBER 589-A5-19-116
PROJECT LOCATION 2200 SW GAGE BLVD TOPEKA, KS 66622	BUILDING NUMBER 6
DATE 07/10/2019	DRAWING NUMBER 6-PJD101B
CHECKED BY JES	Dwg. 67 OF 160
DRAWN BY RLC	

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 one quarter inch = one foot
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 three quarters inch = one foot
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 one and one half inches = one foot
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 nine inches = one foot
 ten inches = one foot
 eleven inches = one foot
 twelve inches = one foot
 thirteen inches = one foot
 fourteen inches = one foot
 fifteen inches = one foot

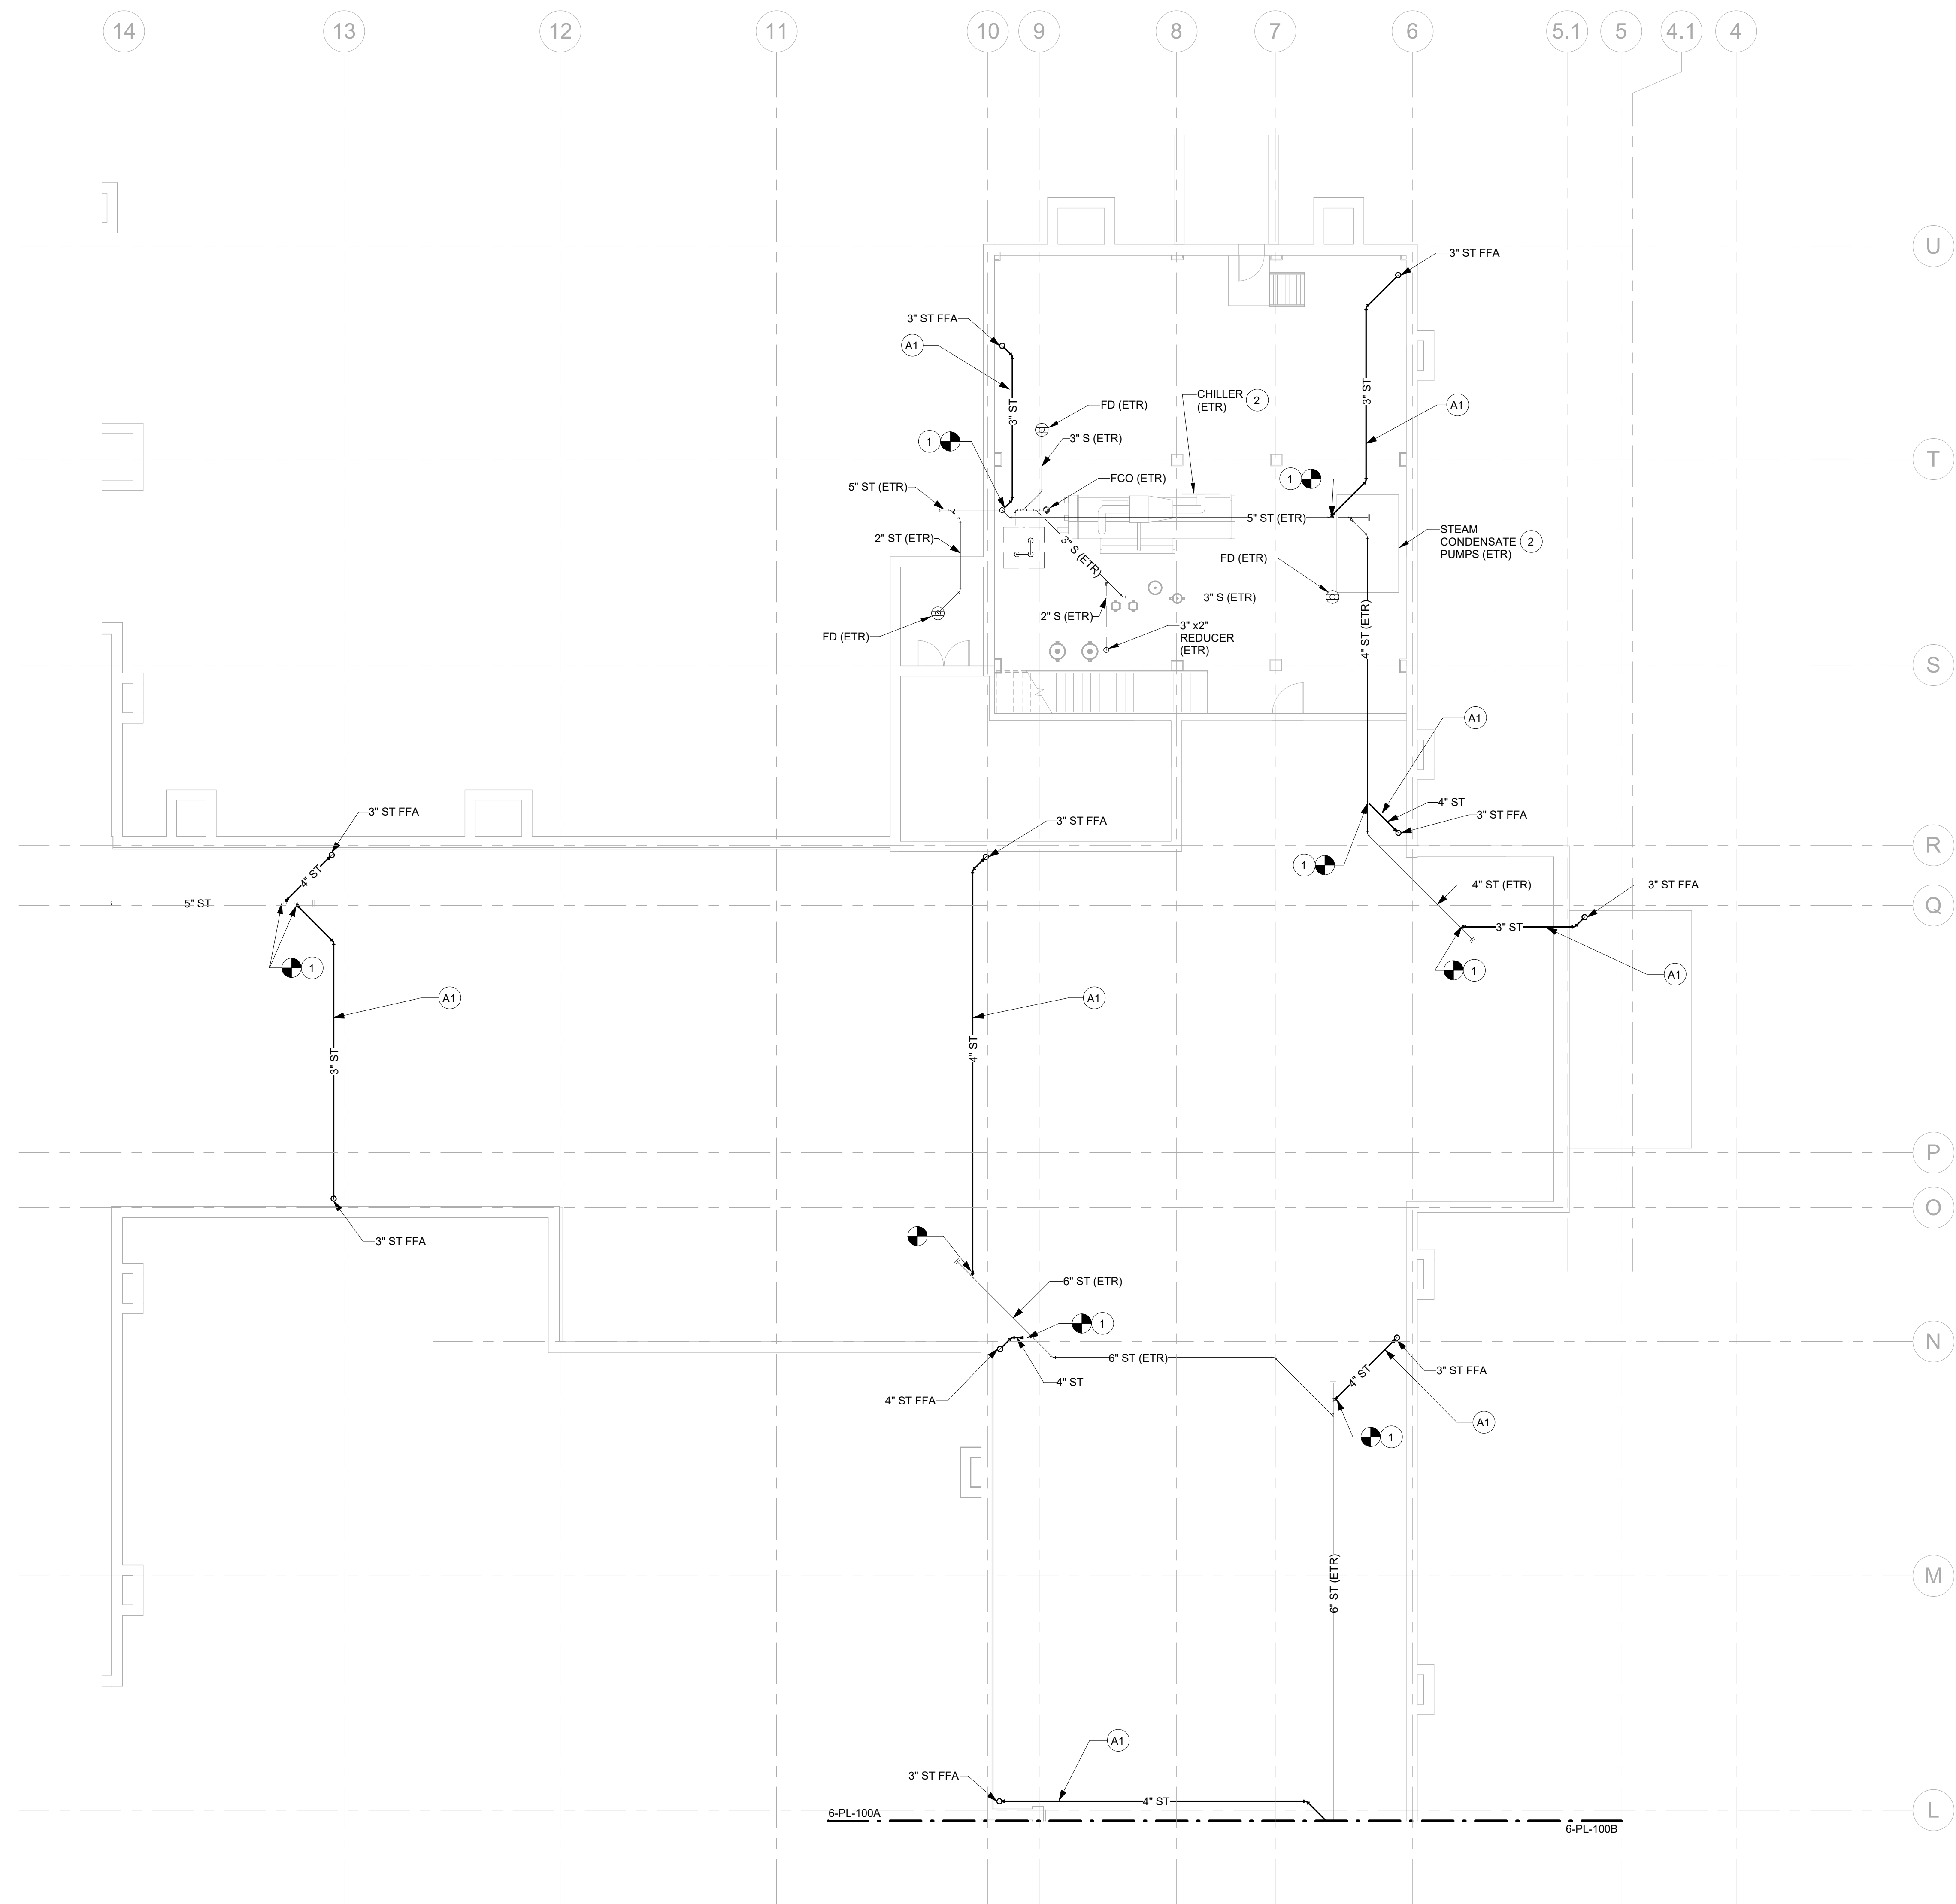

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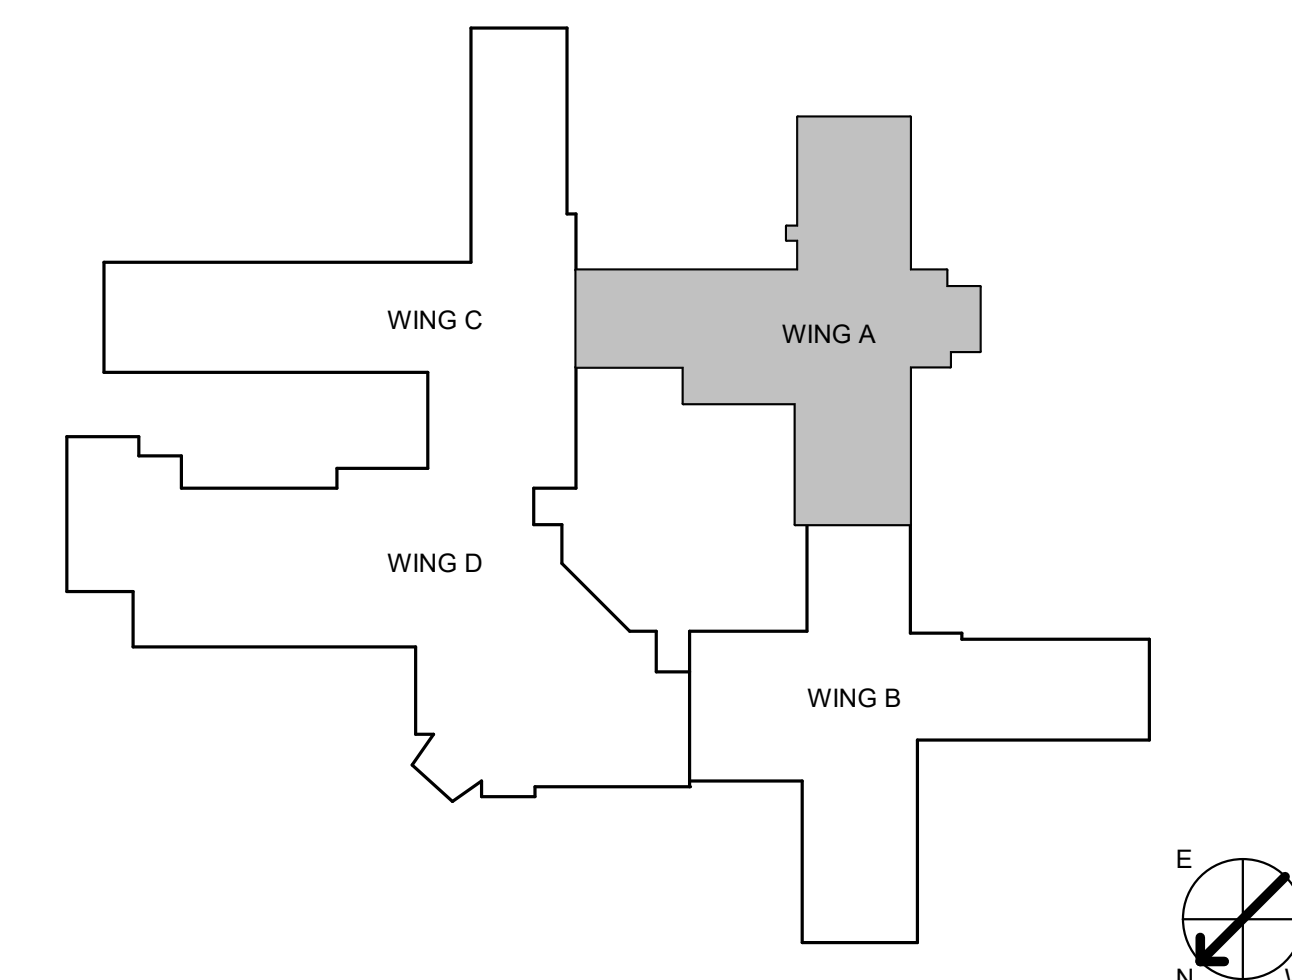
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IN ADDITION, IF THE DEDUCT ALTERNATE IS ELECTED, ALL PLAN WORK ON THIS SHEET IS ALSO SUBJECT TO THE REDUCED AREAS OF WORK AS DEFINED ON ARCHITECTURAL SHEET 6-GI-105.

- PLUMBING PLAN NOTES:**
1. INSTALL STORM PIPING AND CONNECT TO EXISTING PIPING AT DEMARCATION POINT SHOWN.
 2. MECHANICAL EQUIPMENT EXISTING TO REMAIN. COORDINATE NEW PLUMBING WORK WITH EXISTING CONDITIONS. SEE MECHANICAL FOR RELATED INFORMATION.


DEDUCT ALTERNATE NOTES:

A1. IF DEDUCT ALTERNATE IS ACCEPTED, DO NOT PROVIDE NEW STORM PIPING.



1 PLUMBING WASTE PLAN - BASEMENT WING A FLOOR PLAN
 1/8" = 1'-0"

CONSULTANT INFORMATION STRUCTURAL / CIVIL ENGINEER STAND STRUCTURAL ENGINEERING 11927 W. 112TH STREET, SUITE 200 OVERLAND PARK, KS 66210 (913) 214-2169			MECHANICAL / ELECTRICAL / PLUMBING / TECHNICAL ENGINEER SPUR DESIGN 11020 KING STREET, SUITE 350 OVERLAND PARK, KS 66210 (405) 842-6100			FIRE PROTECTION ENGINEER POOLE FIRE PROTECTION, INC. 19910 W. 161ST STREET OLATH, KS 66062 (913) 829-8650			ARCHITECT 513 5th Street Overland Park, KS 66150 spur-design.com 11020 King Street, Suite 350 Overland Park, KS 66210 spur-design.com			Office of Construction and Facilities Management VA U.S. Department of Veteran Affairs 			SHEET TITLE PLUMBING WASTE PLAN - BASEMENT WING A FLOOR PLAN APPROVED: PROJECT DIRECTOR			PROJECT PHASE BID DOCUMENTS FULLY SPRINKLERED			PROJECT TITLE RENOVATE A & B WING BUILDING 6 PROJECT LOCATION 2200 SW GAGE BLVD TOPEKA, KS 66622			VA PROJECT NUMBER 589-A5-19-116 BUILDING NUMBER 6 DRAWING NUMBER 6-PL-100A Dwg. 68 OF 160		
Revision #		Date		DATE 07/10/2019		CHECKED BY JES		DRAWN BY RLC																		

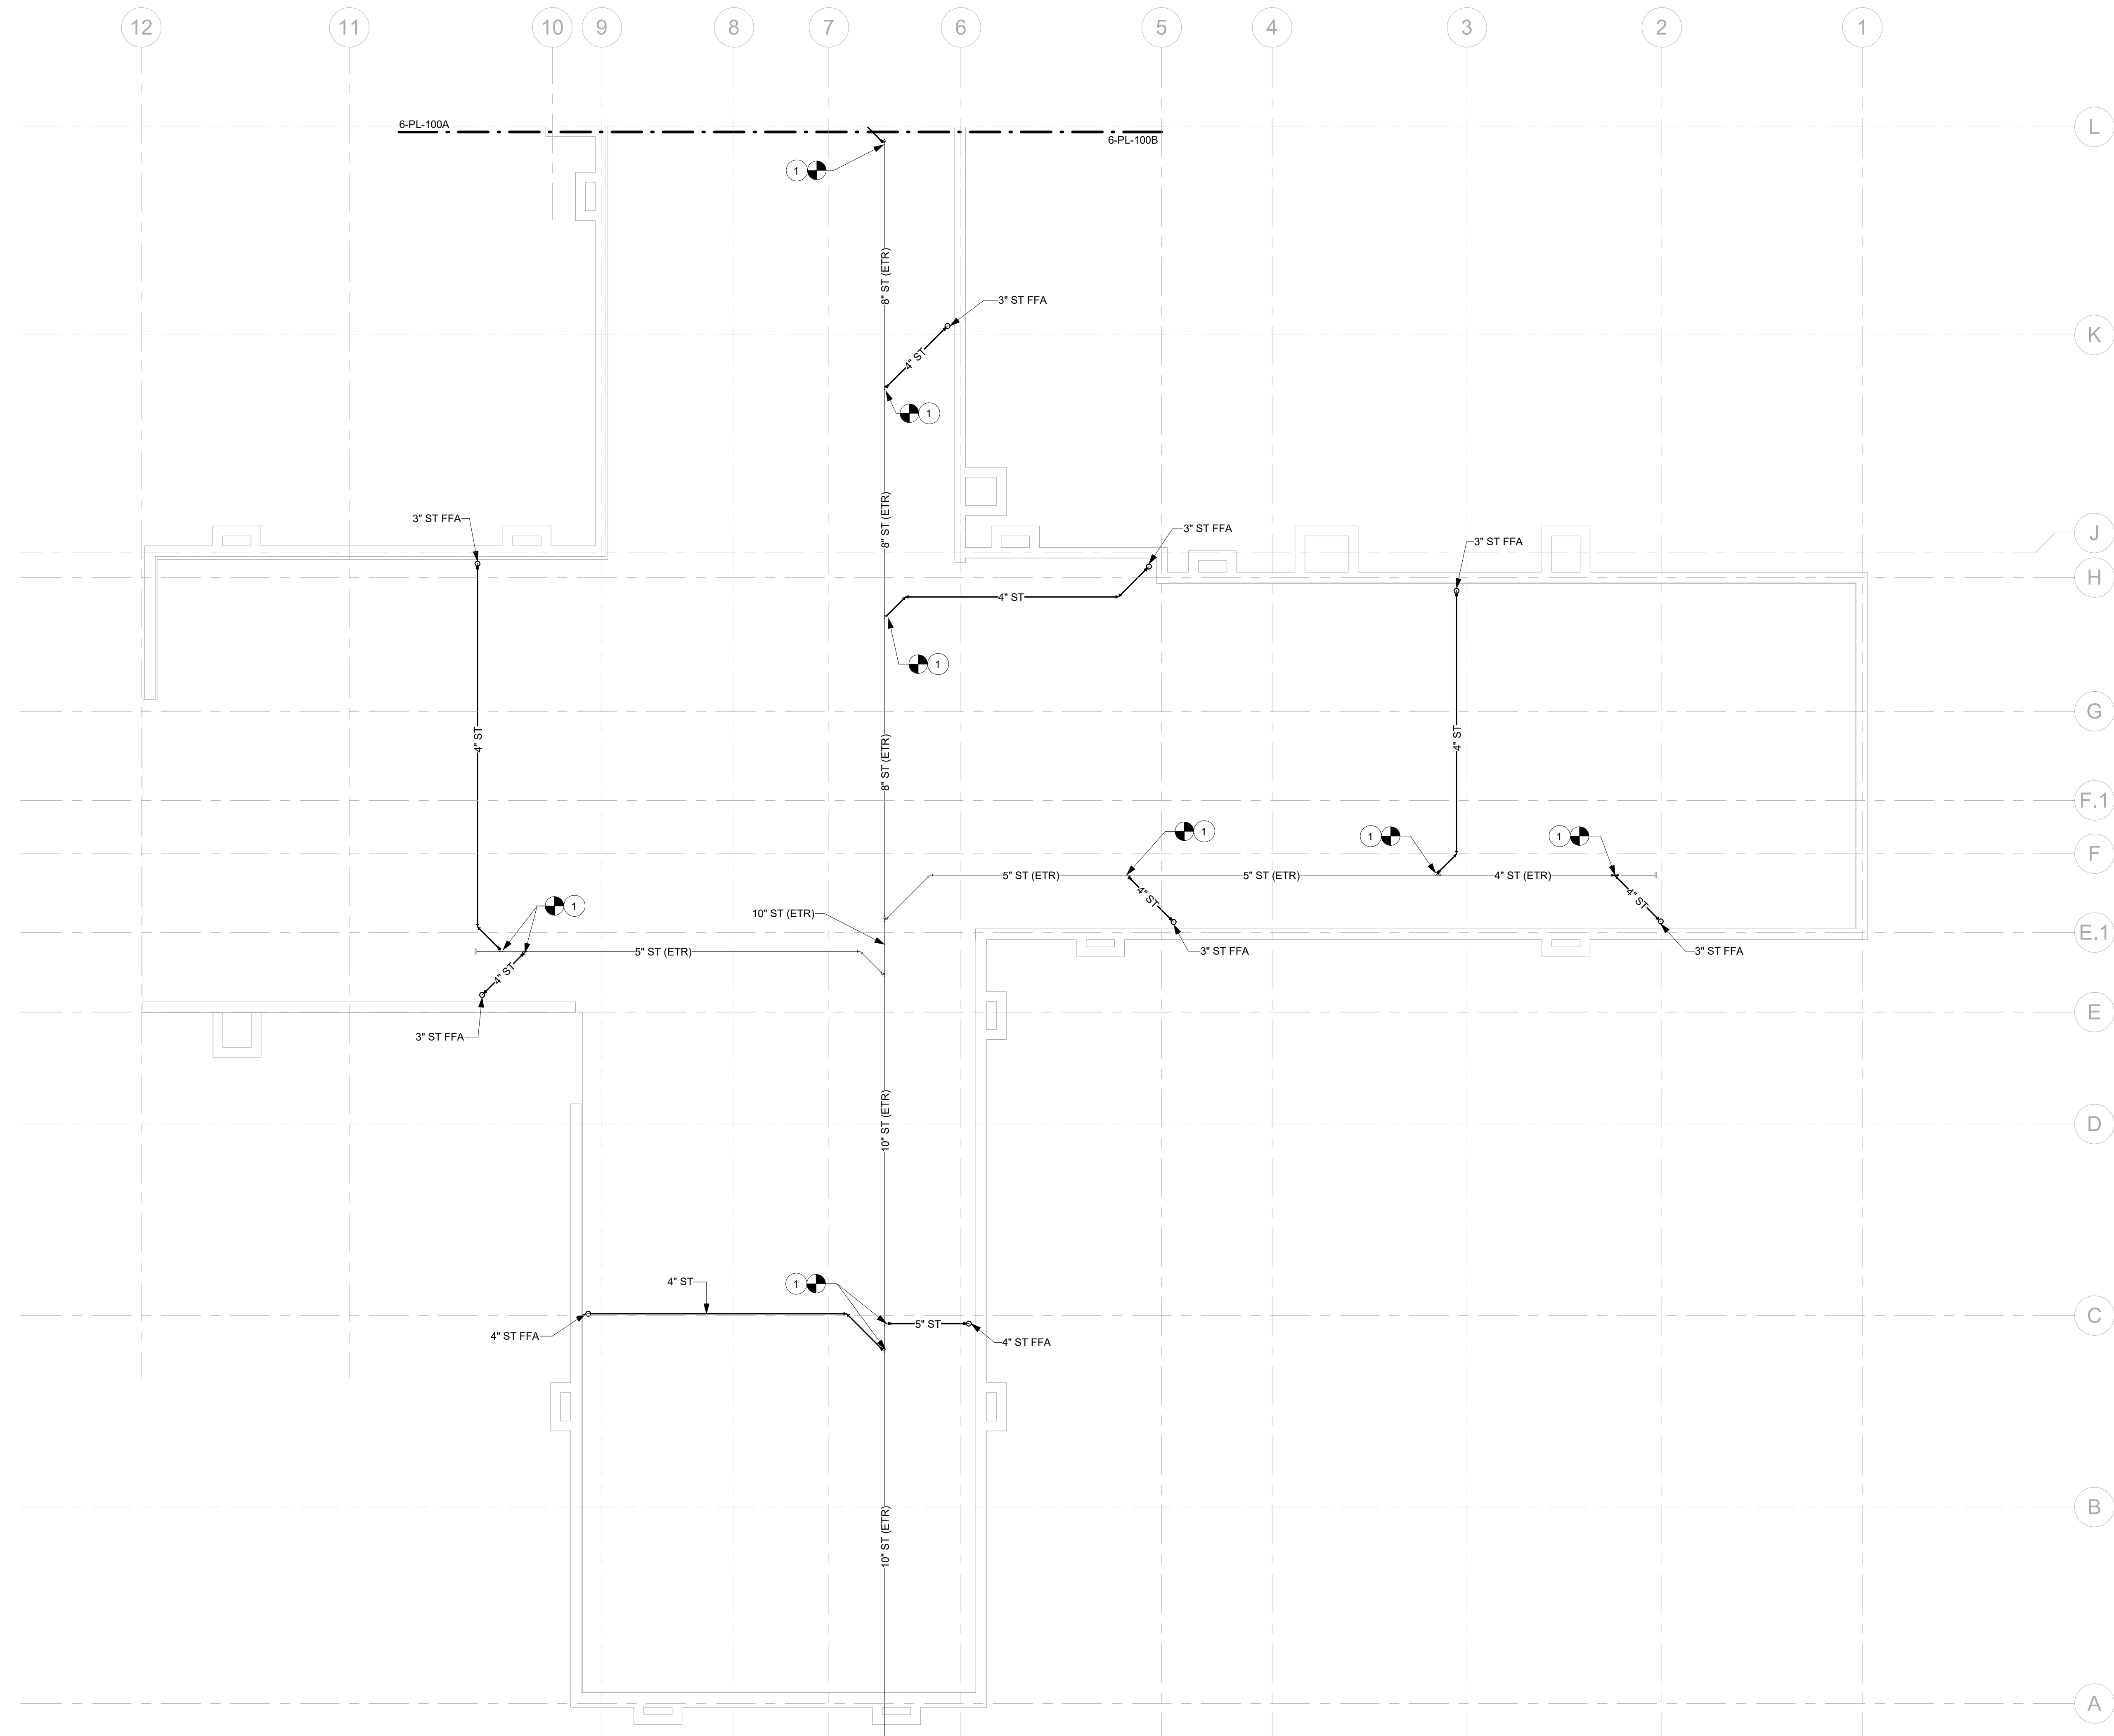

- GENERAL NOTES:**
1. THE AREA OF WORK SHOWN IS ASSOCIATED WITH AN OPERATING FACILITY THAT MUST REMAIN IN SERVICE 24/7.
 2. SEE SHEET 6I-001 FOR ADDITIONAL INFORMATION REGARDING SCHEDULE AND PHASING REQUIREMENTS. SCHEDULE WORK TO MINIMIZE DISRUPTION OF SERVICES.
 3. COORDINATE WORK SCHEDULE WITH THE CONTRACTING OFFICER'S REPRESENTATIVE (COR) BEFORE THE START OF WORK.
 4. COORDINATE PLUMBING WORK WITH OTHER TRADES AND CONTRACTORS. VERIFY ALL EXISTING CONDITIONS BEFORE THE START OF WORK.
 5. COORDINATE TEMPORARY ROOF DRAINAGE DURING CONSTRUCTION AND REPLACEMENT OF STORM PIPE.

DEDUCT ALTERNATE & PHASING:


ALL PLAN WORK SHOWN ON THIS SHEET IS SUBJECT TO THE OVERALL PROJECT PHASING SEQUENCE OUTLINED ON ARCHITECTURAL SHEET 6-GI-102.

IN ADDITION, IF THE DEDUCT ALTERNATE IS ELECTED, ALL PLAN WORK ON THIS SHEET IS ALSO SUBJECT TO THE REDUCED AREAS OF WORK AS DEFINED ON ARCHITECTURAL SHEET 6-GI-105.


- PLUMBING PLAN NOTES:**
1. INSTALL STORM PIPING AND CONNECT TO EXISTING PIPING AT DEMARCATION POINT SHOWN.

three inches = one foot
 one and one-half inches = one foot
 one inch = one foot
 three-quarters inch = one foot
 one-half inch = one foot
 three-eighths inch = one foot
 one-quarter inch = one foot
 one-eighth inch = one foot

1 PLUMBING WASTE PLAN - BASEMENT WING B FLOOR PLAN
 1/8" = 1'-0"

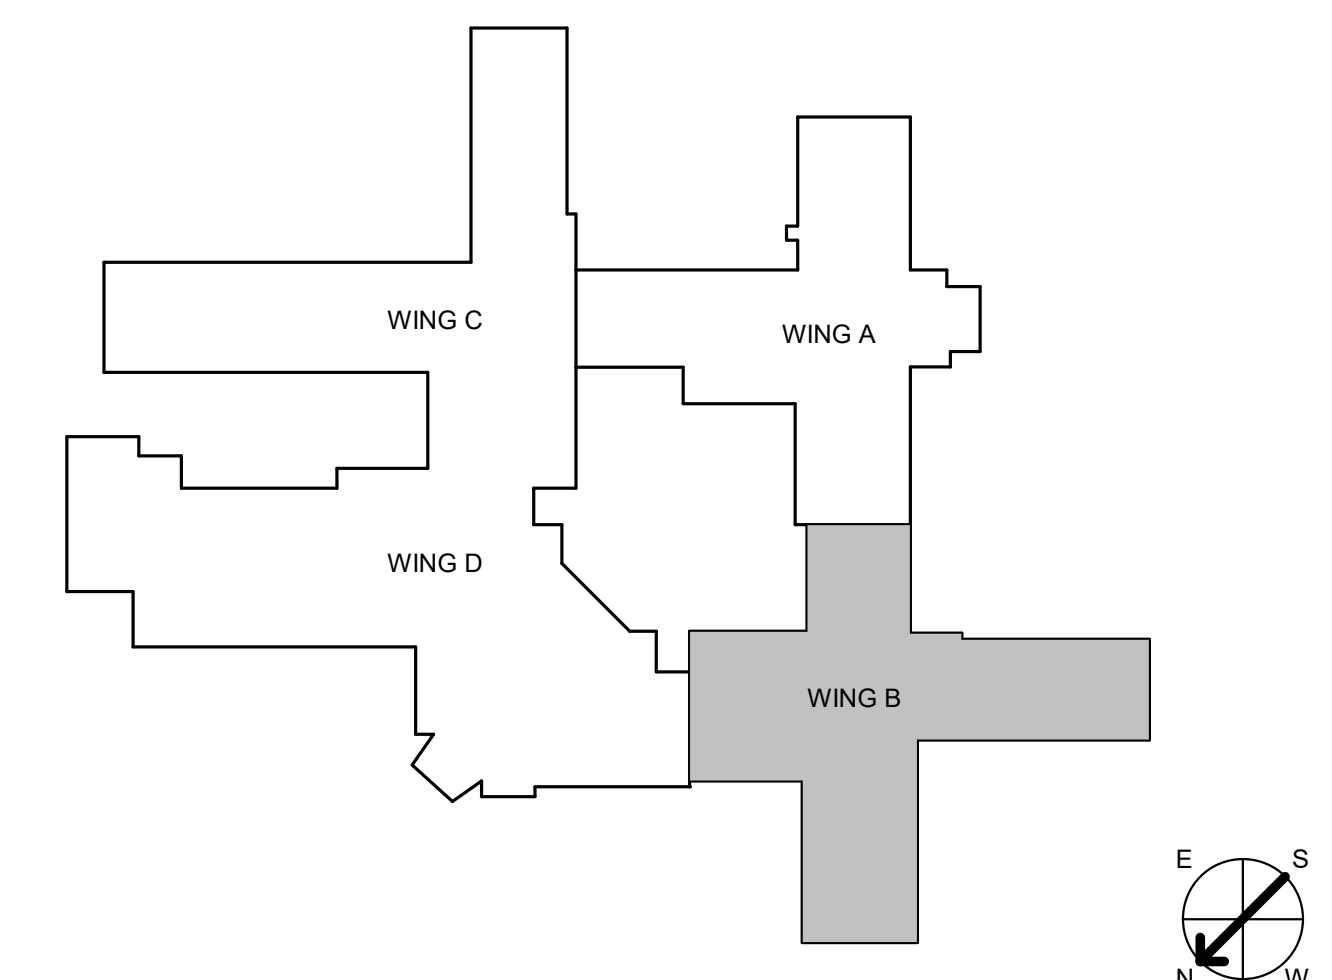

CONSULTANT INFORMATION STRUCTURAL / CIVIL ENGINEER STAND STRUCTURAL ENGINEERING 11627 W. 112TH STREET, SUITE 200 OVERLAND PARK, KS 66210 (913) 214-2169		MECHANICAL / ELECTRICAL / PLUMBING / TECHNICAL ENGINEER SPUR DESIGN 11020 KING STREET, SUITE 350 OVERLAND PARK, KS 66210 (405) 842-6100		FIRE PROTECTION ENGINEER POOLE FIRE PROTECTION, INC. 19910 W. 161ST STREET OLATH, KS 66062 (913) 829-8650		ARCHITECT 513 SW 23th Street Overland Park, KS 66150 spur-design.com 10202 King Street, Suite 300 Overland Park, KS 66150 spur-design.com		Office of Construction and Facilities Management VA U.S. Department of Veteran Affairs		SHEET TITLE PLUMBING WASTE PLAN - BASEMENT WING B FLOOR PLAN APPROVED: PROJECT DIRECTOR		PROJECT PHASE BID DOCUMENTS FULLY SPRINKLERED		PROJECT TITLE RENOVATE A & B WING BUILDING 6 PROJECT LOCATION 2200 SW GAGE BLVD TOPEKA, KS 66622		VA PROJECT NUMBER 589-A5-19-116 BUILDING NUMBER 6 DRAWING NUMBER 6-PL-100B Dwg. 69 OF 160	
Revision # Date																	

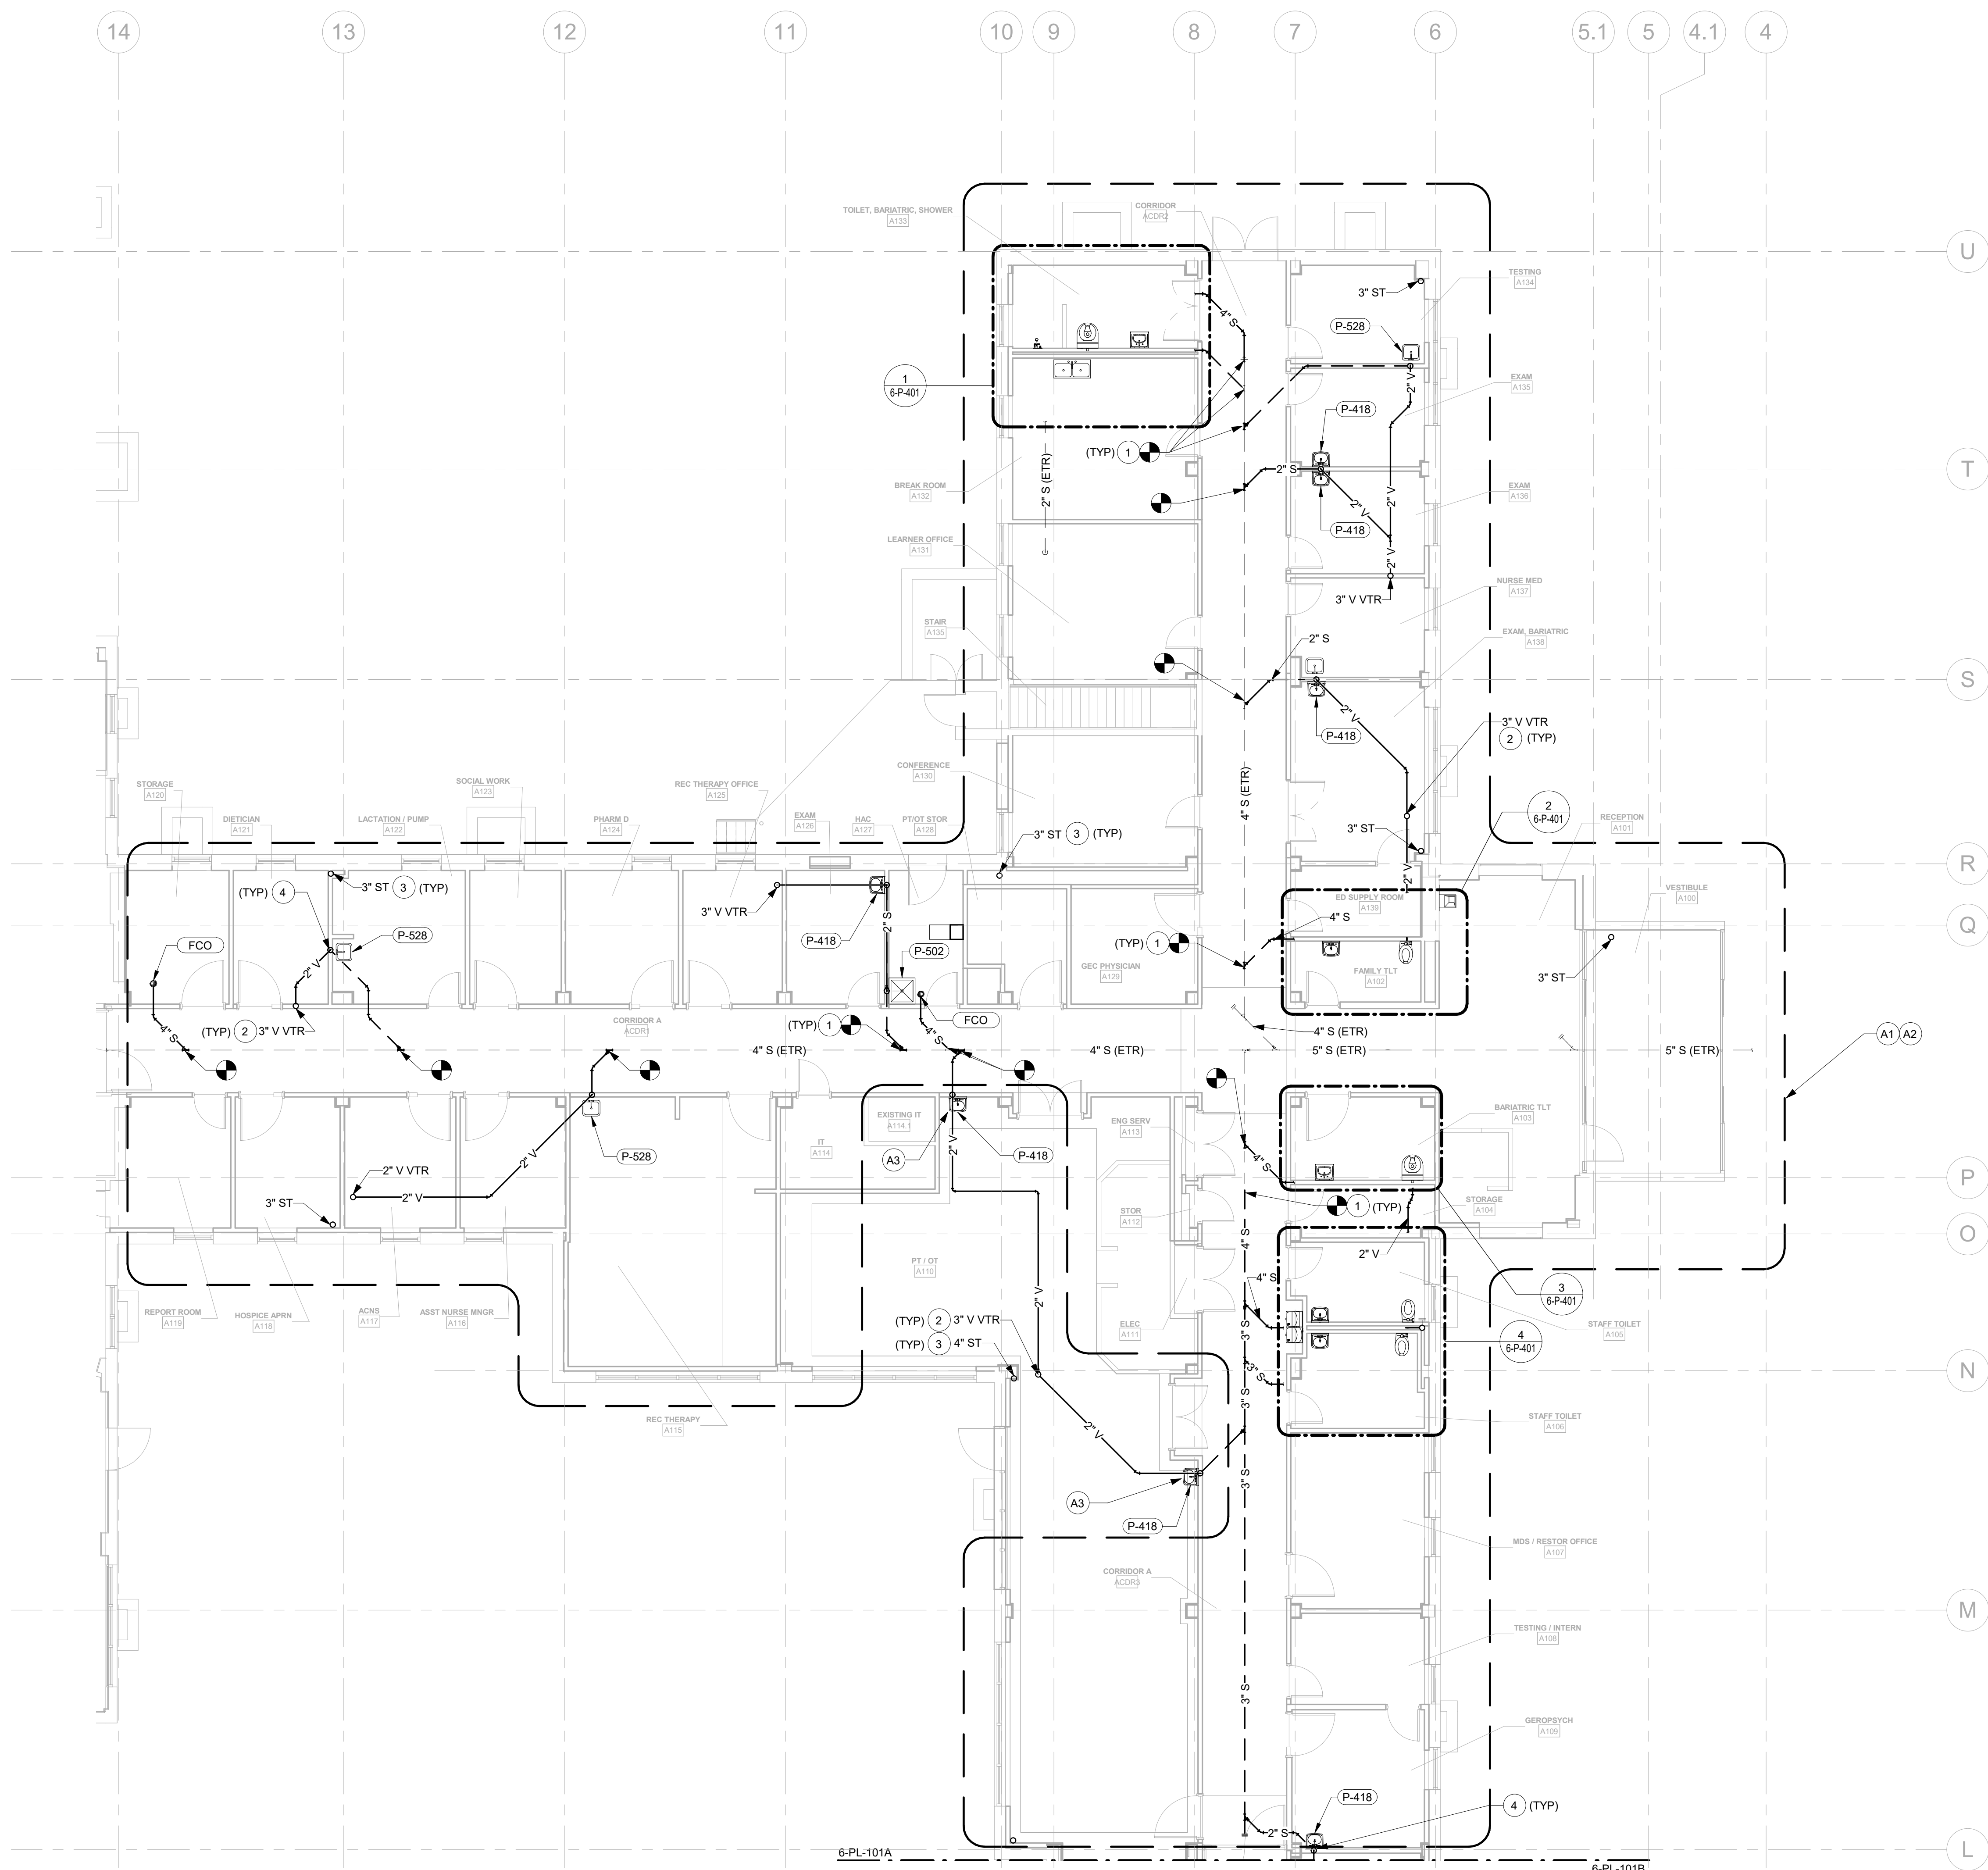

1 PLUMBING WASTE PLAN - LEVEL 1 WING A FLOOR PLAN
1/8" = 1'-0"


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 5. COORDINATE TEMPORARY ROOF DRAINAGE DURING CONSTRUCTION AND REPLACEMENT OF STORM PIPE.

DEDUCT ALTERNATE & PHASING:

ALL PLAN WORK SHOWN ON THIS SHEET IS SUBJECT TO THE OVERALL PROJECT PHASING SEQUENCE OUTLINED ON ARCHITECTURAL SHEET 6-GI-102.

IN ADDITION, IF THE DEDUCT ALTERNATE IS ELECTED, ALL PLAN WORK ON THIS SHEET IS ALSO SUBJECT TO THE REDUCED AREAS OF WORK AS DEFINED ON ARCHITECTURAL SHEET 6-GI-105.

- # PLUMBING PLAN NOTES:**
1. INSTALL SANITARY WASTE PIPING AND CONNECT TO EXISTING PIPING AT DEMARCATION POINT SHOWN.
 2. INSTALL SANITARY VENT PIPING TO VENT THROUGH ROOF. PROVIDE VTR AS SHOWN ON SHEET 6-P-102A. VTR MUST BE A MINIMUM OF 25 FEET AWAY FROM ANY FRESH AIR INTAKES.
 3. INSTALL STORM PIPING AND CONNECT TO EXISTING ROOF DRAIN.
 4. COORDINATE ALL FLOOR PENETRATIONS WITH EXISTING WAFFLE SLAB.
- # DEDUCT ALTERNATE NOTES:**
- A1. IF DEDUCT ALTERNATE IS ACCEPTED, DO NOT PROVIDE NEW STORM PIPING.
 - A2. IF DEDUCT ALTERNATE IS ACCEPTED, DO NOT PROVIDE NEW PLUMBING FIXTURES AND ASSOCIATED SANITARY WASTE AND VENT PIPING.
 - A3. IF DEDUCT ALTERNATE IS ACCEPTED, PROVIDE NEW SANITARY WASTE AND VENT PIPING AS SHOWN.

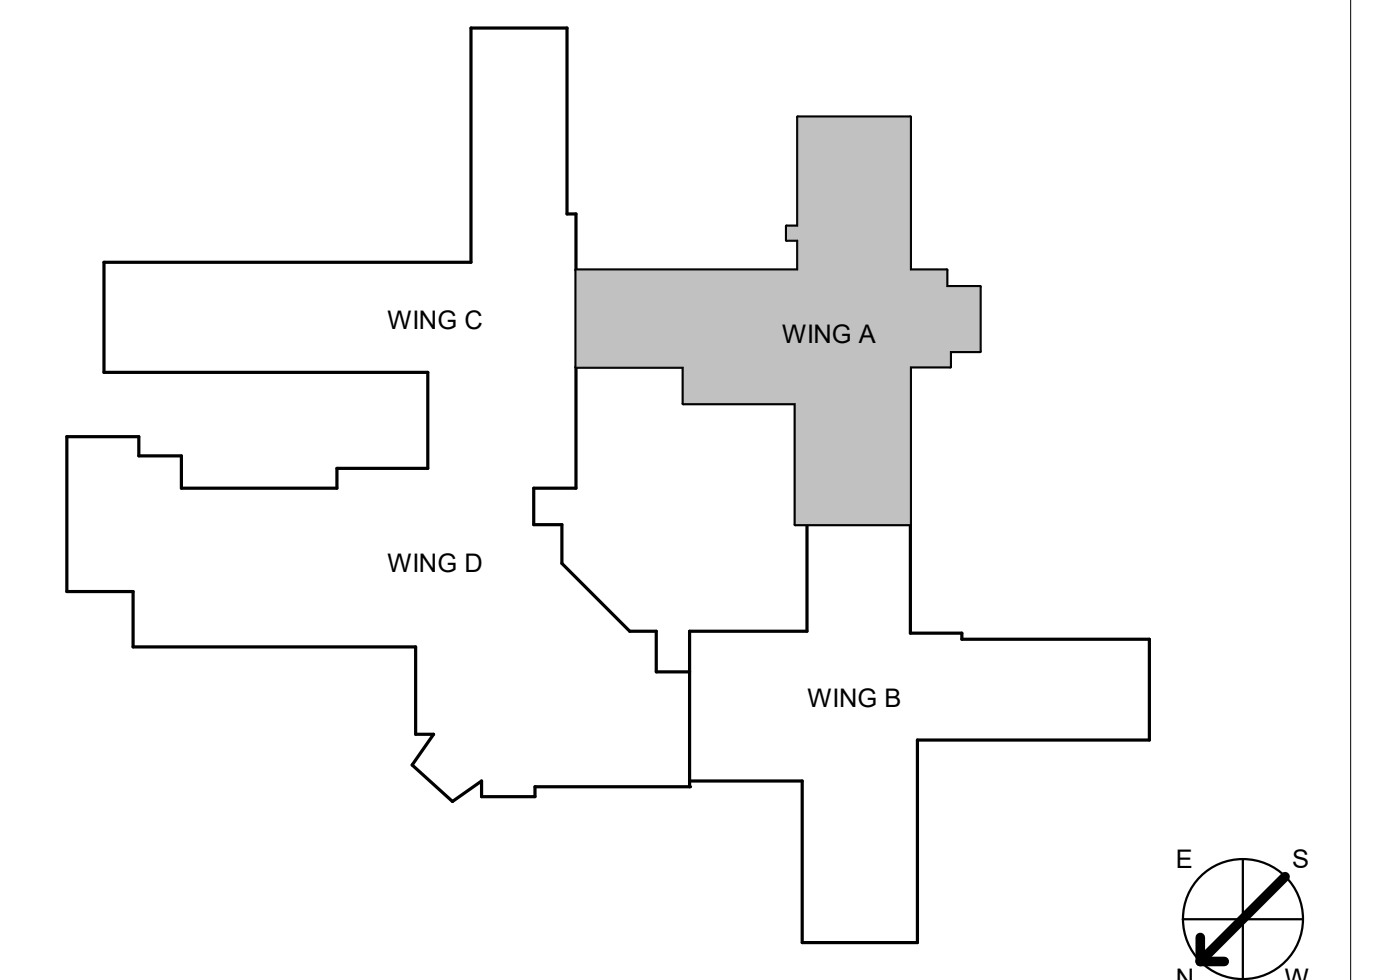

CONSULTANT INFORMATION		
STRUCTURAL / CIVIL ENGINEER	MECHANICAL / ELECTRICAL / PLUMBING / TECHNICAL ENGINEER	FIRE PROTECTION ENGINEER
STAND STRUCTURAL ENGINEERING 11227 W. 112TH STREET, SUITE 200 OVERLAND PARK, KS 66210 (913) 214-2169	SPUR DESIGN 11020 KING STREET, SUITE 350 OVERLAND PARK, KS 66210 (405) 842-6100	POOLE FIRE PROTECTION, INC. 19910 W. 161ST STREET OLATH, KS 66062 (913) 829-8650

ARCHITECT

SPUR DESIGN

313 5th Street
Overland Park, KS 66101
spur-design.com

11020 King Street, Suite 350
Overland Park, KS 66101
spur-design.com




Office of Construction and Facilities Management

VA U.S. Department of Veteran Affairs

SHEET TITLE PLUMBING WASTE PLAN - LEVEL 1 WING A FLOOR PLAN	PROJECT PHASE BID DOCUMENTS
APPROVED: PROJECT DIRECTOR	FULLY SPRINKLERED

PROJECT TITLE RENOVATE A & B WING BUILDING 6	VA PROJECT NUMBER 589-A5-19-116
PROJECT LOCATION 2200 SW GAGE BLVD TOPEKA, KS 66622	BUILDING NUMBER 6
DATE 07/10/2019	DRAWING NUMBER 6-PL-101A
CHECKED BY JES	Dwg. 70 OF 160
DRAWN BY RLC	

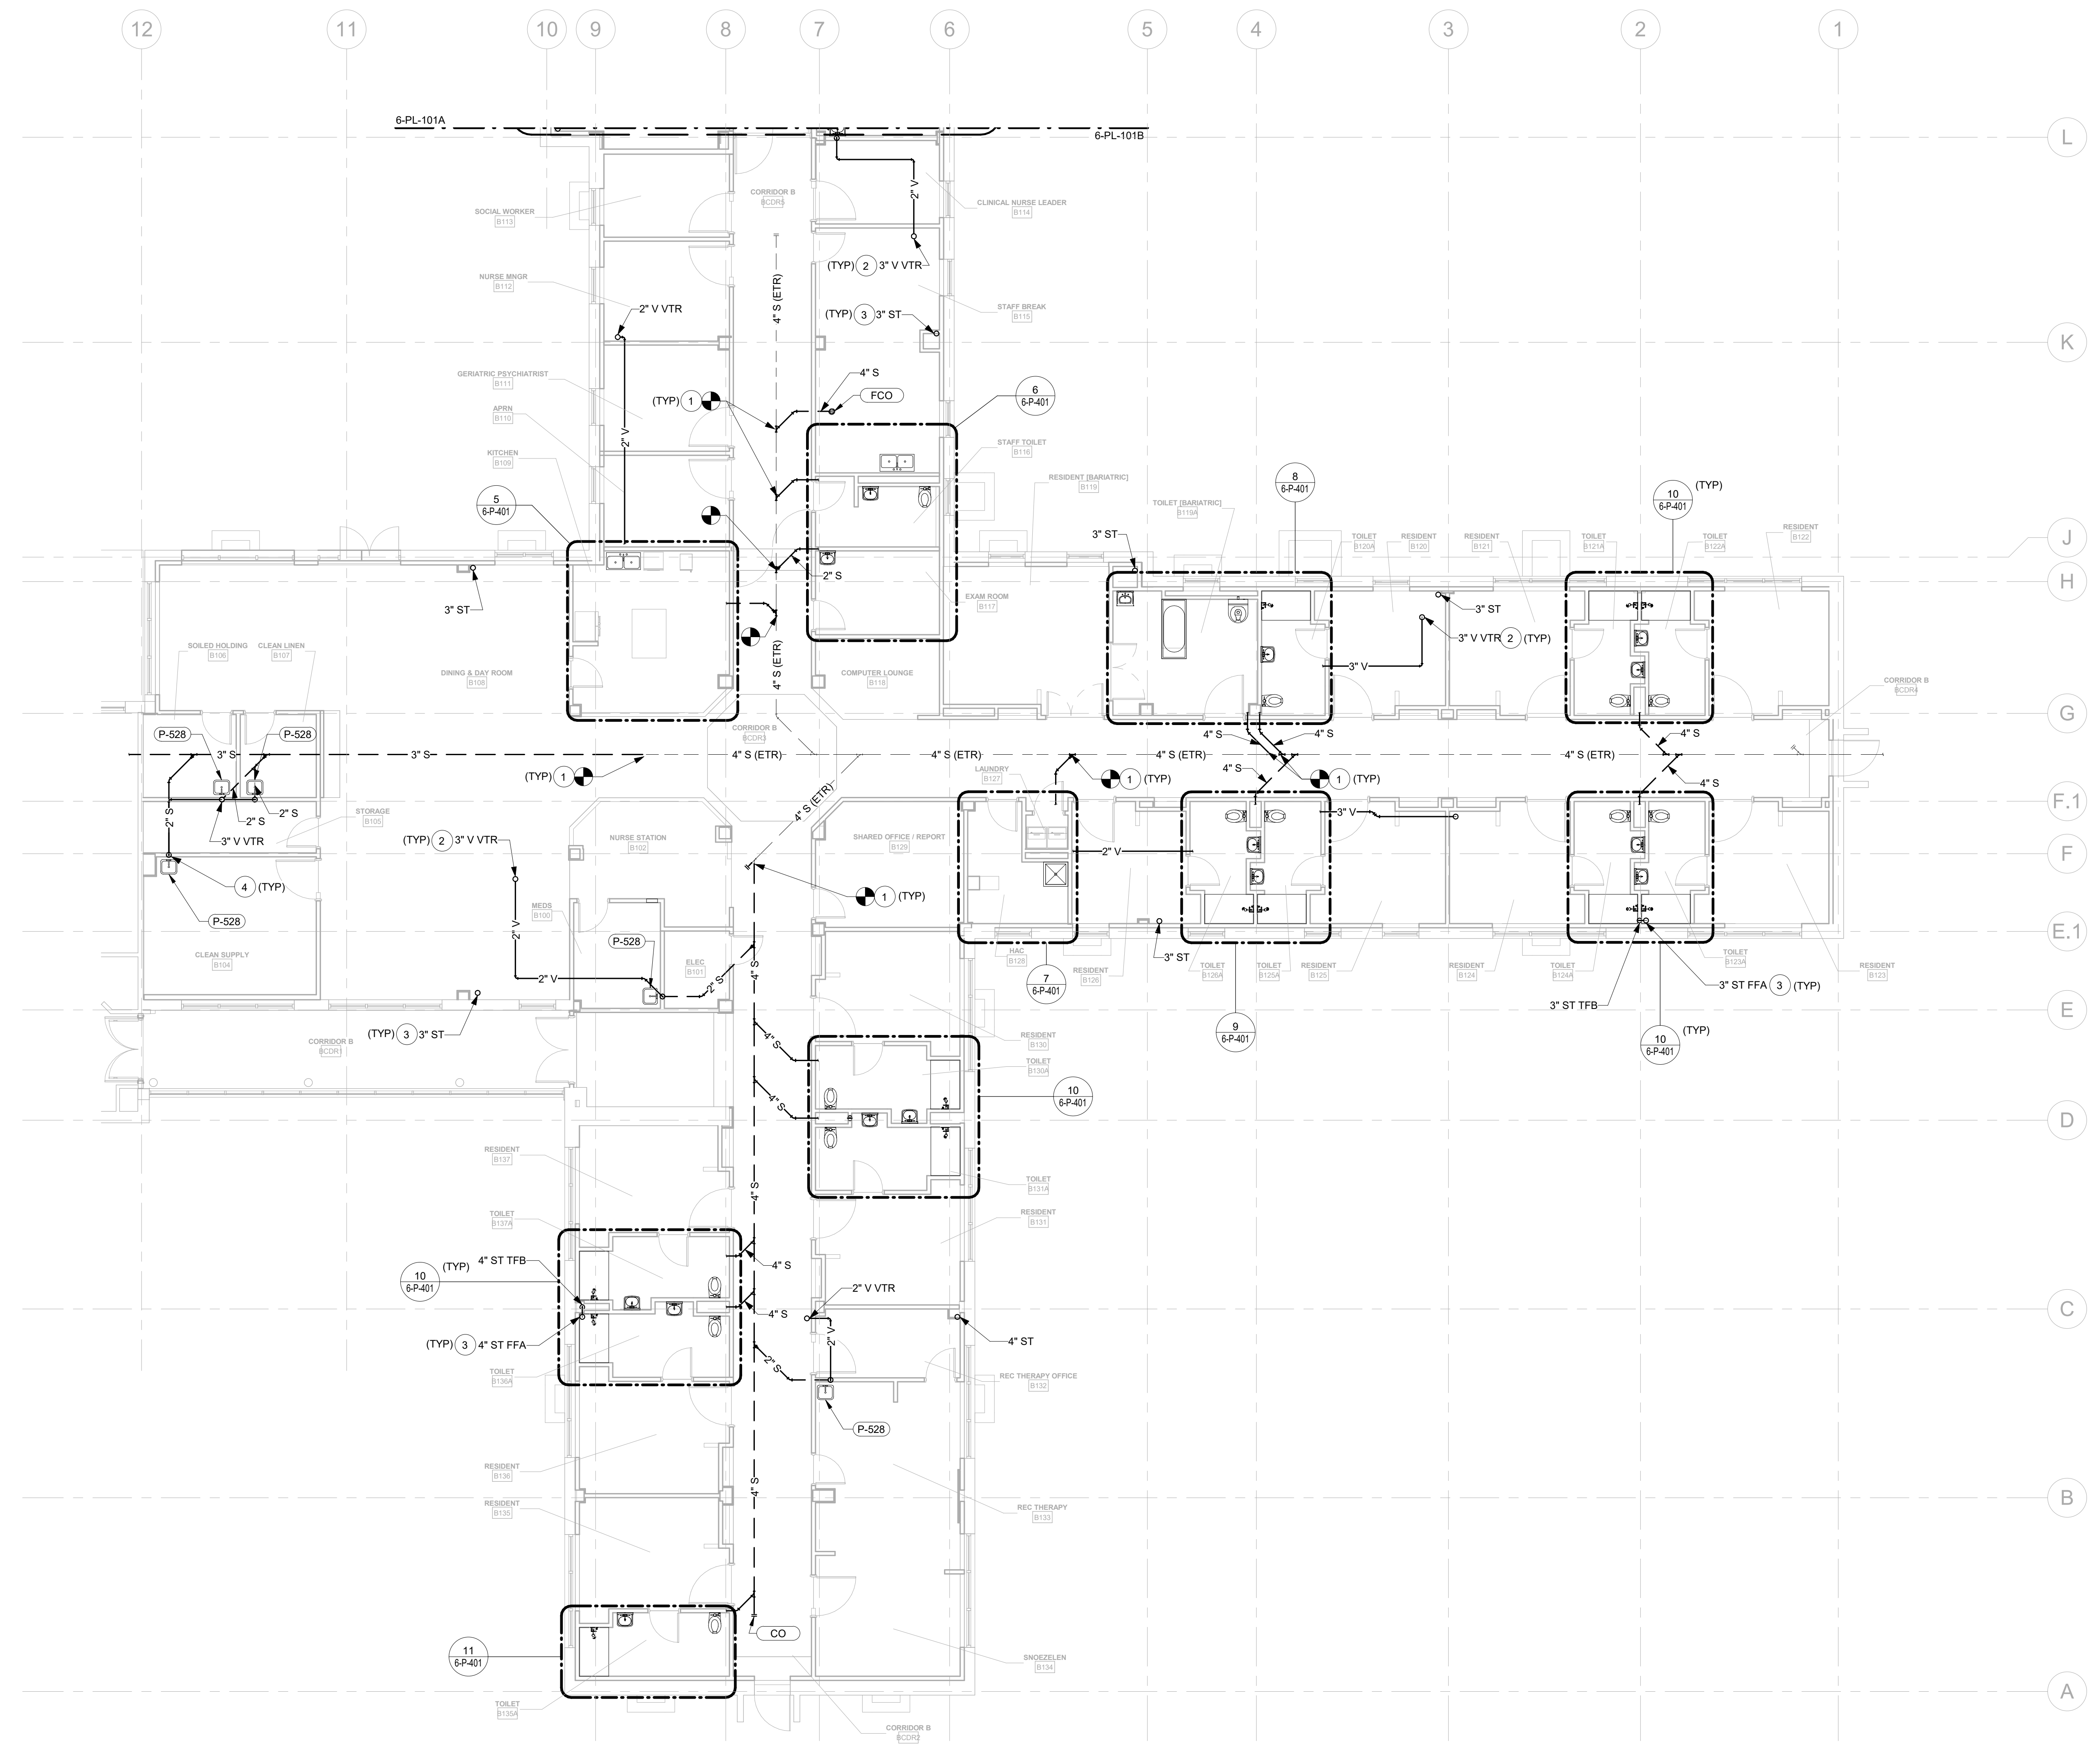

- GENERAL NOTES:**
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 2. SEE SHEET 6I-001 FOR ADDITIONAL INFORMATION REGARDING SCHEDULE AND PHASING REQUIREMENTS. SCHEDULE WORK TO MINIMIZE DISRUPTION OF SERVICES.
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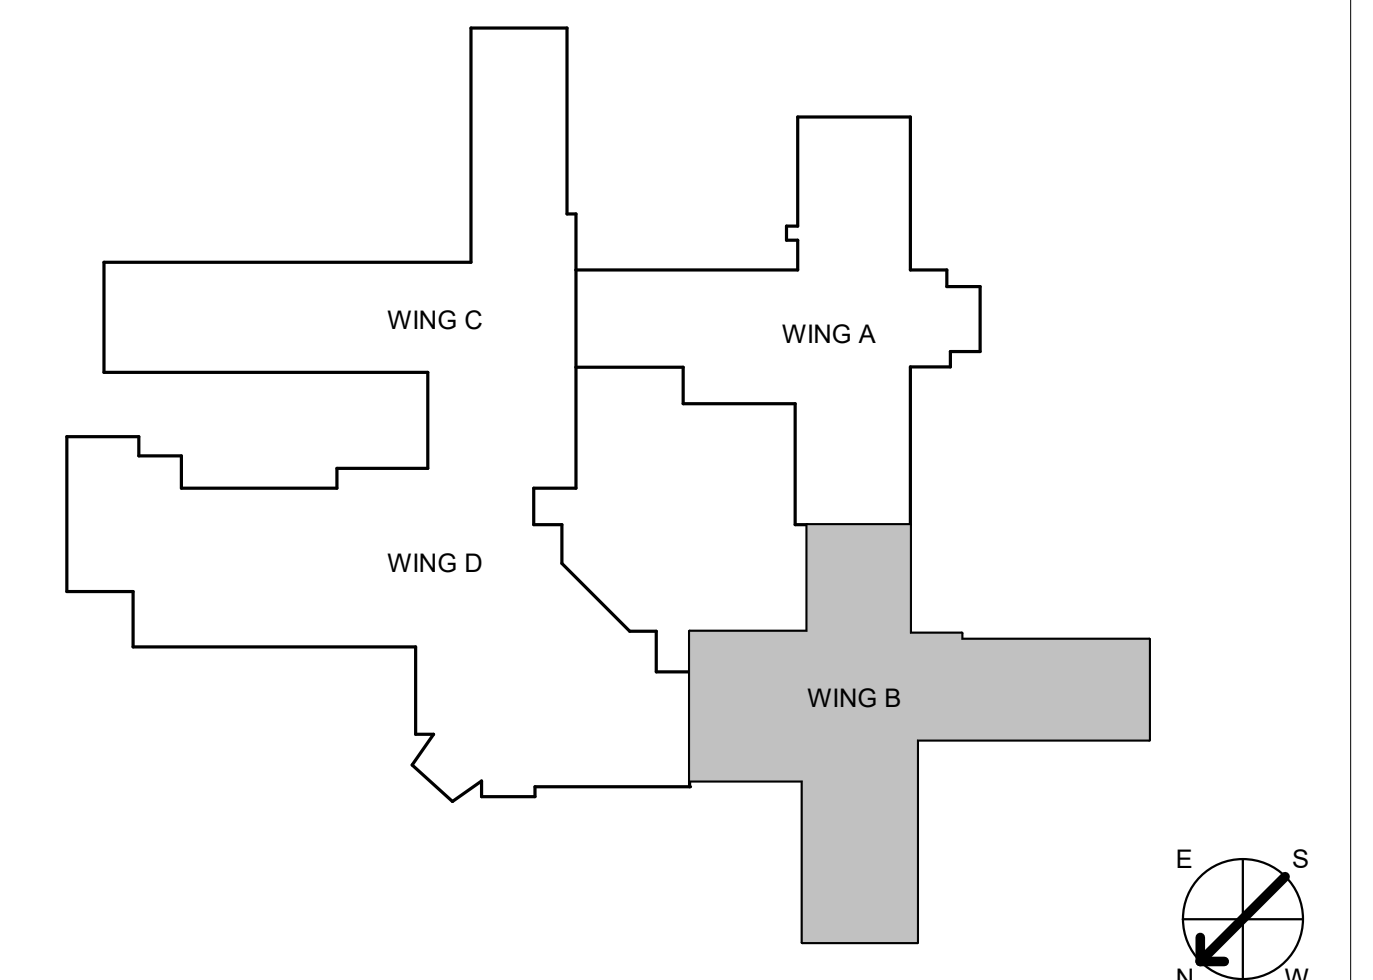
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- PLUMBING PLAN NOTES:**
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 2. INSTALL SANITARY VENT PIPING TO VENT THROUGH ROOF. PROVIDE VTR AS SHOWN ON SHEET 6-P-102B. VTR MUST BE A MINIMUM OF 25 FEET AWAY FROM ANY FRESH AIR INTAKES.
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 4. COORDINATE ALL FLOOR PENETRATIONS WITH EXISTING WAFFLE SLAB.


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CONSULTANT INFORMATION STRUCTURAL / CIVIL ENGINEER: STAND STRUCTURAL ENGINEERING, 11927 W. 112TH STREET, SUITE 200, OVERLAND PARK, KS 66210 (913) 214-2169 MECHANICAL / ELECTRICAL / PLUMBING / TECHNICAL ENGINEER: SPUR DESIGN, 11020 KING STREET, SUITE 350, OVERLAND PARK, KS 66210 (405) 842-6100 FIRE PROTECTION ENGINEER: POOLE FIRE PROTECTION, INC., 19910 W. 161ST STREET, OLATH, KS 66062 (913) 829-8650			ARCHITECT 533 SW 23th Street, Overland Park, KS 66209 10000 Ring Street, Suite 300, Overland Park, KS 66209 KS ARCH REG. NO. A-1139, EXP. 12/31/2019 KS ENGR REG. NO. E-2586, EXP. 12/31/2019		Office of Construction and Facilities Management VA U.S. Department of Veteran Affairs SHEET TITLE: PLUMBING WASTE PLAN - LEVEL 1 WING B FLOOR PLAN APPROVED: PROJECT DIRECTOR		PROJECT PHASE: BID DOCUMENTS FULLY SPRINKLERED		PROJECT TITLE: RENOVATE A & B WING BUILDING 6 PROJECT LOCATION: 2200 SW GAGE BLVD, TOPEKA, KS 66622 DATE: 07/10/2019 CHECKED BY: JES DRAWN BY: RLC		VA PROJECT NUMBER: 589-A5-19-116 BUILDING NUMBER: 6 DRAWING NUMBER: 6-PL-101B Dwg. 71 OF 160	
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three inches = one foot
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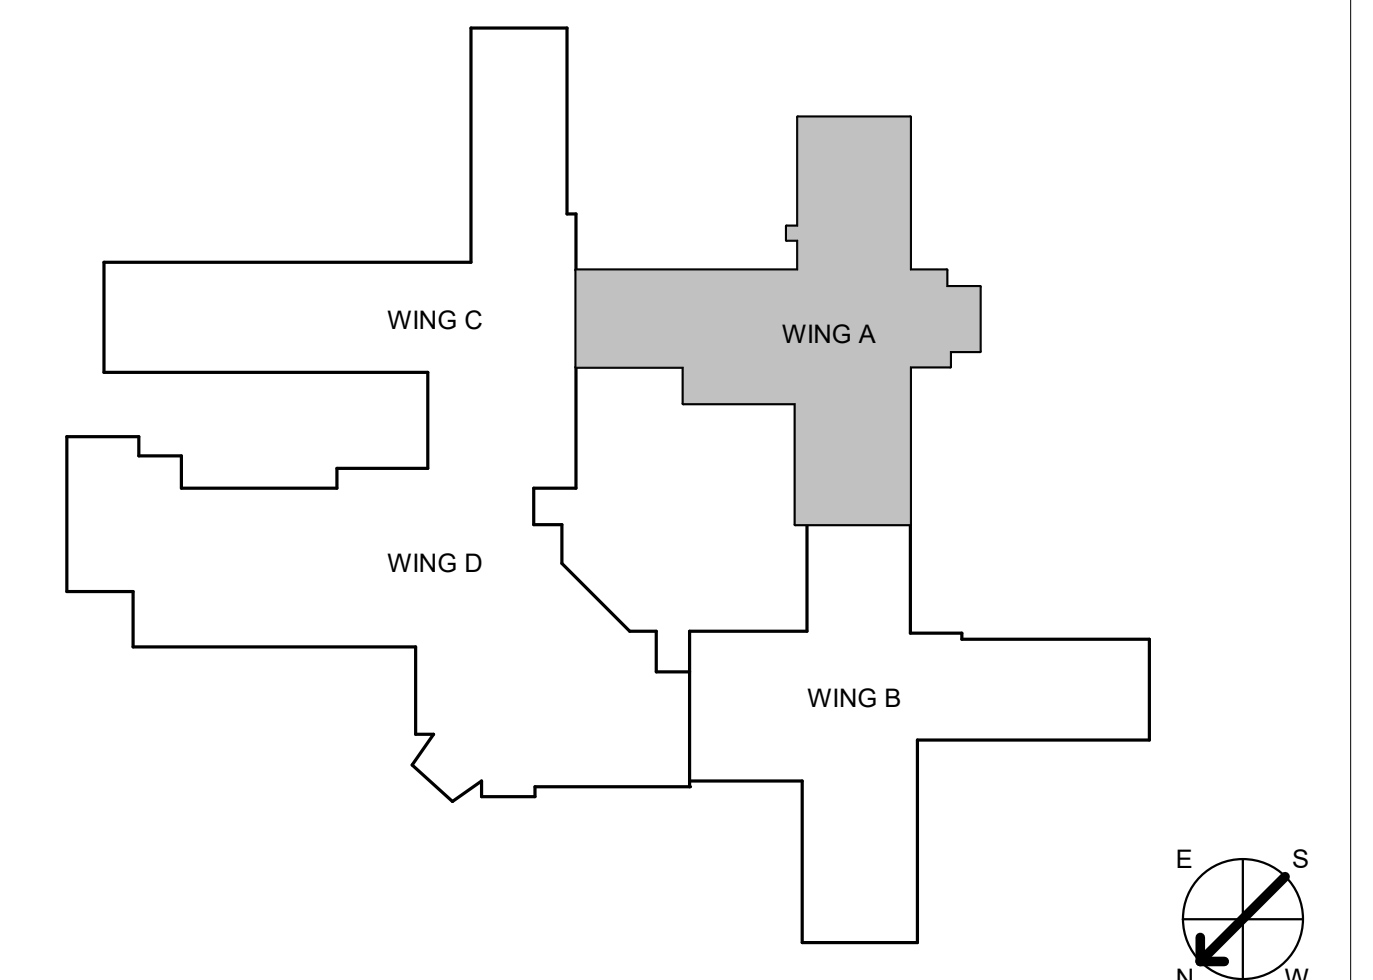
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
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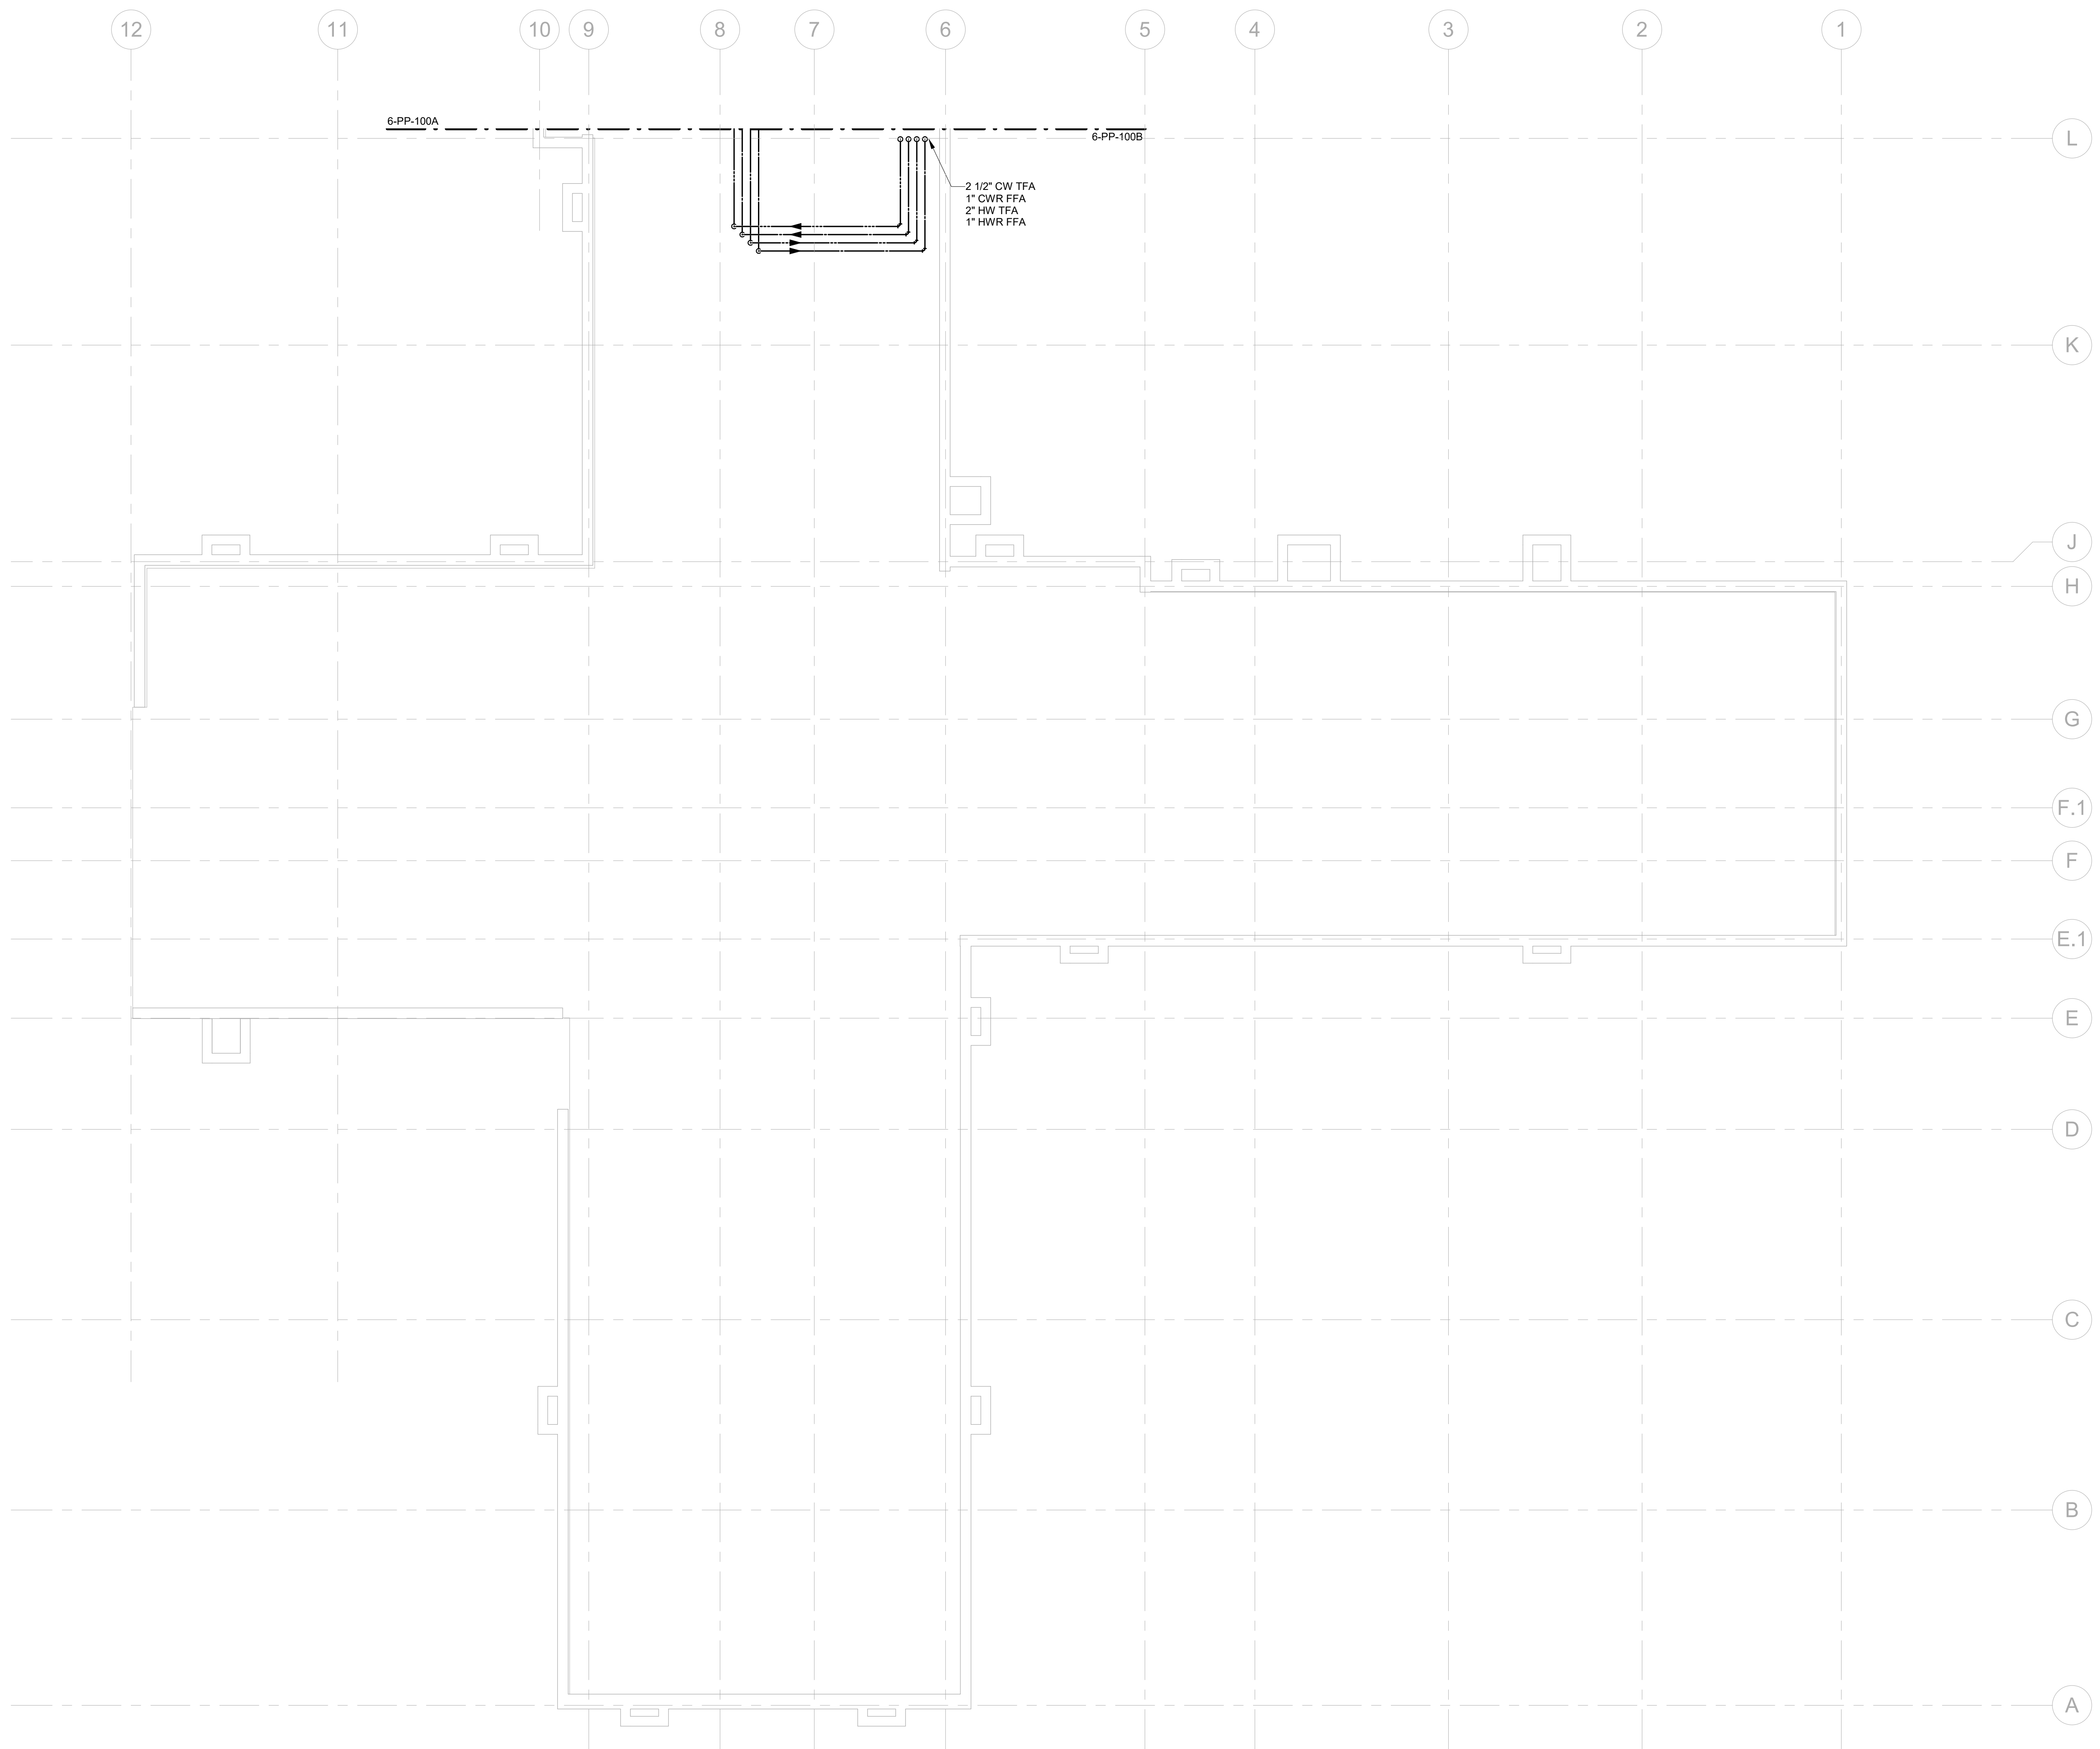
- PLUMBING PLAN NOTES:**
1. INSTALL DOMESTIC WATER PIPING AND CONNECT TO EXISTING PIPING AT DEMARCATION POINT SHOWN.
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1 PLUMBING SUPPLY PLAN - BASEMENT WING A FLOOR PLAN
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CONSULTANT INFORMATION STRUCTURAL / CIVIL ENGINEER STAND STRUCTURAL ENGINEERING 11627 W. 112TH STREET, SUITE 200 OVERLAND PARK, KS 66210 (913) 214-2169		MECHANICAL / ELECTRICAL / PLUMBING / TECHNICAL ENGINEER SPUR DESIGN 11020 KING STREET, SUITE 350 OVERLAND PARK, KS 66210 (405) 842-6100		FIRE PROTECTION ENGINEER POOLE FIRE PROTECTION, INC. 19910 W. 161ST STREET OLATH, KS 66062 (913) 829-8650		ARCHITECT  313 5th Street Overland Park, KS 66204 spur-design.com 11020 King Street, Suite 350 Overland Park, KS 66210 spur-design.com		Office of Construction and Facilities Management VA U.S. Department of Veteran Affairs		SHEET TITLE PLUMBING SUPPLY PLAN - BASEMENT WING A FLOOR PLAN APPROVED: PROJECT DIRECTOR		PROJECT PHASE BID DOCUMENTS FULLY SPRINKLERED		PROJECT TITLE RENOVATE A & B WING BUILDING 6 PROJECT LOCATION 2200 SW GAGE BLVD TOPEKA, KS 66622		VA PROJECT NUMBER 589-A5-19-116 BUILDING NUMBER 6 DRAWING NUMBER 6-PP-100A Dwg. 72 OF 160	
Revision # Date		KS ARCH REG. NO. A-1139, EXP. 12/31/2019 KS ENGR REG. NO. E-2586, EXP. 12/31/2019		DATE 07/10/2019		CHECKED BY JES		DRAWN BY RLC									




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
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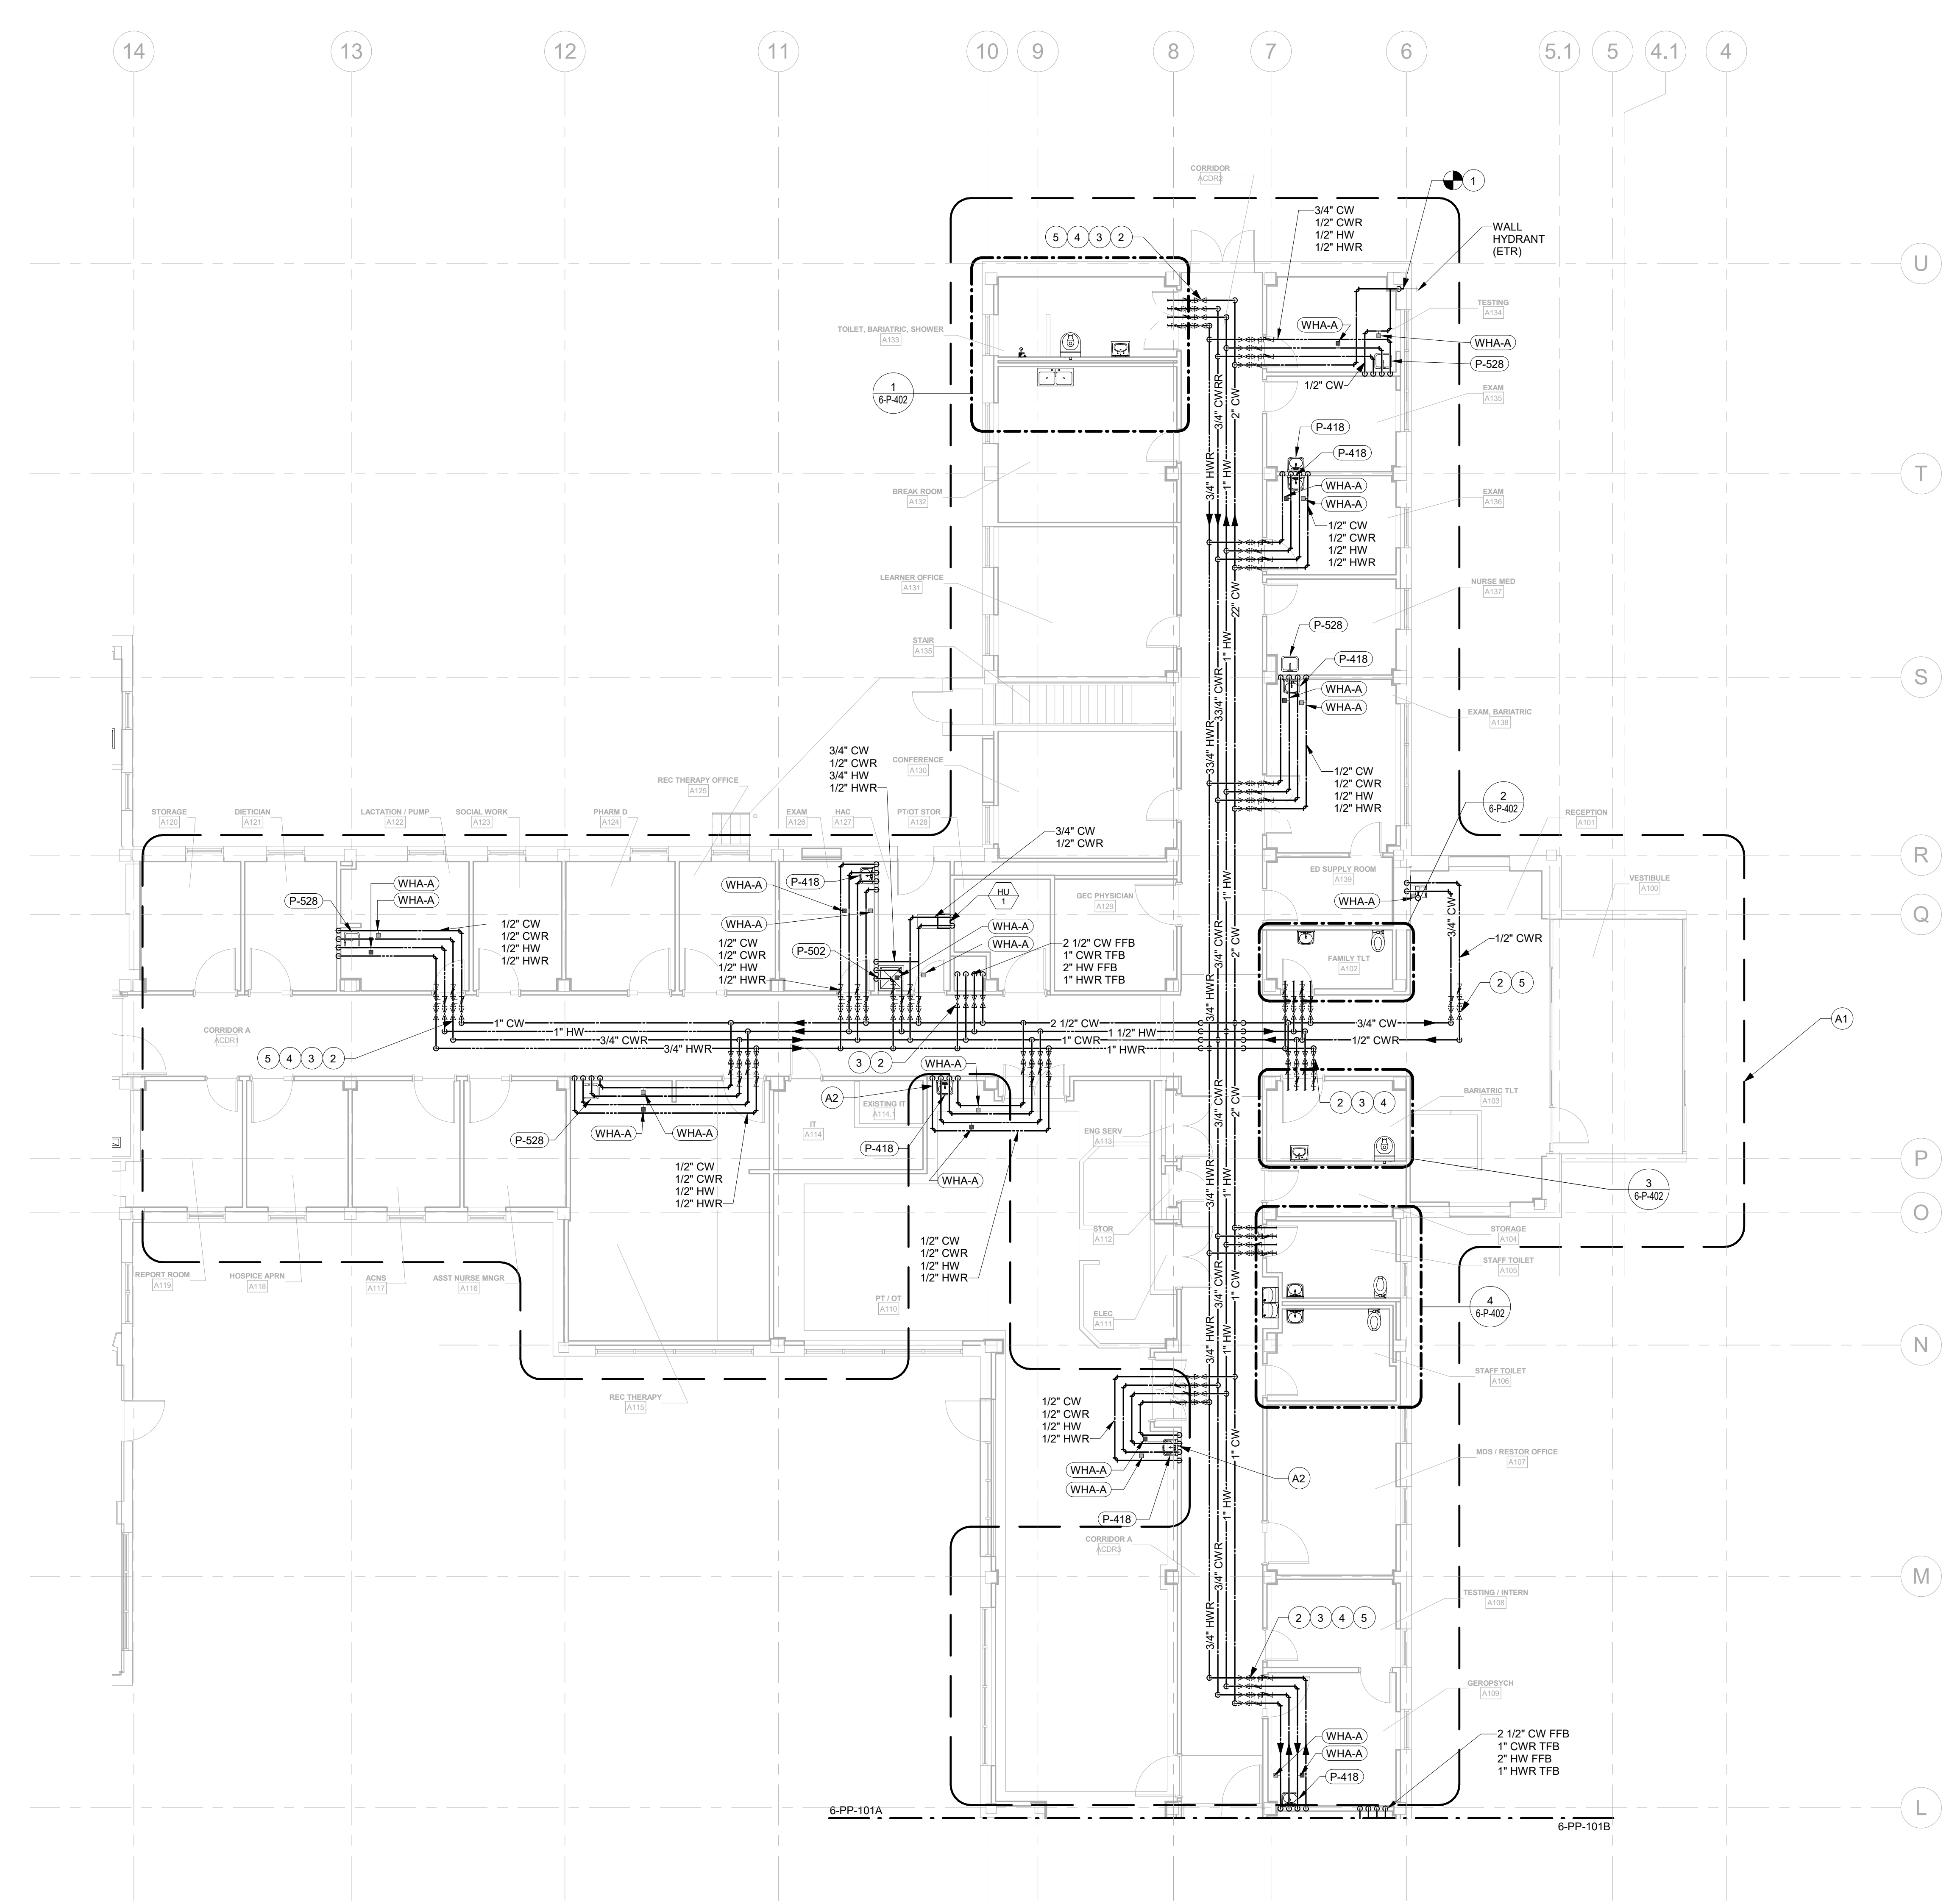
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1 PLUMBING SUPPLY PLAN - BASEMENT WING B FLOOR PLAN
1/8" = 1'-0"

CONSULTANT INFORMATION STRUCTURAL / CIVIL ENGINEER: STAND STRUCTURAL ENGINEERING, 11627 W. 112TH STREET, SUITE 200, OVERLAND PARK, KS 66210, (913) 214-2169 MECHANICAL / ELECTRICAL / PLUMBING / TECHNICAL ENGINEER: SPUR DESIGN, 11020 KING STREET, SUITE 350, OVERLAND PARK, KS 66210, (405) 842-6100 FIRE PROTECTION ENGINEER: POOLE FIRE PROTECTION, INC., 19910 W. 161ST STREET, OLATH, KS 66062, (913) 829-8650		ARCHITECT  512 SW 23th Street, Overland Park, KS 66159, spur-design.com 11020 King Street, Suite 350, Overland Park, KS 66210, spur-design.com		Office of Construction and Facilities Management VA U.S. Department of Veteran Affairs		SHEET TITLE: PLUMBING SUPPLY PLAN - BASEMENT WING B FLOOR PLAN APPROVED: PROJECT DIRECTOR		PROJECT PHASE: BID DOCUMENTS FULLY SPRINKLERED		PROJECT TITLE: RENOVATE A & B WING BUILDING 6 PROJECT LOCATION: 2200 SW GAGE BLVD, TOPEKA, KS 66622		VA PROJECT NUMBER: 589-A5-19-116 BUILDING NUMBER: 6 DRAWING NUMBER: 6-PP-100B Dwg. 73 OF 160	
Revision # Date		KS ARCH REG. NO. A-1139, EXP. 12/31/2019 KS ENGR REG. NO. E-2586, EXP. 12/31/2019				DATE: 07/10/2019		CHECKED BY: JES		DRAWN BY: RLC			

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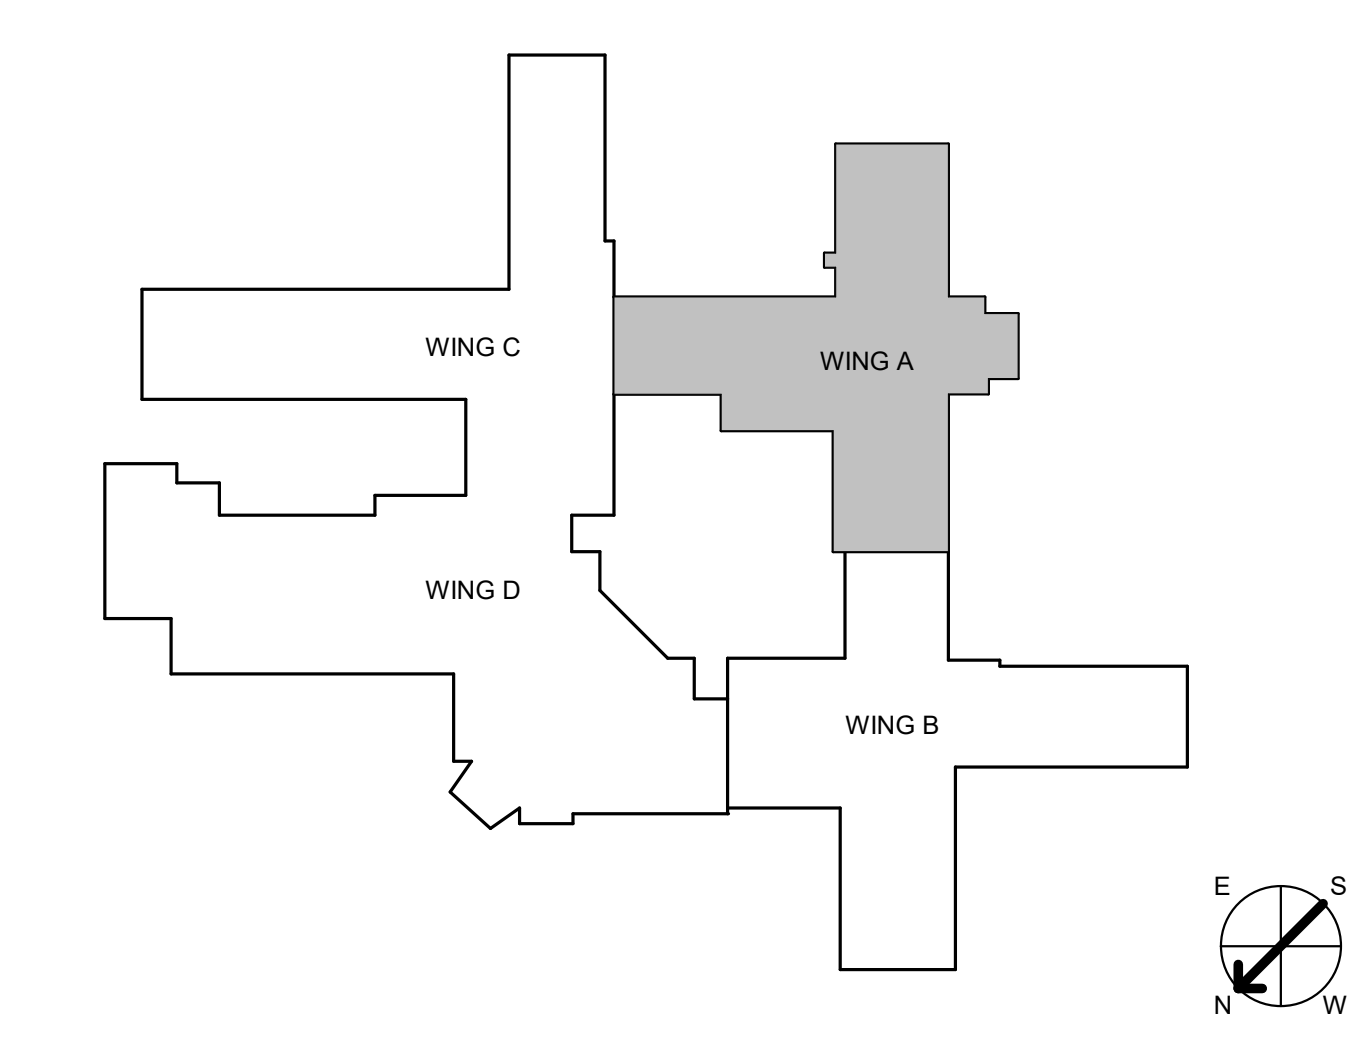
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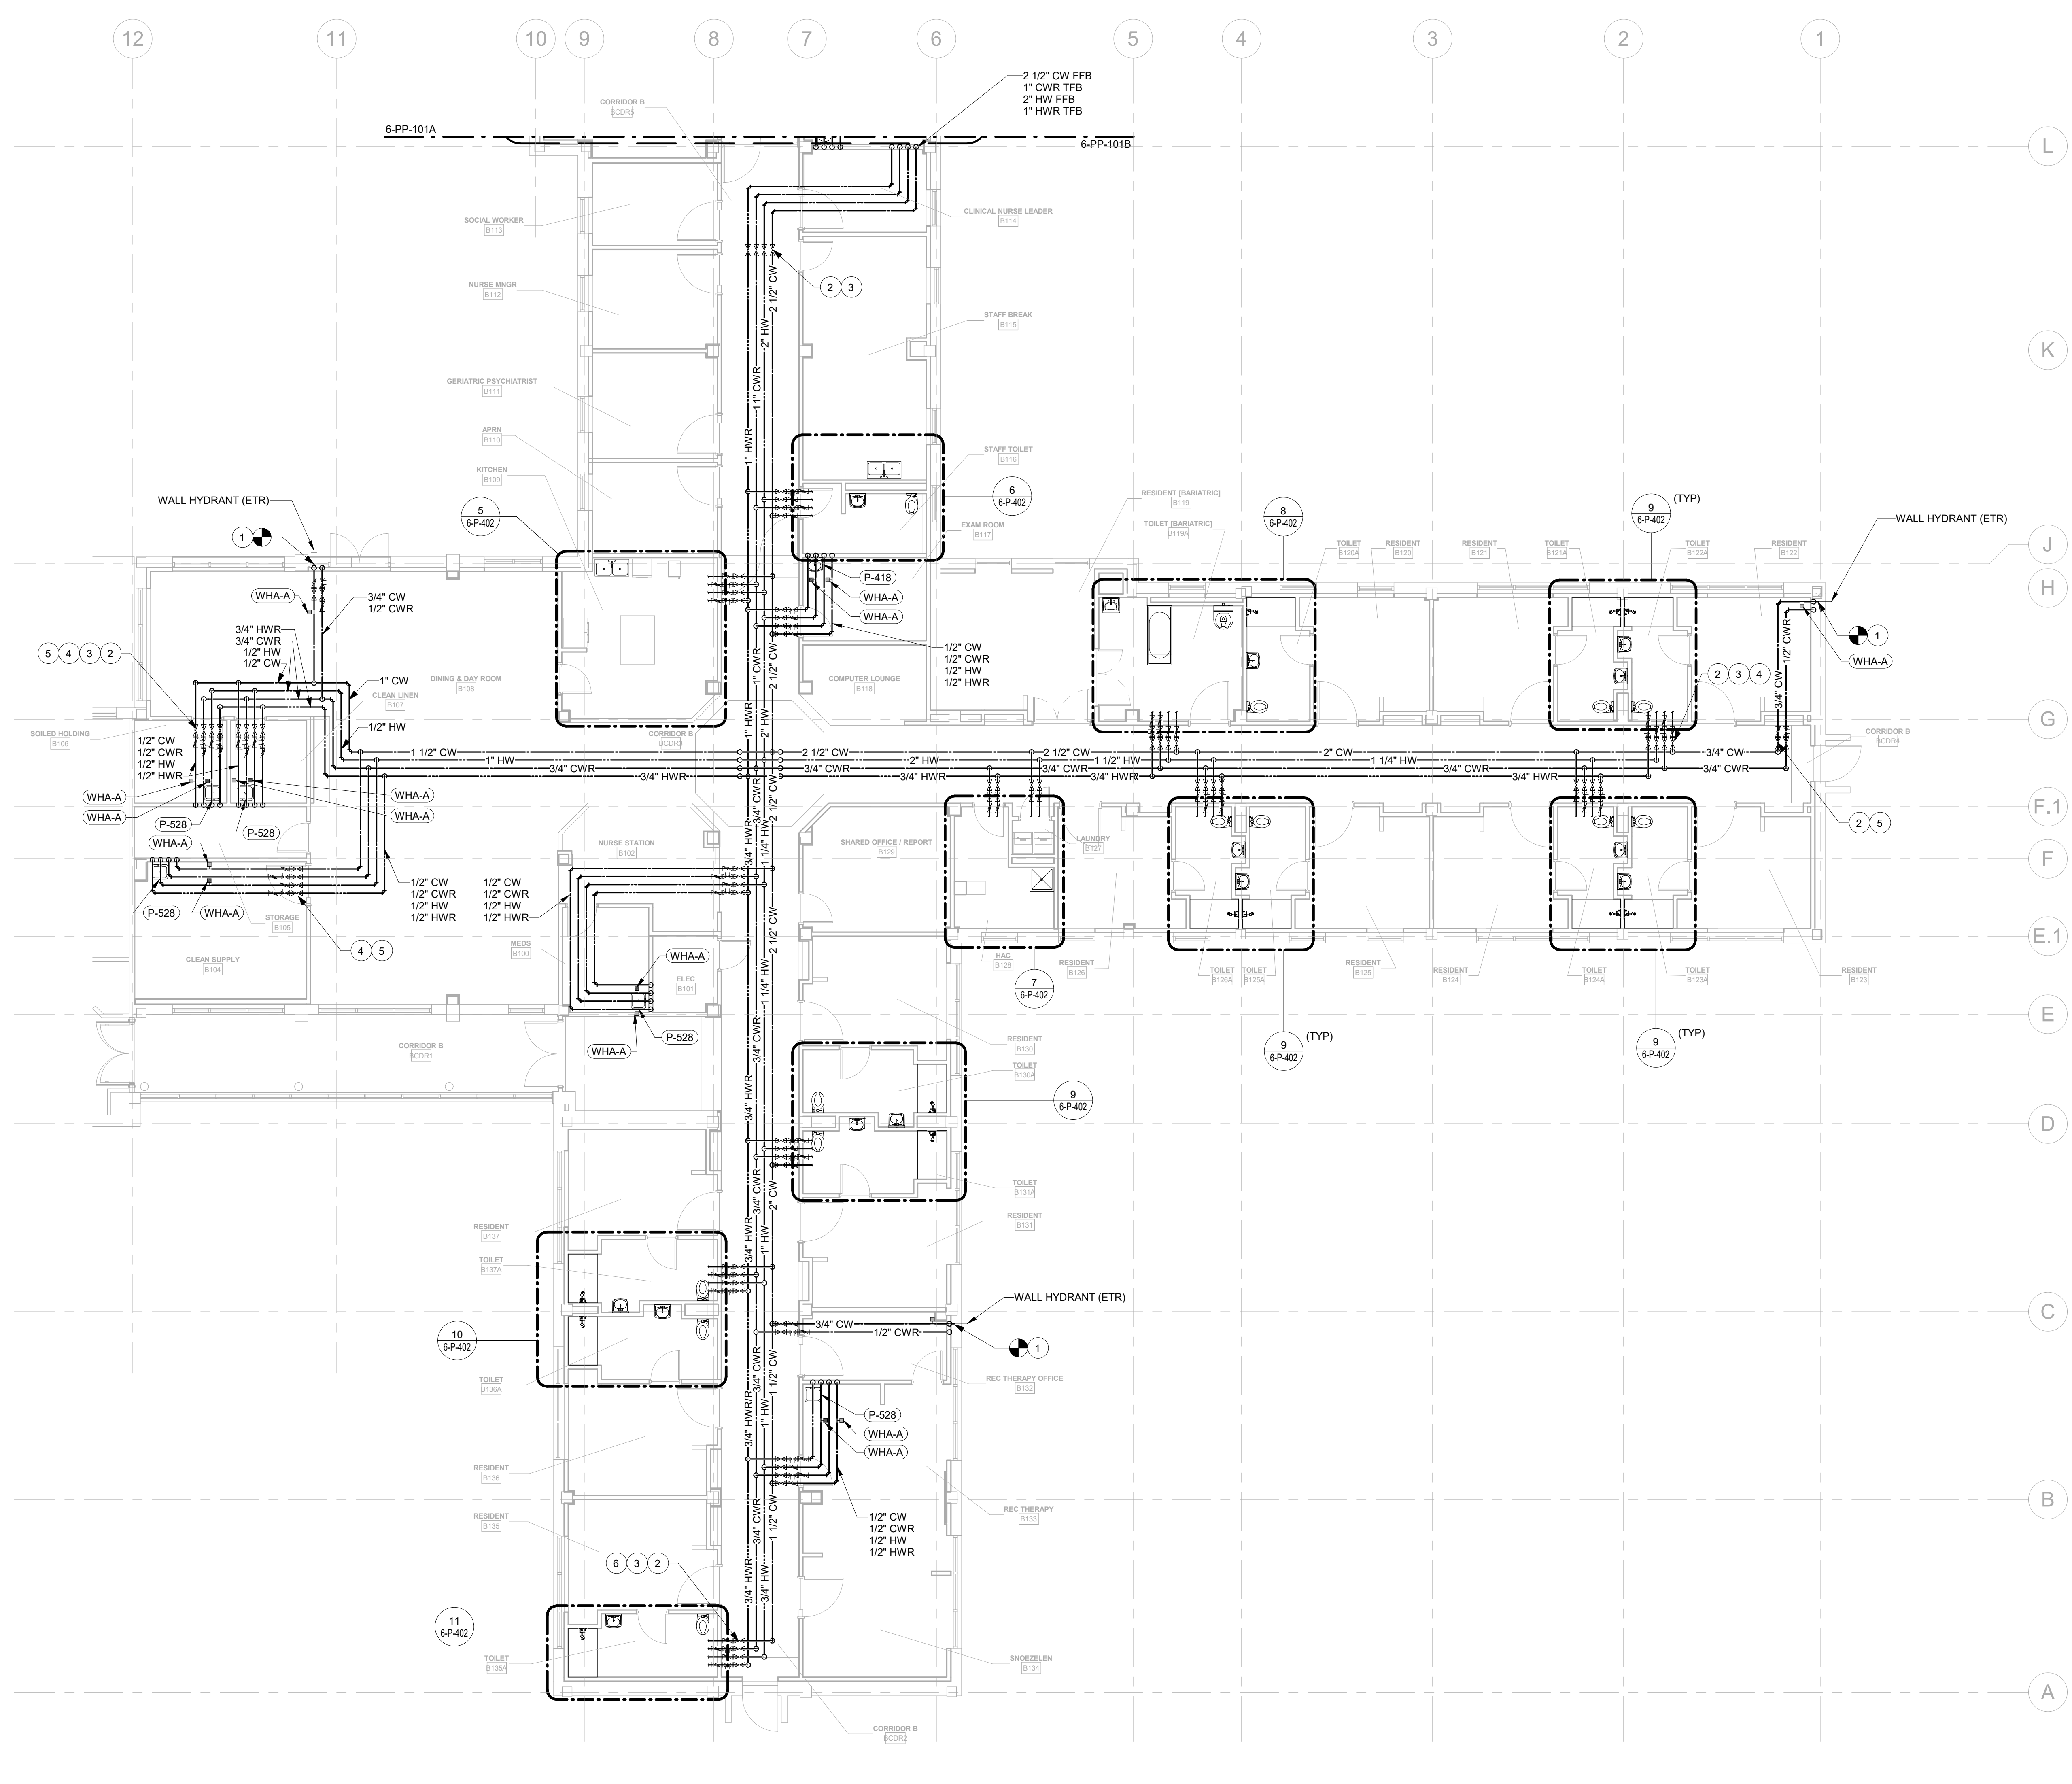
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- PLUMBING PLAN NOTES:**
1. INSTALL DOMESTIC WATER PIPING AND CONNECT TO EXISTING PIPING AT DEMARCATION POINT SHOWN.
 2. PROVIDE TEMPERATURE SENSOR DOWNSTREAM OF COLD WATER SHUT-OFF VALVE.
 3. PROVIDE TEMPERATURE SENSOR DOWNSTREAM OF HOT WATER SHUT-OFF VALVE.
 4. PROVIDE 0.5 GPM FLOW CONTROL VALVE ON HOT WATER RECIRCULATION LINES. ALL OTHER FLOW CONTROL VALVES SHALL BE 0.3 GPM UNLESS OTHERWISE NOTED. SEE PLUMBING FIXTURE SCHEDULE ON SHEET 6-P-601 FOR RELATED INFORMATION.
 5. PROVIDE 0.5 GPM FLOW CONTROL VALVE ON COLD WATER RECIRCULATION LINES. ALL OTHER FLOW CONTROL VALVES SHALL BE 0.3 GPM UNLESS OTHERWISE NOTED. SEE PLUMBING FIXTURE SCHEDULE ON SHEET 6-P-601 FOR RELATED INFORMATION.
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- A1. IF DEDUCT ALTERNATE IS ACCEPTED, DO NOT PROVIDE NEW PLUMBING FIXTURES AND ASSOCIATED DOMESTIC WATER PIPING.
 - A2. IF DEDUCT ALTERNATE IS ACCEPTED, PROVIDE NEW DOMESTIC WATER PIPING AND CONNECT TO EXISTING BELOW FLOOR.

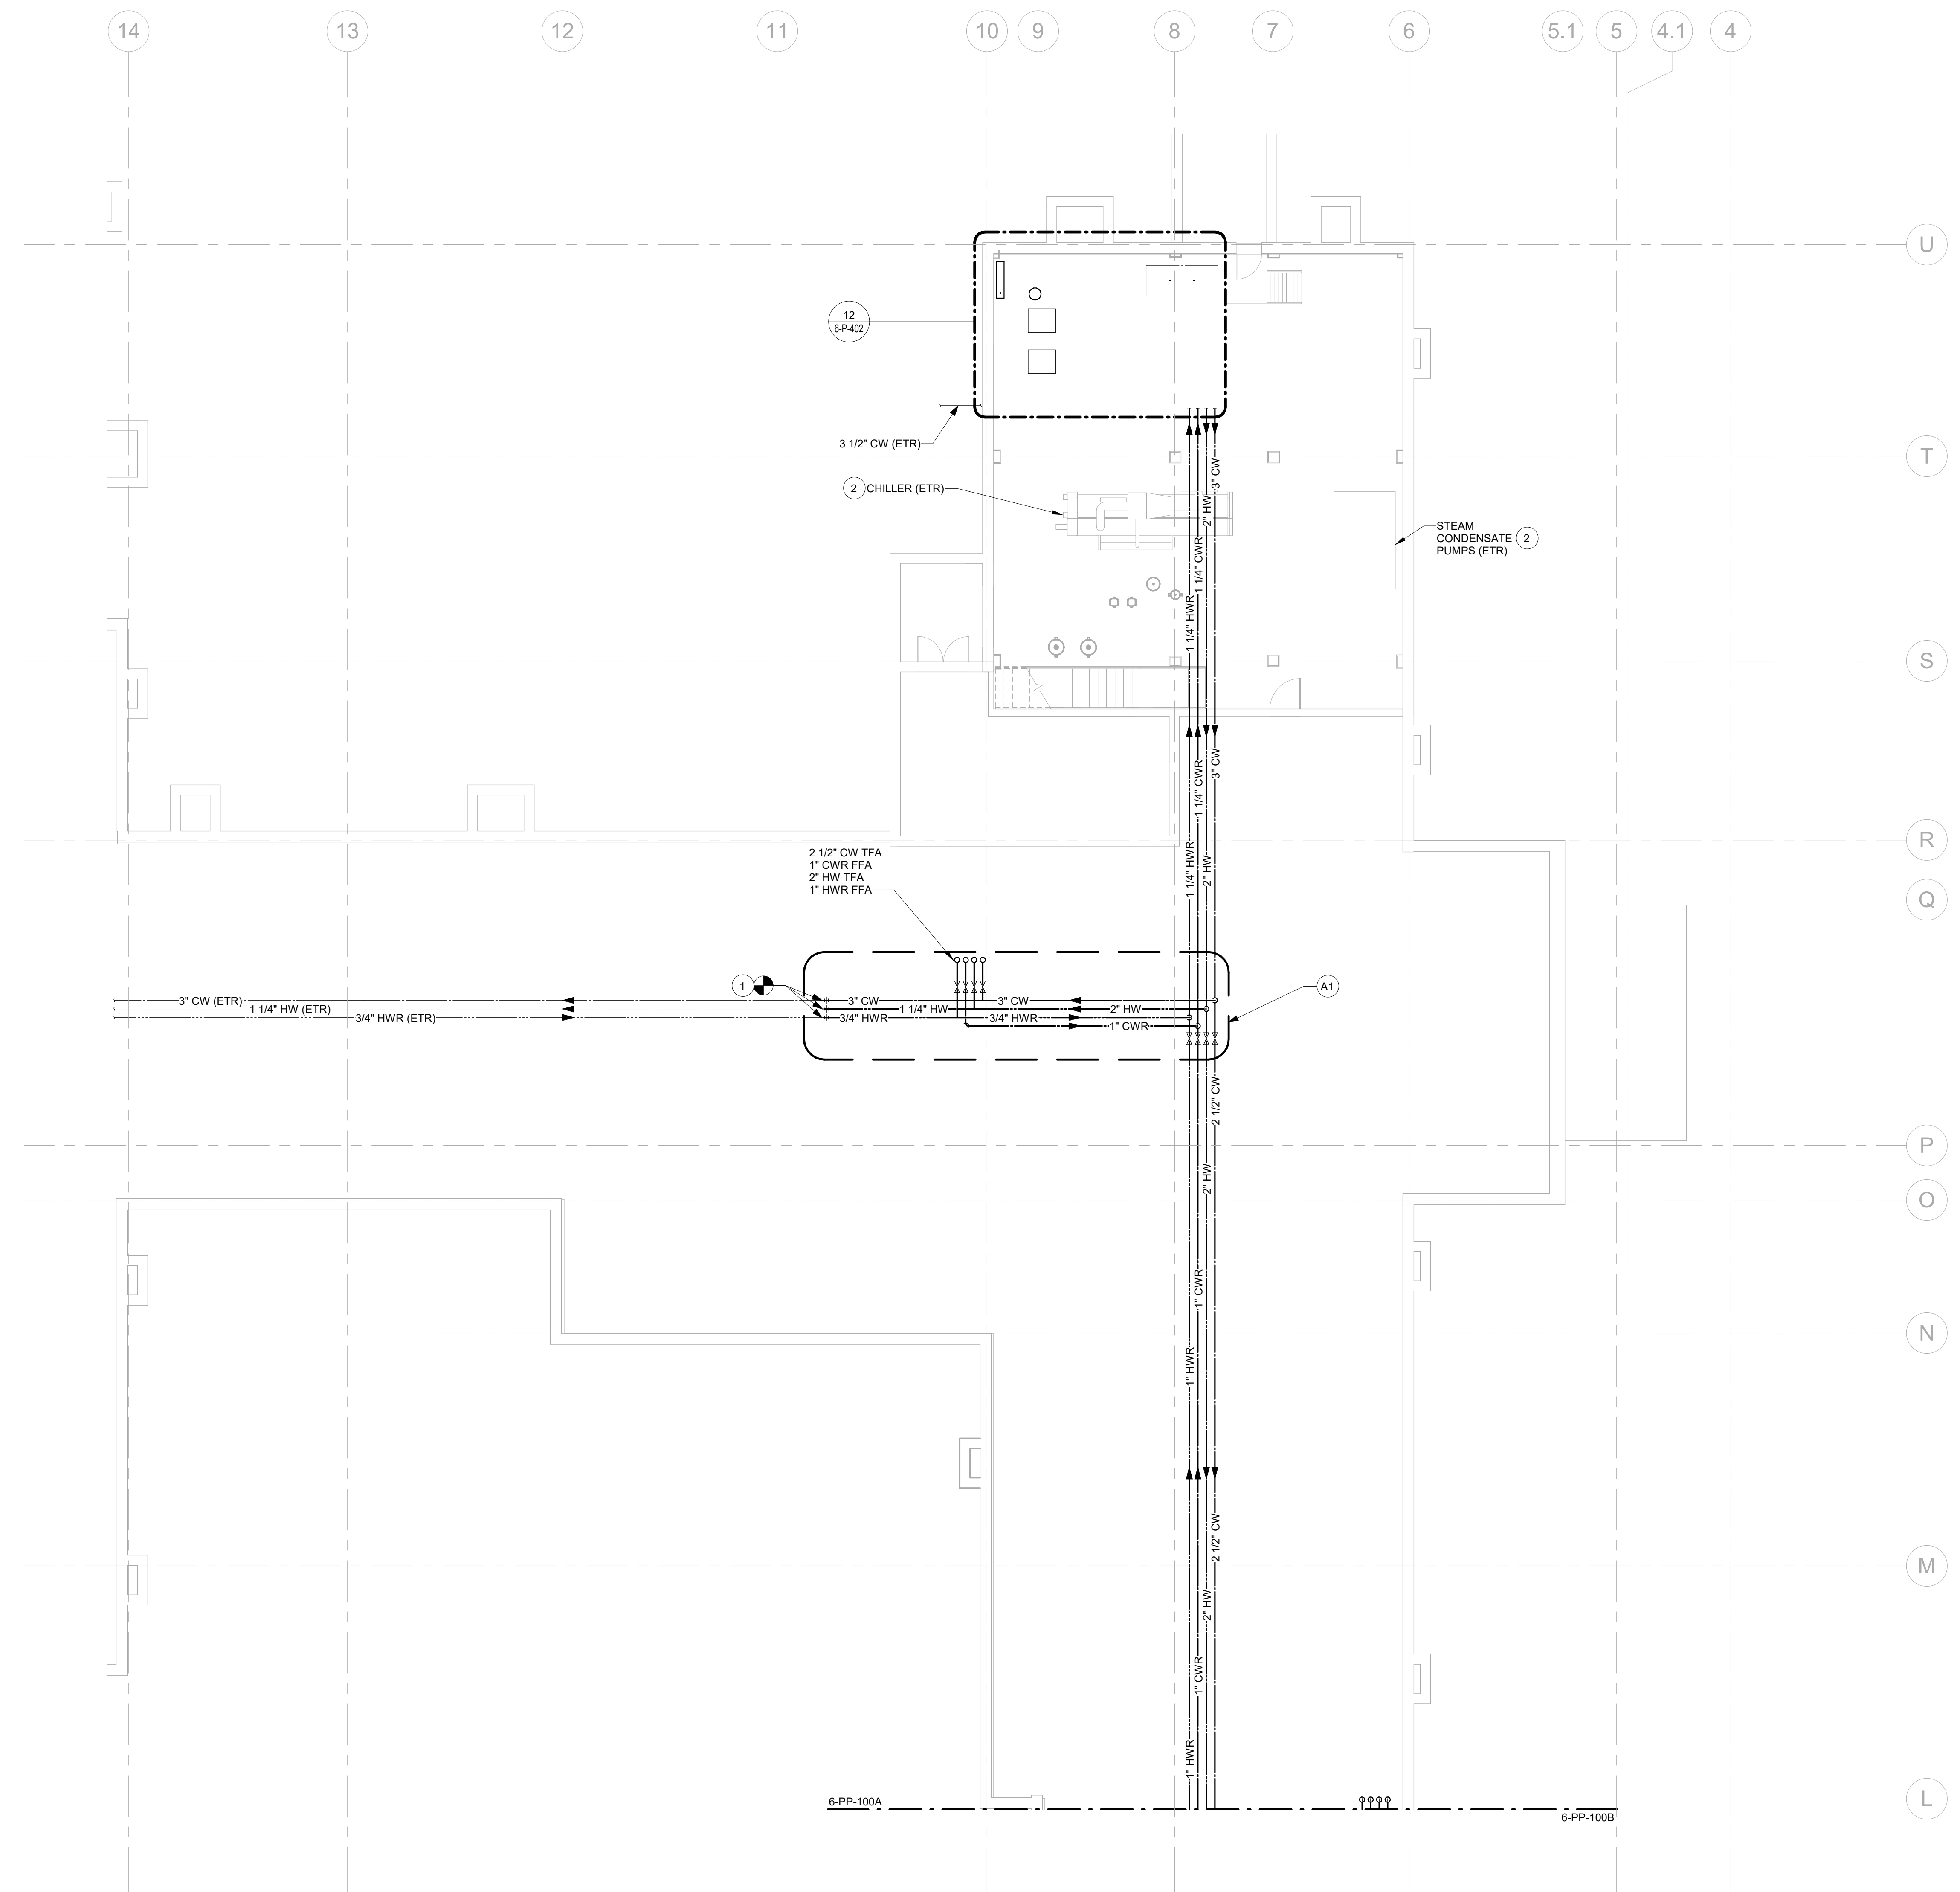

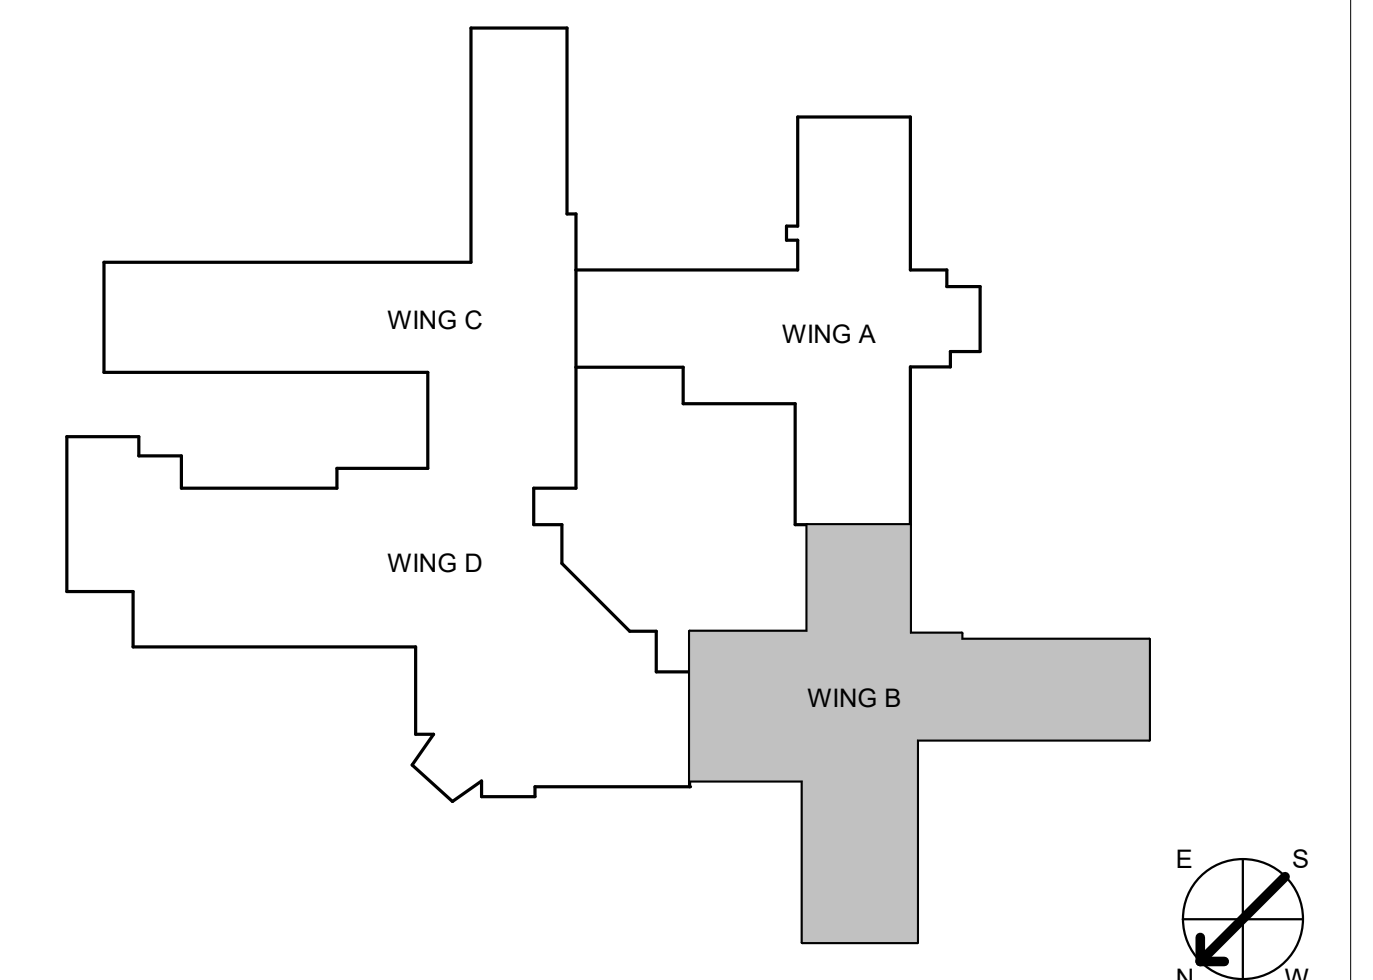CONSULTANT INFORMATION STRUCTURAL / CIVIL ENGINEER: STAND STRUCTURAL ENGINEERING, 11927 W. 112TH STREET, SUITE 200, OVERLAND PARK, KS 66210 (913) 214-2169 MECHANICAL / ELECTRICAL / PLUMBING / TECHNICAL ENGINEER: SPUR DESIGN, 11020 KING STREET, SUITE 350, OVERLAND PARK, KS 66210 (405) 842-6100 FIRE PROTECTION ENGINEER: POOLE FIRE PROTECTION, INC., 19910 W. 161ST STREET, OLATH, KS 66062 (913) 829-8650			ARCHITECT 511 SW 23rd Street, Overland Park, KS 66150 10000 Ring Street, Suite 300, Overland Park, KS 66150 KS ARCH REG. NO. A-1139, EXP. 12/31/2019 KS ENGR REG. NO. E-2586, EXP. 12/31/2019		Office of Construction and Facilities Management VA U.S. Department of Veteran Affairs SHEET TITLE: PLUMBING SUPPLY PLAN - LEVEL 1 WING A FLOOR PLAN APPROVED: PROJECT DIRECTOR		PROJECT PHASE: BID DOCUMENTS FULLY SPRINKLERED		PROJECT TITLE: RENOVATE A & B WING BUILDING 6 PROJECT LOCATION: 2200 SW GAGE BLVD, TOPEKA, KS 66622 DATE: 07/10/2019 CHECKED BY: JES DRAWN BY: RLC		VA PROJECT NUMBER: 589-A5-19-116 BUILDING NUMBER: 6 DRAWING NUMBER: 6-PP-101A Dwg. 74 OF 160	
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1 PLUMBING SUPPLY PLAN - LEVEL 1 WING B FLOOR PLAN
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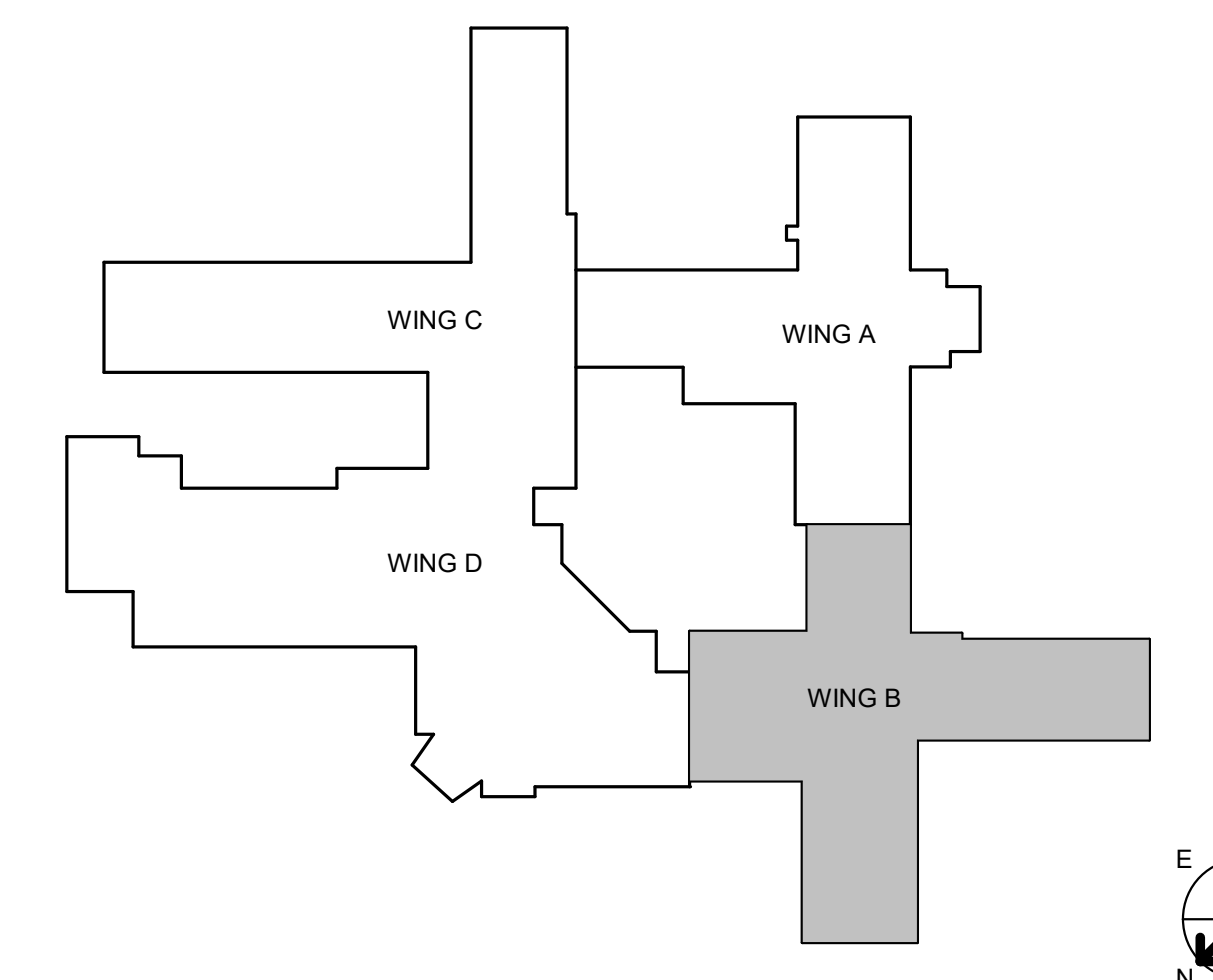
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DEDUCT ALTERNATE & PHASING:


ALL PLAN WORK SHOWN ON THIS SHEET IS SUBJECT TO THE OVERALL PROJECT PHASING SEQUENCE OUTLINED ON ARCHITECTURAL SHEET 6-GI-102.

IN ADDITION, IF THE DEDUCT ALTERNATE IS ELECTED, ALL PLAN WORK ON THIS SHEET IS ALSO SUBJECT TO THE REDUCED AREAS OF WORK AS DEFINED ON ARCHITECTURAL SHEET 6-GI-105.

- PLUMBING PLAN NOTES:**
1. INSTALL DOMESTIC WATER PIPING AND CONNECT TO EXISTING PIPING AT DEMARCATION POINT SHOWN.
 2. PROVIDE TEMPERATURE SENSOR DOWNSTREAM OF COLD WATER SHUT-OFF VALVE.
 3. PROVIDE TEMPERATURE SENSOR DOWNSTREAM OF HOT WATER SHUT-OFF VALVE.
 4. PROVIDE 0.5 GPM FLOW CONTROL VALVE ON HOT WATER RECIRCULATION LINES. ALL OTHER FLOW CONTROL VALVES SHALL BE 0.3 GPM UNLESS OTHERWISE NOTED. SEE PLUMBING FIXTURE SCHEDULE ON SHEET 6-P-601 FOR RELATED INFORMATION.
 5. PROVIDE 0.5 GPM FLOW CONTROL VALVE ON COLD WATER RECIRCULATION LINES. ALL OTHER FLOW CONTROL VALVES SHALL BE 0.3 GPM UNLESS OTHERWISE NOTED. SEE PLUMBING FIXTURE SCHEDULE ON SHEET 6-P-601 FOR RELATED INFORMATION.
 6. PROVIDE 0.7 GPM FLOW CONTROL VALVE ON HOT/COLD WATER RECIRCULATION LINES. ALL OTHER FLOW CONTROL VALVES SHALL BE 0.3 GPM UNLESS OTHERWISE NOTED. SEE PLUMBING FIXTURE SCHEDULE ON SHEET 6-P-601 FOR RELATED INFORMATION.




CONSULTANT INFORMATION STRUCTURAL / CIVIL ENGINEER: STAND STRUCTURAL ENGINEERING, 11627 W. 112TH STREET, SUITE 200, OVERLAND PARK, KS 66210 (913) 214-2169 MECHANICAL / ELECTRICAL / PLUMBING / TECHNICAL ENGINEER: SPUR DESIGN, 11020 KING STREET, SUITE 350, OVERLAND PARK, KS 66210 (405) 842-6100 FIRE PROTECTION ENGINEER: POOLE FIRE PROTECTION, INC., 19910 W. 161ST STREET, OLATH, KS 66062 (913) 829-8650			ARCHITECT 333 SW 23rd Street, Overland Park, KS 66209 spur-design.com 1000 First Street, Suite 300, Overland Park, KS 66204 spur-design.com		Office of Construction and Facilities Management VA U.S. Department of Veteran Affairs SHEET TITLE: PLUMBING SUPPLY PLAN - LEVEL 1 WING B FLOOR PLAN APPROVED: PROJECT DIRECTOR		PROJECT PHASE: BID DOCUMENTS FULLY SPRINKLERED		PROJECT TITLE: RENOVATE A & B WING BUILDING 6 PROJECT LOCATION: 2200 SW GAGE BLVD, TOPEKA, KS 66622 DATE: 07/10/2019 CHECKED BY: JES DRAWN BY: RLC		VA PROJECT NUMBER: 589-A5-19-116 BUILDING NUMBER: 6 DRAWING NUMBER: 6-PP-101B Dwg. 75 OF 160	
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- GENERAL NOTES:**
1. THE AREA OF WORK SHOWN IS ASSOCIATED WITH AN OPERATING FACILITY THAT MUST REMAIN IN SERVICE 24/7.
 2. SEE SHEET 6I-001 FOR ADDITIONAL INFORMATION REGARDING SCHEDULE AND PHASING REQUIREMENTS. SCHEDULE WORK TO MINIMIZE DISRUPTION OF SERVICES.
 3. COORDINATE WORK SCHEDULE WITH THE CONTRACTING OFFICER'S REPRESENTATIVE (COR) BEFORE THE START OF WORK.
 4. COORDINATE PLUMBING WORK WITH OTHER TRADES AND CONTRACTORS. VERIFY ALL EXISTING CONDITIONS BEFORE THE START OF WORK.
 5. POSITIVE PRESSURE PATIENT MEDICAL GAS PIPING SHALL NOT BE BREACHED OR PENETRATED BY ANY MEANS OR PROCESS THAT WILL RESULT IN RESIDUAL COPPER PARTICLES OR OTHER DEBRIS REMAINING IN THE PIPING, OR THAT AFFECTS THE OXYGEN-CLEAN INTERIOR OF THE PIPING. IF BREACHING OR PENETRATING THE MEDICAL GAS PIPING IS REQUIRED, THE PROCESS SHALL ENSURE THAT ANY DEBRIS CREATED BY THE PROCESS REMAINS CONTAINED WITHIN THE WORK AREA.
 6. ALL VALVES IN THE MEDICAL GAS SYSTEMS SHALL BE QUARTER TURN OFF WITH INDICATION OF WHETHER THE VALVE IS OPEN OR CLOSED. A LABEL SHALL BE PROVIDED ON ALL VALVES INDICATING THE TYPE OF SERVICE, THE AREA(S) OR ROOM(S) SERVED, AND A WARNING THAT THE VALVE SHALL NOT BE OPENED OR CLOSED EXCEPT FOR EMERGENCY SITUATIONS.
 7. HOT TAPS OR SIMILAR VALVE ASSEMBLIES ARE NOT PERMITTED IN MEDICAL GAS PIPING SYSTEMS.
 8. EACH NEW FITTING, VALVE, AND LENGTH OF NEW MEDICAL GAS TUBING SHALL BE CLEANED, CAPPED, AND SEALED BY THE MANUFACTURER UNTIL PREPARED FOR INSTALLATION. ALL COMPONENTS SHALL BE CONSTRUCTED OF TYPE K COPPER.
 9. IDENTIFY AREA ALARM(S) SHOWN WITH THE NAME OF THE MEDICAL GASES BEING SERVED AND THE AREAS MONITORED BY THE ALARM PANEL.
 10. STATION OUTLET / INLET ASSEMBLIES MUST BE SELECTED SUCH THAT GAS-SPECIFIC COMPONENTS CANNOT BE INTERCHANGED BETWEEN THE STATION OUTLET / INLET FOR DIFFERENT GASES.
 11. ALL NEW MEDICAL GAS BRANCH PIPING TO ROOM OUTLET / INLET ASSEMBLIES IS 3/4" UNLESS NOTED OTHERWISE. 1/2" BRANCH PIPING TO INDIVIDUAL OUTLETS / INLETS IS PERMITTED.
- DEDUCT ALTERNATE & PHASING:**
- ALL PLAN WORK SHOWN ON THIS SHEET IS SUBJECT TO THE OVERALL PROJECT PHASING SEQUENCE OUTLINED ON ARCHITECTURAL SHEET 6-GI-102.
- IN ADDITION, IF THE DEDUCT ALTERNATE IS ELECTED, ALL PLAN WORK ON THIS SHEET IS ALSO SUBJECT TO THE REDUCED AREAS OF WORK AS DEFINED ON ARCHITECTURAL SHEET 6-GI-105.

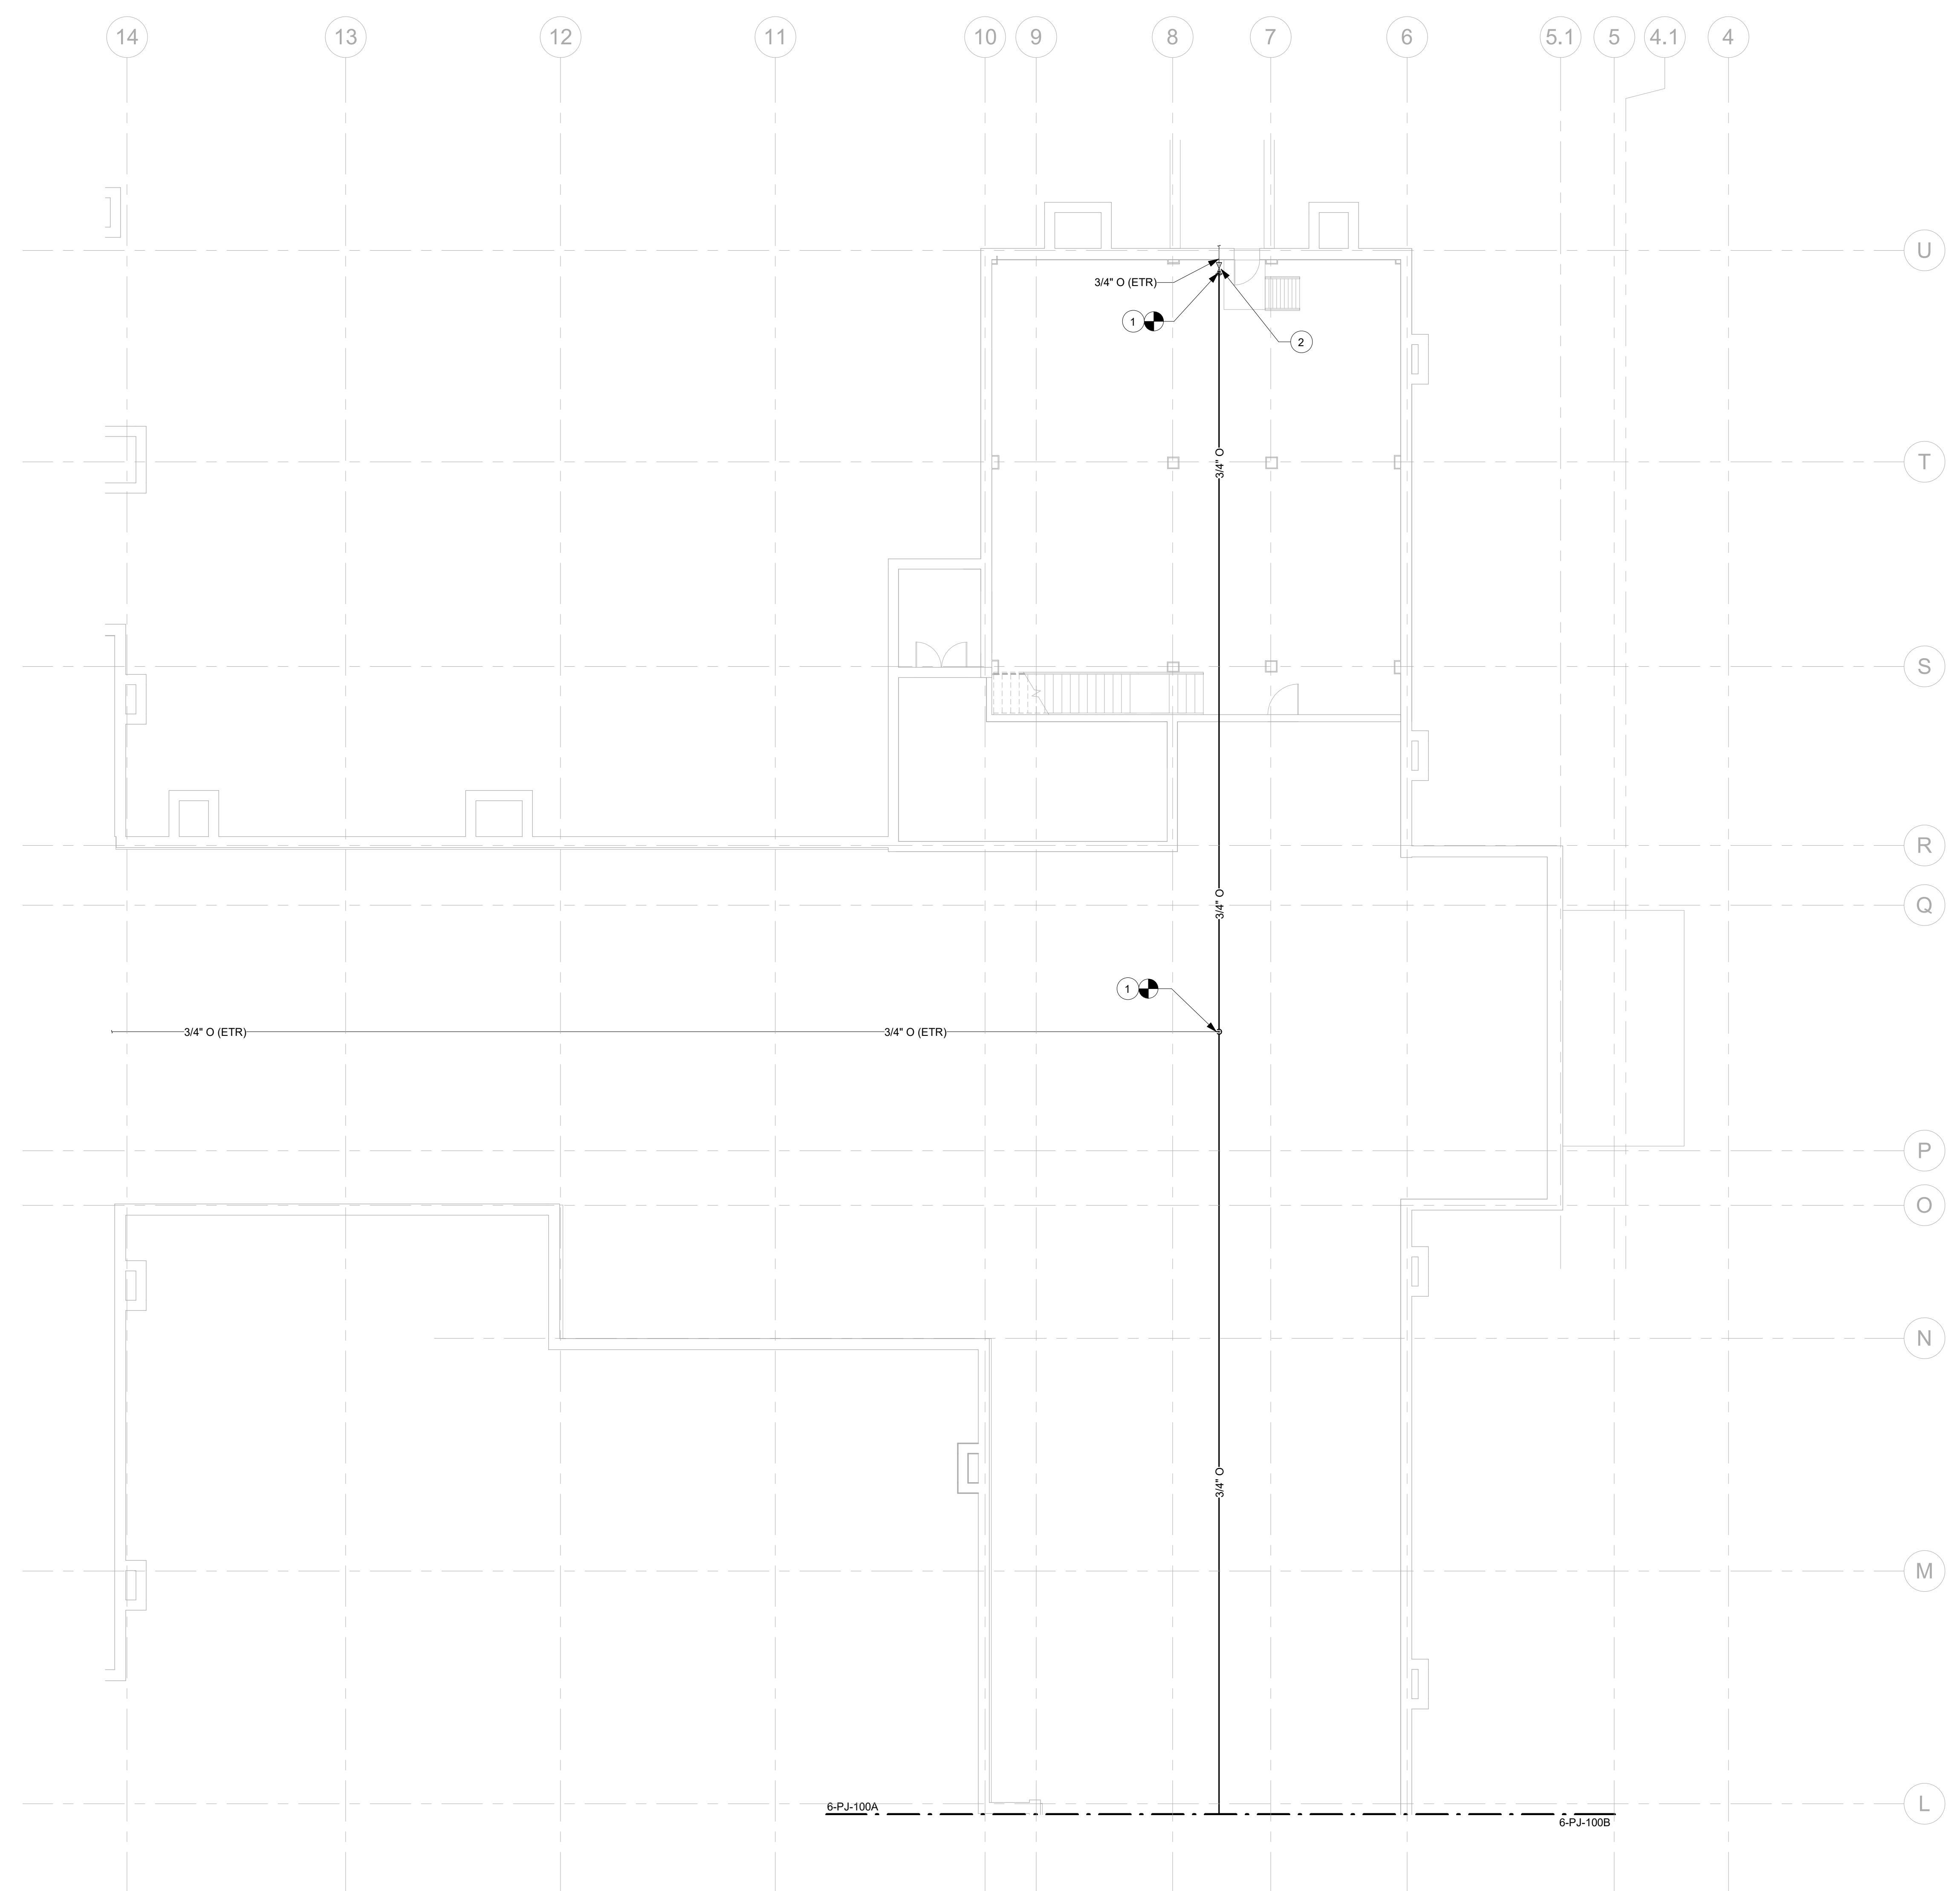- PLUMBING PLAN NOTES:**
1. CONNECT TO EXISTING MEDICAL GAS SYSTEM AT LOCATION SHOWN.
 2. PROVIDE A MAIN LINE SHUTOFF VALVE INSIDE OF THE BUILDING SERVED IN THE LOCATION SHOWN.




1 MEDICAL GAS PLAN - BASEMENT WING A FLOOR PLAN
1/8" = 1'-0"

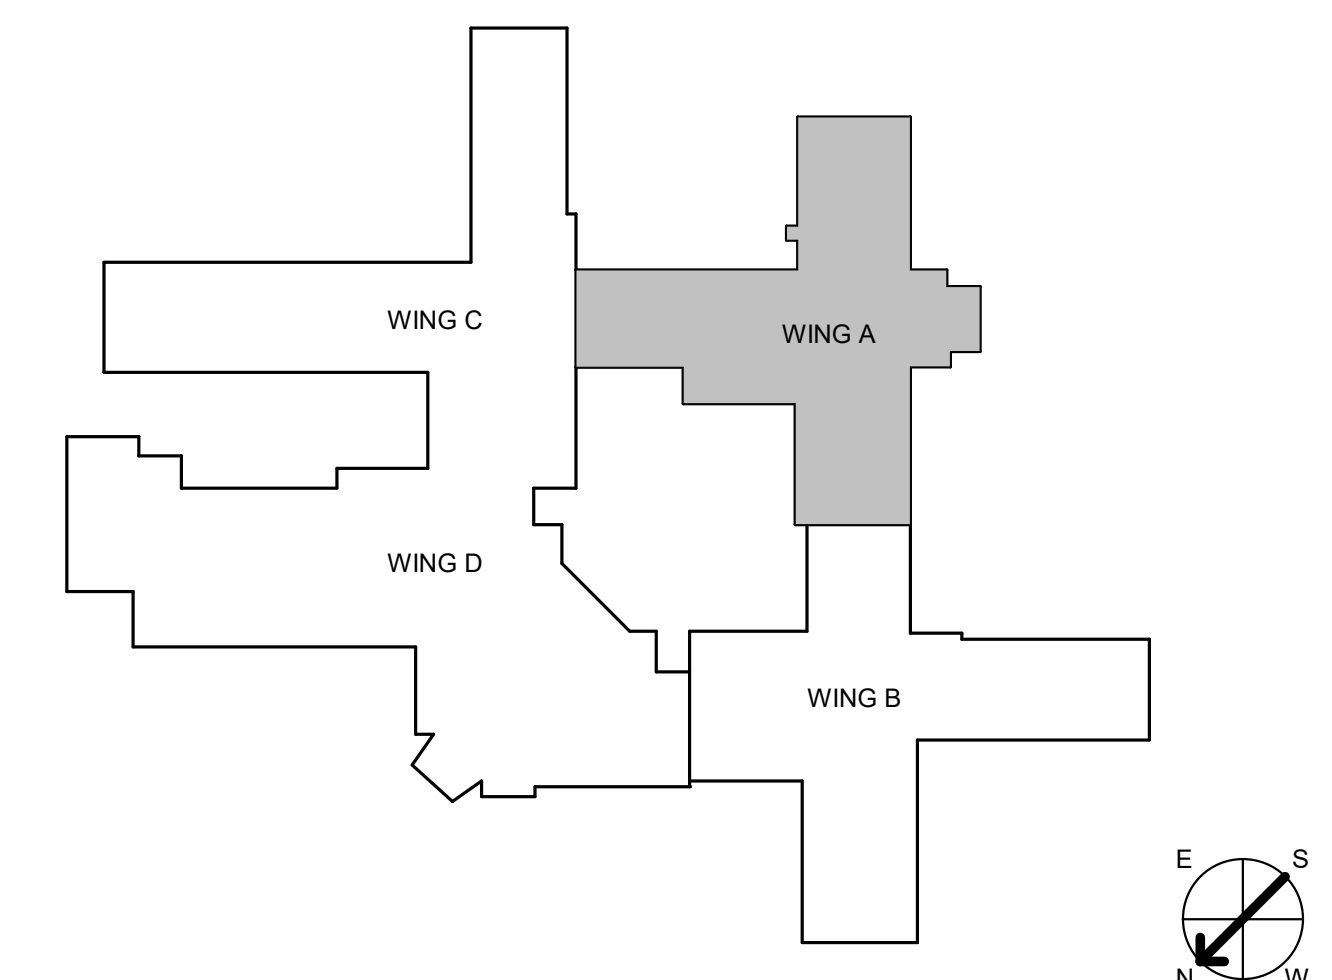three eighths inch = one foot
one quarter inch = one foot
one eighth inch = one foot
three quarters inch = one foot
one half inch = one foot
one inch = one foot
one and one half inches = one foot
three eighths inch = one foot
one quarter inch = one foot
one eighth inch = one foot
three quarters inch = one foot
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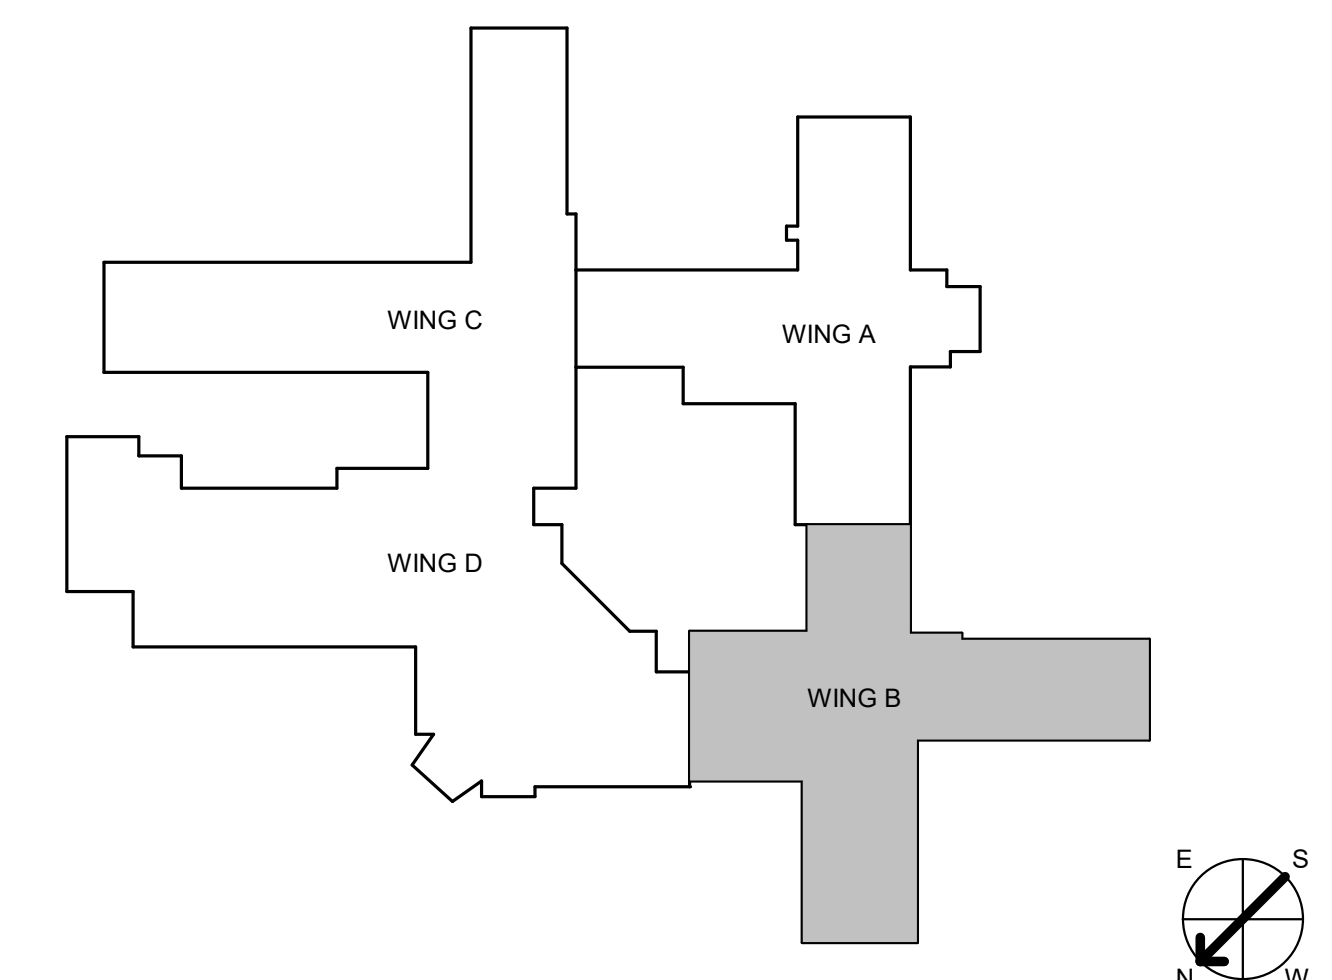
CONSULTANT INFORMATION STRUCTURAL / CIVIL ENGINEER: STAND STRUCTURAL ENGINEERING, 11827 W. 112TH STREET, SUITE 200, OVERLAND PARK, KS 66210 (913) 214-2169 MECHANICAL / ELECTRICAL / PLUMBING / TECHNICAL ENGINEER: SPUR DESIGN, 11020 KING STREET, SUITE 350, OVERLAND PARK, KS 66210 (405) 842-6100 FIRE PROTECTION ENGINEER: POOLE FIRE PROTECTION, INC., 19910 W. 161ST STREET, OLATH, KS 66062 (913) 829-8650		ARCHITECT 513 SW 23th Street, Overland Park, KS 66159 spur-design.com 10000 King Street, Suite 300, Overland Park, KS 66163 spur-design.com KS ARCH REG. NO. A-1139, EXP. 12/31/2019 KS ENGR REG. NO. E-2586, EXP. 12/31/2019		Office of Construction and Facilities Management VA U.S. Department of Veteran Affairs		SHEET TITLE: MEDICAL GAS PLAN - BASEMENT WING A FLOOR PLAN APPROVED: PROJECT DIRECTOR		PROJECT PHASE: BID DOCUMENTS FULLY SPRINKLERED		PROJECT TITLE: RENOVATE A & B WING BUILDING 6 PROJECT LOCATION: 2200 SW GAGE BLVD, TOPEKA, KS 66622 DATE: 07/10/2019 CHECKED BY: JES DRAWN BY: RLC		VA PROJECT NUMBER: 589-A5-19-116 BUILDING NUMBER: 6 DRAWING NUMBER: 6-PJ-100A Dwg. 76 OF 160	
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three inches = one foot
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


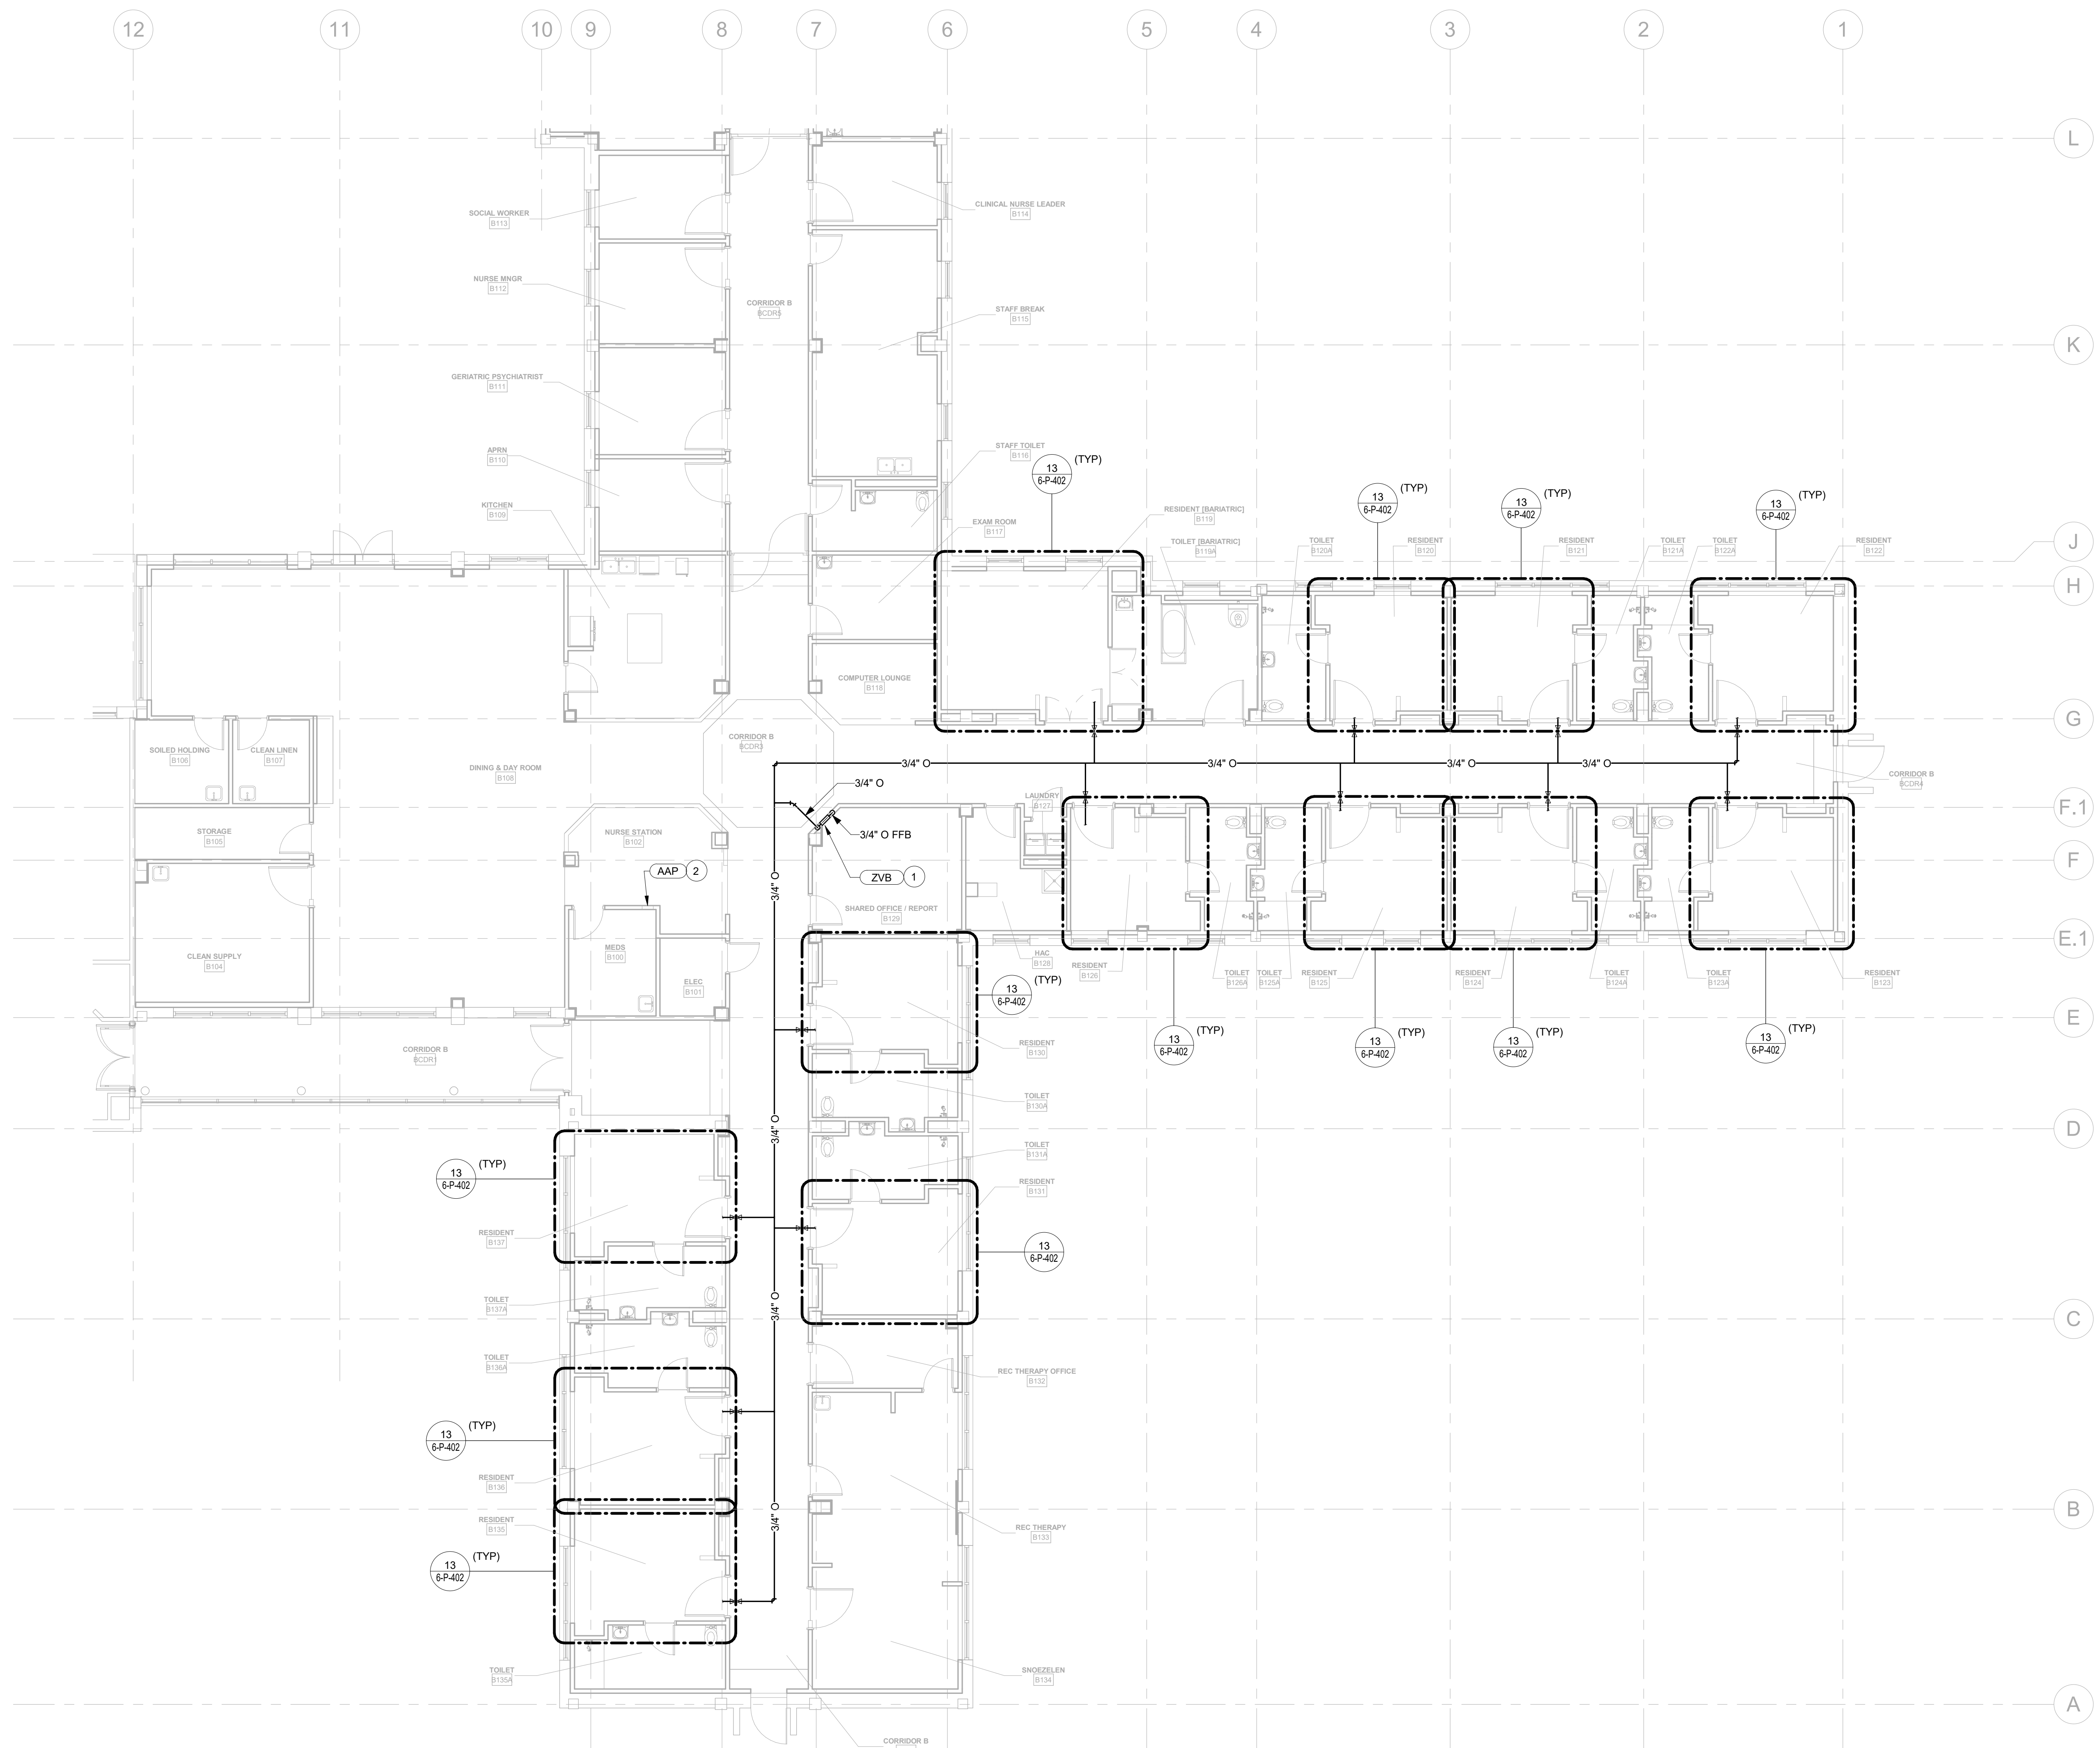
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 4. COORDINATE PLUMBING WORK WITH OTHER TRADES AND CONTRACTORS. VERIFY ALL EXISTING CONDITIONS BEFORE THE START OF WORK.
 5. POSITIVE PRESSURE PATIENT MEDICAL GAS PIPING SHALL NOT BE BREACHED OR PENETRATED BY ANY MEANS OR PROCESS THAT WILL RESULT IN RESIDUAL COPPER PARTICLES OR OTHER DEBRIS REMAINING IN THE PIPING, OR THAT AFFECTS THE OXYGEN-CLEAN INTERIOR OF THE PIPING. IF BREACHING OR PENETRATING THE MEDICAL GAS PIPING IS REQUIRED, THE PROCESS SHALL ENSURE THAT ANY DEBRIS CREATED BY THE PROCESS REMAINS CONTAINED WITHIN THE WORK AREA.
 6. ALL VALVES IN THE MEDICAL GAS SYSTEMS SHALL BE QUARTER TURN OFF WITH INDICATION OF WHETHER THE VALVE IS OPEN OR CLOSED. A LABEL SHALL BE PROVIDED ON ALL VALVES INDICATING THE TYPE OF SERVICE, THE AREA(S) OR ROOM(S) SERVED, AND A WARNING THAT THE VALVE SHALL NOT BE OPENED OR CLOSED EXCEPT FOR EMERGENCY SITUATIONS.
 7. HOT TAPS OR SIMILAR VALVE ASSEMBLIES ARE NOT PERMITTED IN MEDICAL GAS PIPING SYSTEMS.
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 9. IDENTIFY AREA ALARM(S) SHOWN WITH THE NAME OF THE MEDICAL GASES BEING SERVED AND THE AREAS MONITORED BY THE ALARM PANEL.
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- DEDUCT ALTERNATE & PHASING:**
- ALL PLAN WORK SHOWN ON THIS SHEET IS SUBJECT TO THE OVERALL PROJECT PHASING SEQUENCE OUTLINED ON ARCHITECTURAL SHEET 6-GI-102.
- IN ADDITION, IF THE DEDUCT ALTERNATE IS ELECTED, ALL PLAN WORK ON THIS SHEET IS ALSO SUBJECT TO THE REDUCED AREAS OF WORK AS DEFINED ON ARCHITECTURAL SHEET 6-GI-105.

- # PLUMBING PLAN NOTES:**
1. PROVIDE A RISER VALVE ADJACENT TO THE MAIN LINE PIPING SYSTEM IN THE LOCATION(S) SHOWN.
 2. ROUTE MEDICAL GAS PIPING TO ZONE VALVE BOX ABOVE.

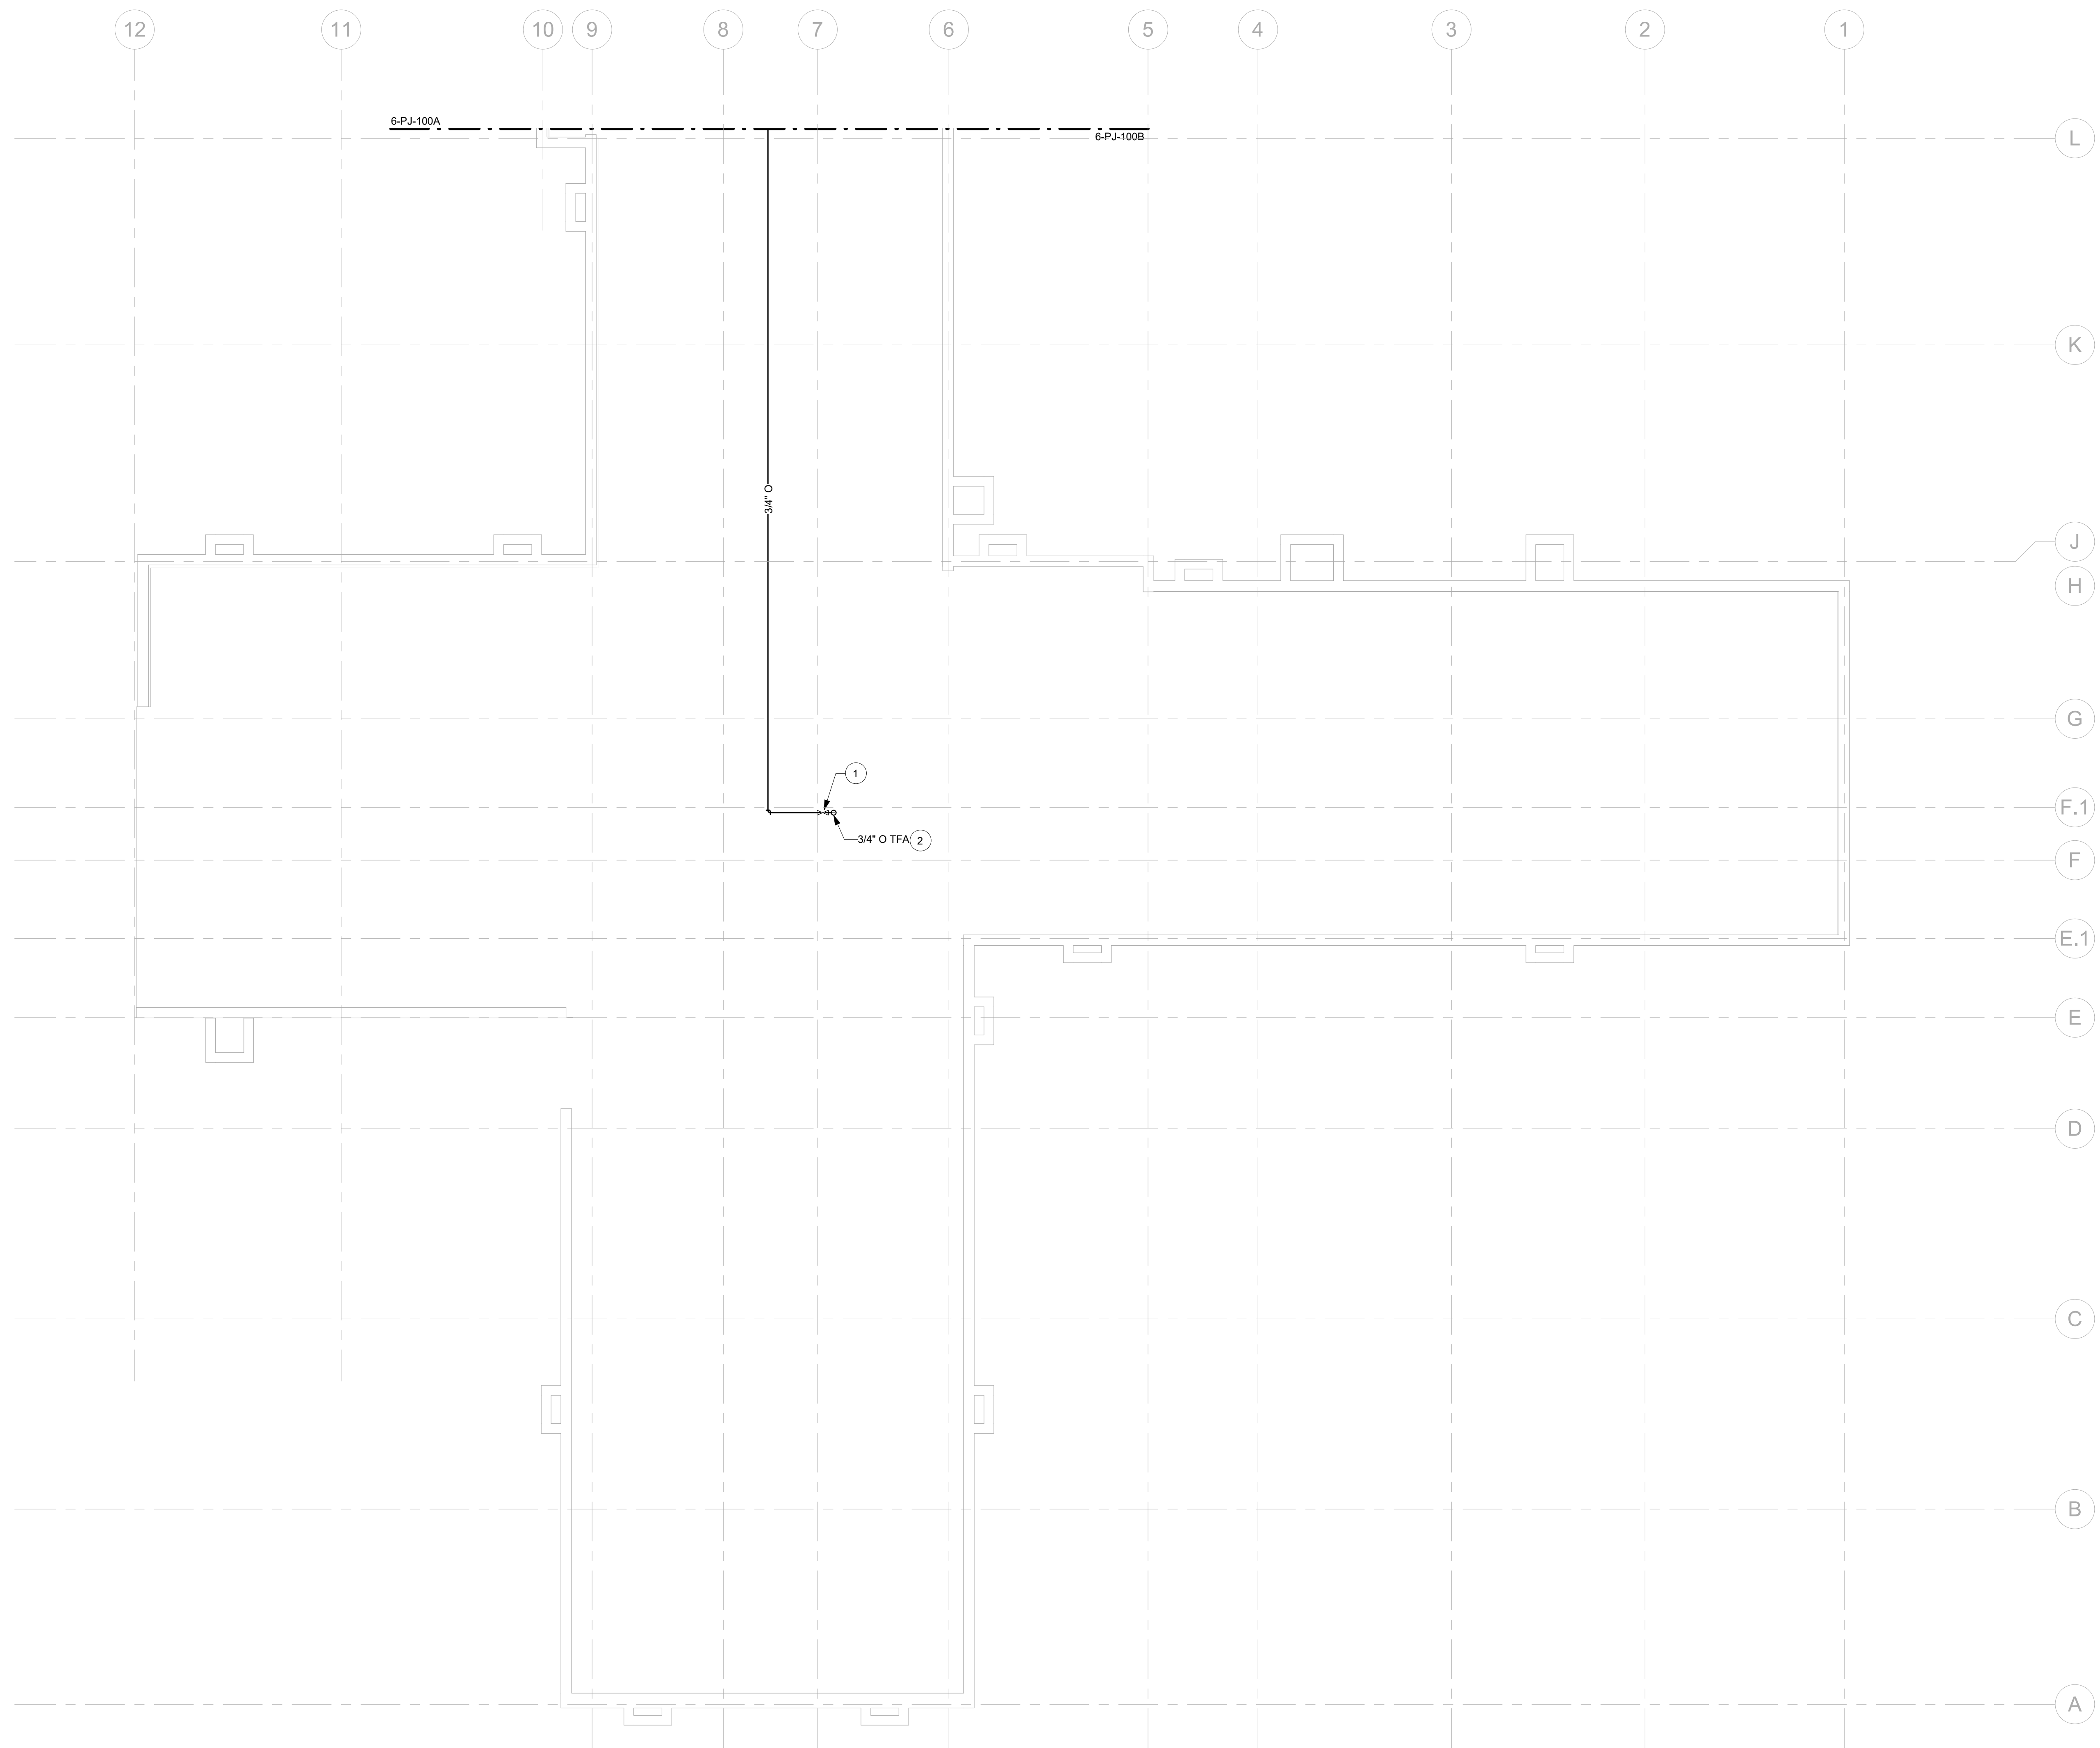

1 MEDICAL GAS PLAN - BASEMENT WING B FLOOR PLAN
 1/8" = 1'-0"


CONSULTANT INFORMATION STRUCTURAL / CIVIL ENGINEER STAND STRUCTURAL ENGINEERING 11627 W. 112TH STREET, SUITE 200 OVERLAND PARK, KS 66210 (913) 214-2169			MECHANICAL / ELECTRICAL / PLUMBING / TECHNICAL ENGINEER SPUR DESIGN 11020 KING STREET, SUITE 350 OVERLAND PARK, KS 66210 (405) 842-6100			FIRE PROTECTION ENGINEER POOLE FIRE PROTECTION, INC. 19910 W. 161ST STREET OLATH, KS 66062 (913) 829-8650			ARCHITECT  512 SW 23th Street Overland Park, KS 66209 spur-design.com 11020 King Street, Suite 350 Overland Park, KS 66210 spur-design.com			Office of Construction and Facilities Management VA U.S. Department of Veteran Affairs			SHEET TITLE MEDICAL GAS PLAN - BASEMENT WING B FLOOR PLAN APPROVED: PROJECT DIRECTOR			PROJECT PHASE BID DOCUMENTS FULLY SPRINKLERED			PROJECT TITLE RENOVATE A & B WING BUILDING 6 PROJECT LOCATION 2200 SW GAGE BLVD TOPEKA, KS 66622			VA PROJECT NUMBER 589-A5-19-116 BUILDING NUMBER 6 DRAWING NUMBER 6-PJ-100B Dwg. 77 OF 160		
Revision #		Date		DATE 07/10/2019		CHECKED BY JES		DRAWN BY RLC																		



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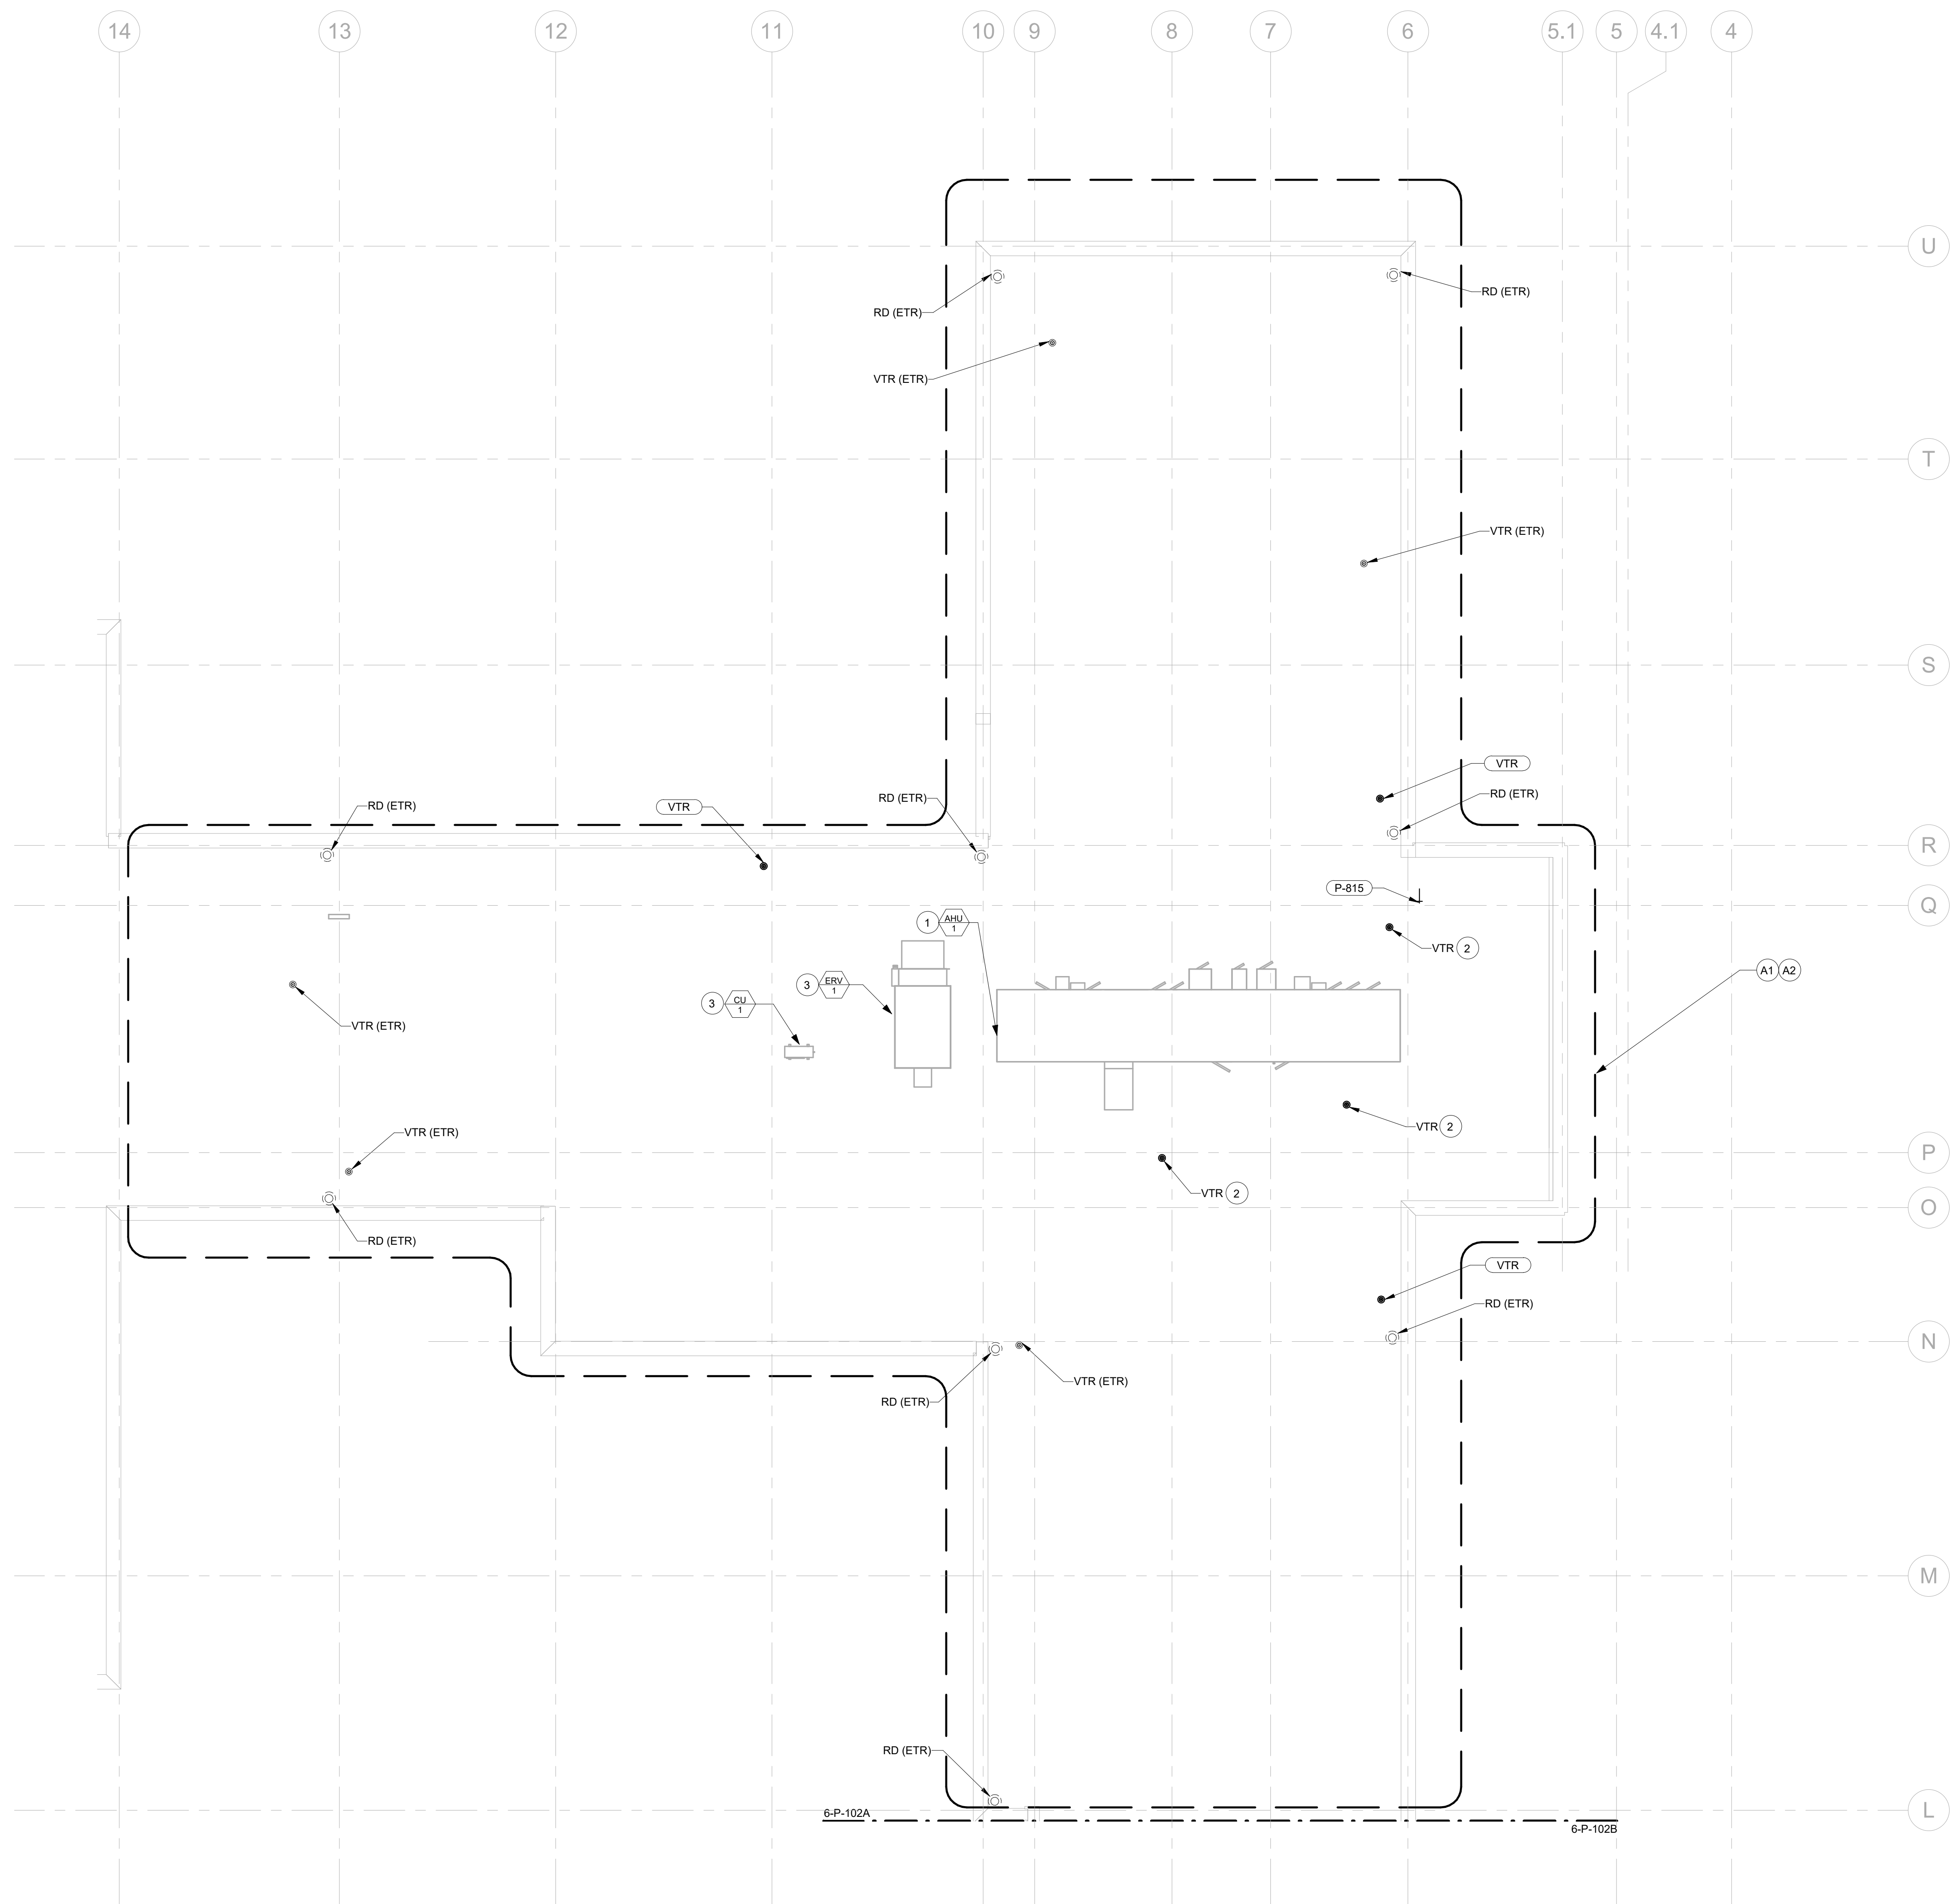
- PLUMBING PLAN NOTES:**
1. INSTALL A 1-VALVE ZONE VALVE BOX ASSEMBLY FOR THE MEDICAL GAS PIPING SYSTEMS IN THE LOCATION SHOWN. REFER TO DETAIL 1016-P-502 AND SPECIFICATIONS 22 62 00 / 22 63 00 FOR ADDITIONAL REQUIREMENTS.
 2. PROVIDE AN AREA ALARM PANEL AT NURSES STATION IN LOCATION SHOWN WITH GAS-SPECIFIC TRANSDUCERS FOR OXYGEN. PROVIDE HIGH AND LOW PRESSURE ALARM CONTACTS FOR CONNECTION TO THE BMS FOR ALARM MONITORING. REFER TO SPECIFICATIONS 22 62 00 / 22 63 00 FOR ADDITIONAL REQUIREMENTS.

1 MEDICAL GAS PLAN - LEVEL 1 WING B FLOOR PLAN
1/8" = 1'-0"

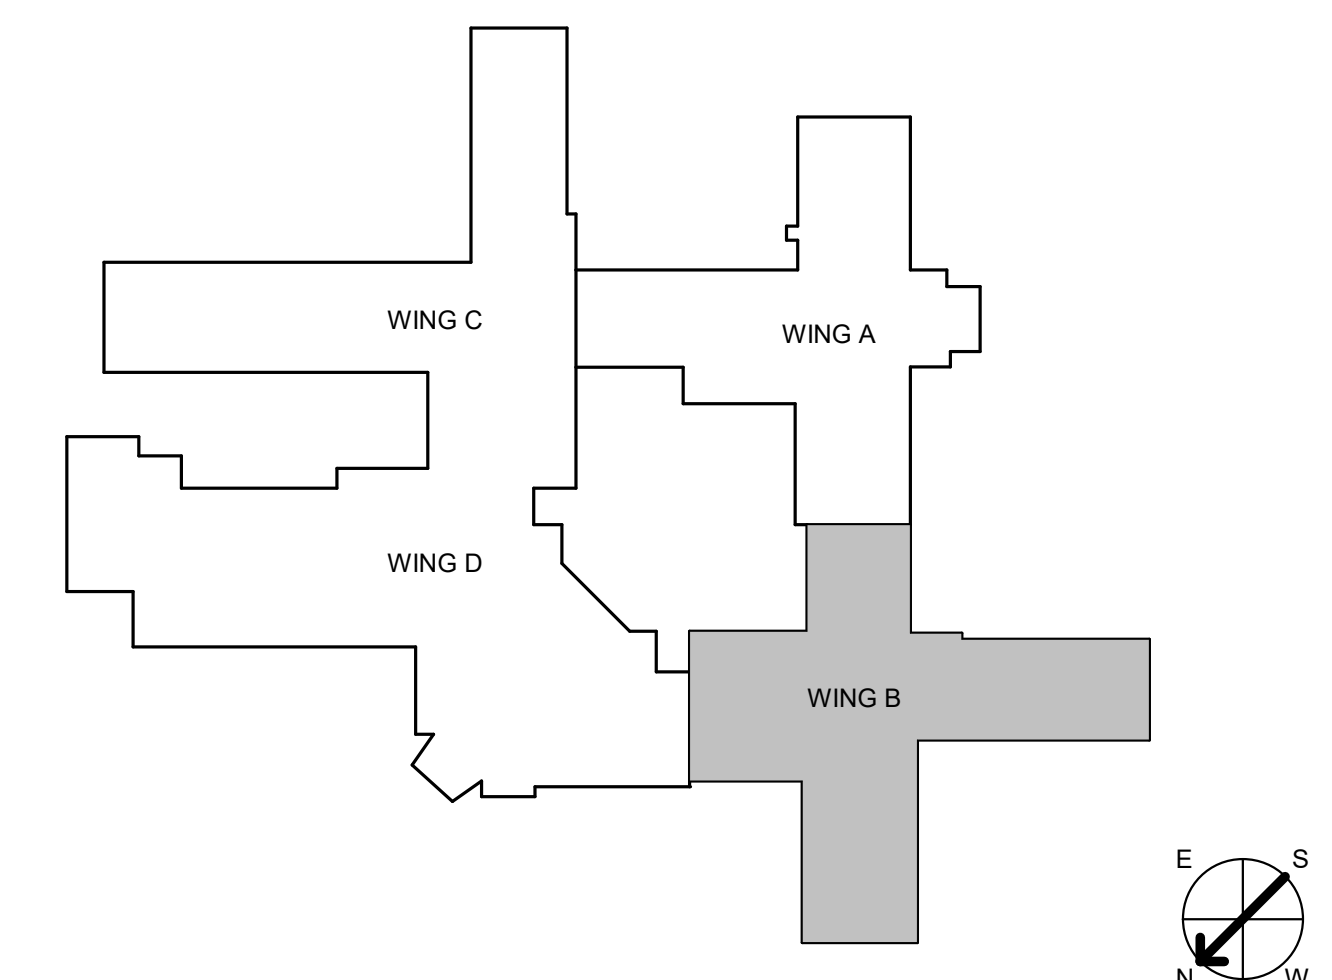

CONSULTANT INFORMATION STRUCTURAL / CIVIL ENGINEER: STAND STRUCTURAL ENGINEERING, 11627 W. 112TH STREET, SUITE 200, OVERLAND PARK, KS 66210 (913) 214-2169 MECHANICAL / ELECTRICAL / PLUMBING / TECHNICAL ENGINEER: SPUR DESIGN, 11020 KING STREET, SUITE 350, OVERLAND PARK, KS 66210 (405) 842-6100 FIRE PROTECTION ENGINEER: POOLE FIRE PROTECTION, INC., 19910 W. 161ST STREET, OLATH, KS 66062 (913) 829-8650			ARCHITECT 333 SW 23th Street, Overland Park, KS 66209 10000 King Street, Suite 300, Overland Park, KS 66209 KS ARCH REG. NO. A-1139, EXP. 12/31/2019 KS ENGR REG. NO. E-2586, EXP. 12/31/2019		Office of Construction and Facilities Management VA U.S. Department of Veteran Affairs		SHEET TITLE: MEDICAL GAS PLAN - LEVEL 1 WING B FLOOR PLAN APPROVED: PROJECT DIRECTOR		PROJECT PHASE: BID DOCUMENTS FULLY SPRINKLERED		PROJECT TITLE: RENOVATE A & B WING BUILDING 6 PROJECT LOCATION: 2200 SW GAGE BLVD, TOPEKA, KS 66622 DATE: 07/10/2019 CHECKED BY: JES DRAWN BY: RLC		VA PROJECT NUMBER: 589-A5-19-116 BUILDING NUMBER: 6 DRAWING NUMBER: 6-PJ-101B Dwg. 78 OF 160	
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three inches = one foot
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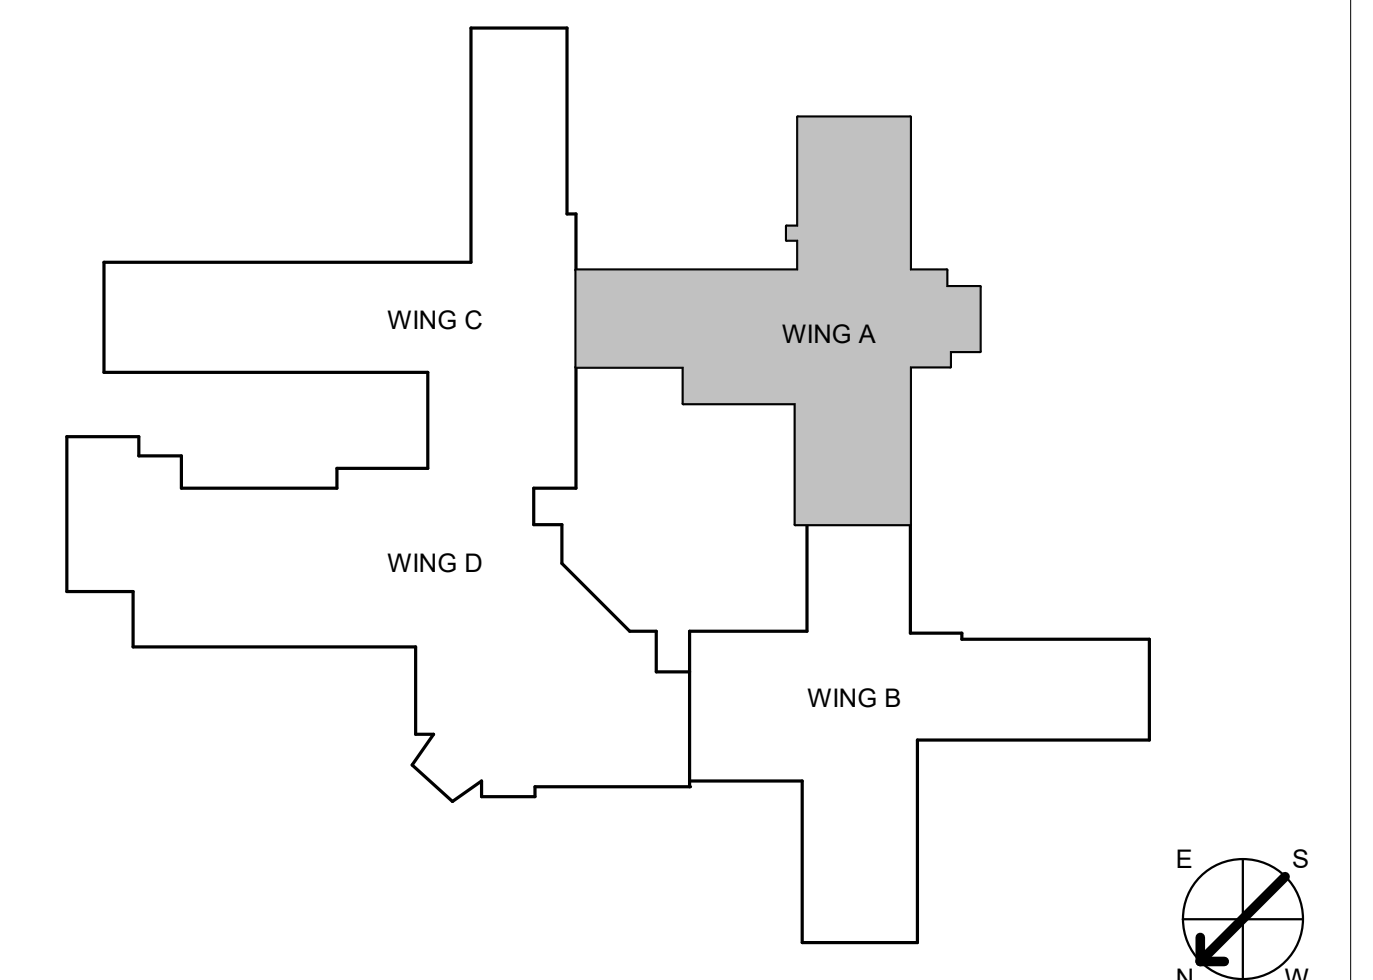


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 5. COORDINATE TEMPORARY ROOF DRAINAGE DURING CONSTRUCTION AND REPLACEMENT OF STORM PIPE.
 6. THE DEMOLITION DRAWINGS ARE DEEMED SCHEMATIC. CONTRACTOR RESPONSIBLE FOR FIELD VERIFYING EXISTING DEMOLITION WORK PRIOR TO SUBMISSION OF PROPOSAL.
 7. ALL PLUMBING FIXTURES SHOWN ON THIS SHEET ARE EXISTING TO BE DEMOLISHED UNLESS NOTED OTHERWISE.



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- PLUMBING PLAN NOTES:**
1. SEE MECHANICAL FOR NEW AHU LOCATION. COORDINATE VENT TERMINATIONS AND ROOF DRAINS TO ACCOMMODATE TO AHU.
 2. DEMOLISH EXISTING VENT THROUGH ROOF.
 3. SEE MECHANICAL FOR EQUIPMENT LOCATIONS AND SCHEDULES.


- DEDUCT ALTERNATE NOTES:**
- A1. IF DEDUCT ALTERNATE IS ACCEPTED, DO NOT DEMOLISH EXISTING VENTS THROUGH ROOF.
 - A2. IF DEDUCT ALTERNATE IS ACCEPTED, DO NOT PROVIDE NEW VENTS THROUGH ROOF.



1 PLUMBING PLAN - WING A ROOF PLAN
 1/8" = 1'-0"

CONSULTANT INFORMATION STRUCTURAL / CIVIL ENGINEER STAND STRUCTURAL ENGINEERING 11927 W. 112TH STREET, SUITE 200 OVERLAND PARK, KS 66210 (913) 214-2169		MECHANICAL / ELECTRICAL / PLUMBING / TECHNICAL ENGINEER SPUR DESIGN 11020 KING STREET, SUITE 350 OVERLAND PARK, KS 66210 (405) 842-6100		FIRE PROTECTION ENGINEER POOLE FIRE PROTECTION, INC. 19910 W. 161ST STREET OLATH, KS 66062 (913) 829-8650		ARCHITECT  513 SW 23th Street Overland Park, KS 66150 spur-design.com 11020 King Street, Suite 350 Overland Park, KS 66150 spur-design.com		Office of Construction and Facilities Management VA U.S. Department of Veteran Affairs		SHEET TITLE PLUMBING PLAN - WING A ROOF PLAN APPROVED: PROJECT DIRECTOR		PROJECT PHASE BID DOCUMENTS FULLY SPRINKLERED		PROJECT TITLE RENOVATE A & B WING BUILDING 6		VA PROJECT NUMBER 589-A5-19-116	
Revision #		Date		KS ARCH REG. NO. A-1139, EXP. 12/31/2019 KS ENGR REG. NO. E-2586, EXP. 12/31/2019				DATE 07/10/2019		CHECKED BY JES		DRAWN BY RLC		BUILDING NUMBER 6			
												PROJECT LOCATION 2200 SW GAGE BLVD TOPEKA, KS 66622		DRAWING NUMBER 6-P-102A			
														Dwg. 79 OF 160			

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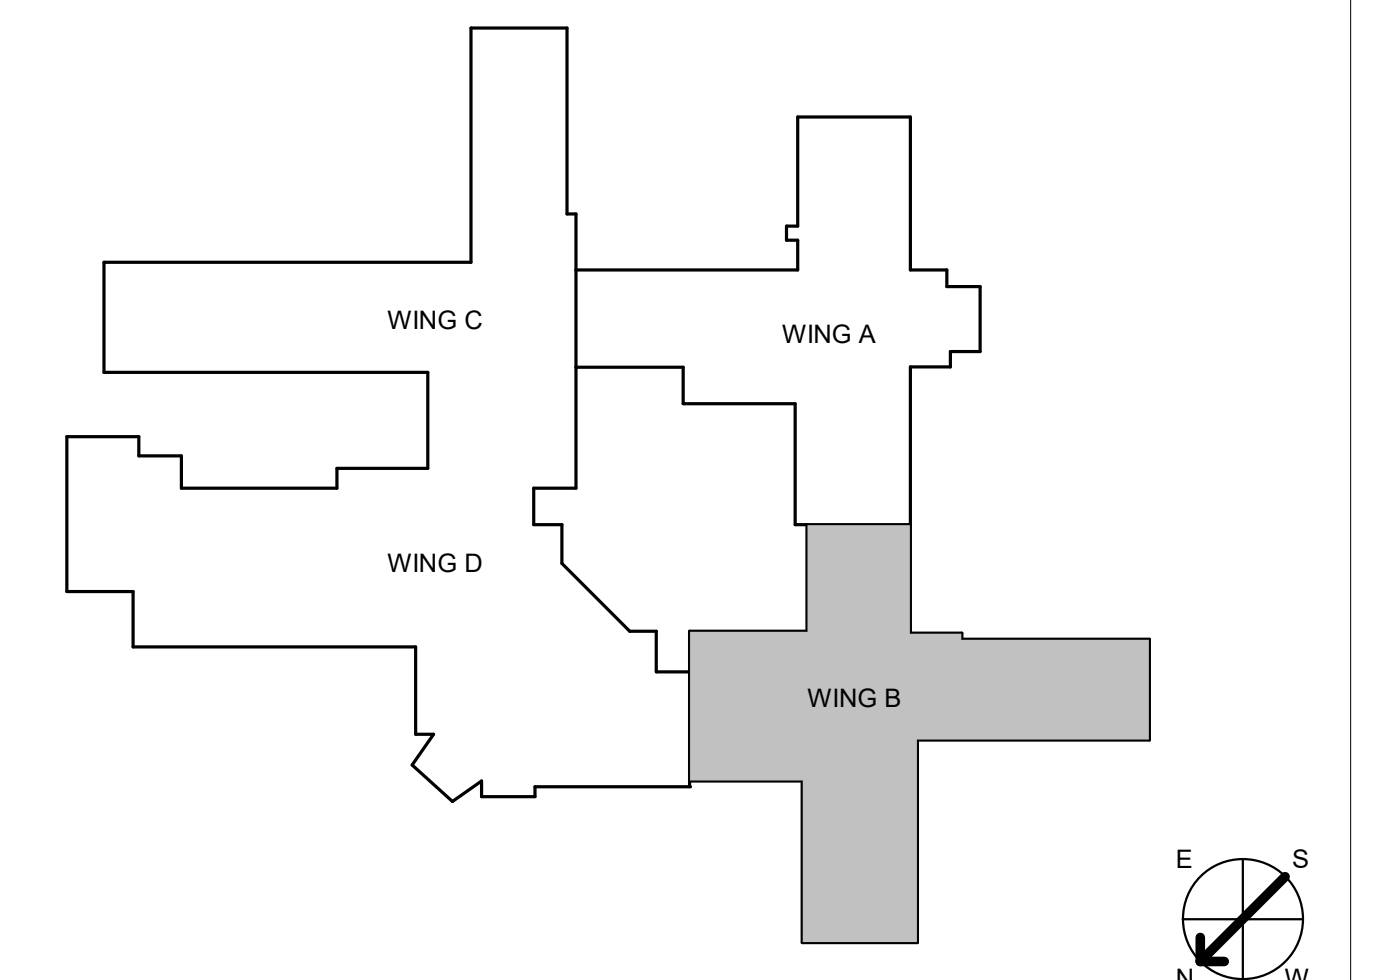
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
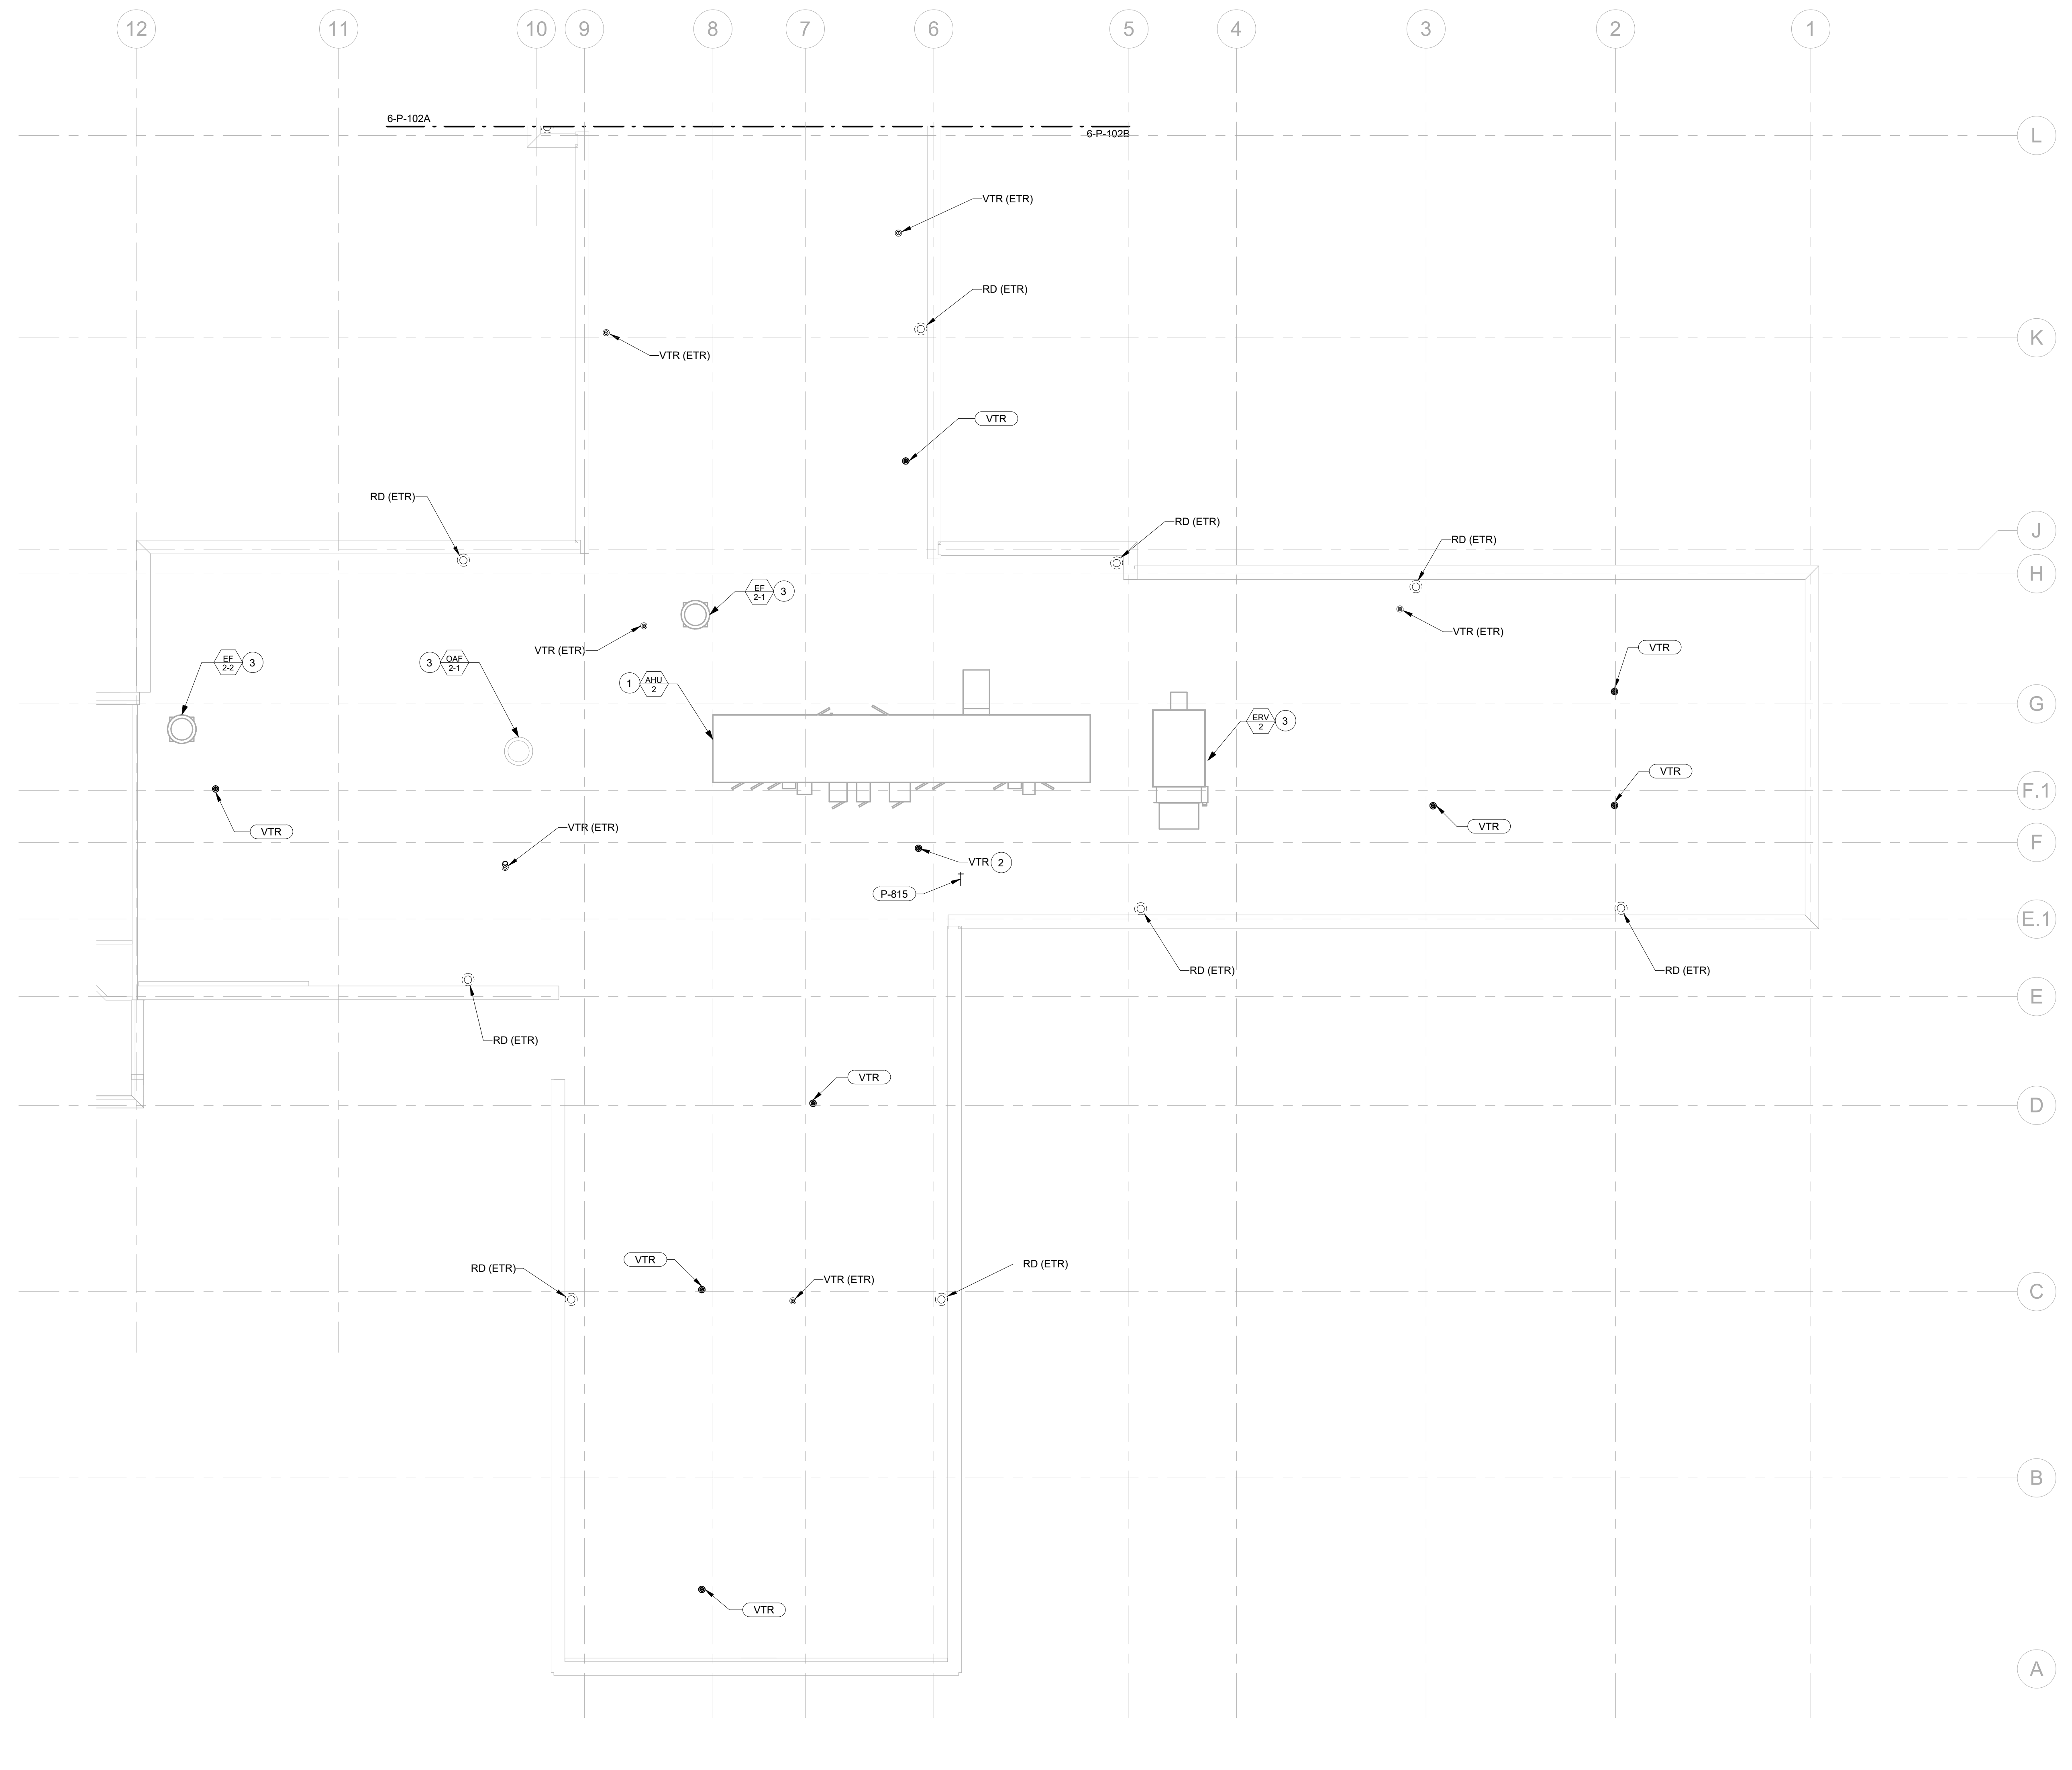
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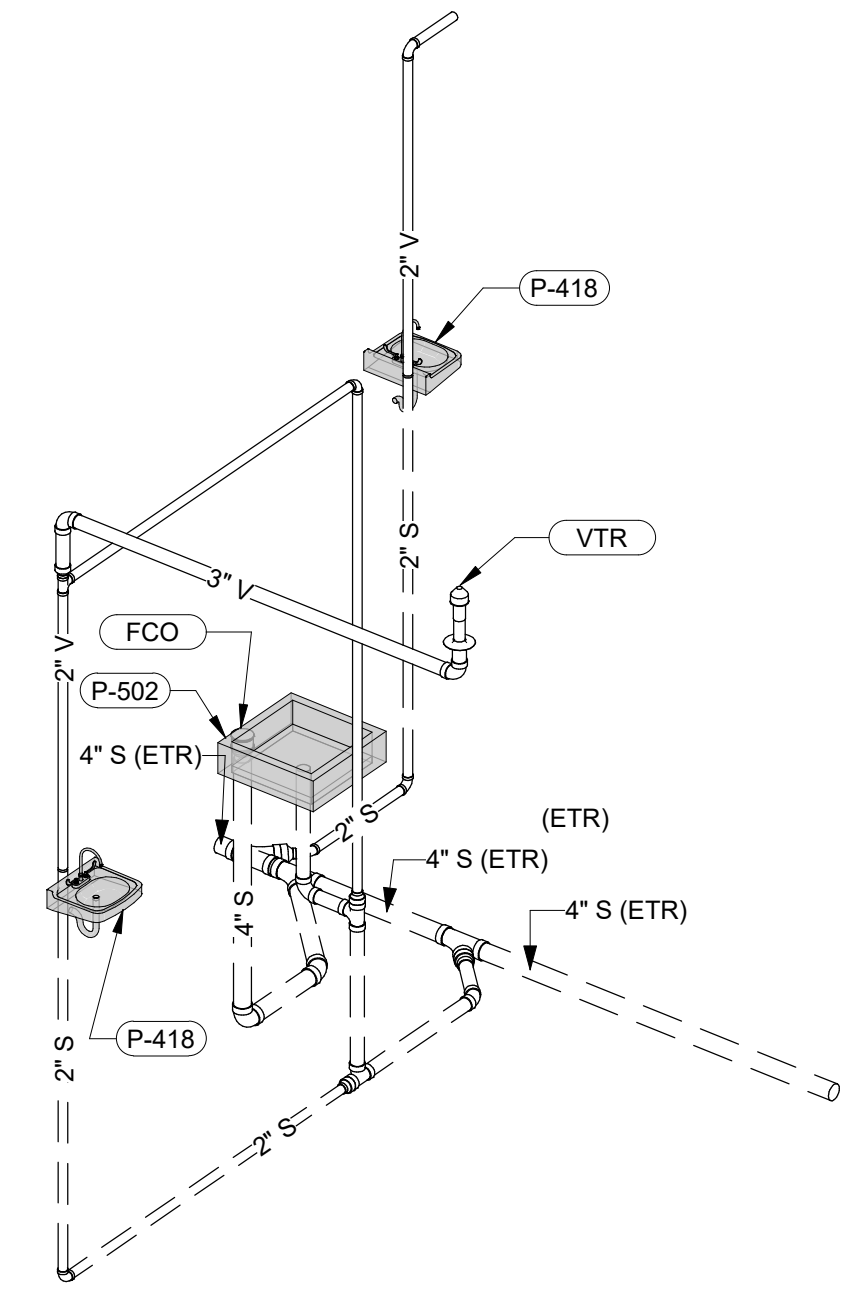
1. SEE MECHANICAL FOR NEW AHU LOCATION. COORDINATE VENT TERMINATIONS AND ROOF DRAINS TO ACCOMMODATE TO AHU.
2. DEMOLISH EXISTING VENT THROUGH ROOF.
3. SEE MECHANICAL FOR EQUIPMENT LOCATIONS AND SCHEDULES.

1 PLUMBING PLAN - WING B ROOF PLAN
 1/8" = 1'-0"




CONSULTANT INFORMATION STRUCTURAL / CIVIL ENGINEER STAND STRUCTURAL ENGINEERING 11627 W. 112TH STREET, SUITE 200 OVERLAND PARK, KS 66210 (913) 214-2169		MECHANICAL / ELECTRICAL / PLUMBING / TECHNICAL ENGINEER SPUR DESIGN 11020 KING STREET, SUITE 350 OVERLAND PARK, KS 66210 (405) 842-6100		FIRE PROTECTION ENGINEER POOLE FIRE PROTECTION, INC. 19910 W. 161ST STREET OLATH, KS 66062 (913) 829-8650		ARCHITECT  513 SW 20th Street Overland Park, KS 66150 spur-design.com 11020 King Street, Suite 300 Overland Park, KS 66150 spur-design.com		Office of Construction and Facilities Management VA U.S. Department of Veteran Affairs		SHEET TITLE PLUMBING PLAN - WING B ROOF PLAN APPROVED: PROJECT DIRECTOR		PROJECT PHASE BID DOCUMENTS FULLY SPRINKLERED		PROJECT TITLE RENOVATE A & B WING BUILDING 6		VA PROJECT NUMBER 589-A5-19-116					
Revision #		Date		KS ARCH REG. NO. A-1139, EXP. 12/31/2019 KS ENGR REG. NO. E-2586, EXP. 12/31/2019				PROJECT LOCATION 2200 SW GAGE BLVD TOPEKA, KS 66622		BUILDING NUMBER 6		DRAWING NUMBER 6-P-102B		DATE 07/10/2019		CHECKED BY JES		DRAWN BY RLC		Dwg. 80 OF 160	


A
B
C
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E
F




5 PT/OT (A110), EXAM (A126), AND HAC (A127)

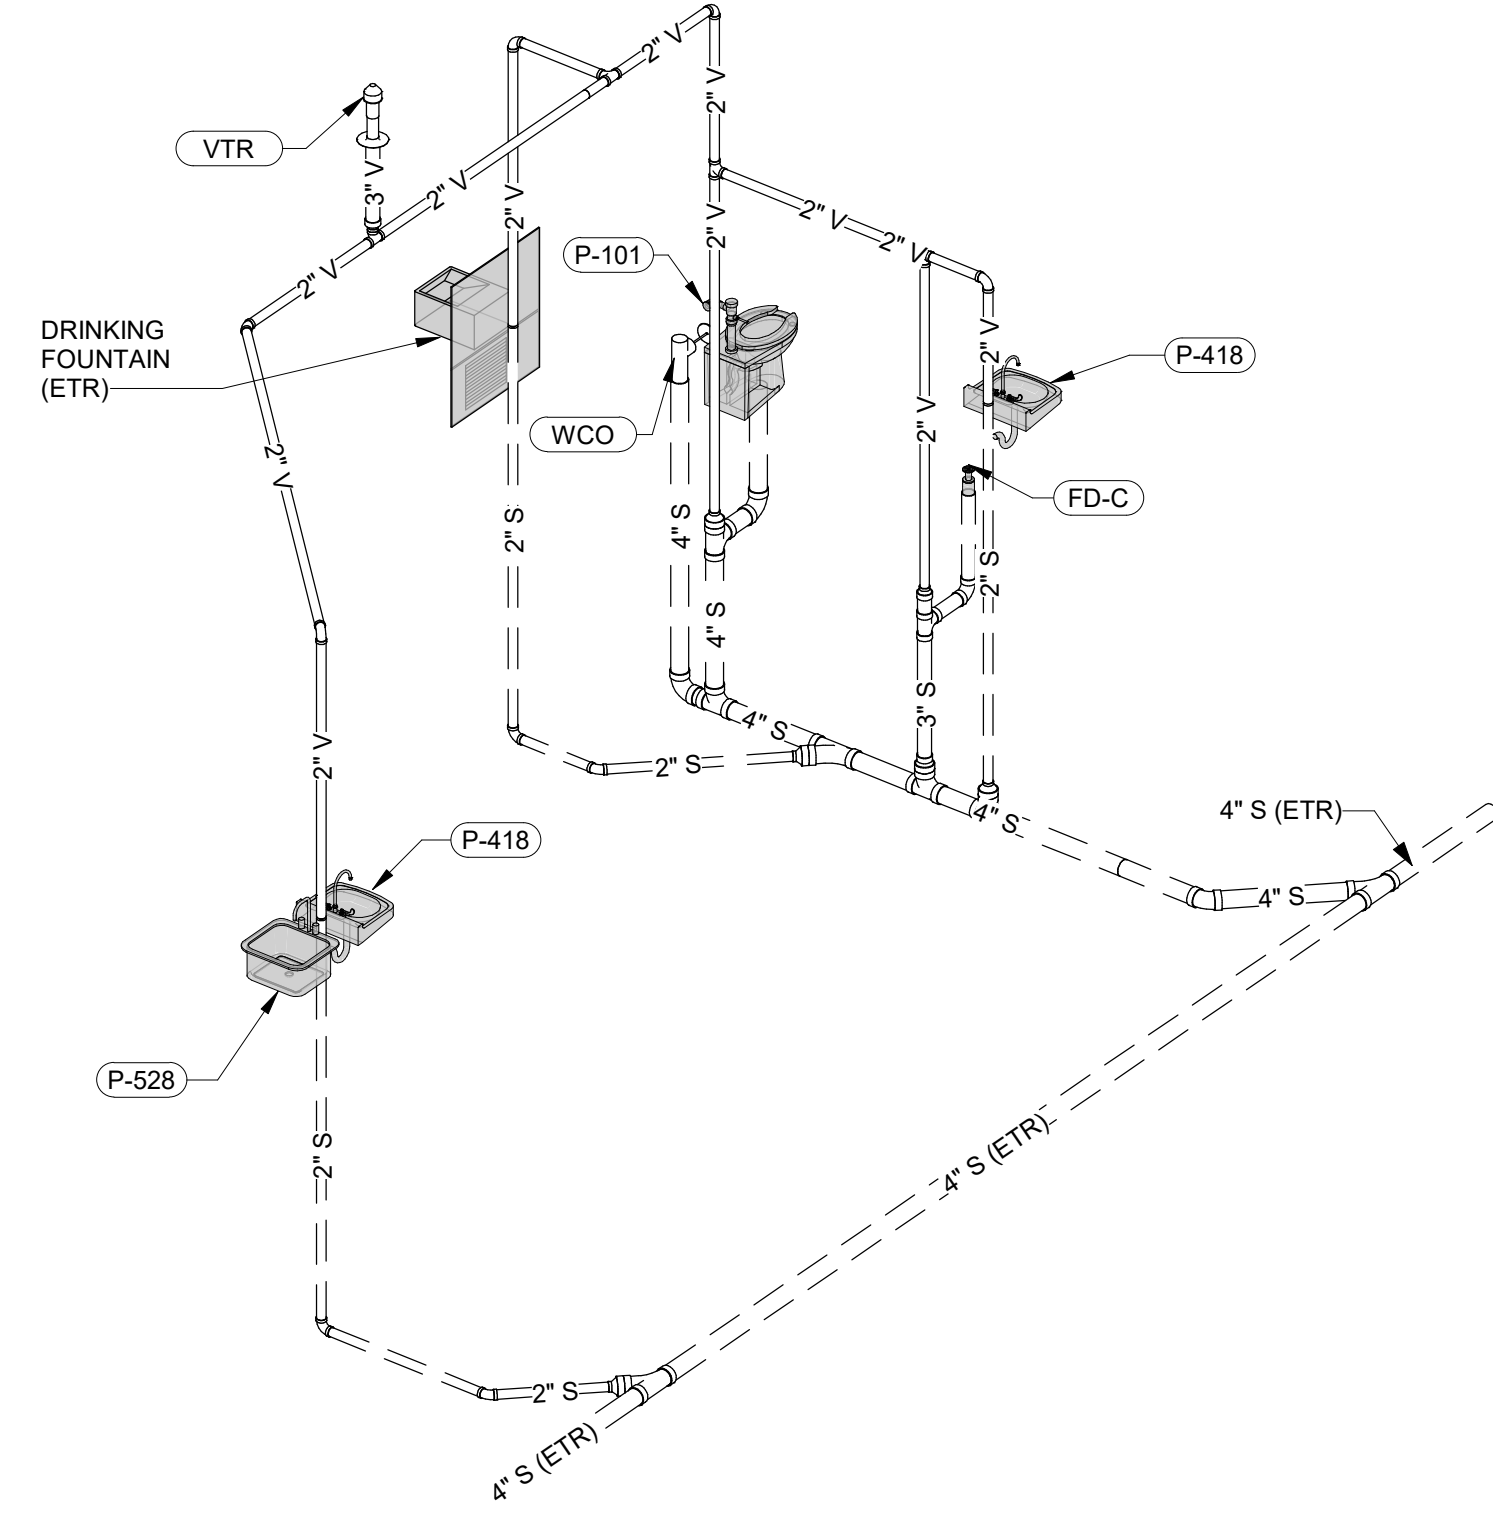


3 RECEPTION (A101), FAMILY TOILET (A102), NURSE MED (A137), AND BARIATRIC EXAM (A138)

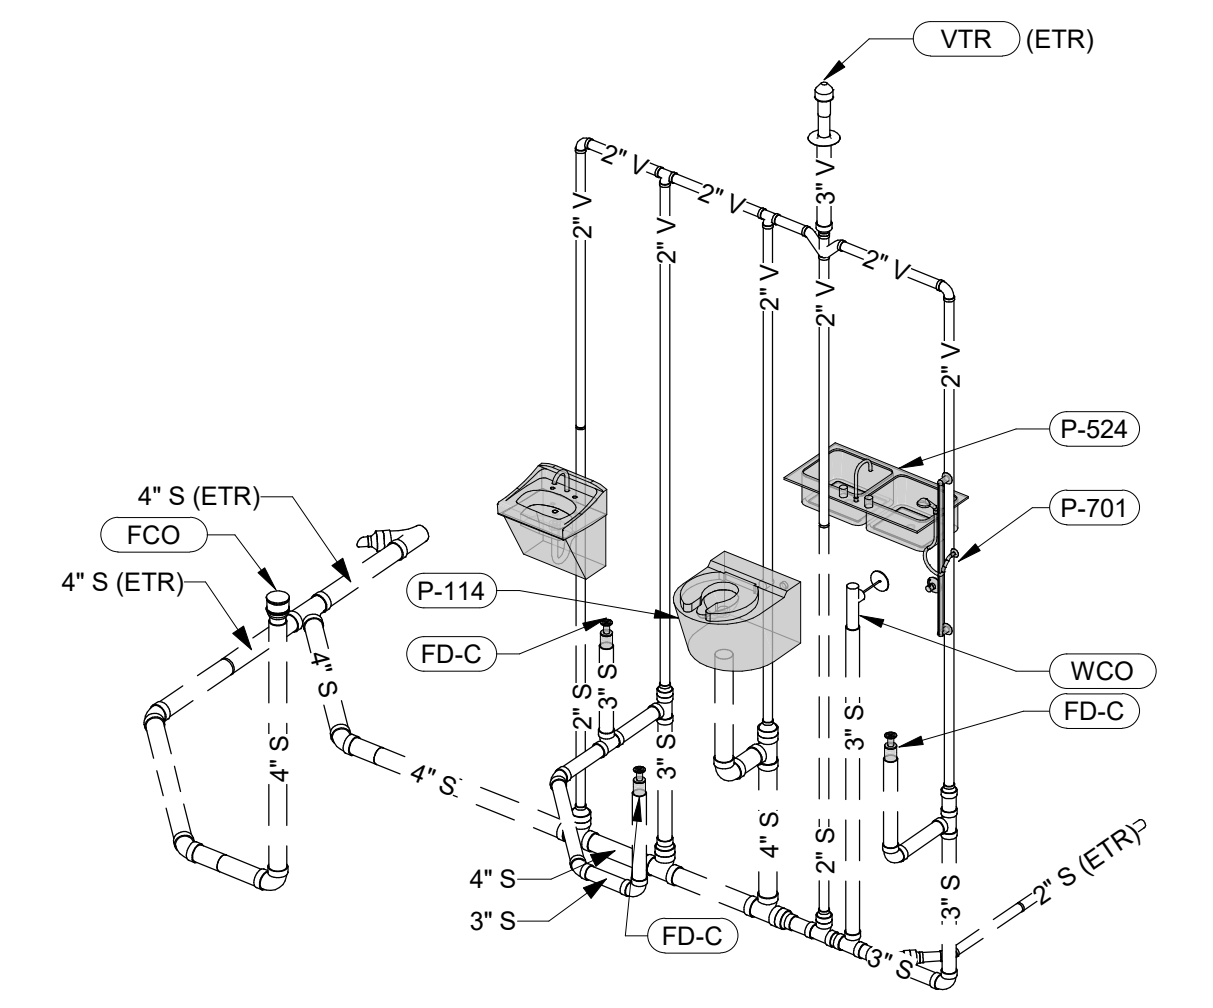


1 BREAK ROOM (A132) AND BARIATRIC TOILET (A133)

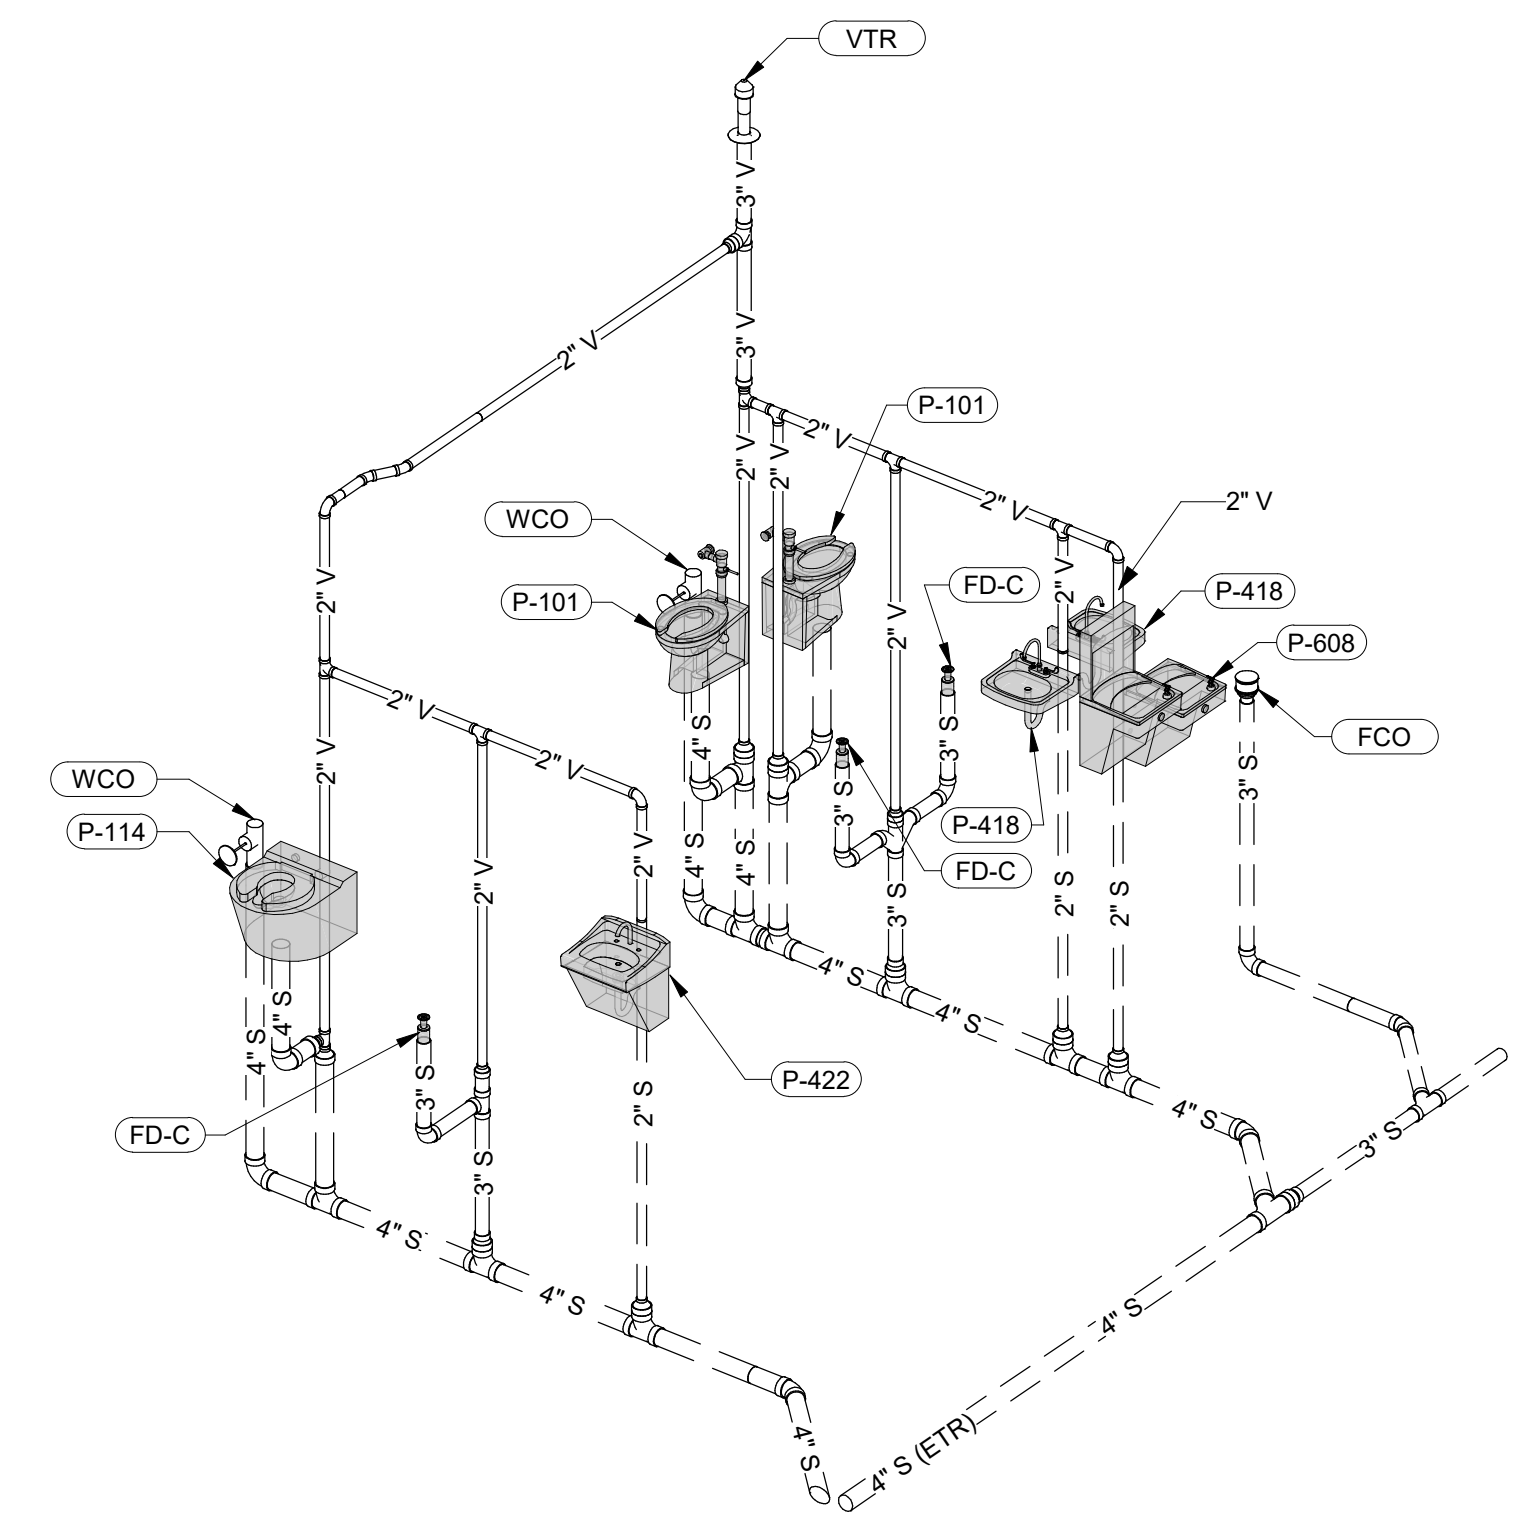

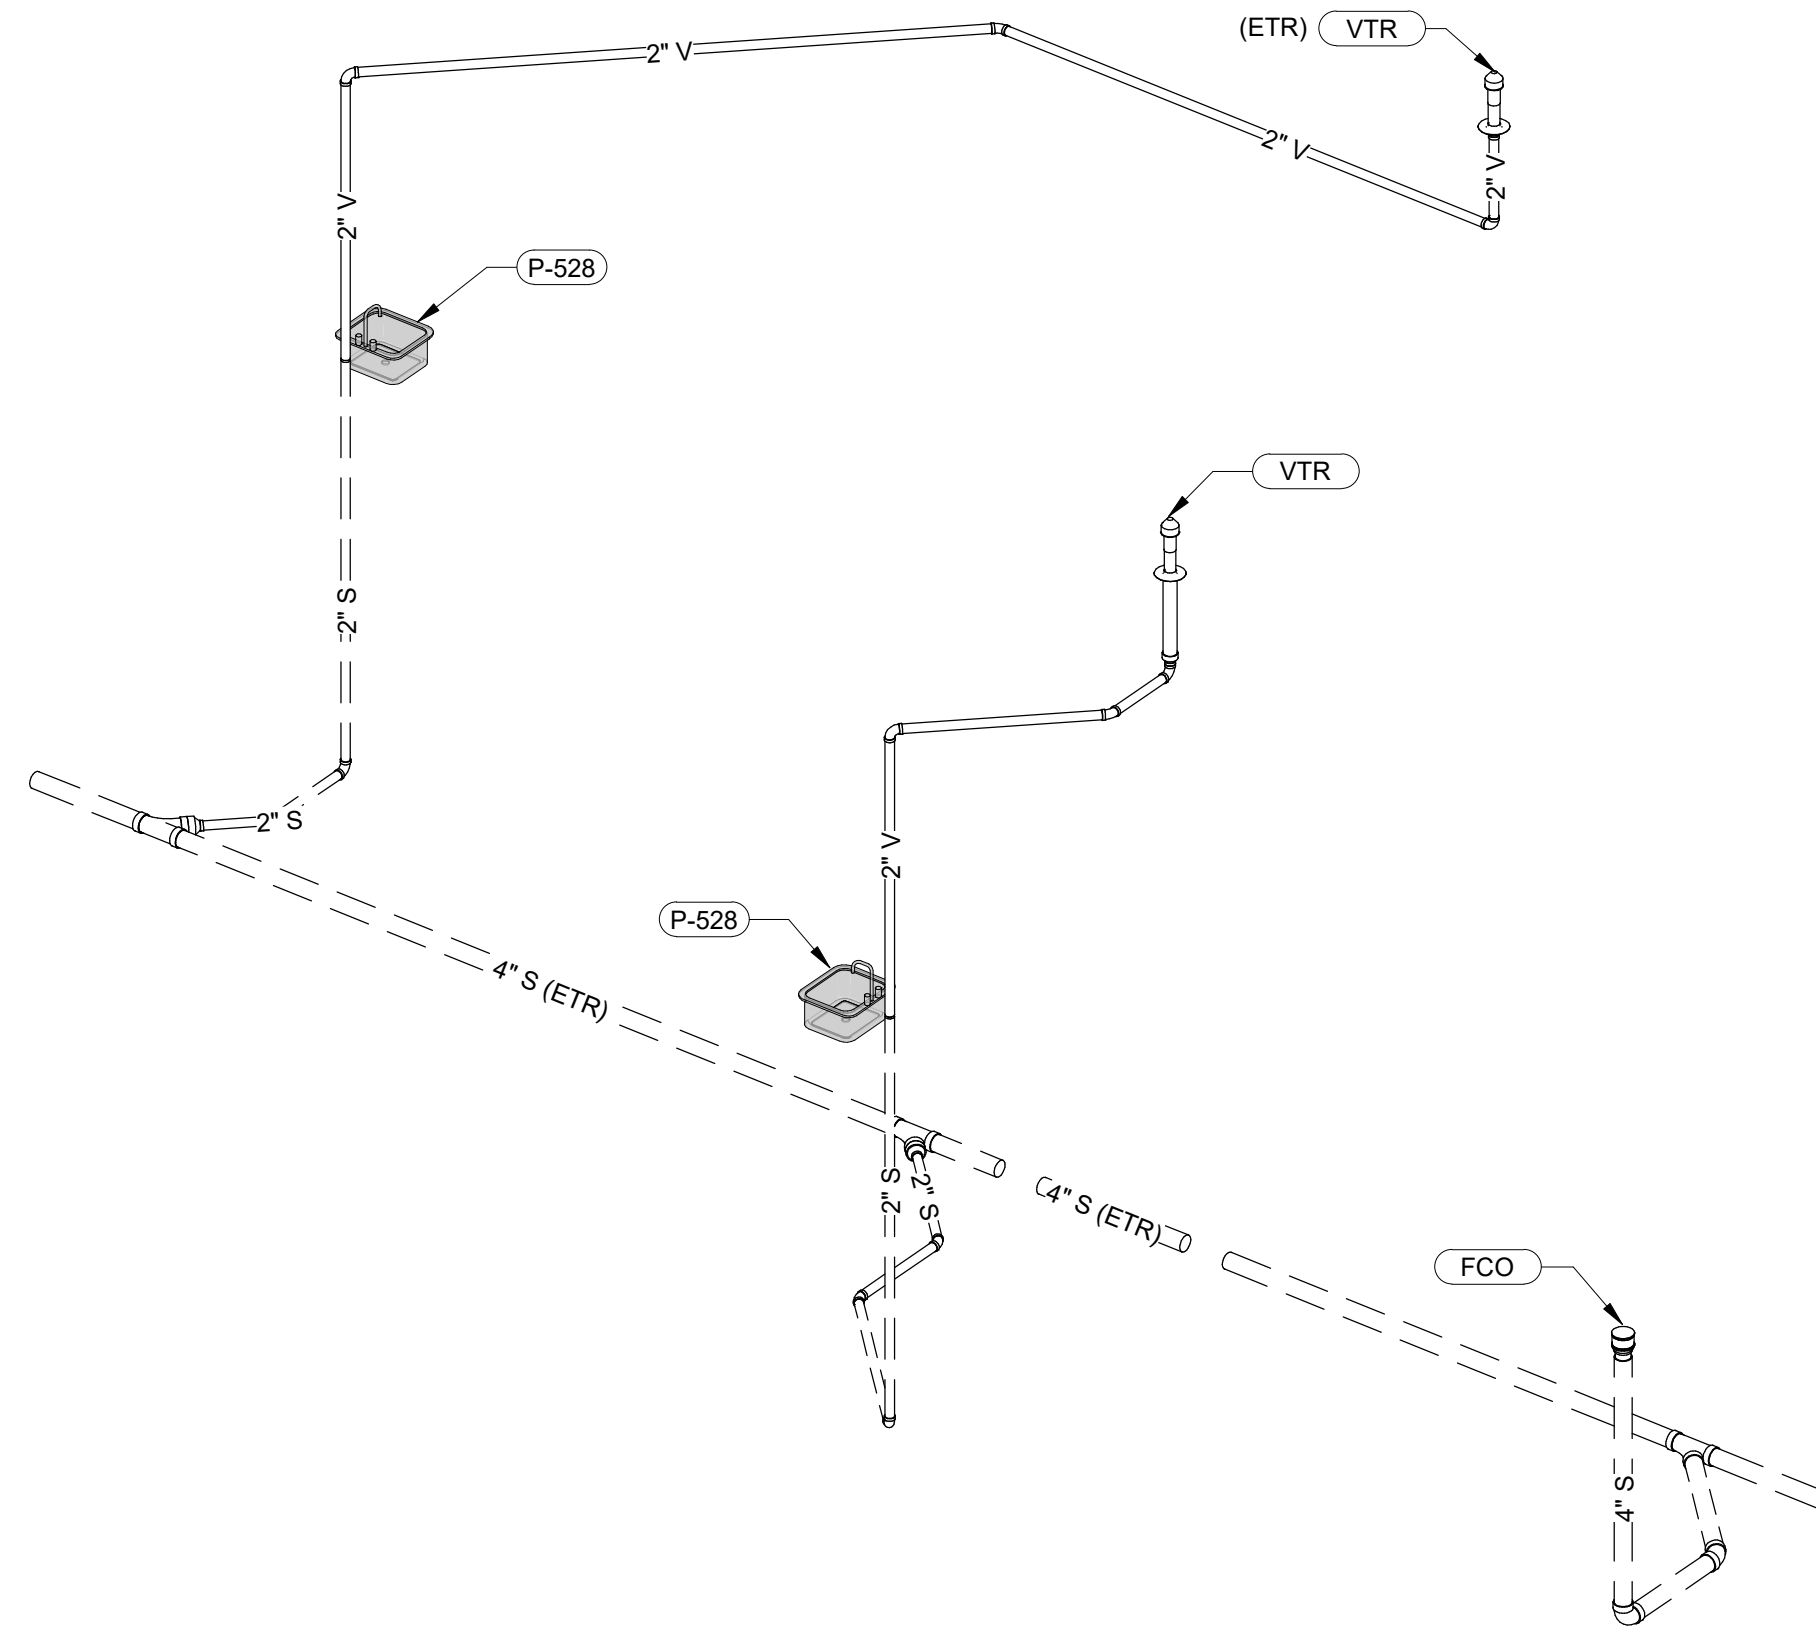

6 BARIATRIC TOILET (A103), STAFF TOILETS (A105 & A106)

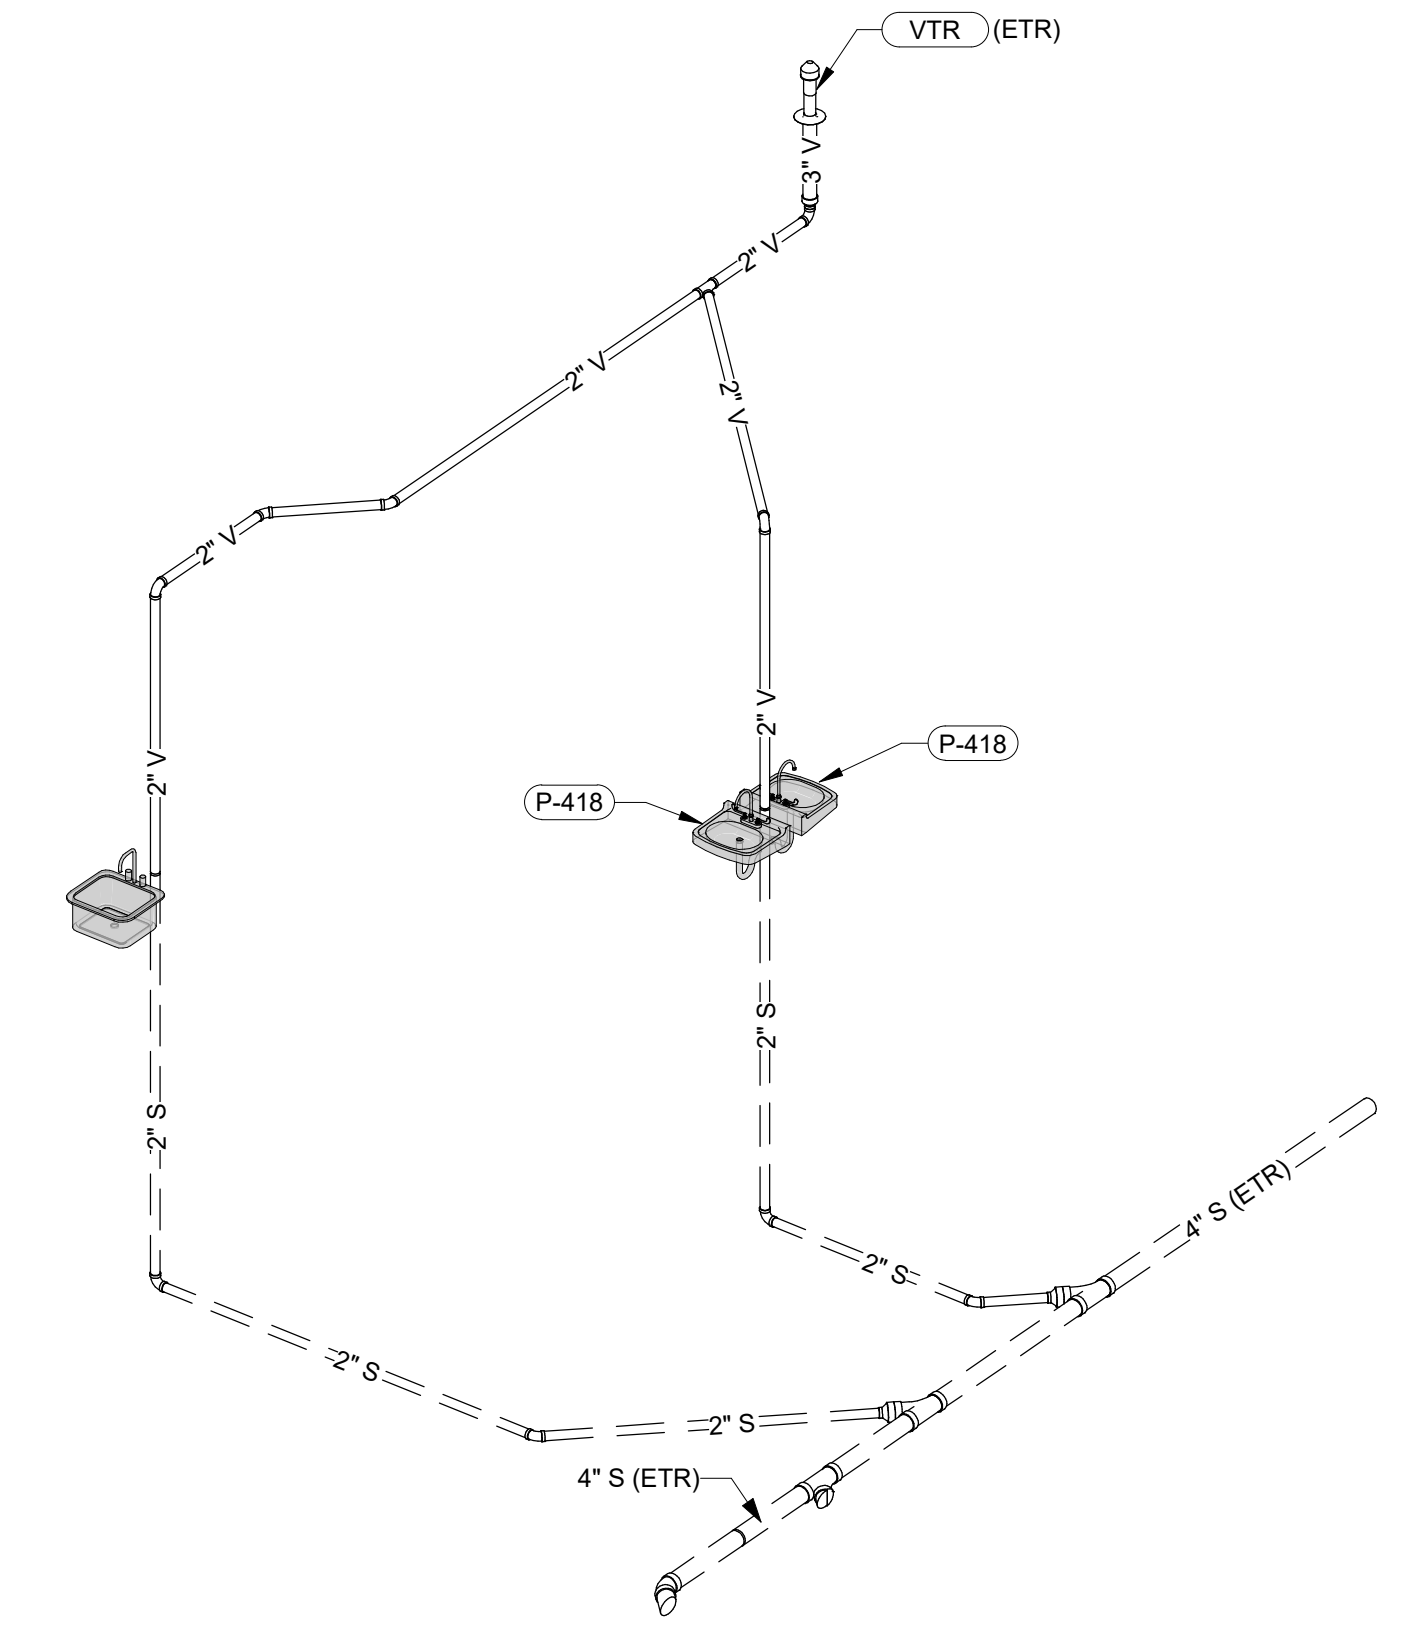


4 REC THERAPY (A115) AND LACTATION/PUMP (A122)




2 TESTING (A134) AND EXAMS (A135 & A136)


CONSULTANT INFORMATION STRUCTURAL / CIVIL ENGINEER STAND STRUCTURAL ENGINEERING 11627 W. 112TH STREET, SUITE 200 OVERLAND PARK, KS 66210 (913) 214-2169 MECHANICAL / ELECTRICAL / PLUMBING / TECHNICAL ENGINEER SPUR DESIGN 11020 KING STREET, SUITE 350 OVERLAND PARK, KS 66210 (405) 842-6100 FIRE PROTECTION ENGINEER POOLE FIRE PROTECTION, INC. 19910 W. 161ST STREET OLATH, KS 66062 (913) 829-8650		ARCHITECT  512 SW 23th Street Overland Park, KS 66159 (913) 241-2169 11020 King Street, Suite 350 Overland Park, KS 66210 (405) 842-6100  DAN E. SOMMER LICENSED PROFESSIONAL ENGINEER 22162 7/10/2019 KANSAS		Office of Construction and Facilities Management VA U.S. Department of Veteran Affairs		SHEET TITLE PLUMBING RISER DIAGRAMS APPROVED: PROJECT DIRECTOR		PROJECT PHASE BID DOCUMENTS FULLY SPRINKLERED		PROJECT TITLE RENOVATE A & B WING BUILDING 6 PROJECT LOCATION 2200 SW GAGE BLVD TOPEKA, KS 66622		VA PROJECT NUMBER 589-A5-19-116 BUILDING NUMBER 6 DRAWING NUMBER 6-P-301 Dwg. 81 OF 160	
Revision #	Date												

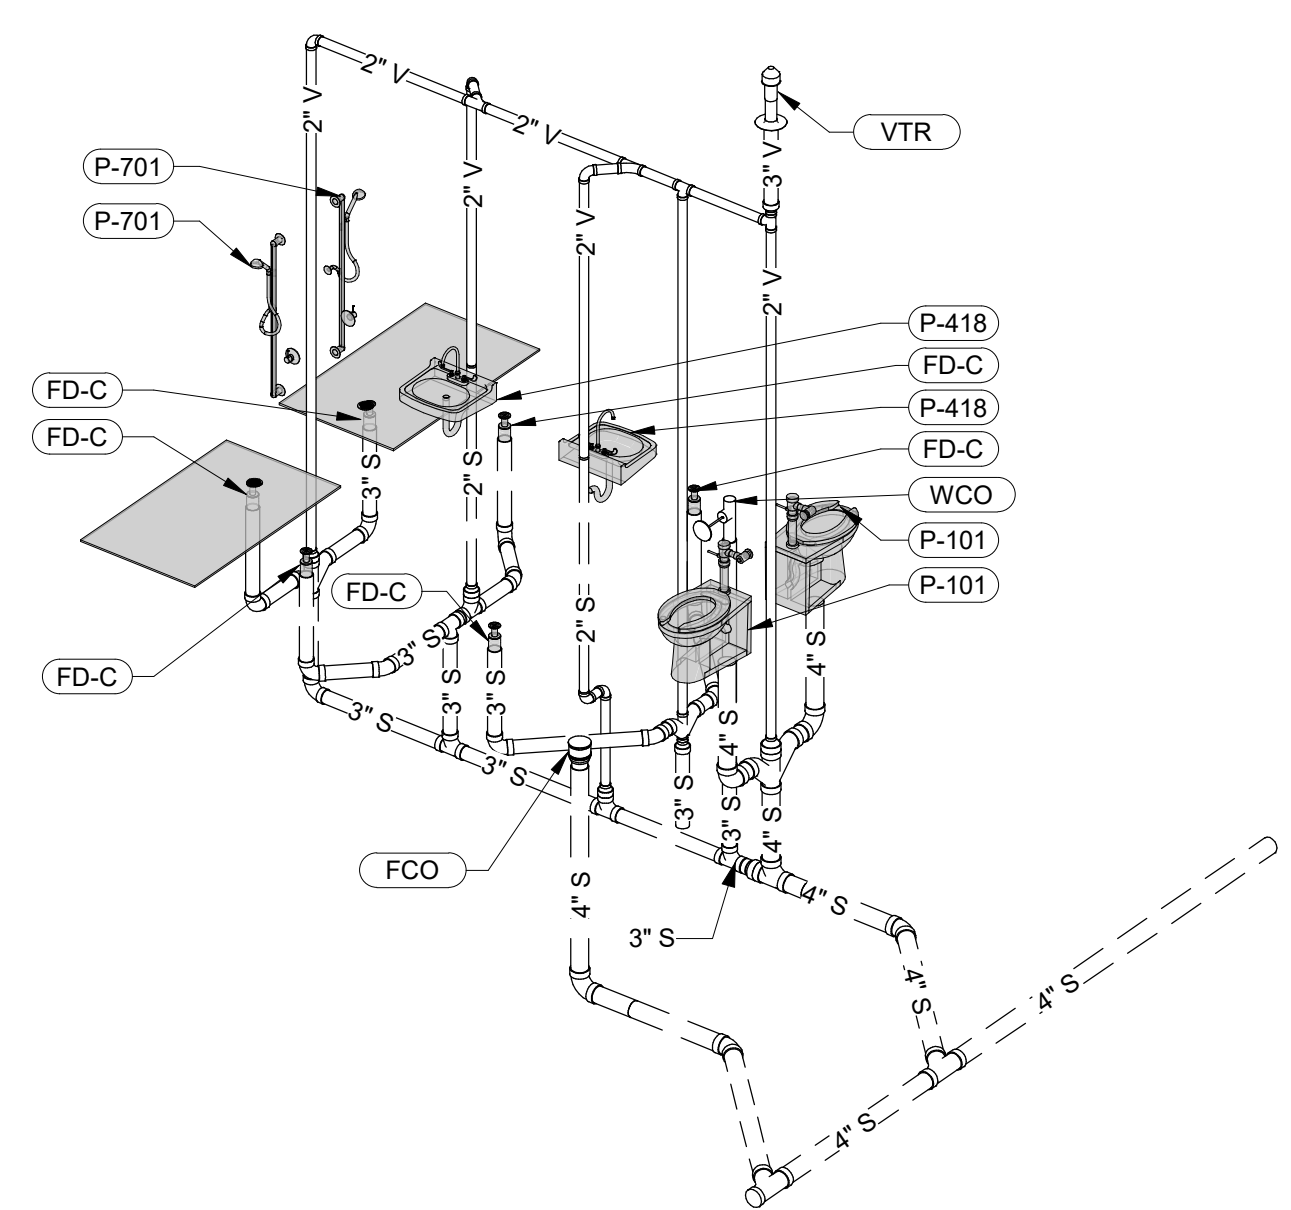


10 TOILETS (B130A & B131A)

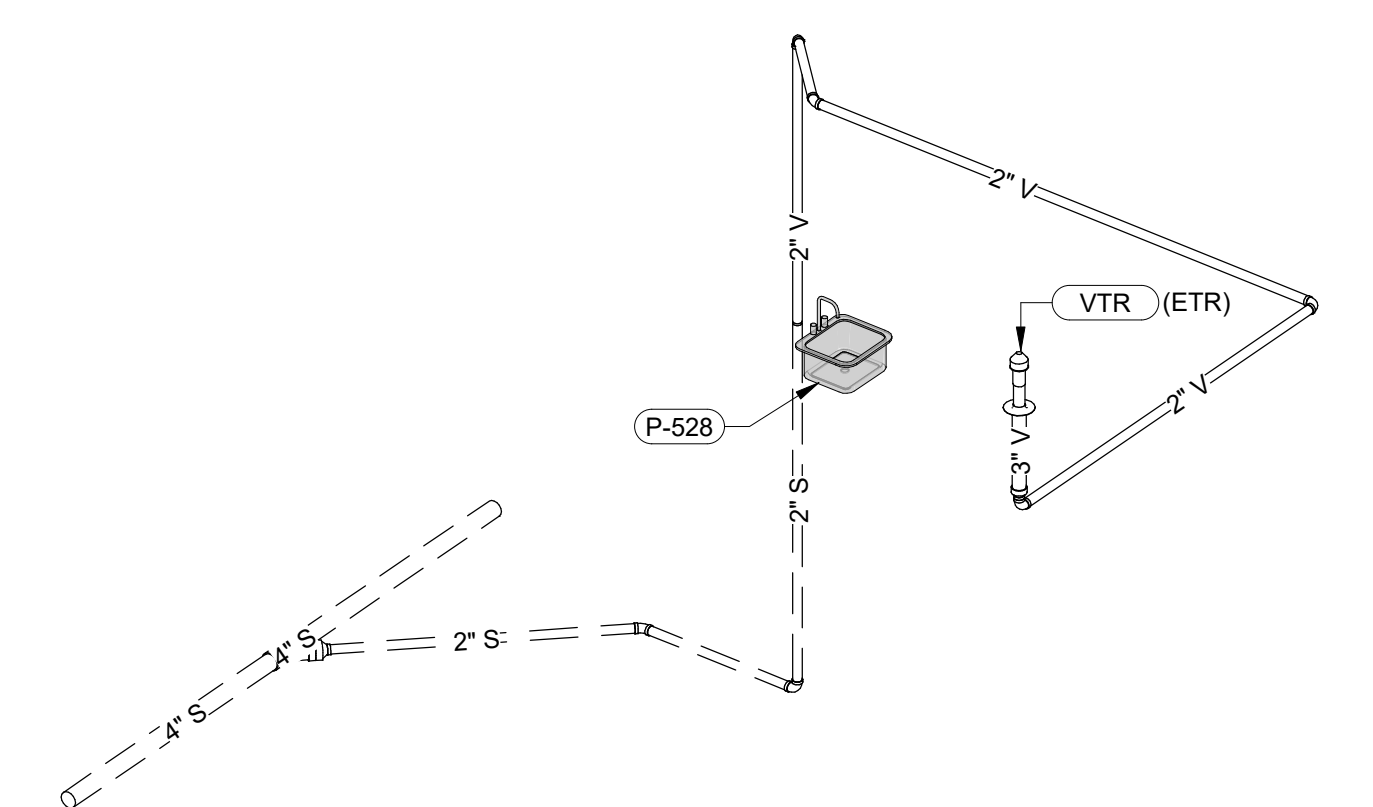


7 MEDS (B100)

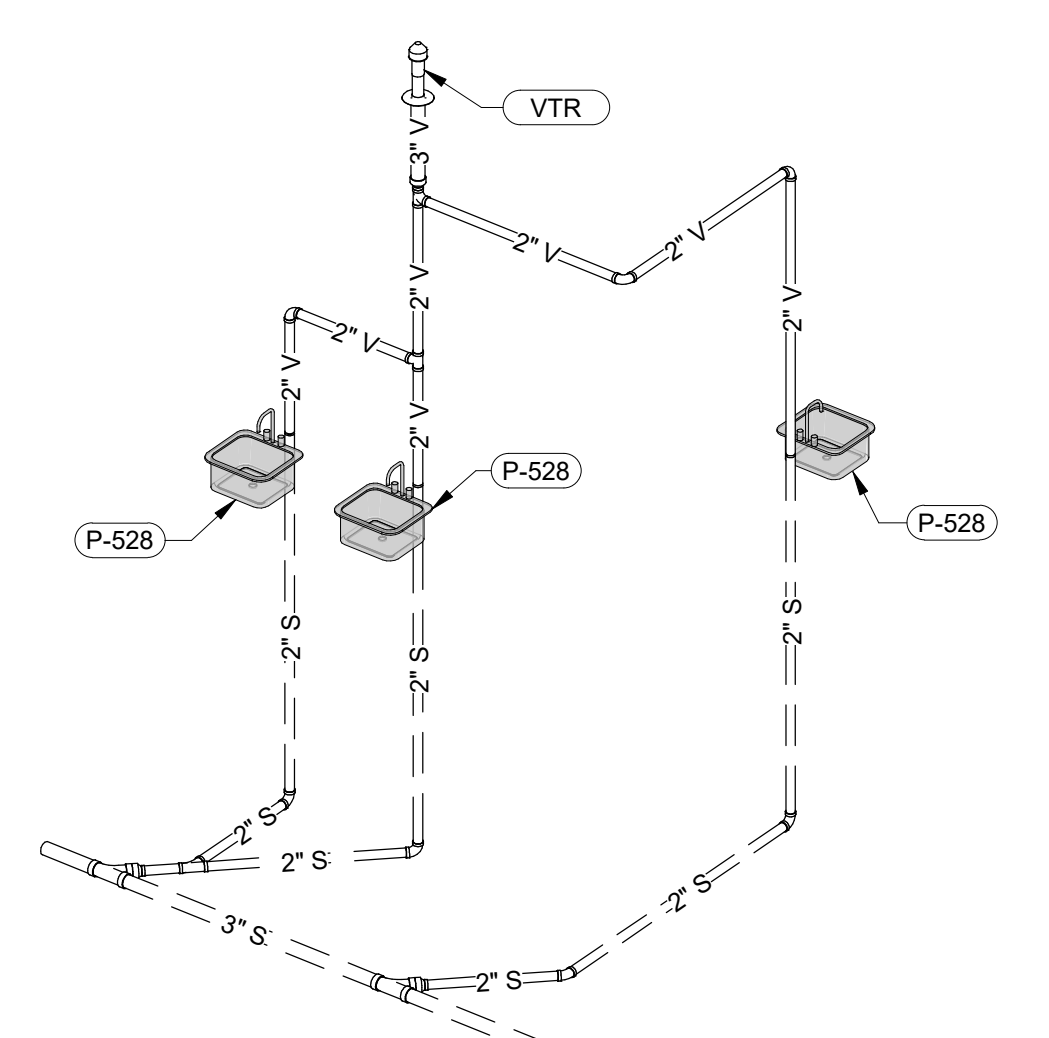


4 CLEAN SUPPLY (B104), SOILED HOLDING (B106), AND CLEAN LINEN (B107)

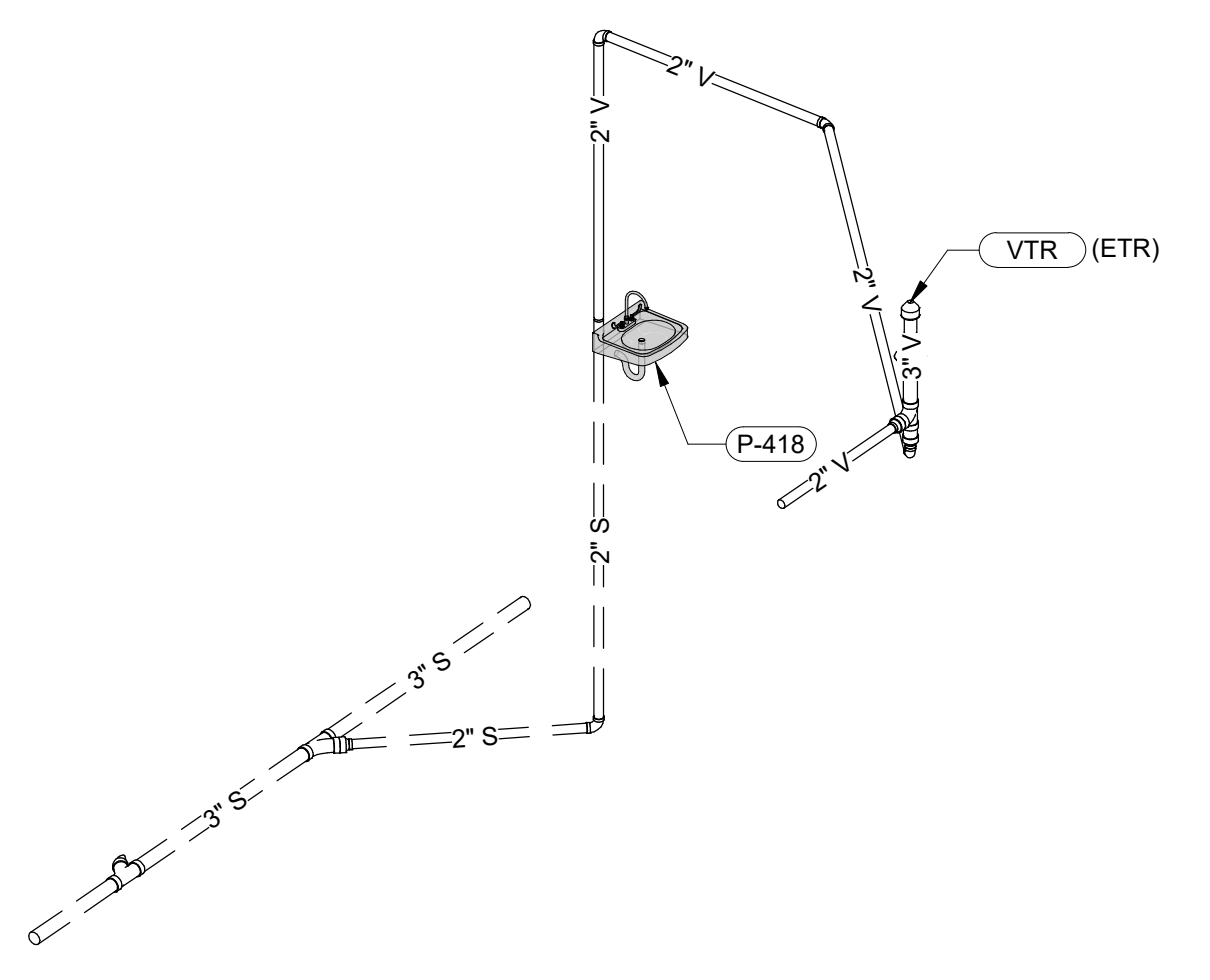


1 PT/OT (A110)

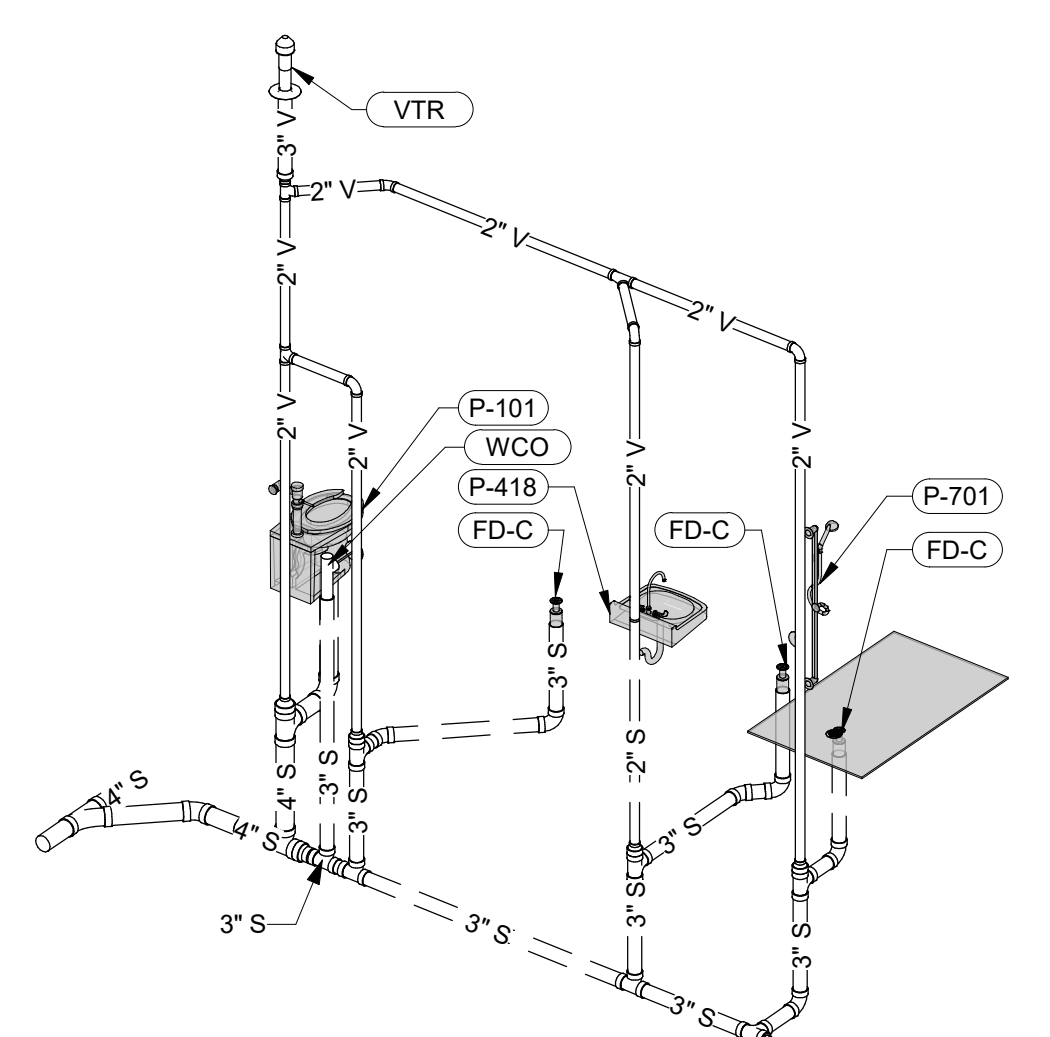


11 TOILET (B135A)

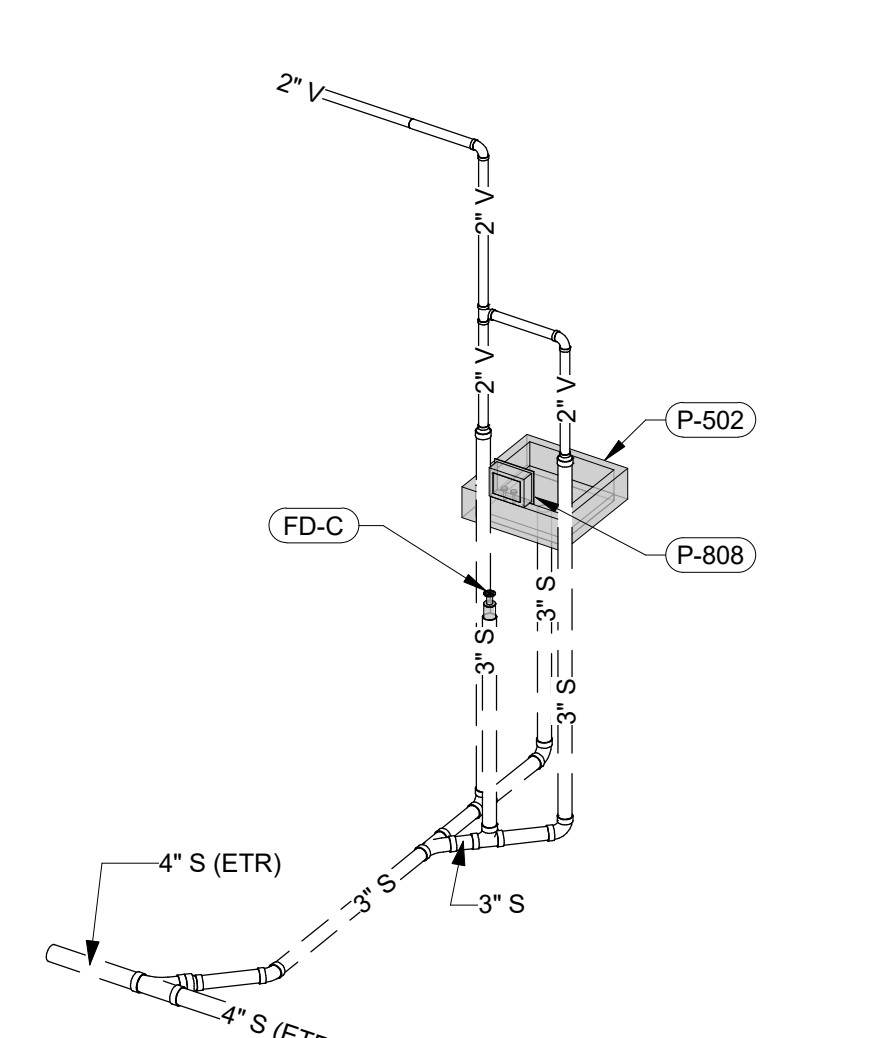


8 LAUNDRY (B127) AND HAC (B128)

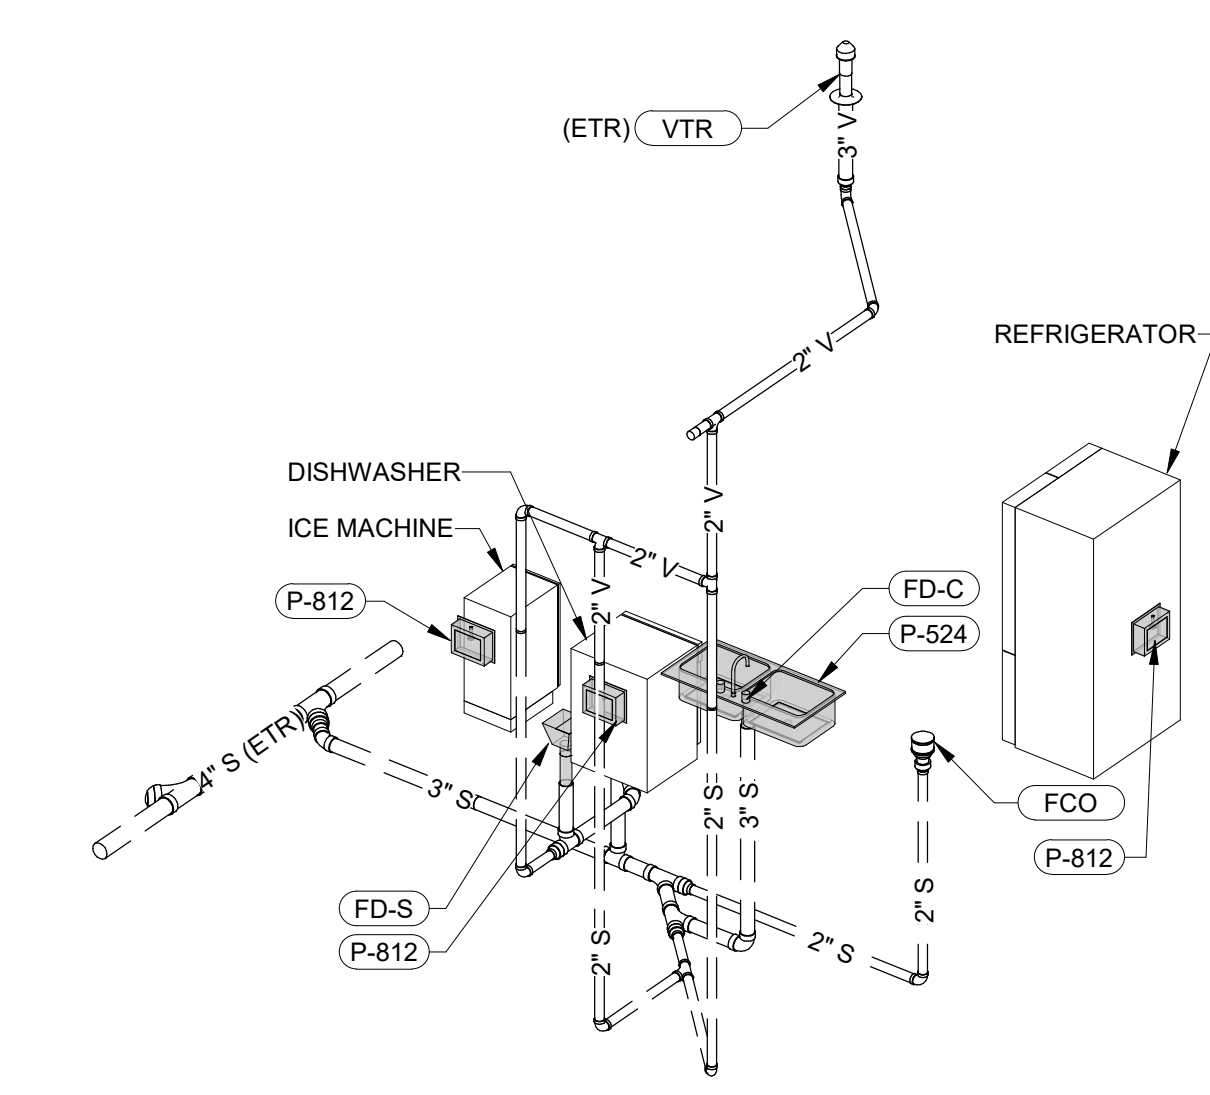


5 KITCHEN (B109)

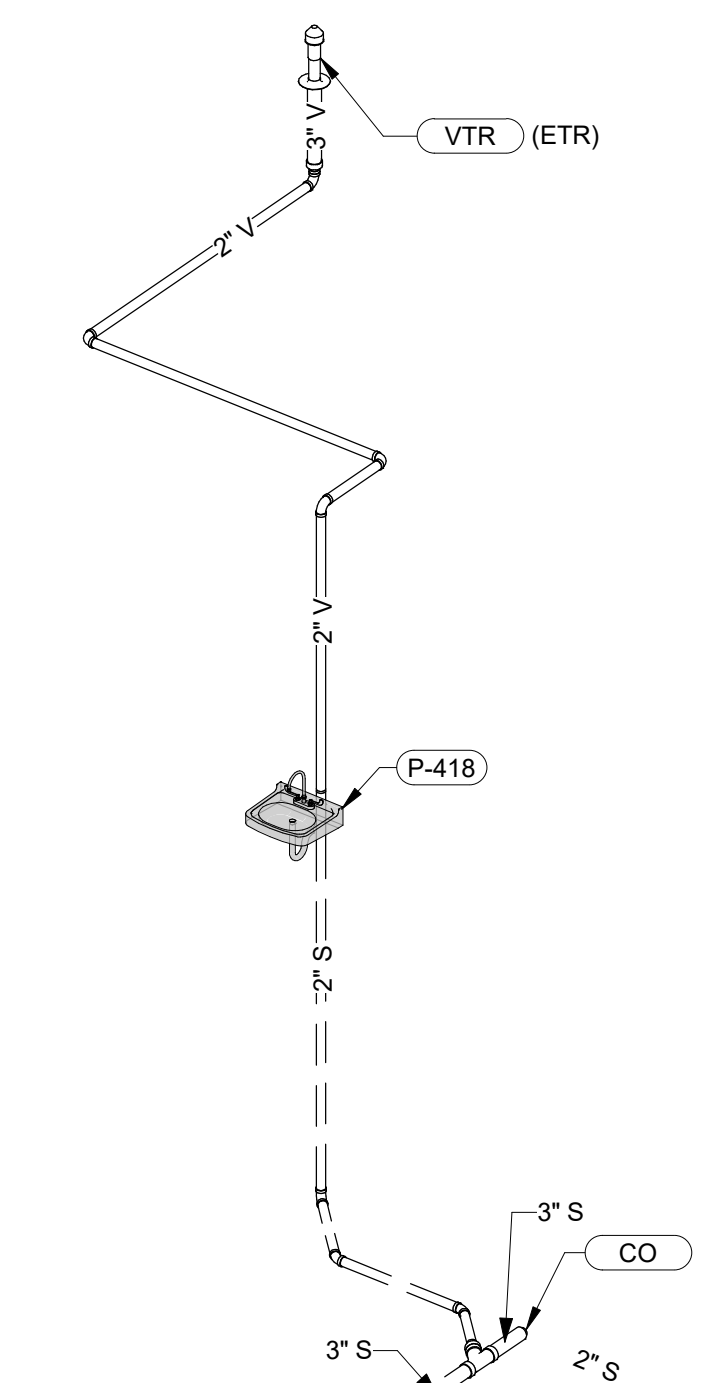


2 GEROPSYCH (A109)

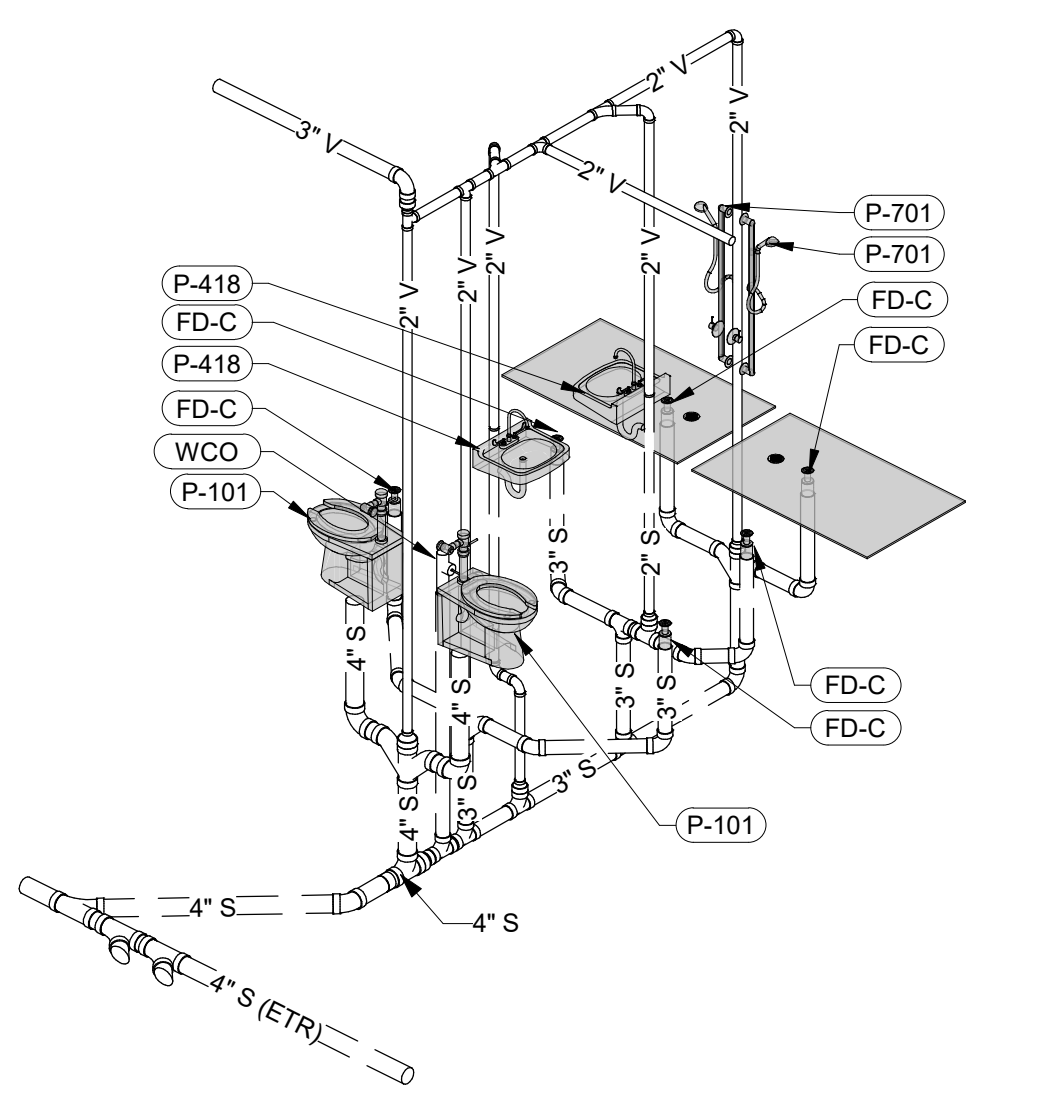

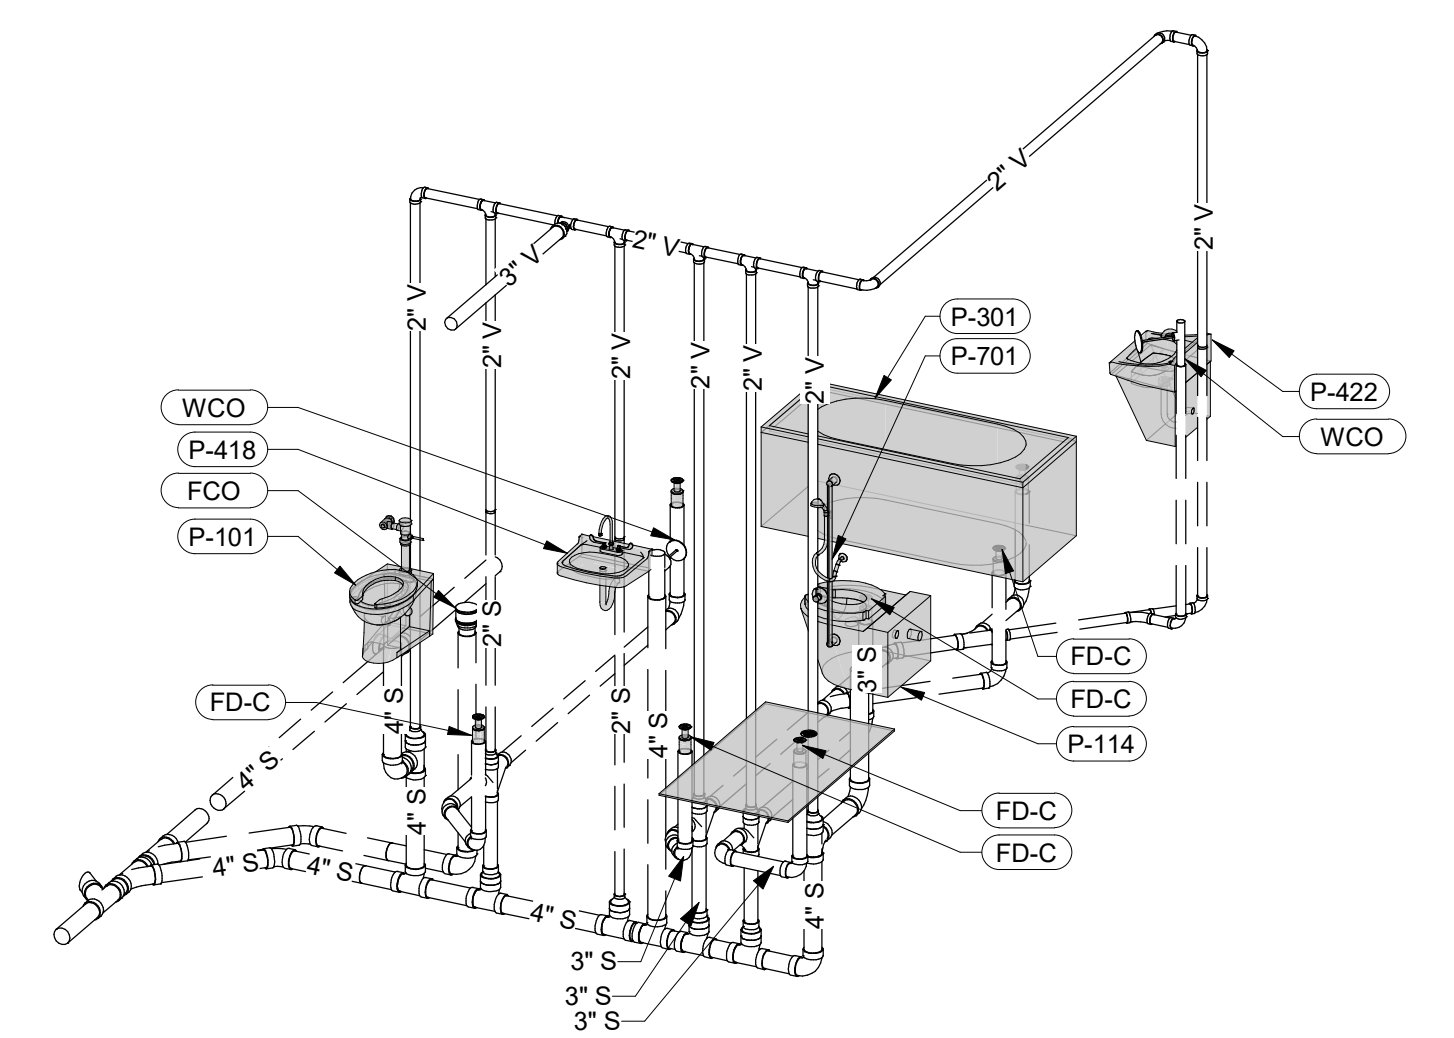

9 TOILET (B125A & B126A)

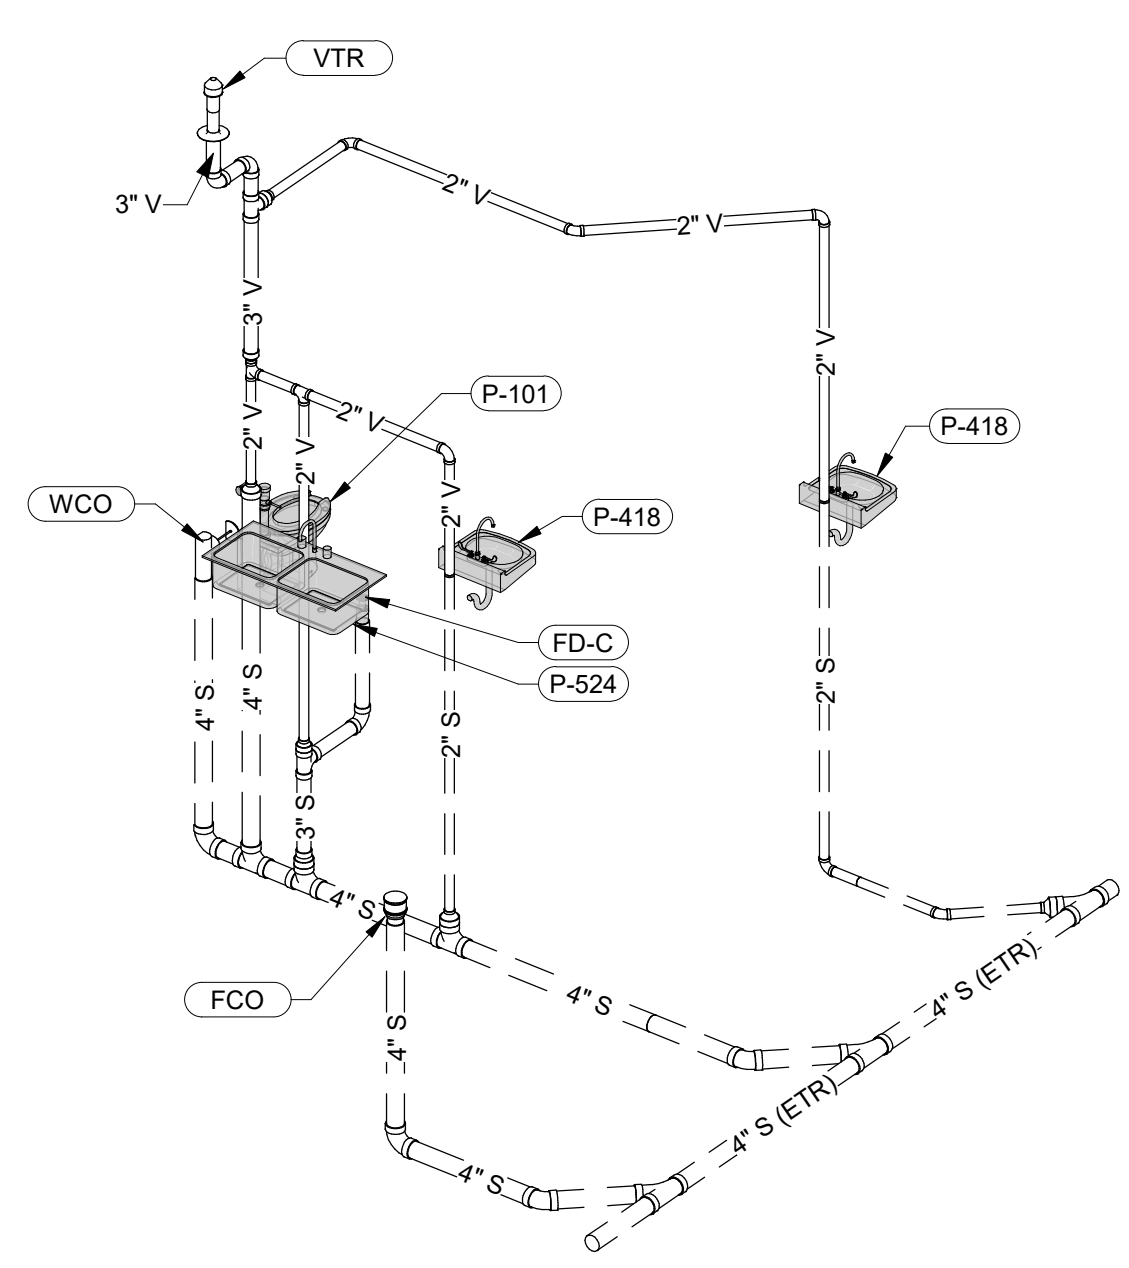


6 BARIATRIC TOILET (B119A) AND TOILET (B120A)




3 STAFF BREAK (B115) AND STAFF TOILET (B116)


CONSULTANT INFORMATION STRUCTURAL / CIVIL ENGINEER MECHANICAL / ELECTRICAL / PLUMBING / TECHNICAL ENGINEER FIRE PROTECTION ENGINEER STAND STRUCTURAL ENGINEERING 11627 W. 112TH STREET, SUITE 200 OVERLAND PARK, KS 66210 (913) 214-2169 SPUR DESIGN 11020 KING STREET, SUITE 350 OVERLAND PARK, KS 66210 (405) 842-6100 POOLE FIRE PROTECTION, INC. 19910 W. 161ST STREET OLATH, KS 66062 (913) 829-8650		ARCHITECT  512 5th Street Overland Park, KS 66150 (913) 214-2169 KS ARCH REG. NO. A-1139, EXP. 12/31/2019 KS ENGR REG. NO. E-2586, EXP. 12/31/2019  DAN E. SOMMER LICENSED PROFESSIONAL ENGINEER 22162 7/10/2019 KANSAS		Office of Construction and Facilities Management VA U.S. Department of Veteran Affairs SHEET TITLE PLUMBING RISER DIAGRAMS APPROVED: PROJECT DIRECTOR		PROJECT PHASE BID DOCUMENTS FULLY SPRINKLERED		PROJECT TITLE RENOVATE A & B WING BUILDING 6 PROJECT LOCATION 2200 SW GAGE BLVD TOPEKA, KS 66622 DATE 07/10/2019 CHECKED BY JES DRAWN BY RLC		VA PROJECT NUMBER 589-A5-19-116 BUILDING NUMBER 6 DRAWING NUMBER 6-P-302 Dwg. 82 OF 160	
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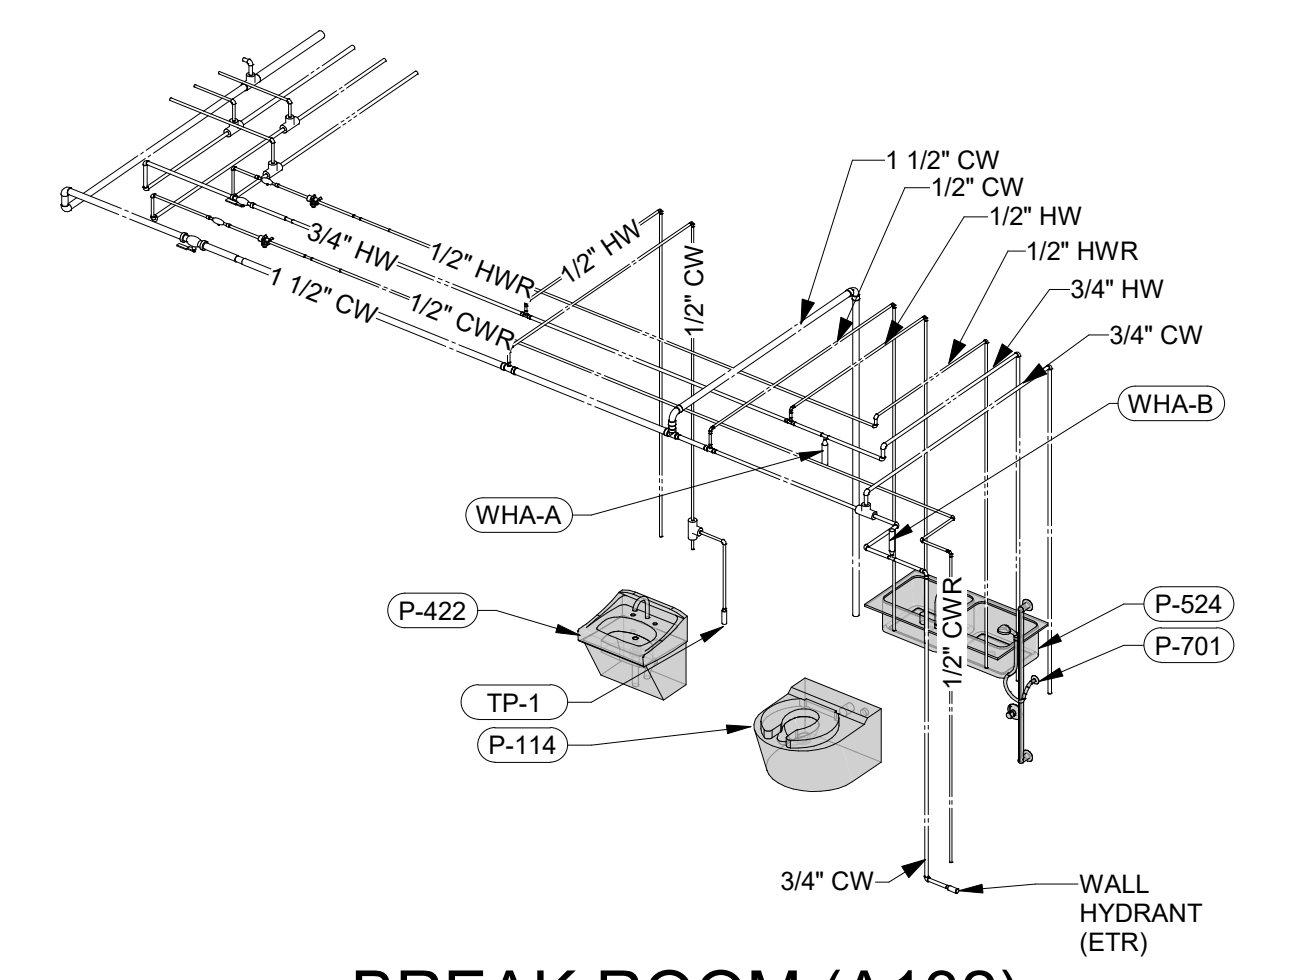
13 GEROPSYCH (A109)

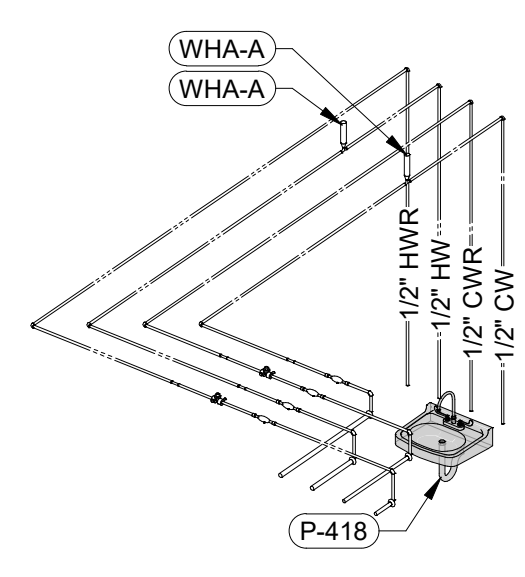


9 FAMILY TOILET (A102) AND RECEPTION (A101)

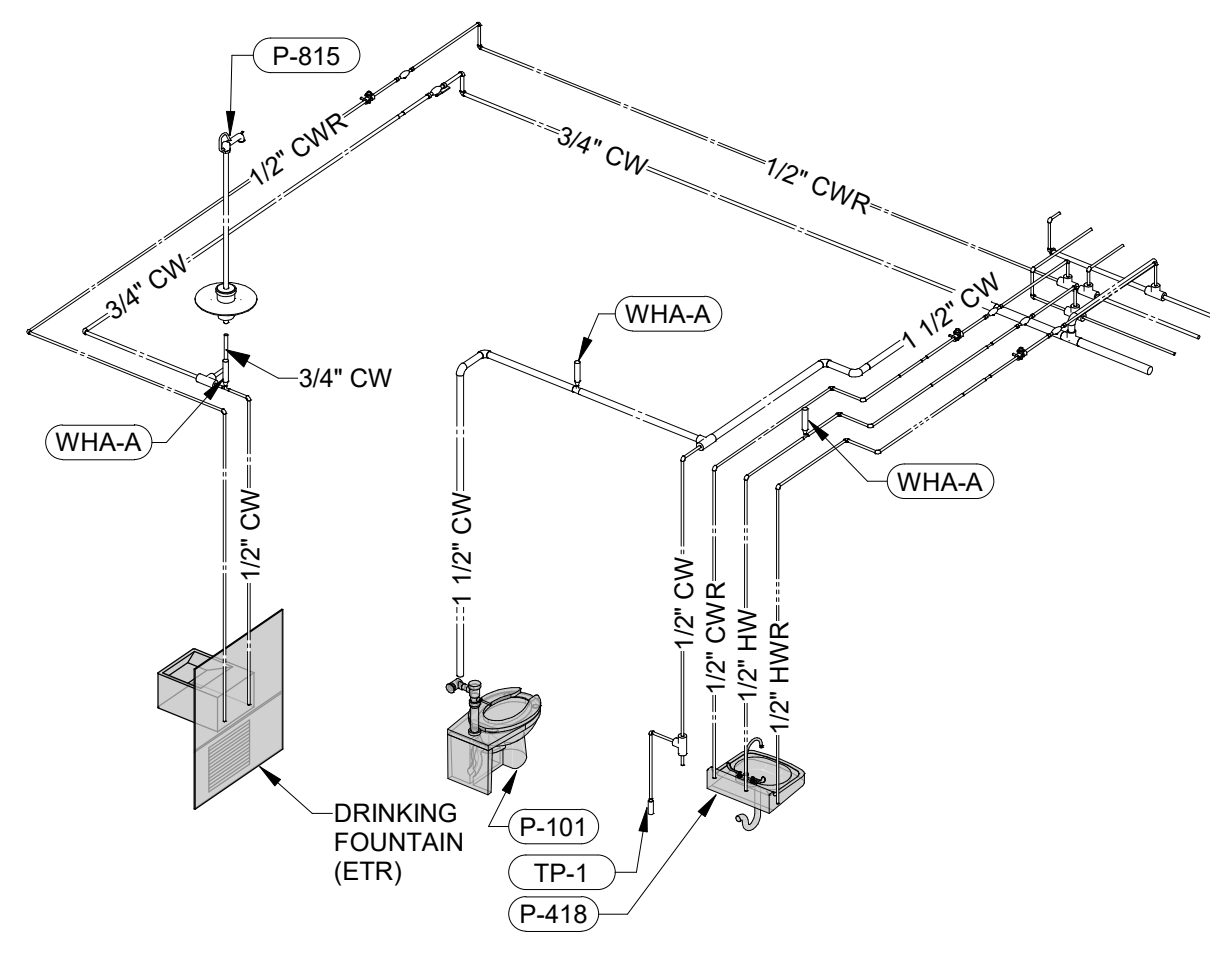


5 LACTATION/PUMP (A122)

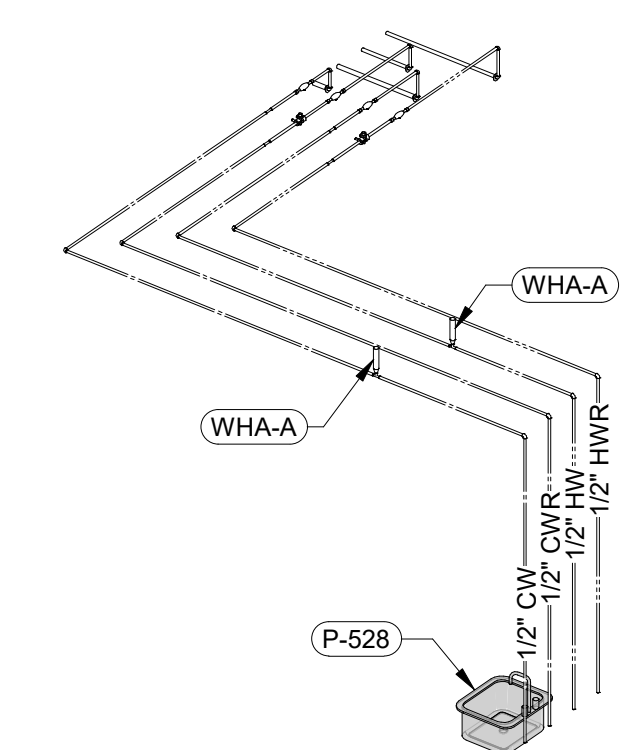


1 BREAK ROOM (A132) AND BARIATRIC TOILET (A133)

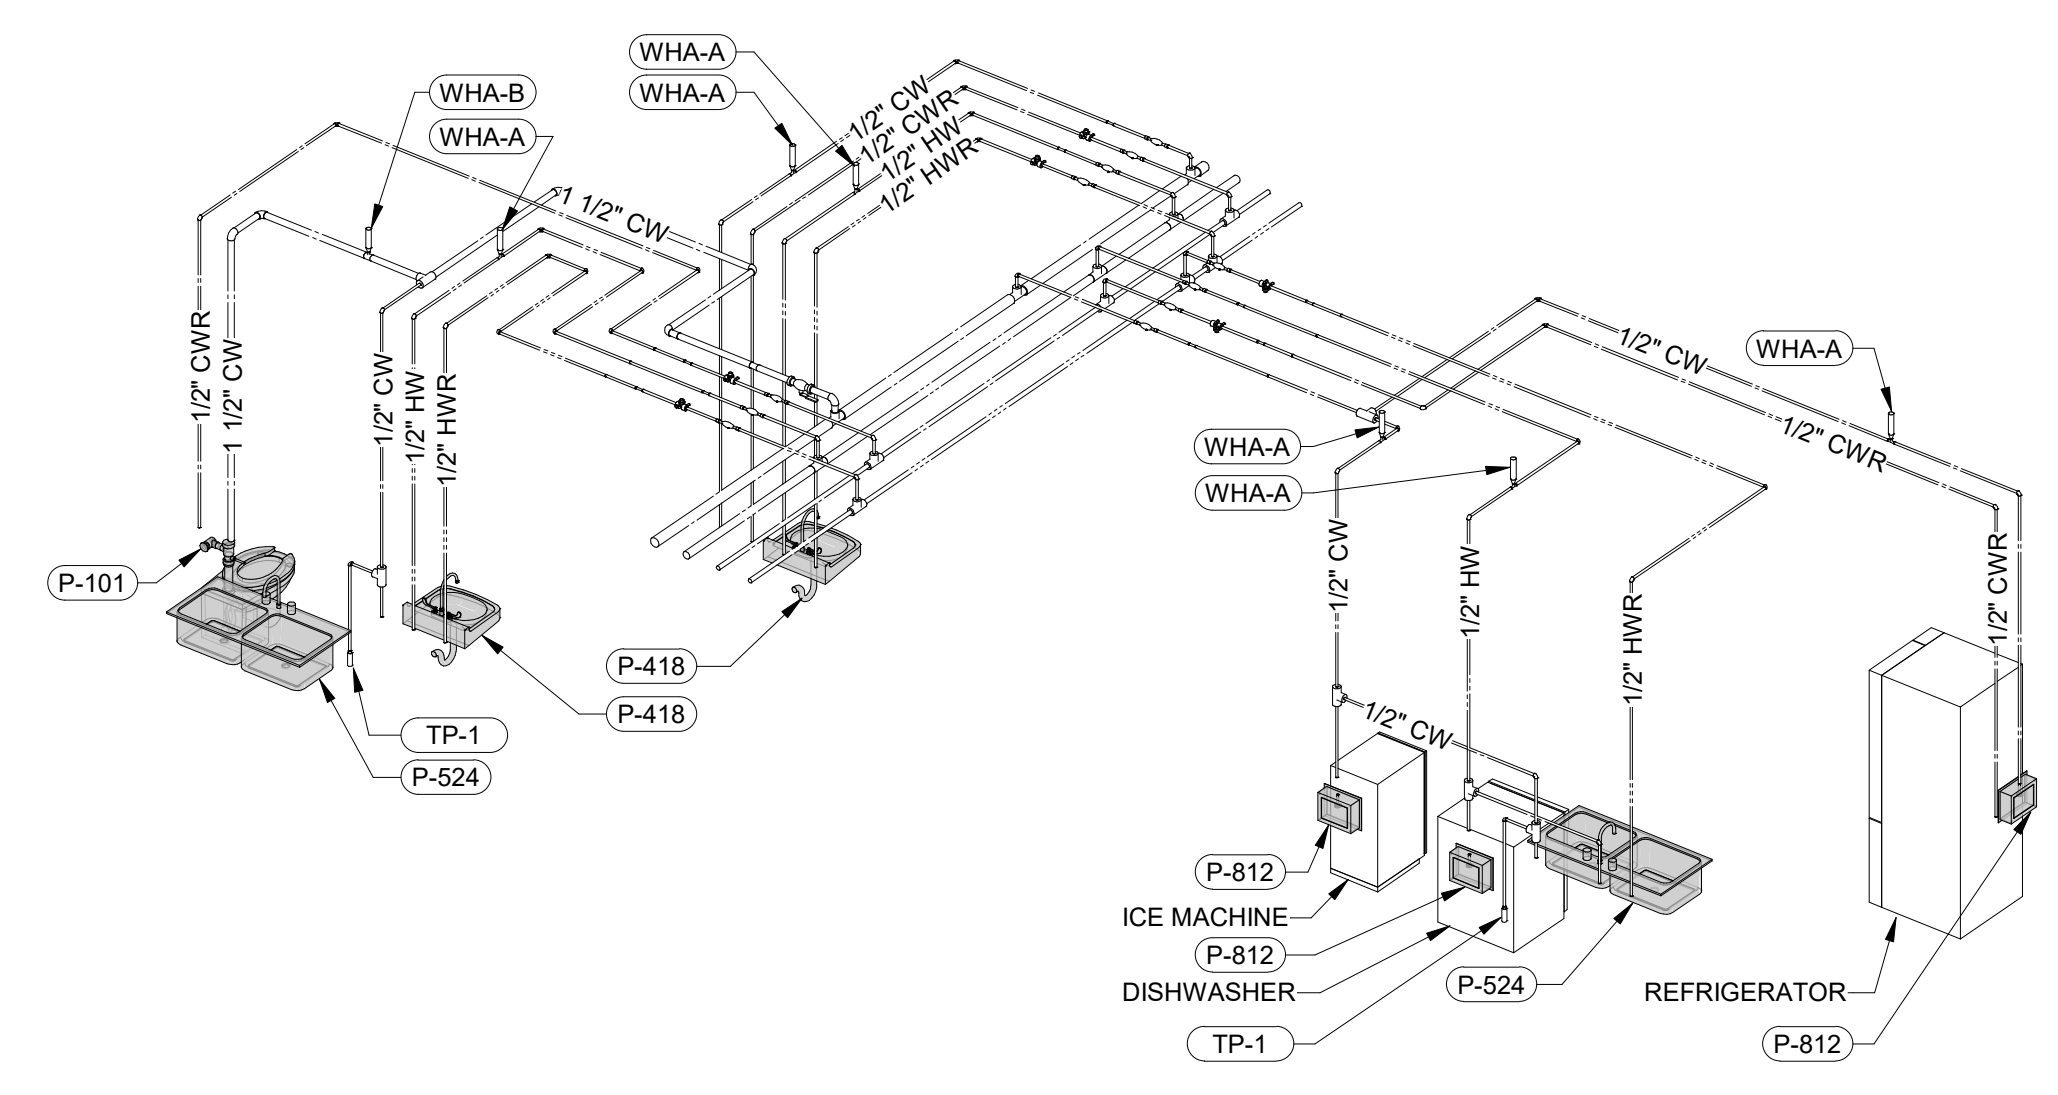


14 KITCHEN (B109), STAFF BREAK (B115), STAFF TOILET (B116), AND EXAM ROOM (B117)

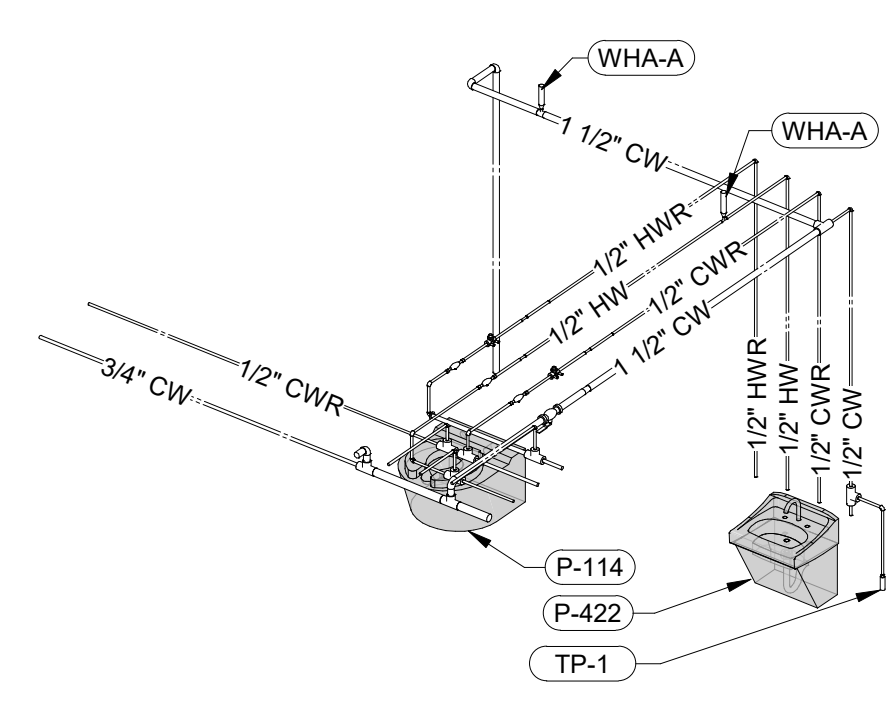


10 BARIATRIC TOILET (A103)

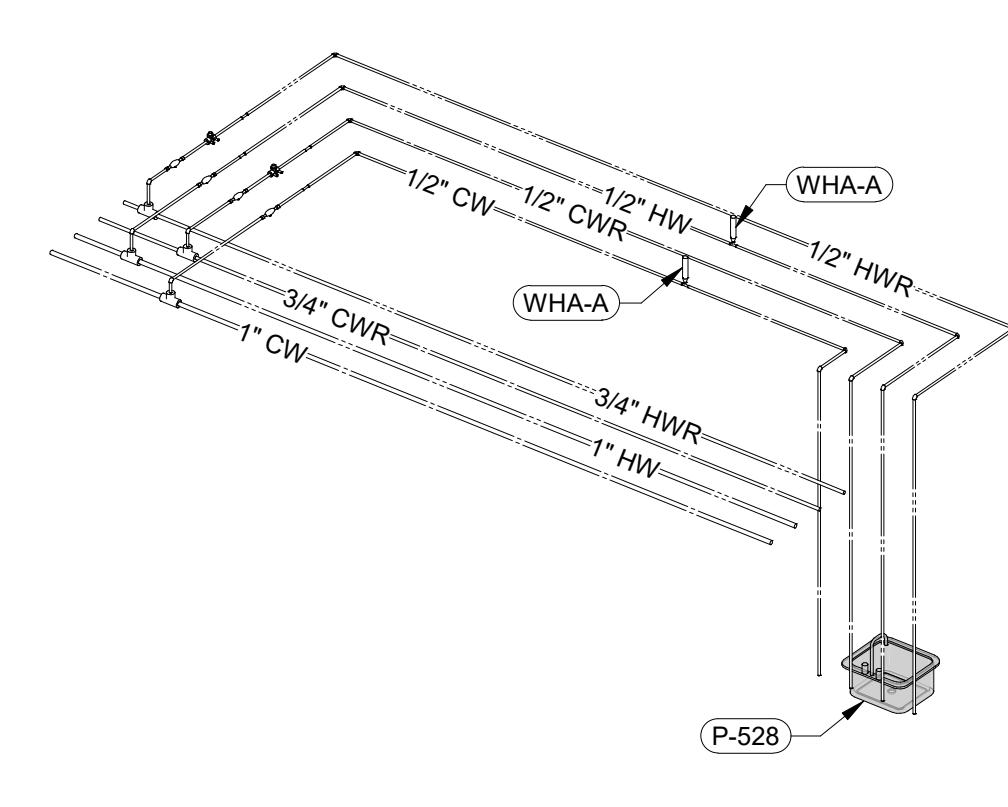


6 REC THERAPY (A115)

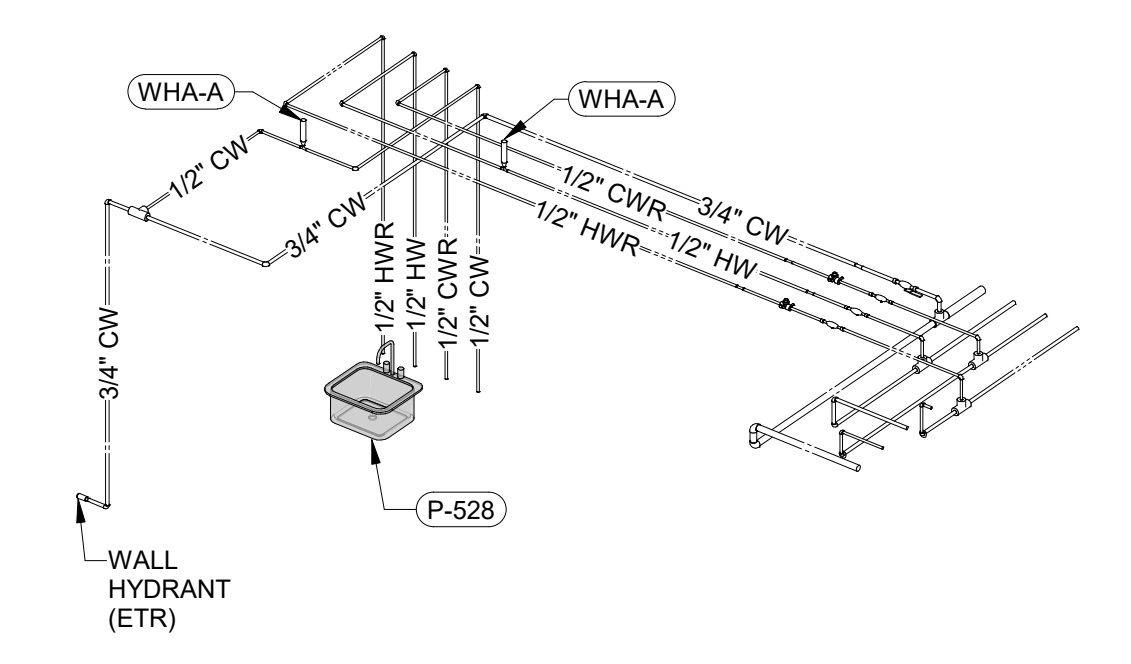


2 TESTING (A134)

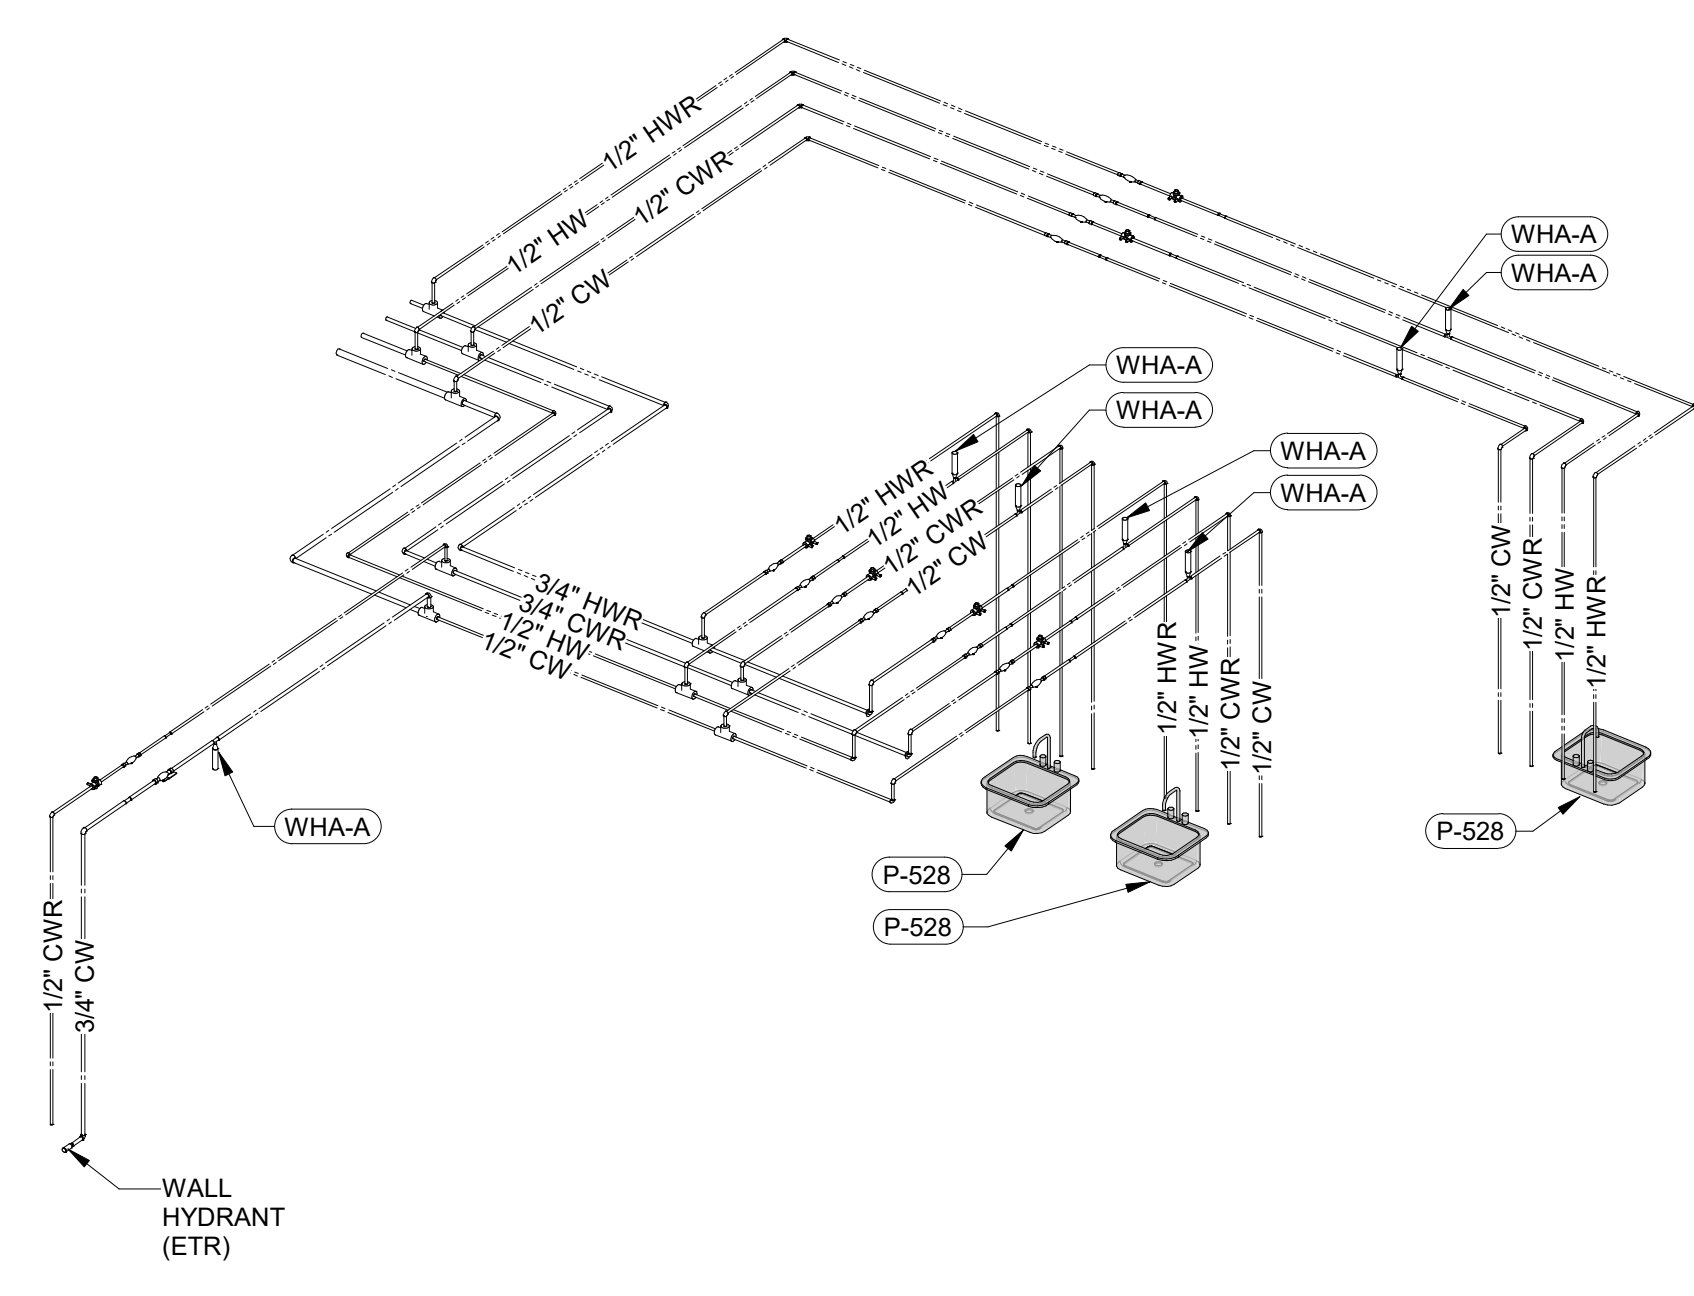


15 CLEAN SUPPLY (B104), SOILED HOLDING (B106), CLEAN LINEN (B107), AND DINING & DAY ROOM (B108)

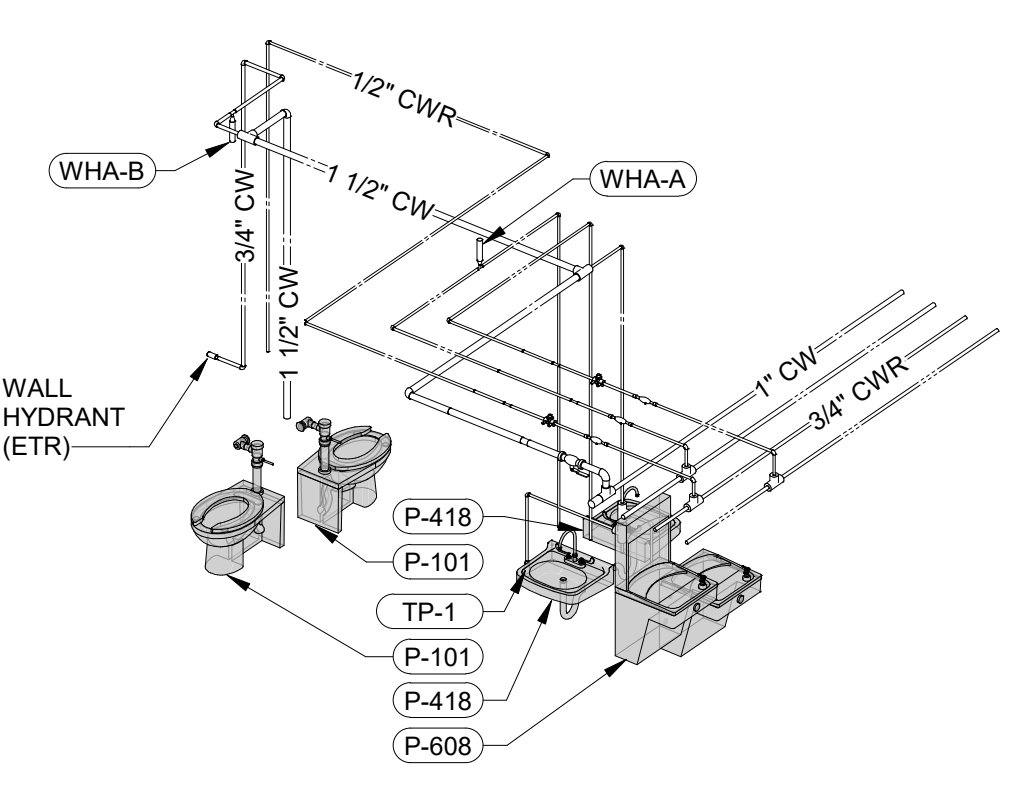


11 STAFF TOILETS (A105 & A106)

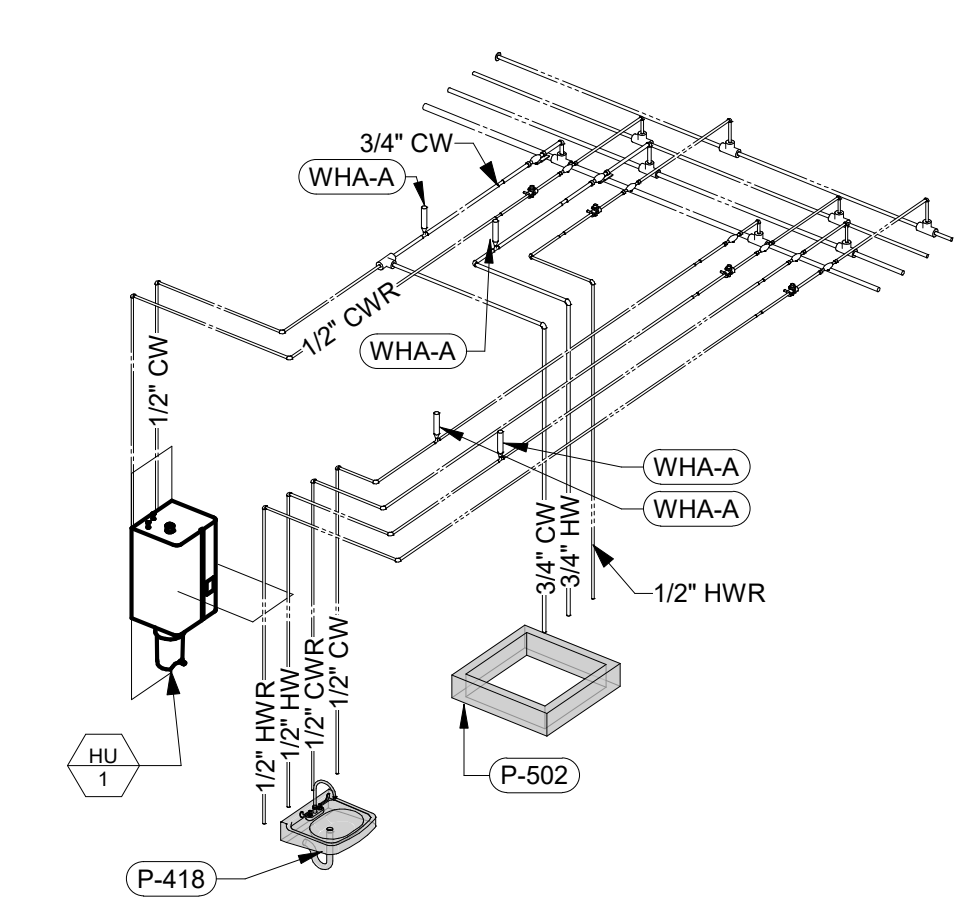


7 EXAM (A126) AND HAC (A127)

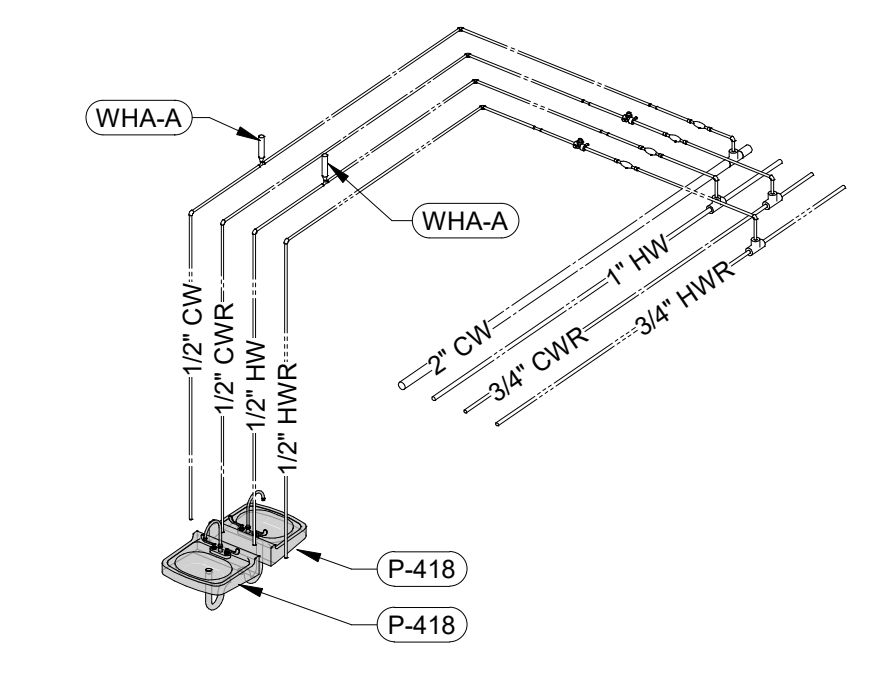


3 EXAMS (A135 & A136)

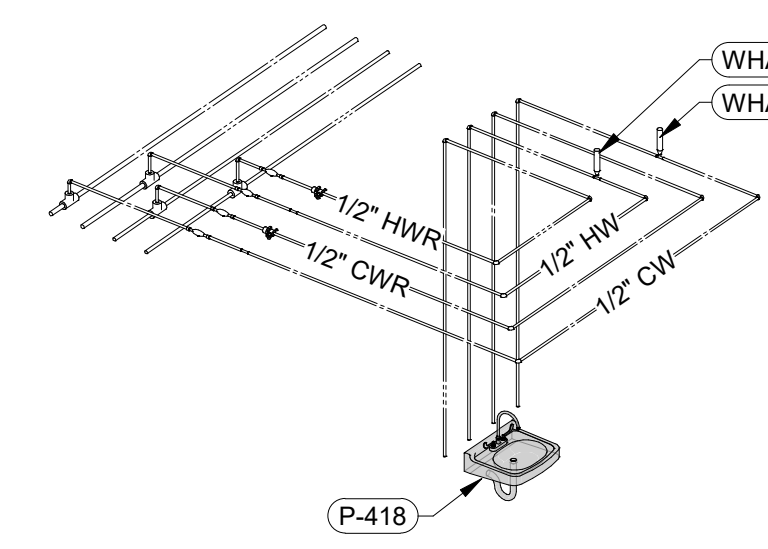

12 PT/OT (A110) - PLAN EAST WALL

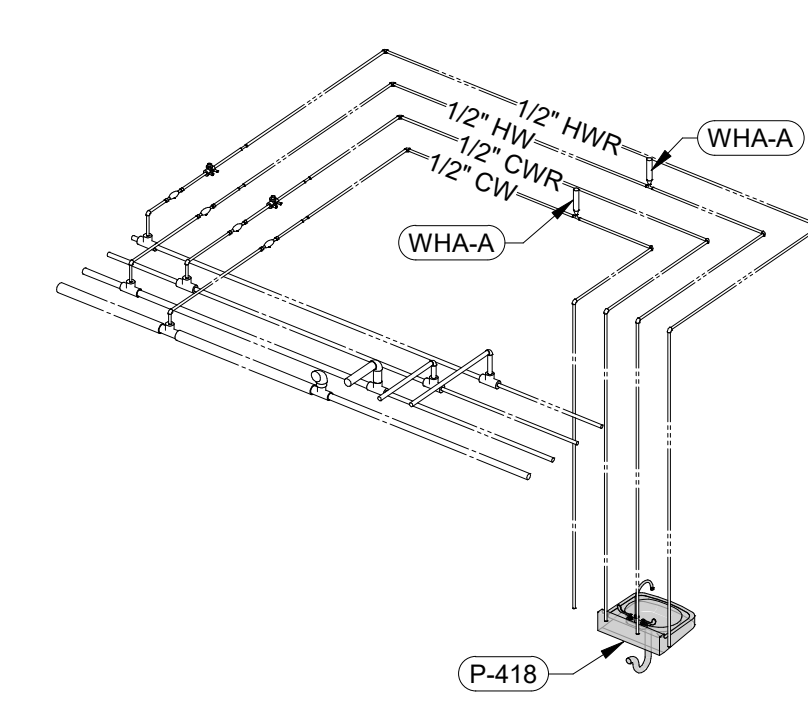

8 PT/OT (A110) - PLAN NORTH WALL

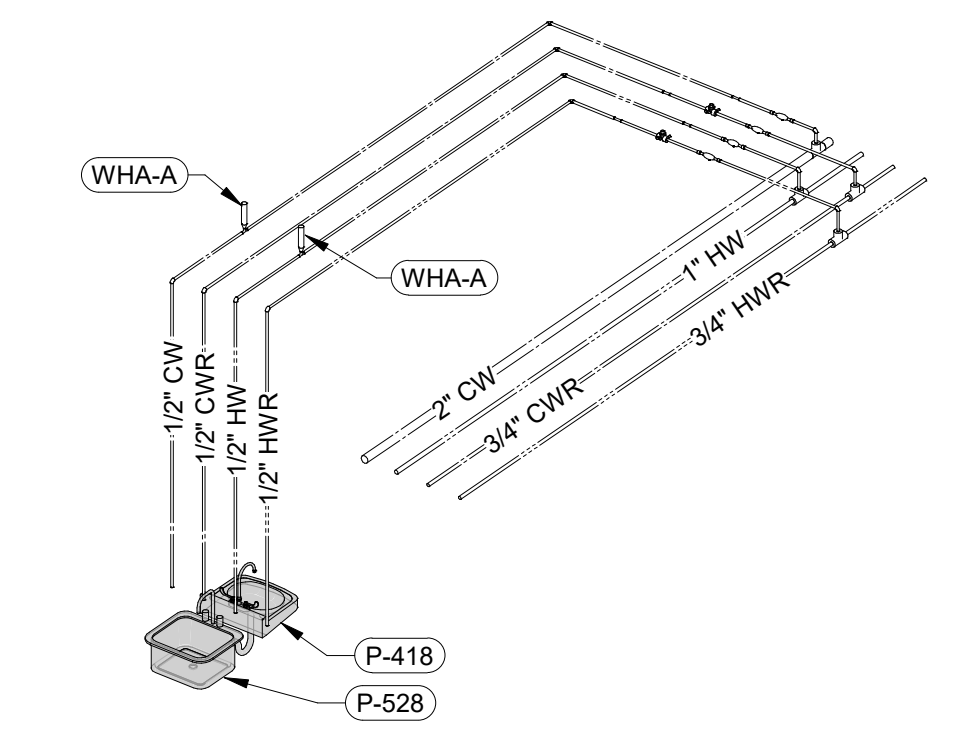

4 NURSE MED (A137) AND BARIATRIC EXAM (A138)

CONSULTANT INFORMATION		
STRUCTURAL / CIVIL ENGINEER	MECHANICAL / ELECTRICAL / PLUMBING / TECHNICAL ENGINEER	FIRE PROTECTION ENGINEER
STAND STRUCTURAL ENGINEERING 11827 W. 112TH STREET, SUITE 200 OVERLAND PARK, KS 66210 (913) 214-2169	SPUR DESIGN 11020 KING STREET, SUITE 350 OVERLAND PARK, KS 66210 (405) 842-6100	POOLE FIRE PROTECTION, INC. 19910 W. 161ST STREET OLATH, KS 66062 (913) 829-8650

ARCHITECT

312 5th Street
Overland Park, KS 66150
www.spur-design.com

11020 King Street, Suite 300
Overland Park, KS 66150
www.spur-design.com

KS ARCH REG. NO. A-1139, EXP. 12/31/2019
KS ENGR REG. NO. E-2586, EXP. 12/31/2019

Office of Construction and Facilities Management

VA U.S. Department of Veteran Affairs


SHEET TITLE PLUMBING RISER DIAGRAMS
APPROVED: PROJECT DIRECTOR

PROJECT PHASE BID DOCUMENTS
FULLY SPRINKLERED


PROJECT TITLE RENOVATE A & B WING BUILDING 6	VA PROJECT NUMBER 589-A5-19-116
PROJECT LOCATION 2200 SW GAGE BLVD TOPEKA, KS 66622	BUILDING NUMBER 6
DATE 07/10/2019	DRAWING NUMBER 6-P-303
CHECKED BY JES	DRAWN BY RLC

Dwg. 83 OF 160


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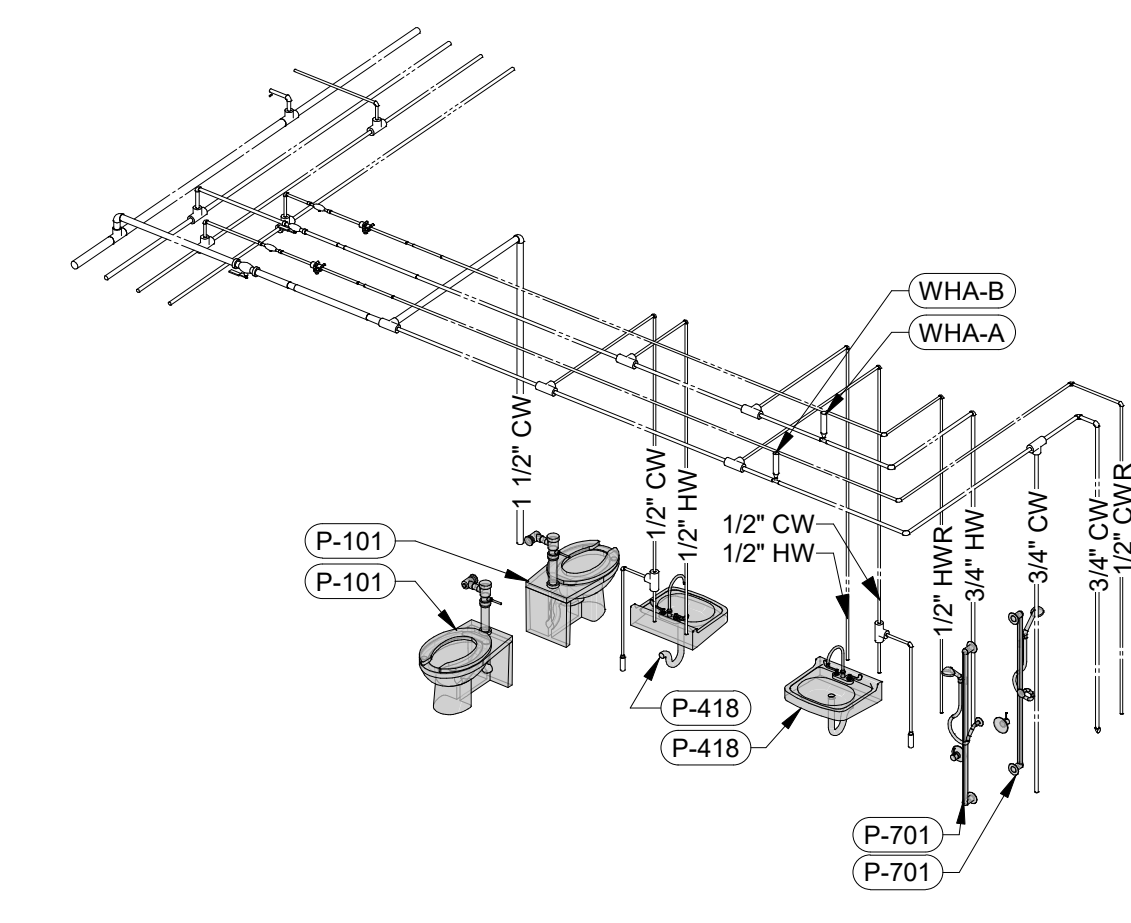
8 TOILET (B135A)

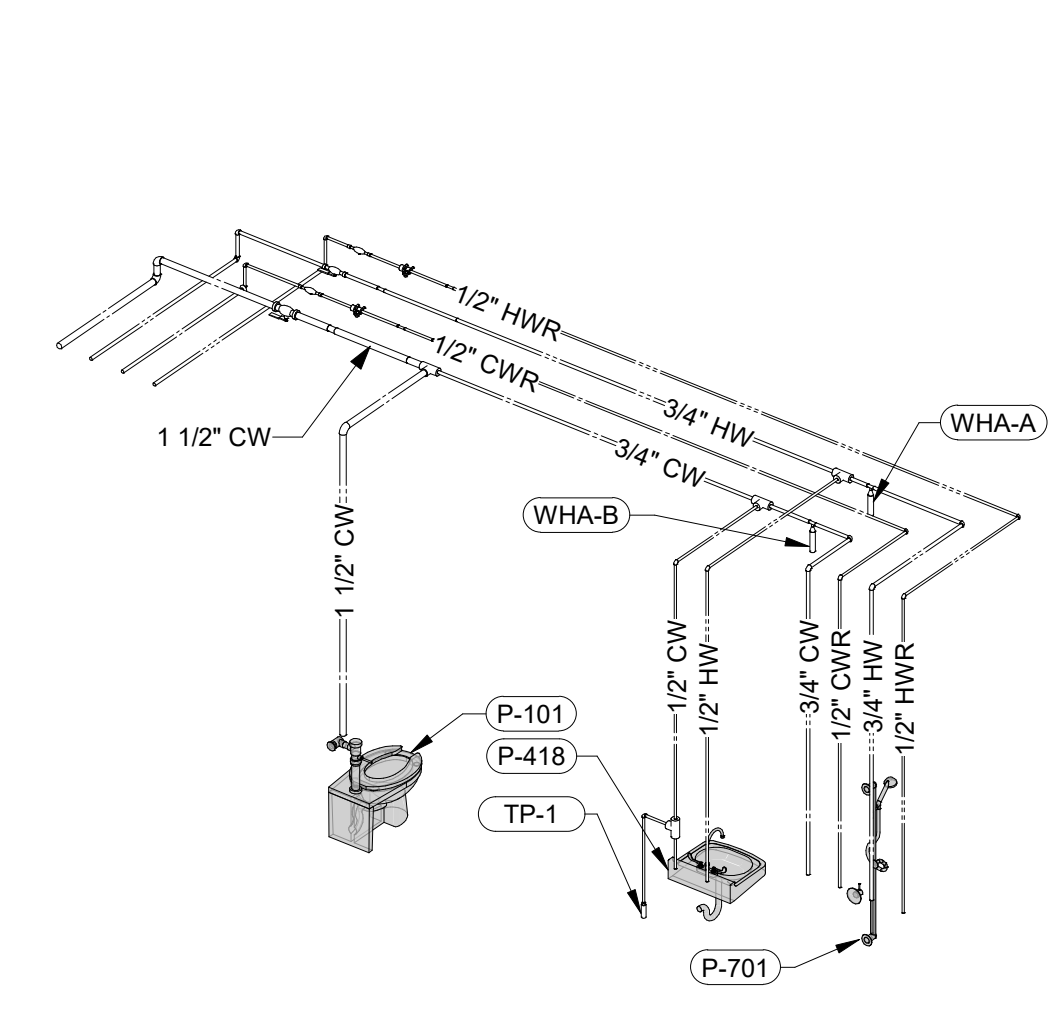


5 TOILETS (B130A & B131A)

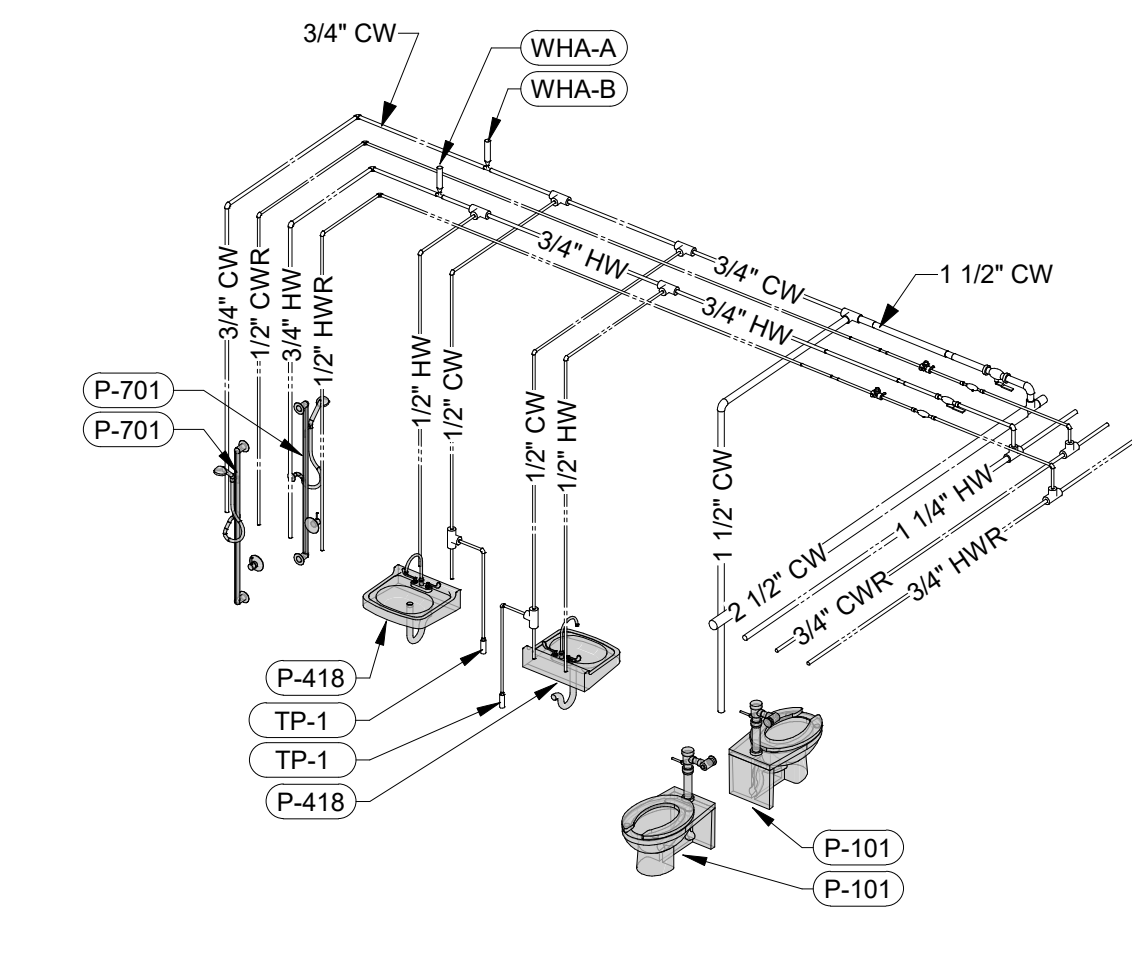


1 MEDS (B100)

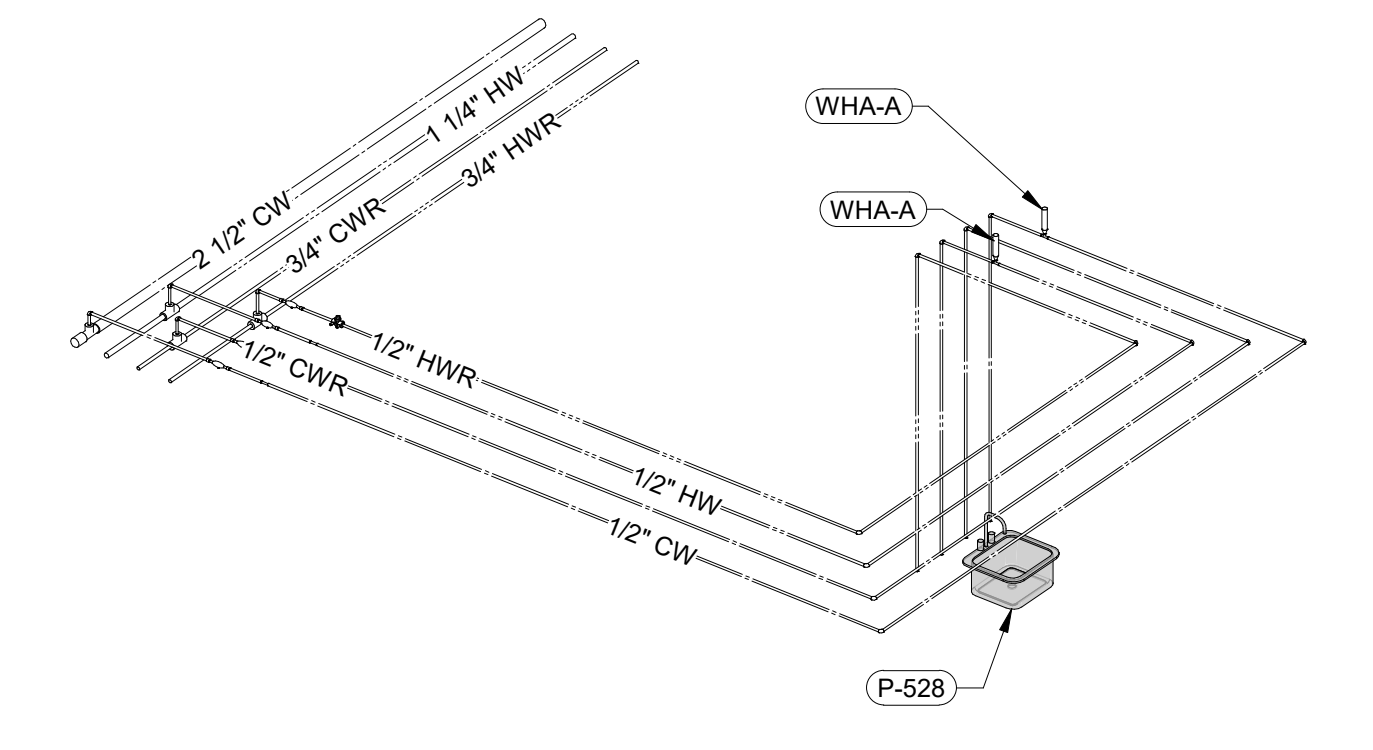


6 TOILET (B136A & B137A)

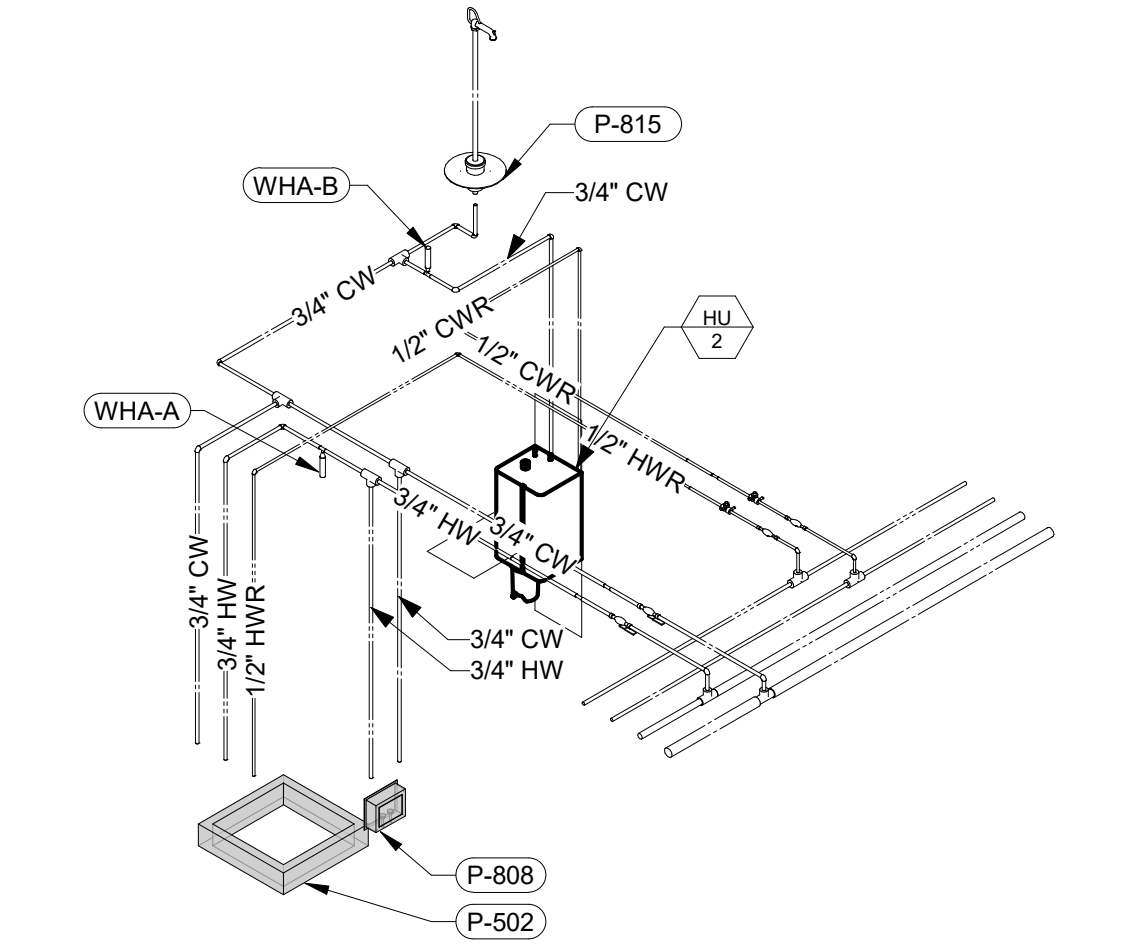


2 LAUNDRY (B127) AND HAC (B128)

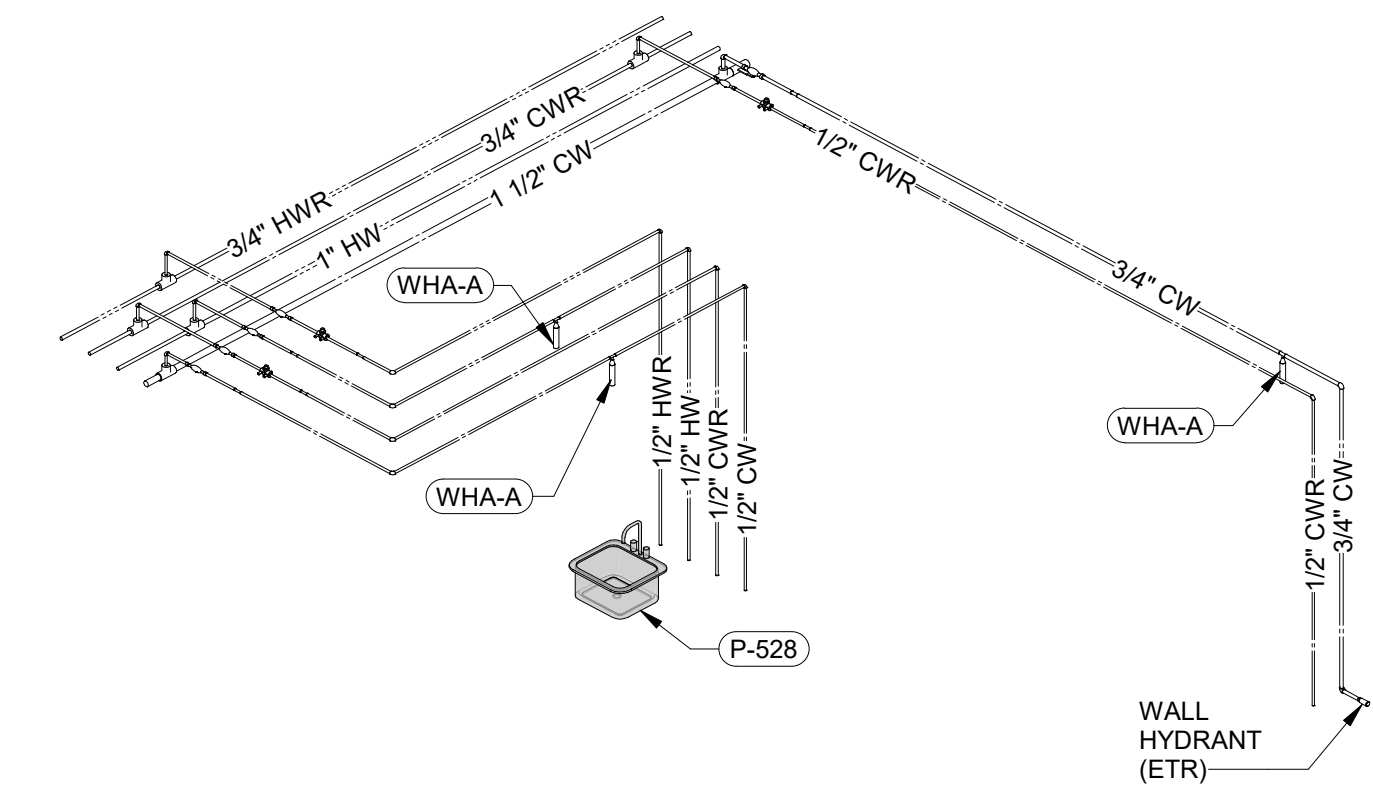

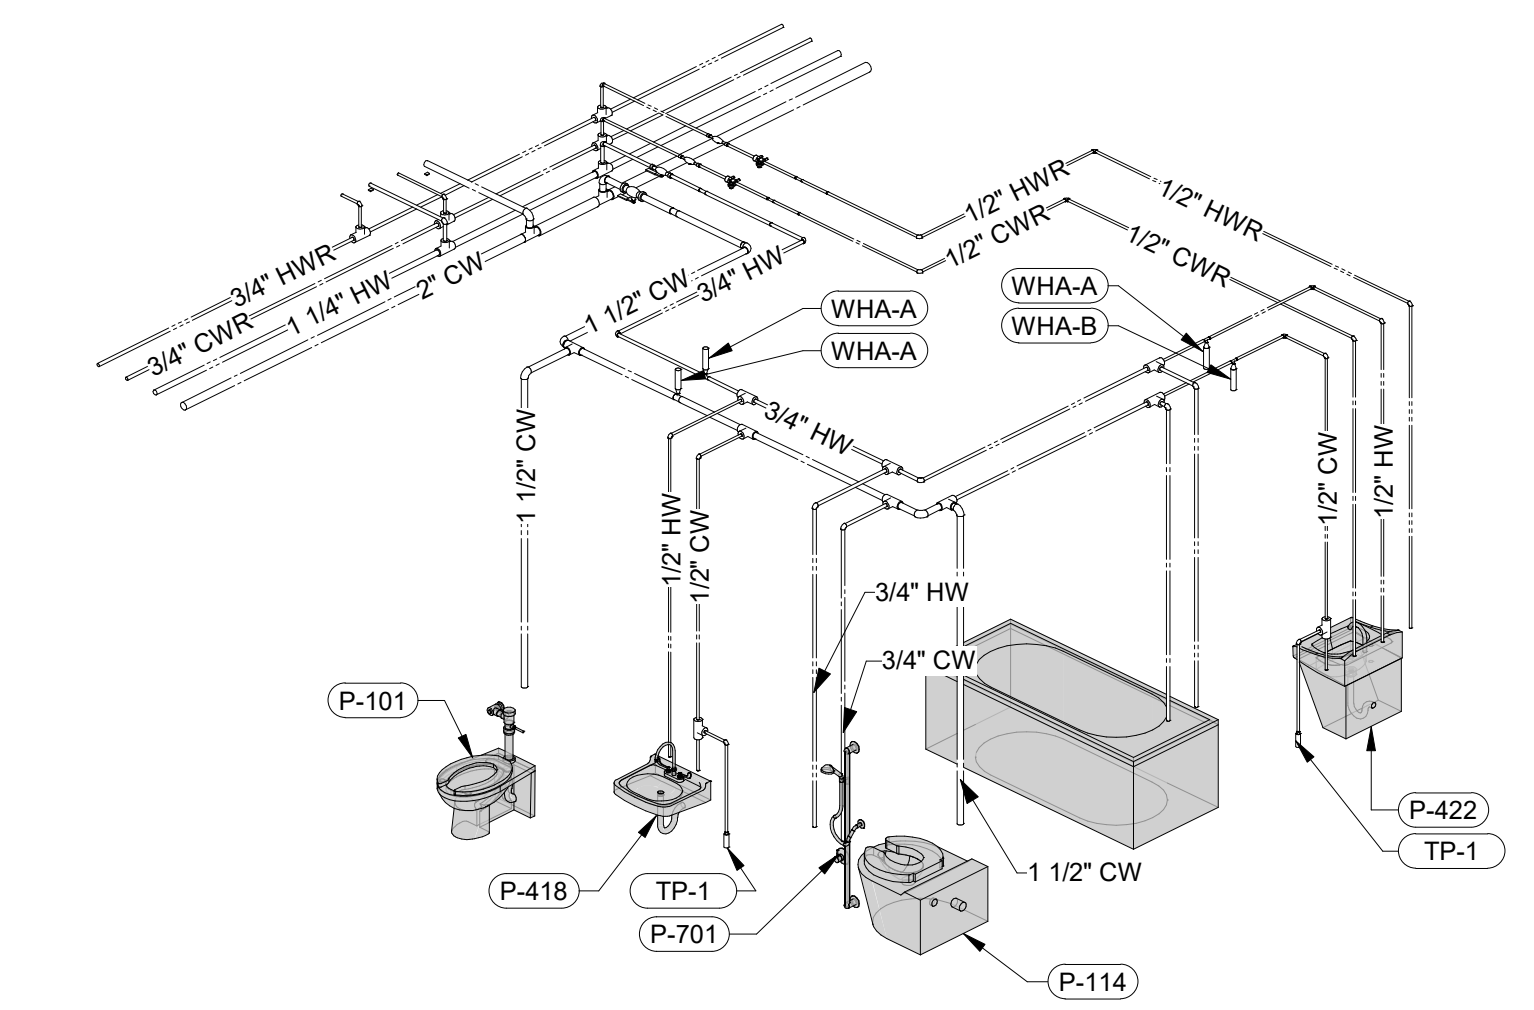

7 REC THERAPY OFFICE (B132) AND REC THERAPY (B133)

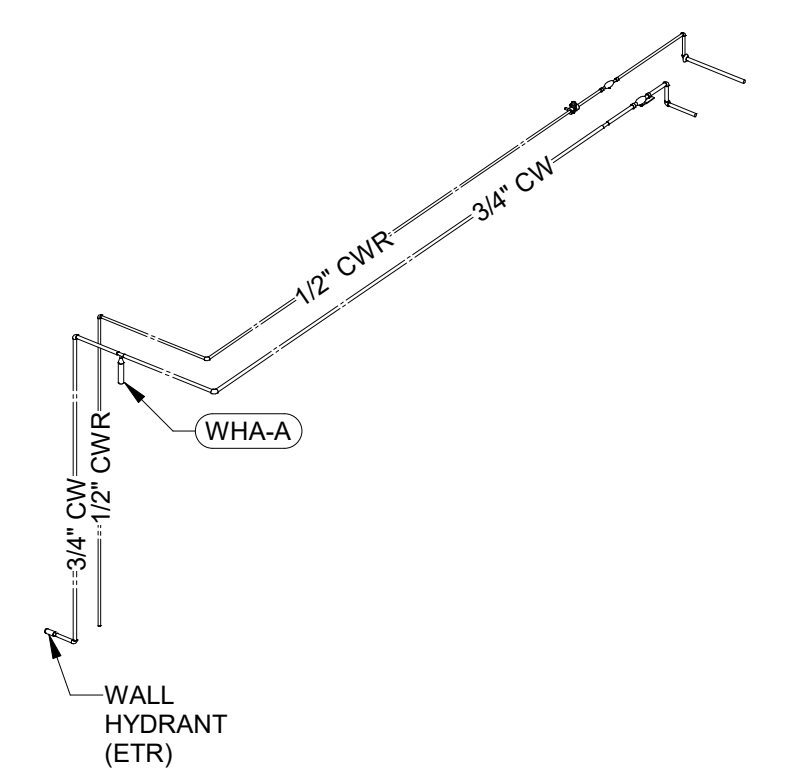

3 BARIATRIC TOILET (B119A)




4 RESIDENT (B122)


CONSULTANT INFORMATION STRUCTURAL / CIVIL ENGINEER STAND STRUCTURAL ENGINEERING 11227 W. 112TH STREET, SUITE 200 OVERLAND PARK, KS 66210 (913) 214-2169 MECHANICAL / ELECTRICAL / PLUMBING / TECHNICAL ENGINEER SPUR DESIGN 11020 KING STREET, SUITE 350 OVERLAND PARK, KS 66210 (405) 842-6100 FIRE PROTECTION ENGINEER POOLE FIRE PROTECTION, INC. 19910 W. 161ST STREET OLATH, KS 66062 (913) 829-8650		ARCHITECT  512 5th Street Overland Park, KS 66150 (913) 214-2169  DAN E. SOMMER LICENSED PROFESSIONAL ENGINEER 22162 7/10/2019 KANSAS		Office of Construction and Facilities Management VA U.S. Department of Veteran Affairs		SHEET TITLE PLUMBING RISER DIAGRAMS APPROVED: PROJECT DIRECTOR		PROJECT PHASE BID DOCUMENTS FULLY SPRINKLERED		PROJECT TITLE RENOVATE A & B WING BUILDING 6 PROJECT LOCATION 2200 SW GAGE BLVD TOPEKA, KS 66622 DATE 07/10/2019 CHECKED BY JES DRAWN BY RLC		VA PROJECT NUMBER 589-A5-19-116 BUILDING NUMBER 6 DRAWING NUMBER 6-P-304 Dwg. 84 OF 160	
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PLUMBING PLAN NOTES:


1. INSTALL SANITARY VENT PIPING TO VENT THROUGH ROOF. PROVIDE VTR AS SHOWN ON SHEET 6-P-102A. VTR MUST BE A MINIMUM OF 25 FEET AWAY FROM ANY FRESH AIR INTAKES.
2. INSTALL SANITARY VENT PIPING TO VENT THROUGH ROOF. PROVIDE VTR AS SHOWN ON SHEET 6-P-102B. VTR MUST BE A MINIMUM OF 25 FEET AWAY FROM ANY FRESH AIR INTAKES.
3. INSTALL STORM PIPING AND CONNECT TO EXISTING ROOF DRAIN.
4. COORDINATE ALL FLOOR PENETRATIONS WITH EXISTING WAFFLE SLAB.

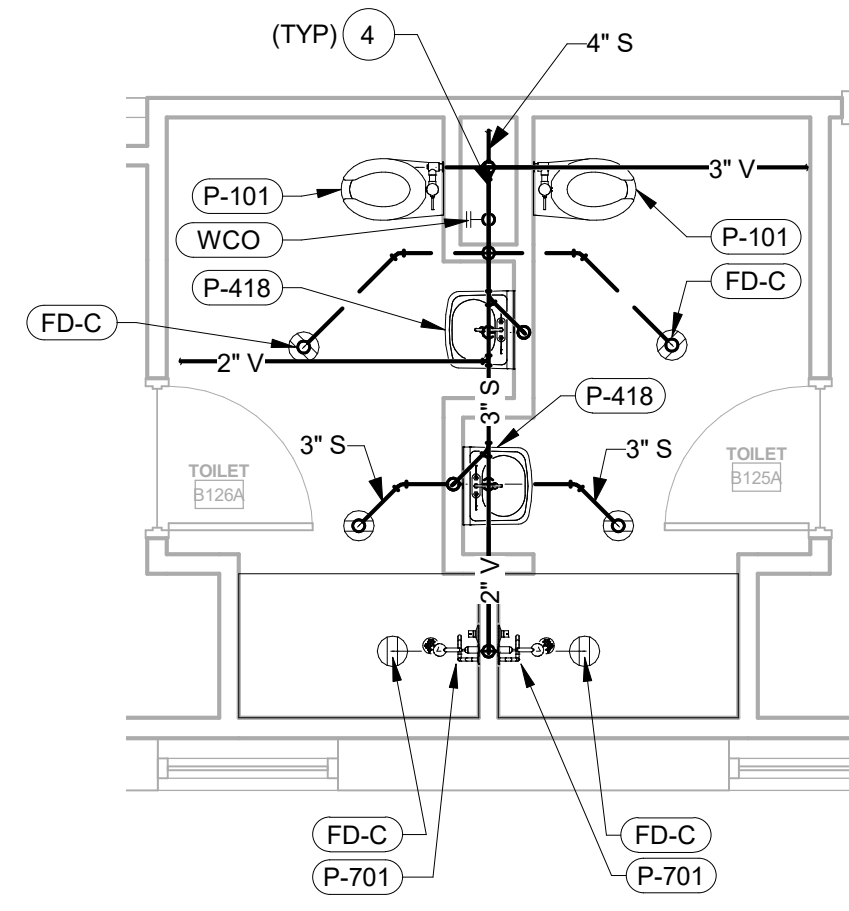


9 TOILET (B125A & B126A)
1/4" = 1'-0"

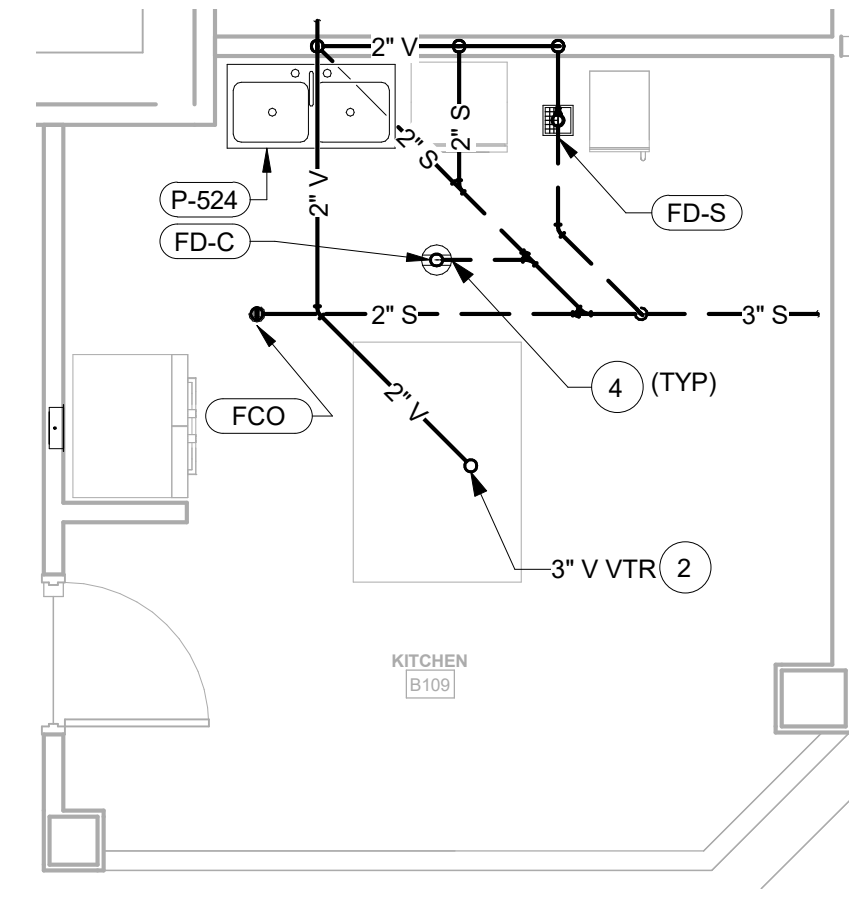


5 KITCHEN (B109)
1/4" = 1'-0"

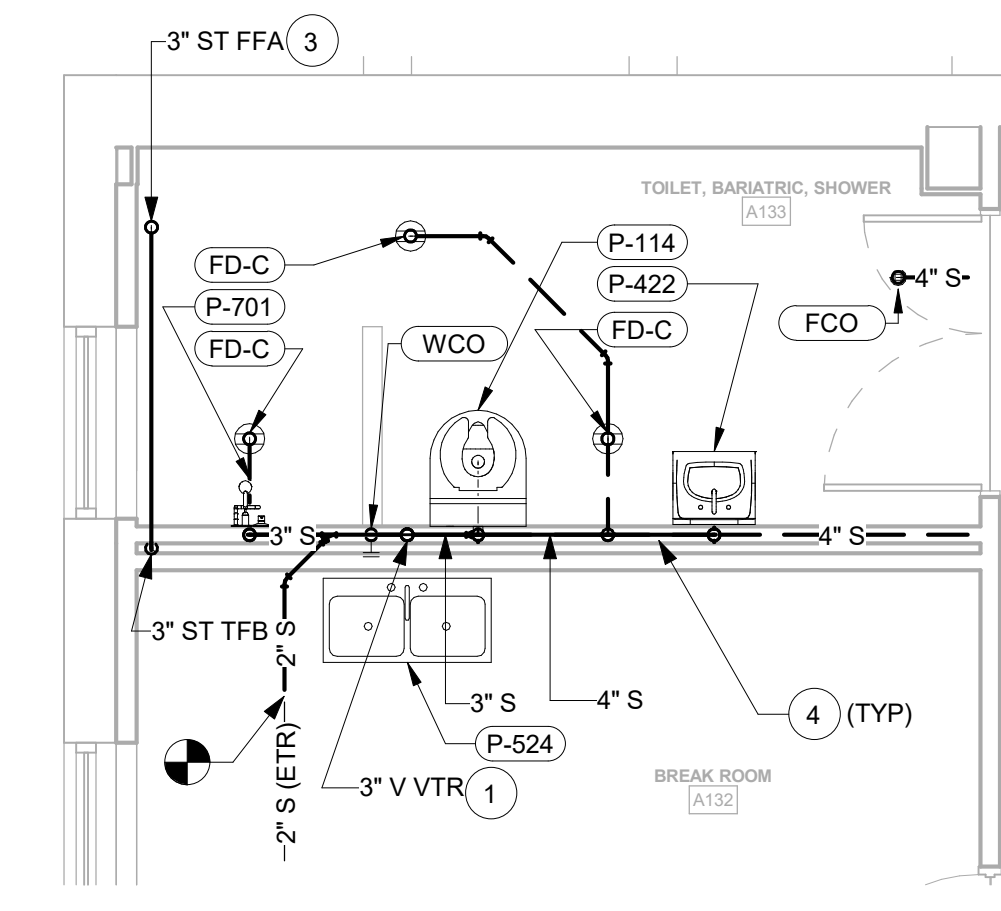


1 BREAK ROOM (A132) AND BARIATRIC TOILET (A133)
1/4" = 1'-0"

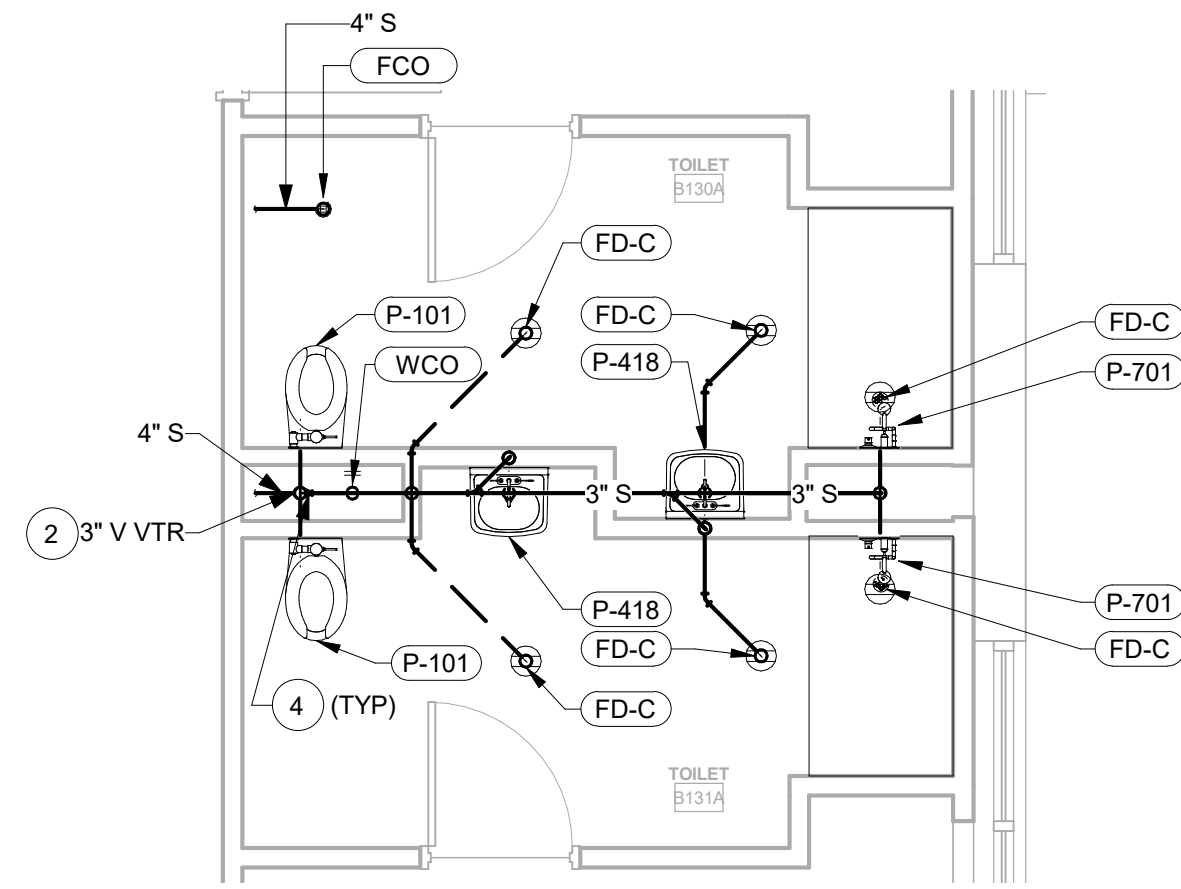


10 TOILETS (B130A & B131A)
1/4" = 1'-0"

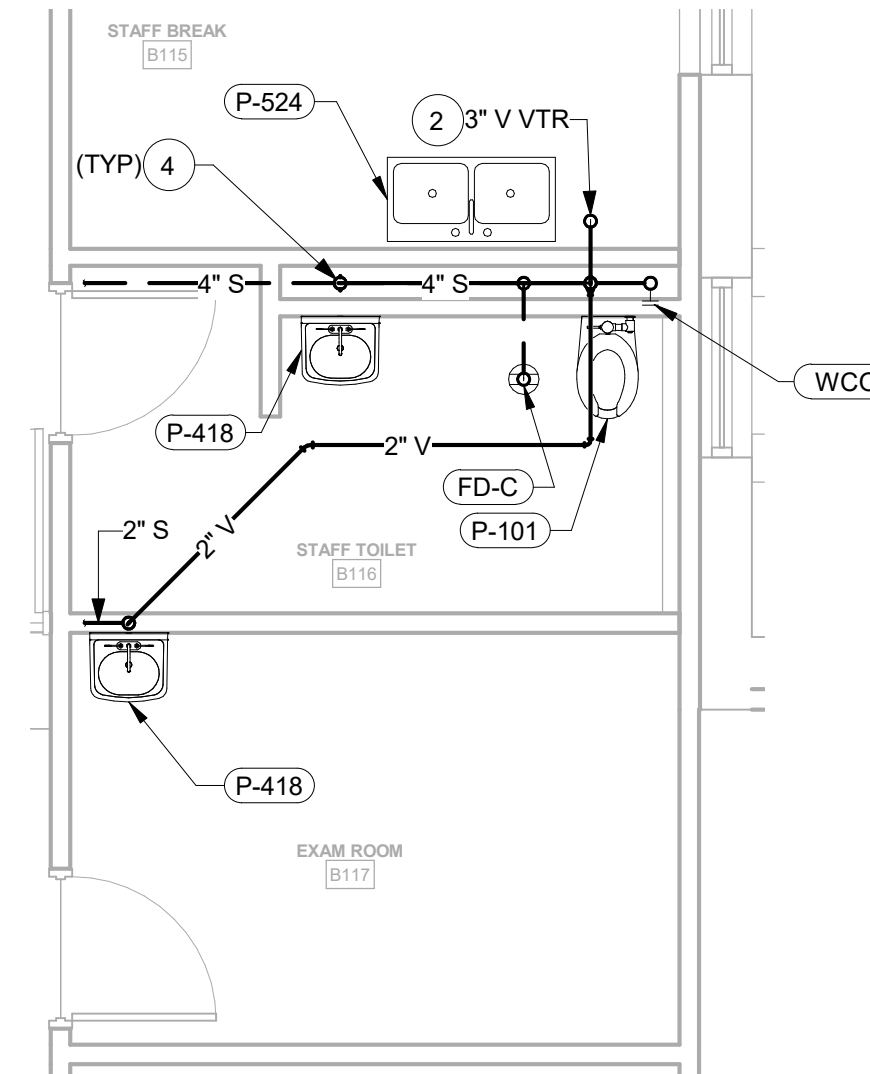


6 STAFF BREAK (B115), STAFF TOILET (B116), AND EXAM ROOM (B117)
1/4" = 1'-0"

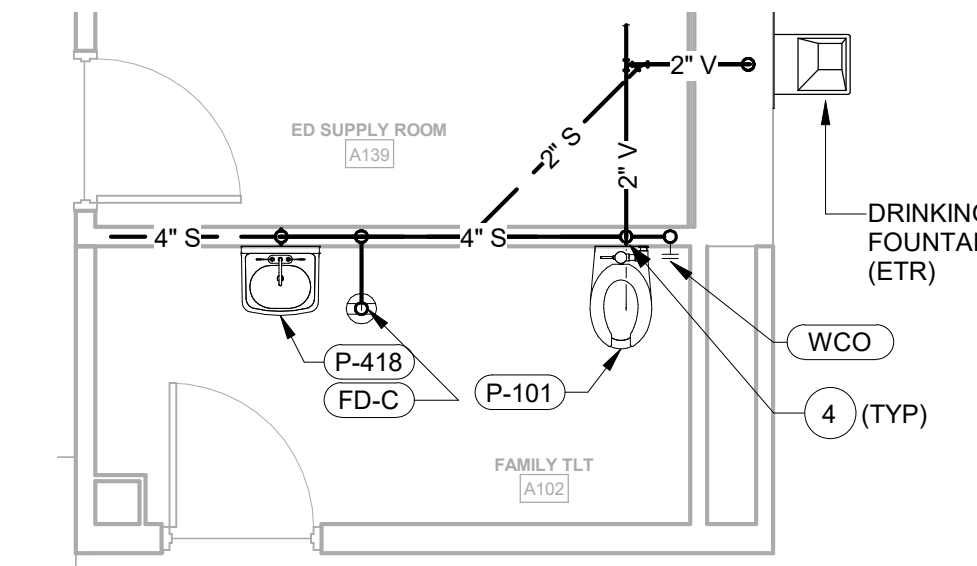


2 FAMILY TOILET (A102)
1/4" = 1'-0"

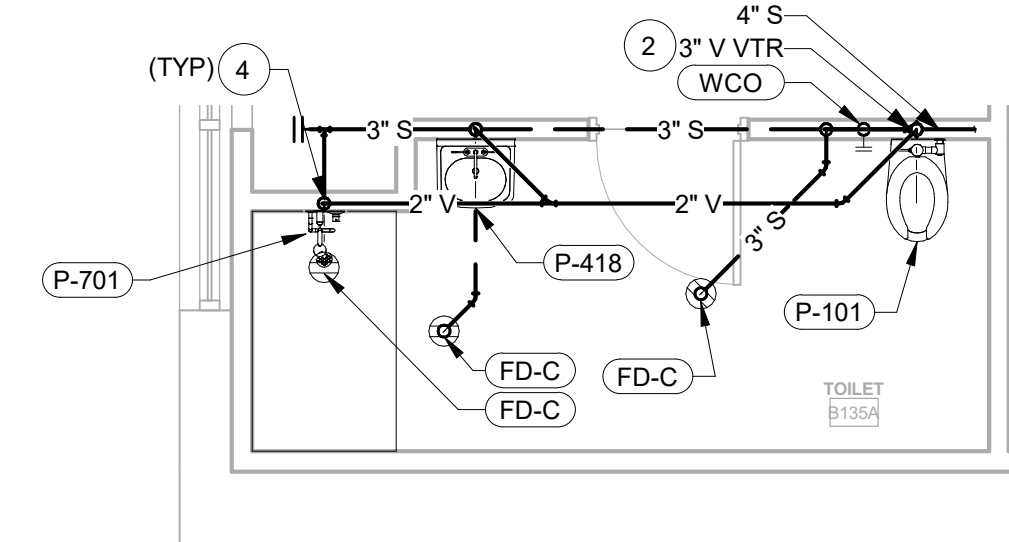


11 TOILET (B135A)
1/4" = 1'-0"

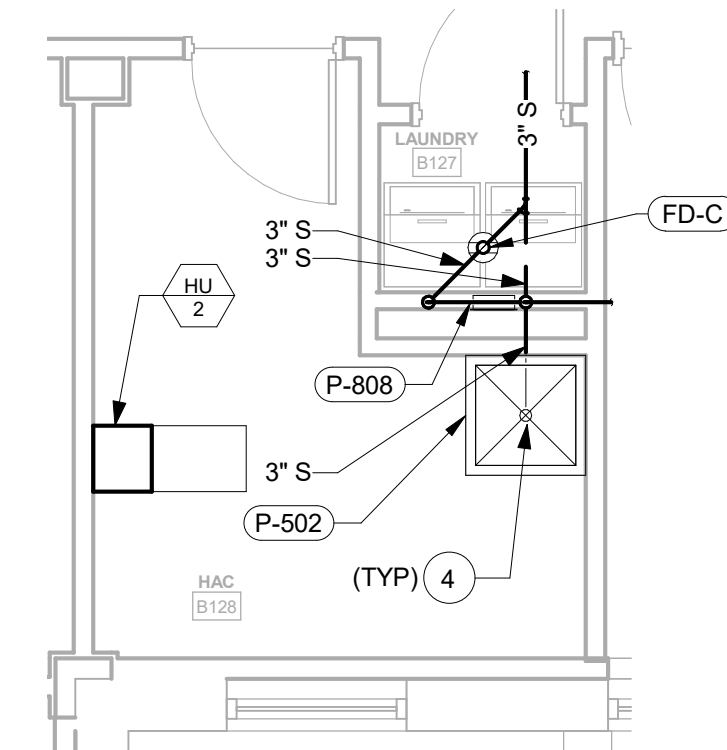


7 LAUNDRY (B127) AND HAC (B128)
1/4" = 1'-0"

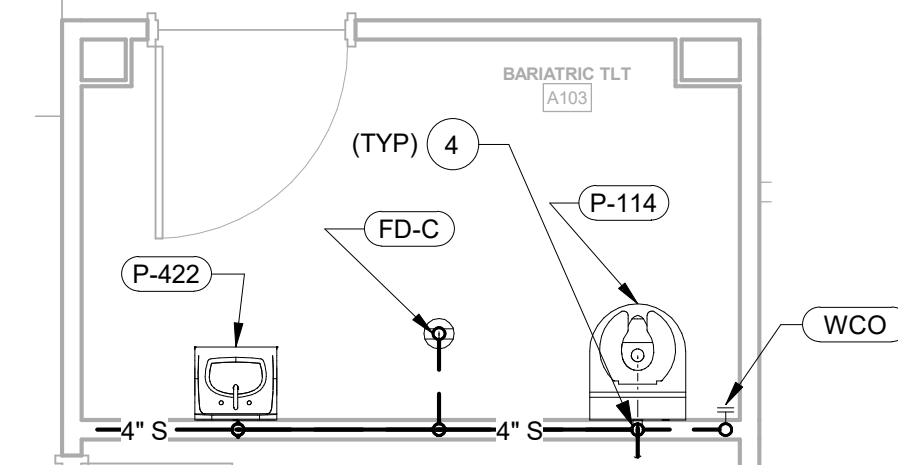

3 BARIATRIC TOILET (A103)
1/4" = 1'-0"

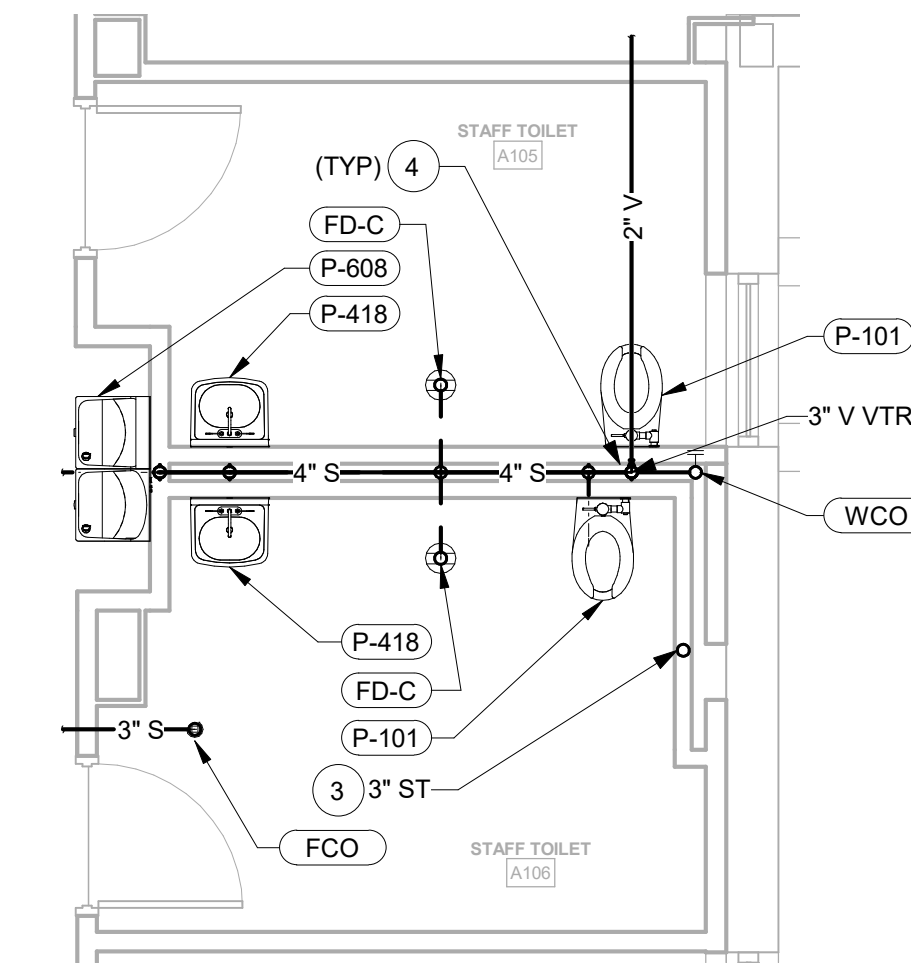

4 STAFF TOILETS (A105 & A106)
1/4" = 1'-0"

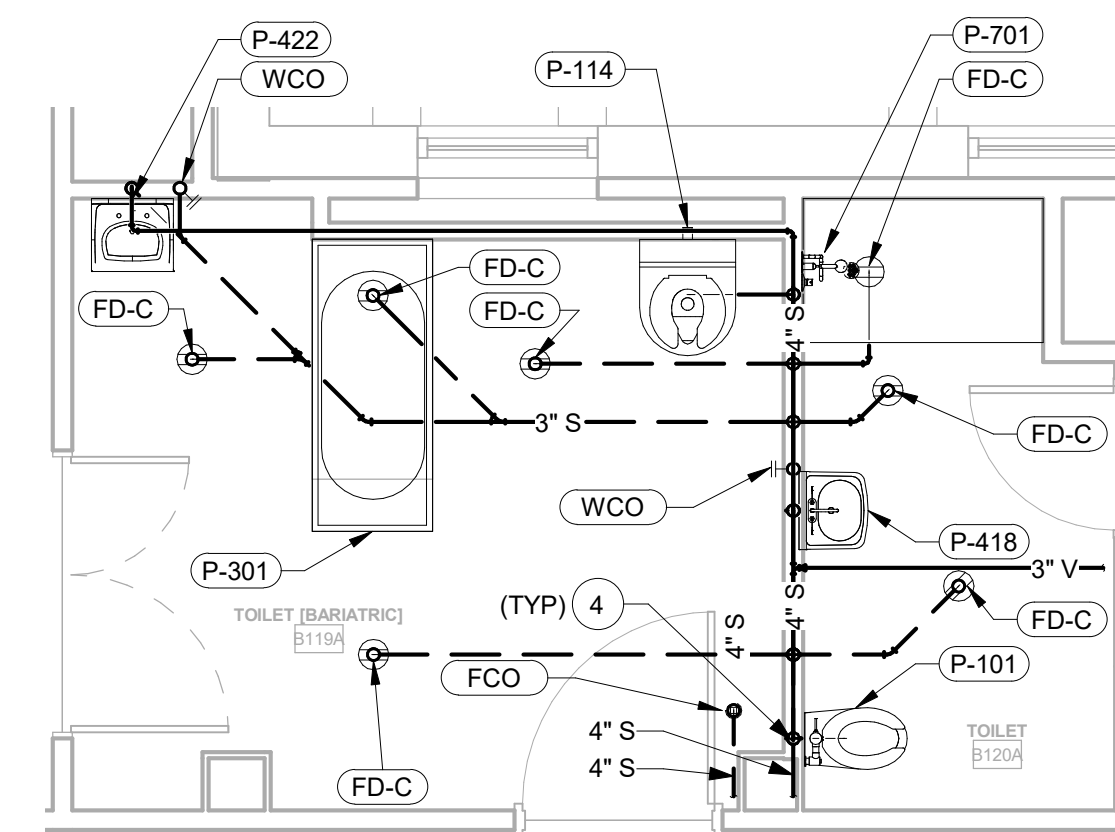

8 TOILET (B119A) AND BARIATRIC TOILET (B120A)
1/4" = 1'-0"

CONSULTANT INFORMATION

STRUCTURAL / CIVIL ENGINEER
STAND STRUCTURAL ENGINEERING
11927 W. 112TH STREET, SUITE 200
OVERLAND PARK, KS 66210
(913) 214-2169

MECHANICAL / ELECTRICAL / PLUMBING / TECHNICAL ENGINEER
SPUR DESIGN
11020 KING STREET, SUITE 350
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FIRE PROTECTION ENGINEER
POOLE FIRE PROTECTION, INC.
19910 W. 161ST STREET
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ARCHITECT



513 5th Street
Overland Park, KS 66209
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10020 King Street, Suite 300
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spur-design.com



Office of
Construction
and Facilities
Management

VA U.S. Department
of Veteran Affairs

SHEET TITLE
PLUMBING PARTIAL PLANS

APPROVED: PROJECT DIRECTOR

PROJECT PHASE
BID DOCUMENTS

FULLY SPRINKLERED

PROJECT TITLE
RENOVATE A & B WING BUILDING 6

PROJECT LOCATION
2200 SW GAGE BLVD
TOPEKA, KS 66622

DATE
07/10/2019

CHECKED BY
JES

DRAWN BY
RLC

VA PROJECT NUMBER
589-A5-19-116


BUILDING NUMBER
6

DRAWING NUMBER
6-P-401


Dwg. 85 OF 160

PLUMBING PLAN NOTES:


1. INSTALL DOMESTIC WATER PIPING AND CONNECT TO EXISTING PIPING AT DEMARCATION POINT SHOWN.
2. PROVIDE TRAP PRIMER WITH ACCESS PANEL IN LOCATION SHOWN ON ENLARGED PLAN. ROUTE TRAP PRIMER SUPPLY LINES TO FLOOR DRAINS.
3. PROVIDE TEMPERATURE SENSOR DOWNSTREAM OF DOMESTIC STEAM-WATER HEATER.
4. PROVIDE TEMPERATURE SENSOR UPSTREAM OF RECIRCULATION PUMP.
5. ROUTE MEDICAL GAS PIPING DOWN TO NEW HEADWALL AS SHOWN. COORDINATE CONNECTIONS WITH HEADWALL MANUFACTURER AND MEDICAL GAS EQUIPMENT SUPPLIER.
6. VERIFY OUTLET CONNECTION MANUFACTURER/TYPE WITH COR PRIOR TO SUBMISSION.

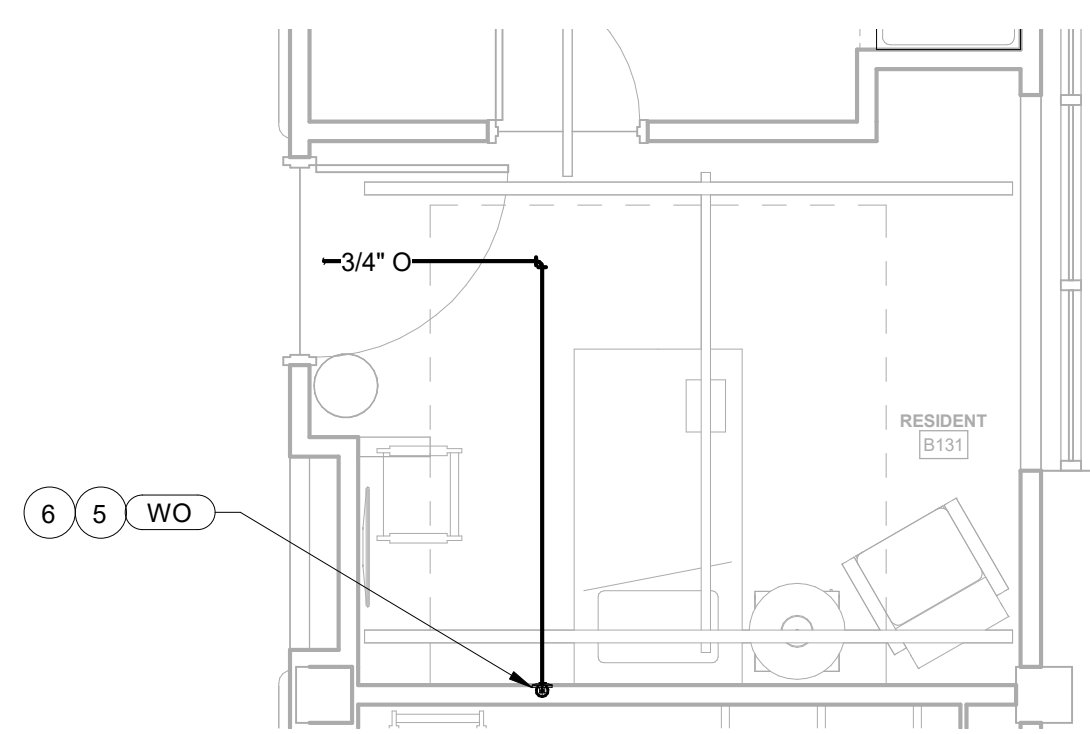


13 RESIDENT ROOM (B105)
1/4" = 1'-0"

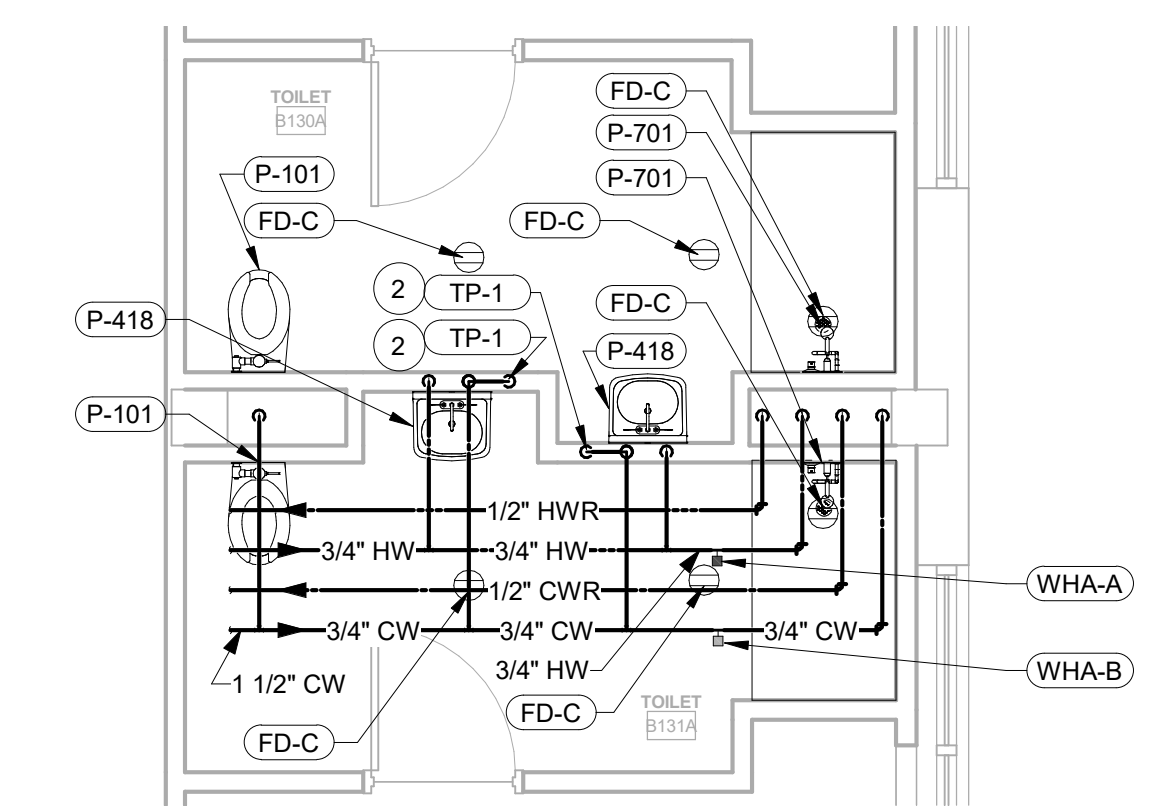


9 TOILETS (B130A & B131A)
1/4" = 1'-0"

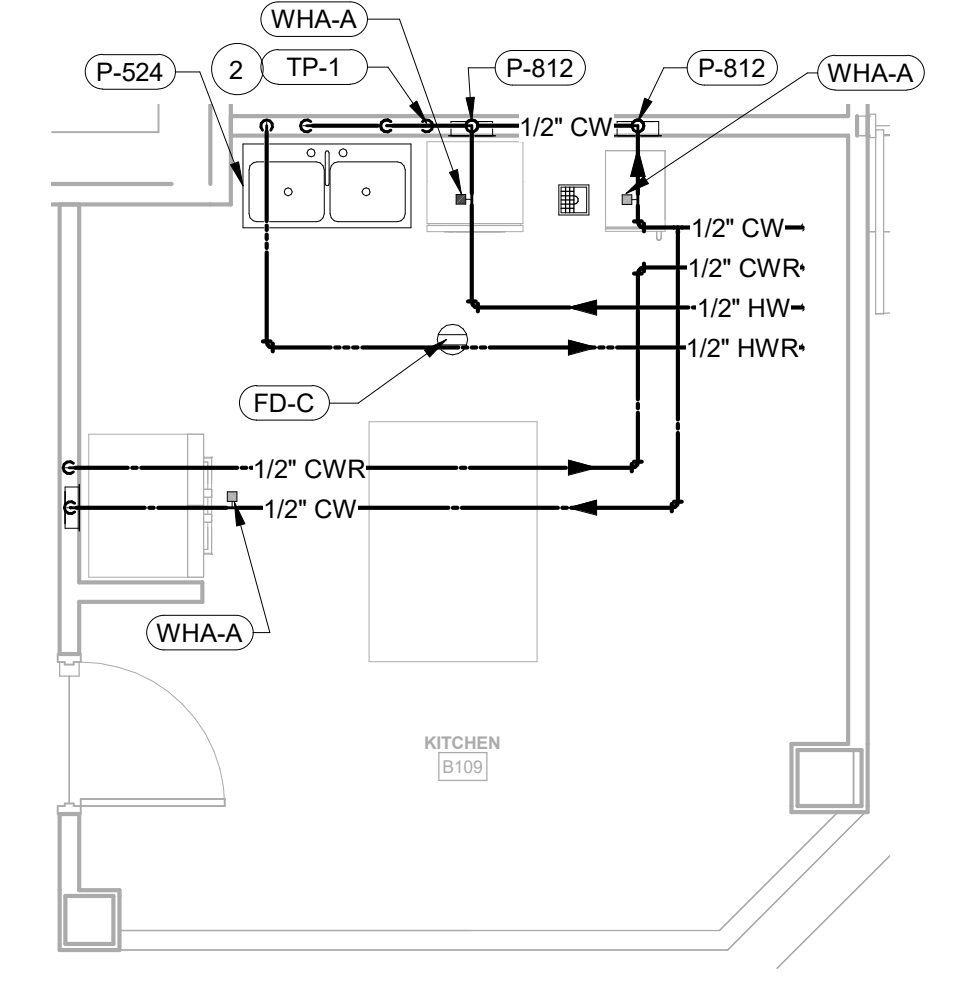


5 KITCHEN (B109)
1/4" = 1'-0"

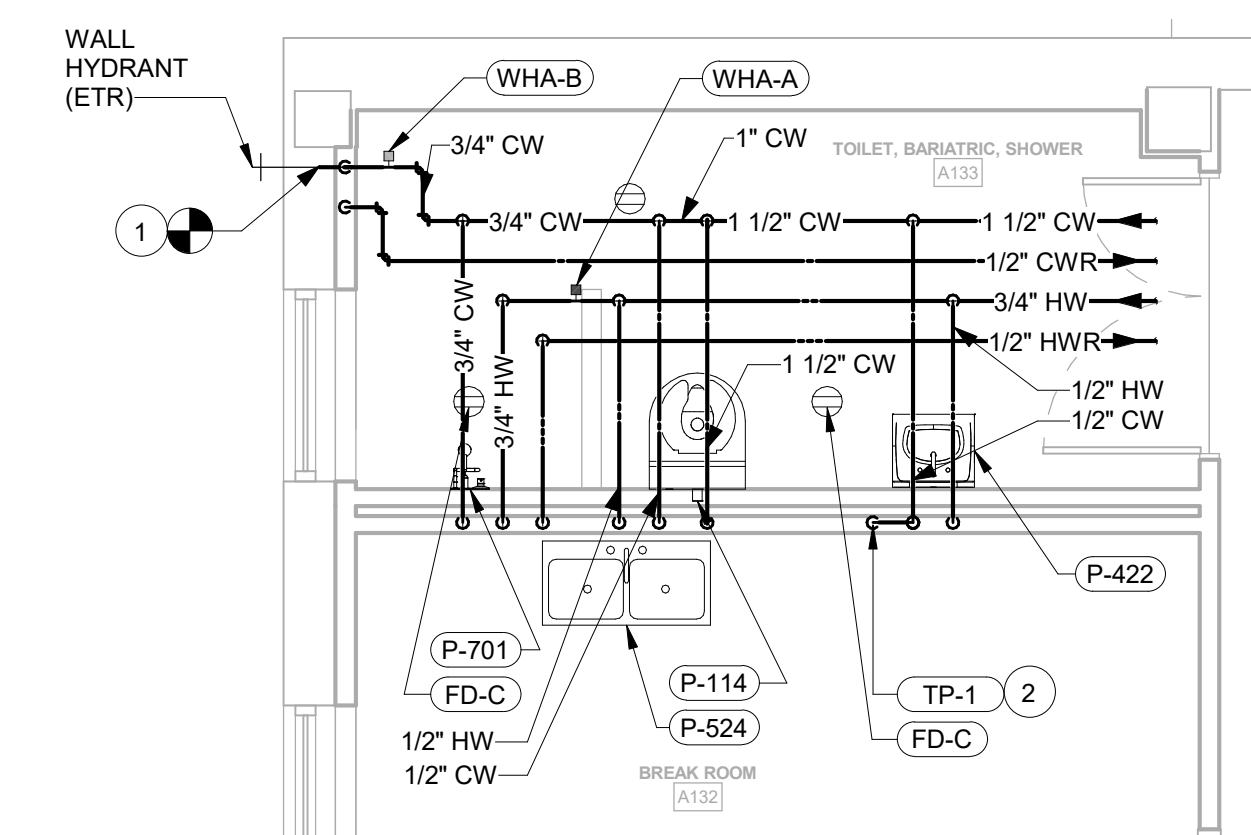


1 BREAK ROOM (A132) AND BARIATRIC TOILET (A133)
1/4" = 1'-0"

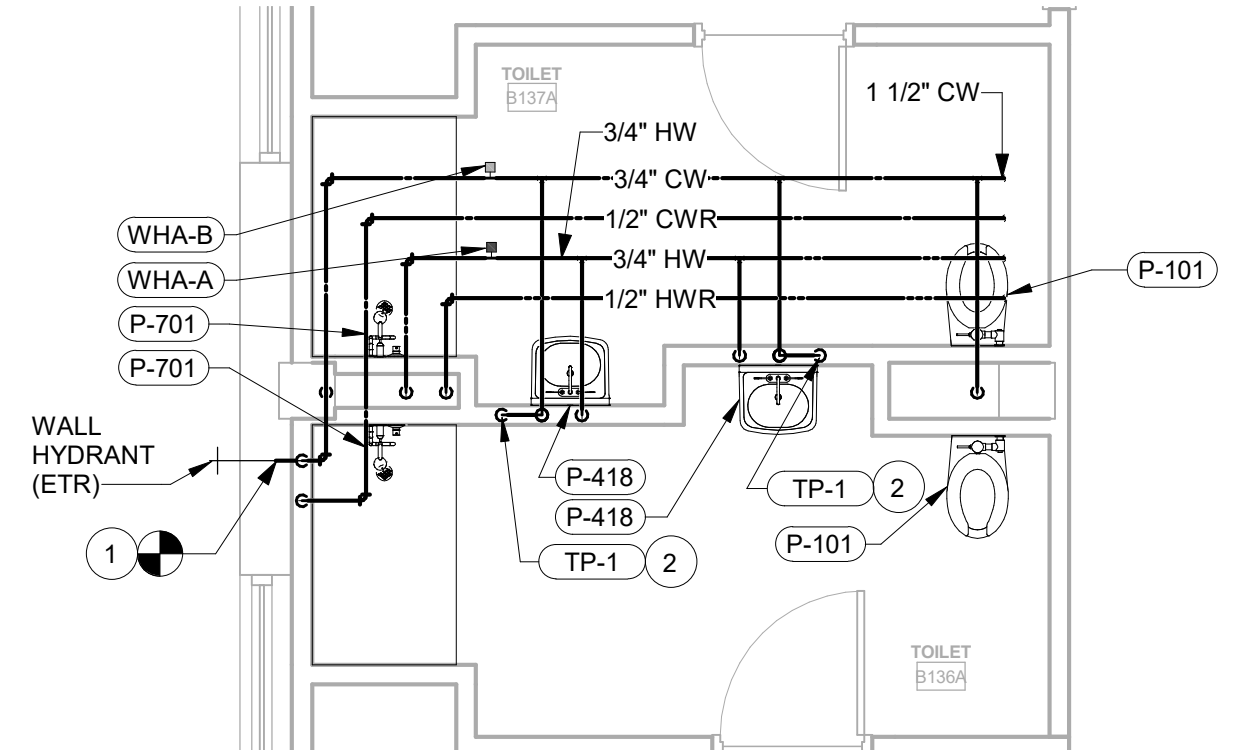


10 TOILET (B136A & B137A)
1/4" = 1'-0"

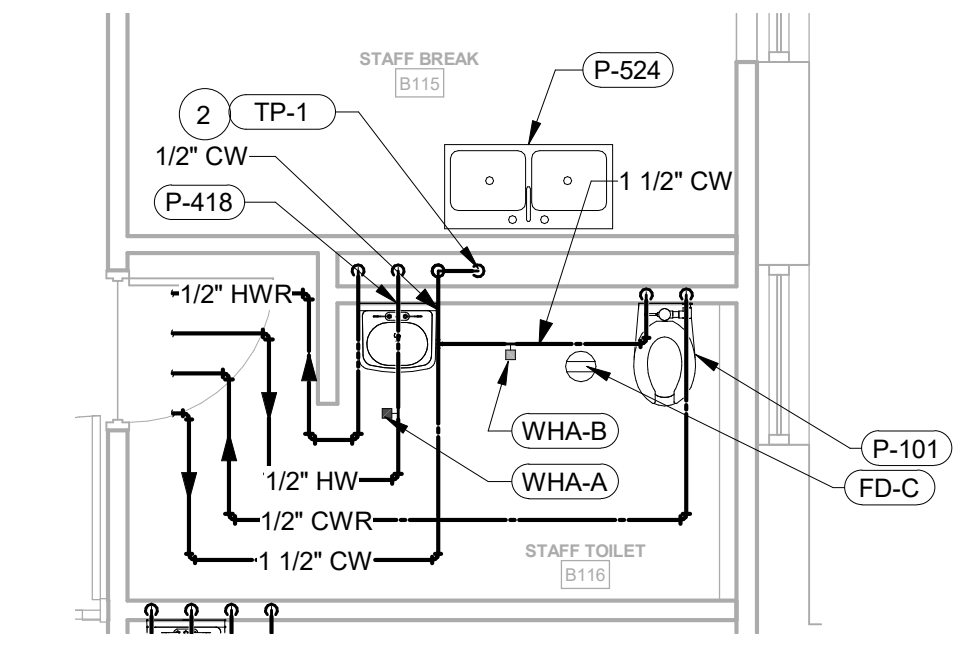


6 STAFF BREAK (B115) AND STAFF TOILET (B116)
1/4" = 1'-0"

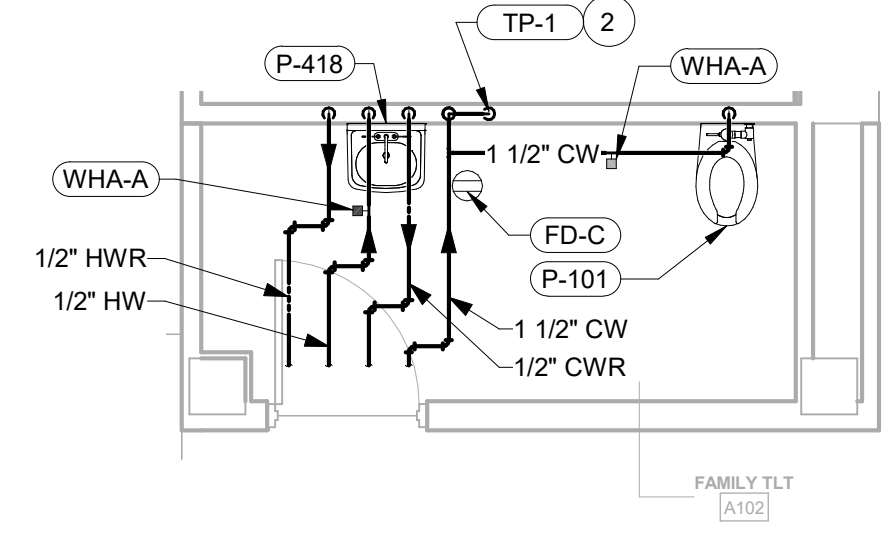


2 FAMILY TOILET (A102)
1/4" = 1'-0"

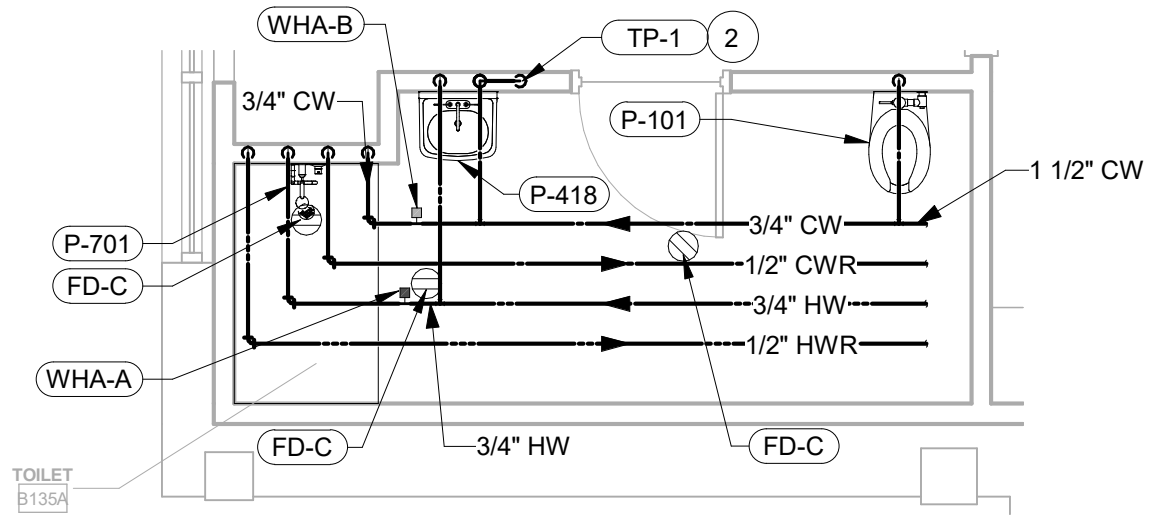


11 TOILET (B135A)
1/4" = 1'-0"

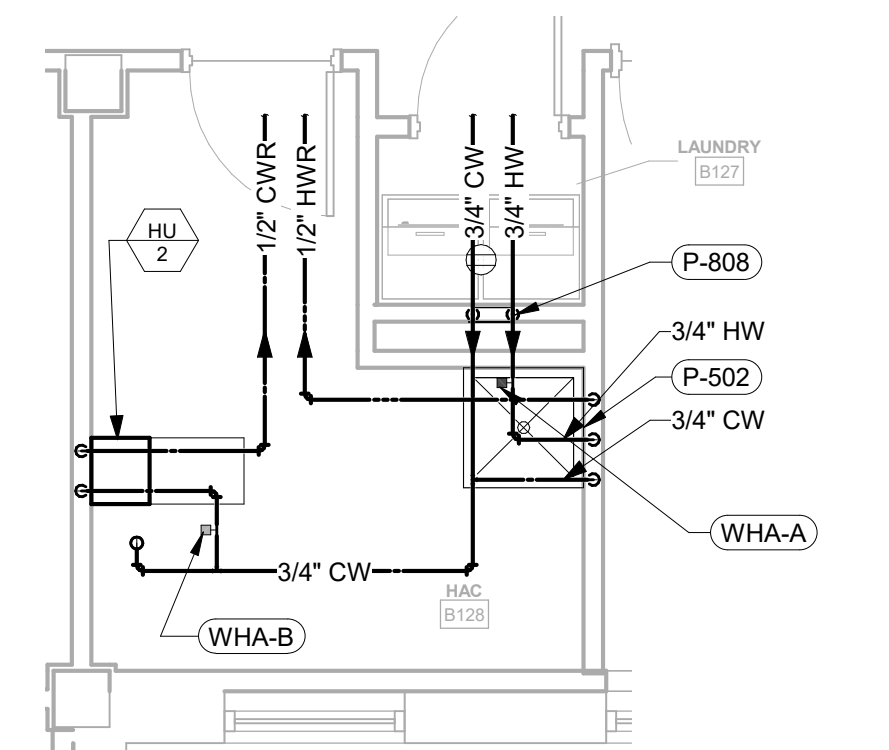


7 LAUNDRY (B127) AND HAC (B128)
1/4" = 1'-0"

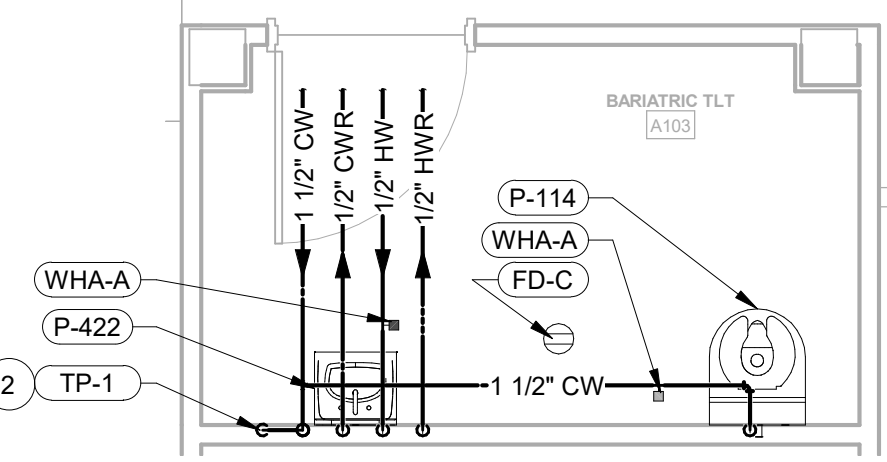


3 BARIATRIC TOILET (A103)
1/4" = 1'-0"

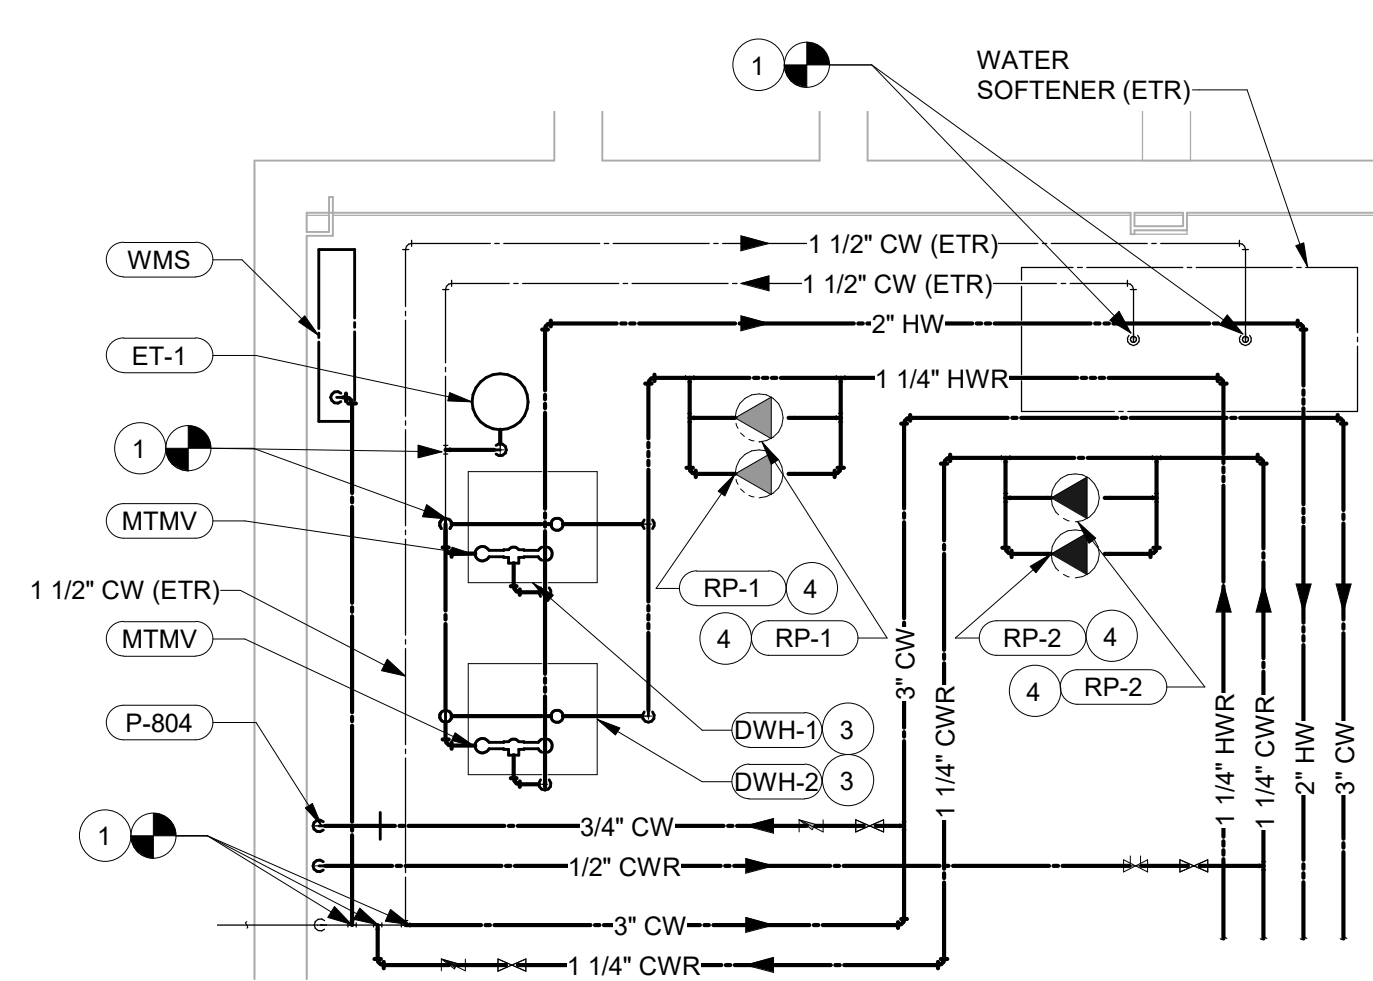

12 MECHANICAL ROOM - DOMESTIC WATER
1/4" = 1'-0"

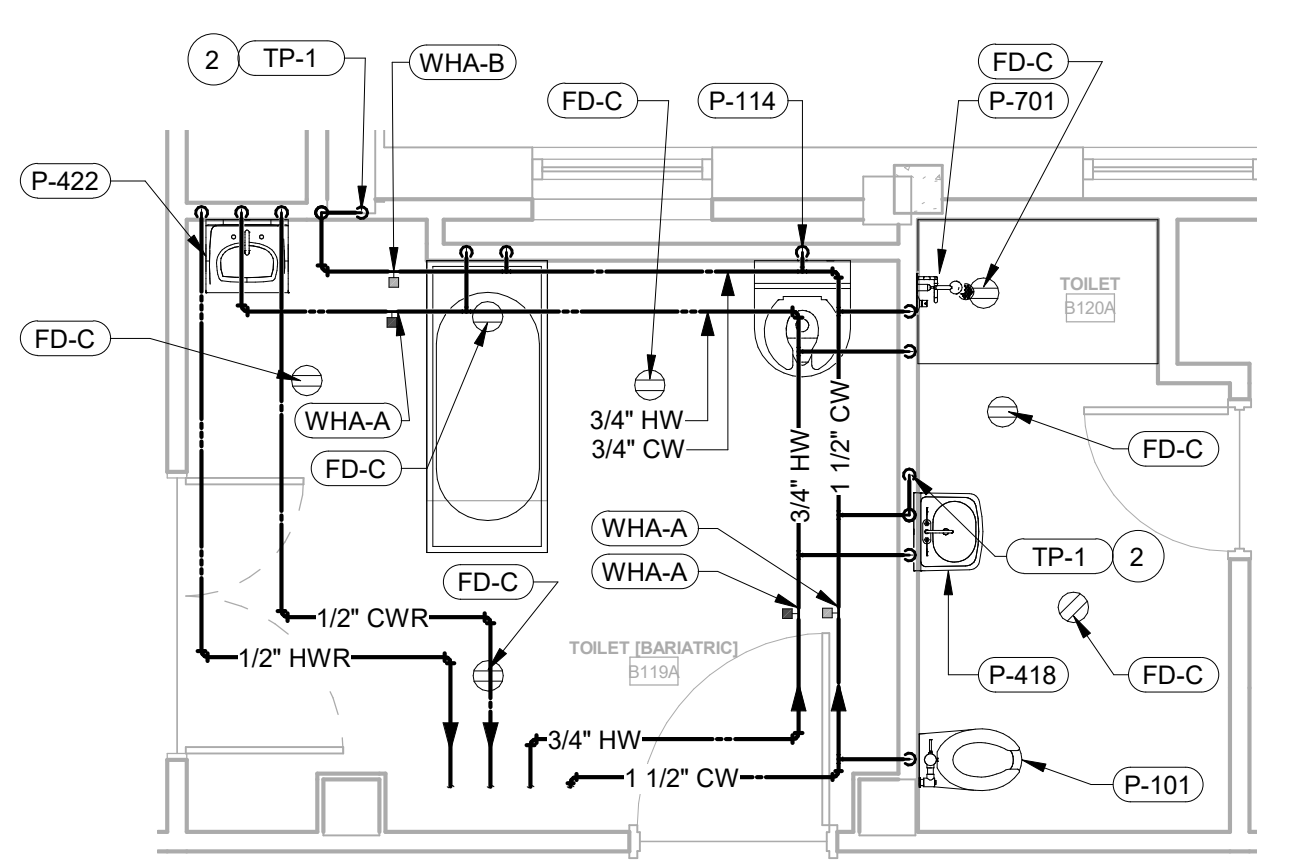

8 BARIATRIC TOILET (B119A)
1/4" = 1'-0"

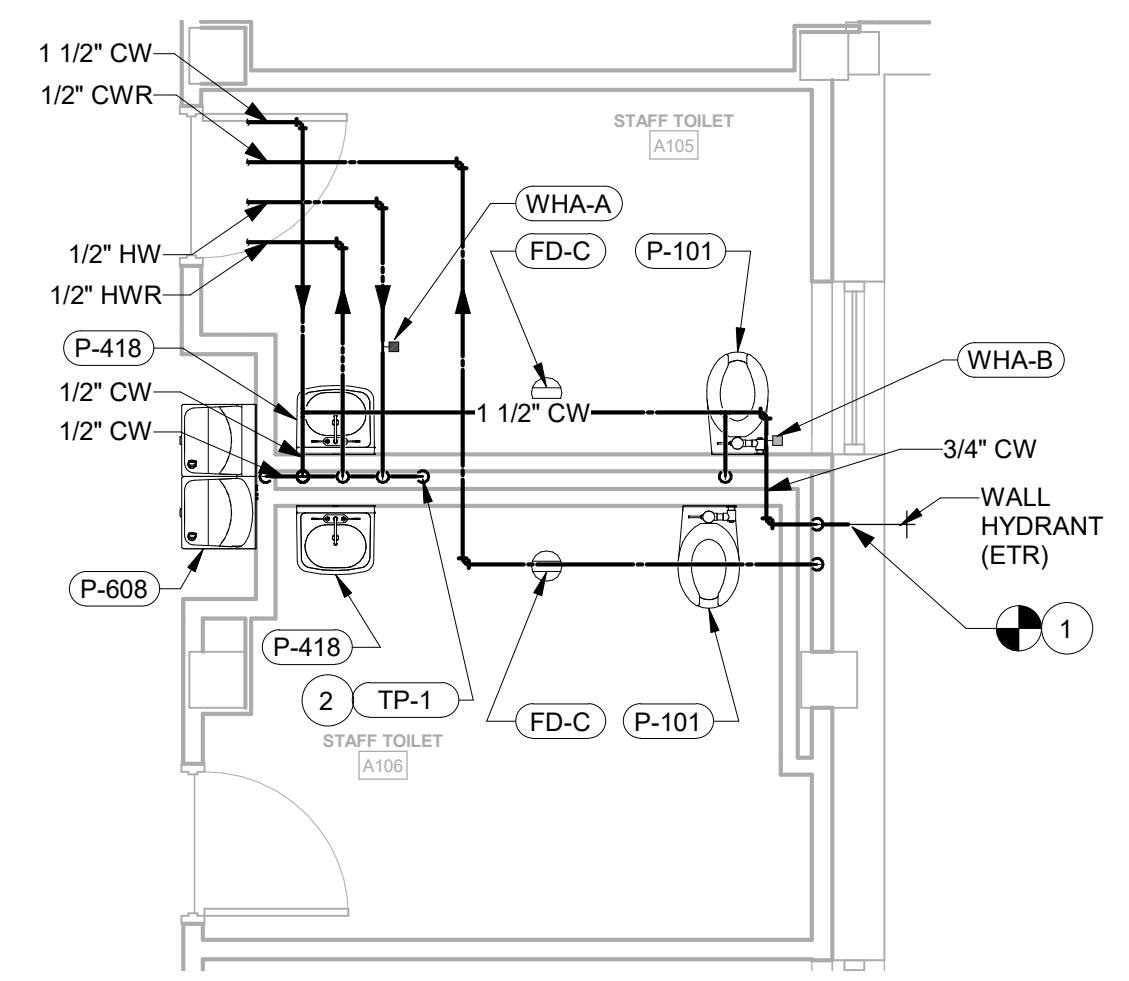

4 STAFF TOILETS (A105 & A106)
1/4" = 1'-0"

CONSULTANT INFORMATION

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ARCHITECT



Office of Construction and Facilities Management

VA U.S. Department of Veteran Affairs

SHEET TITLE
PLUMBING PARTIAL PLANS

APPROVED: PROJECT DIRECTOR

PROJECT PHASE
BID DOCUMENTS

FULLY SPRINKLERED

PROJECT TITLE
RENOVATE A & B WING BUILDING 6

PROJECT LOCATION
2200 SW GAGE BLVD
TOPEKA, KS 66622

DATE
07/10/2019

CHECKED BY
JES

DRAWN BY
RLC


VA PROJECT NUMBER
589-A5-19-116

BUILDING NUMBER
6

DRAWING NUMBER
6-P-402


Dwg. 86 OF 160

three inches = one foot
 one and one-half inches = one foot
 one inch = one foot
 three-quarters inch = one foot
 one-half inch = one foot
 three-eighths inch = one foot
 one-quarter inch = one foot
 one-eighth inch = one foot

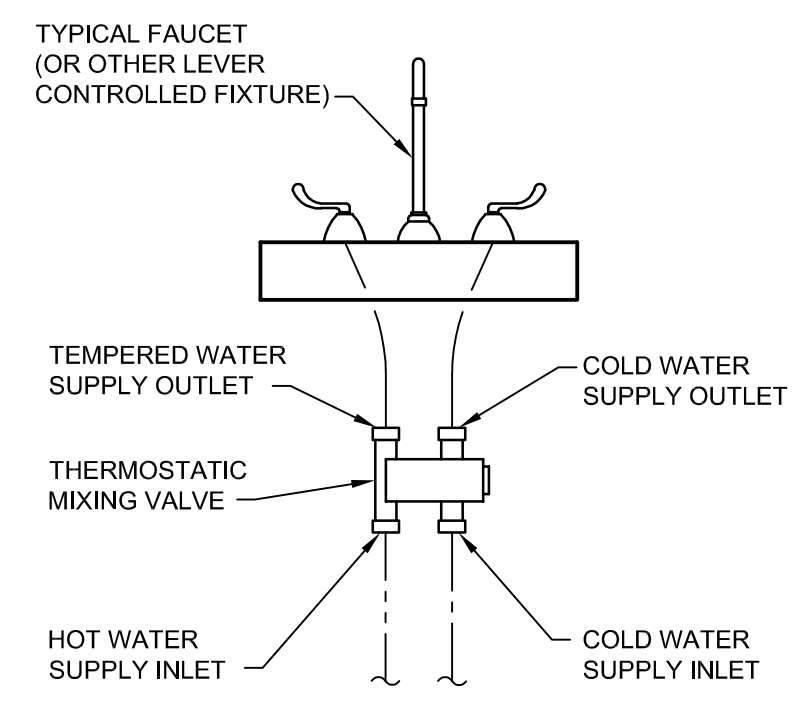


NOTE: POINT-OF-USE THERMOSTATIC MIXING VALVES MUST CONFORM TO ASSE 1070


7 POINT-OF-USE 4-PORT THERMOSTATIC MIXING VALVE DETAIL NOT TO SCALE

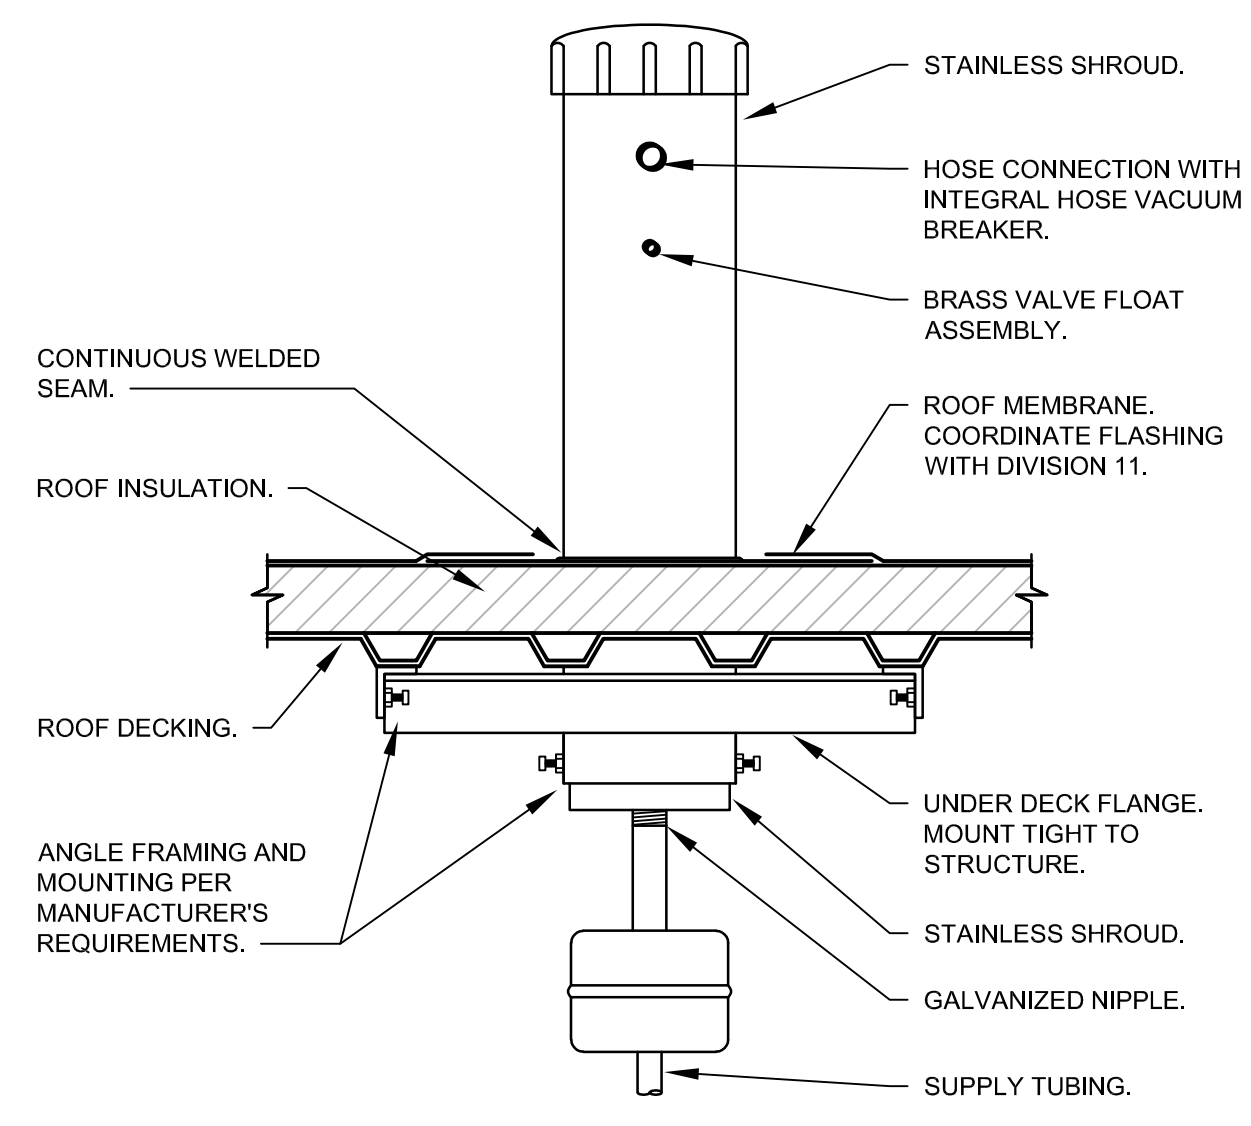


8 ROOF HYDRANT DETAIL NOT TO SCALE

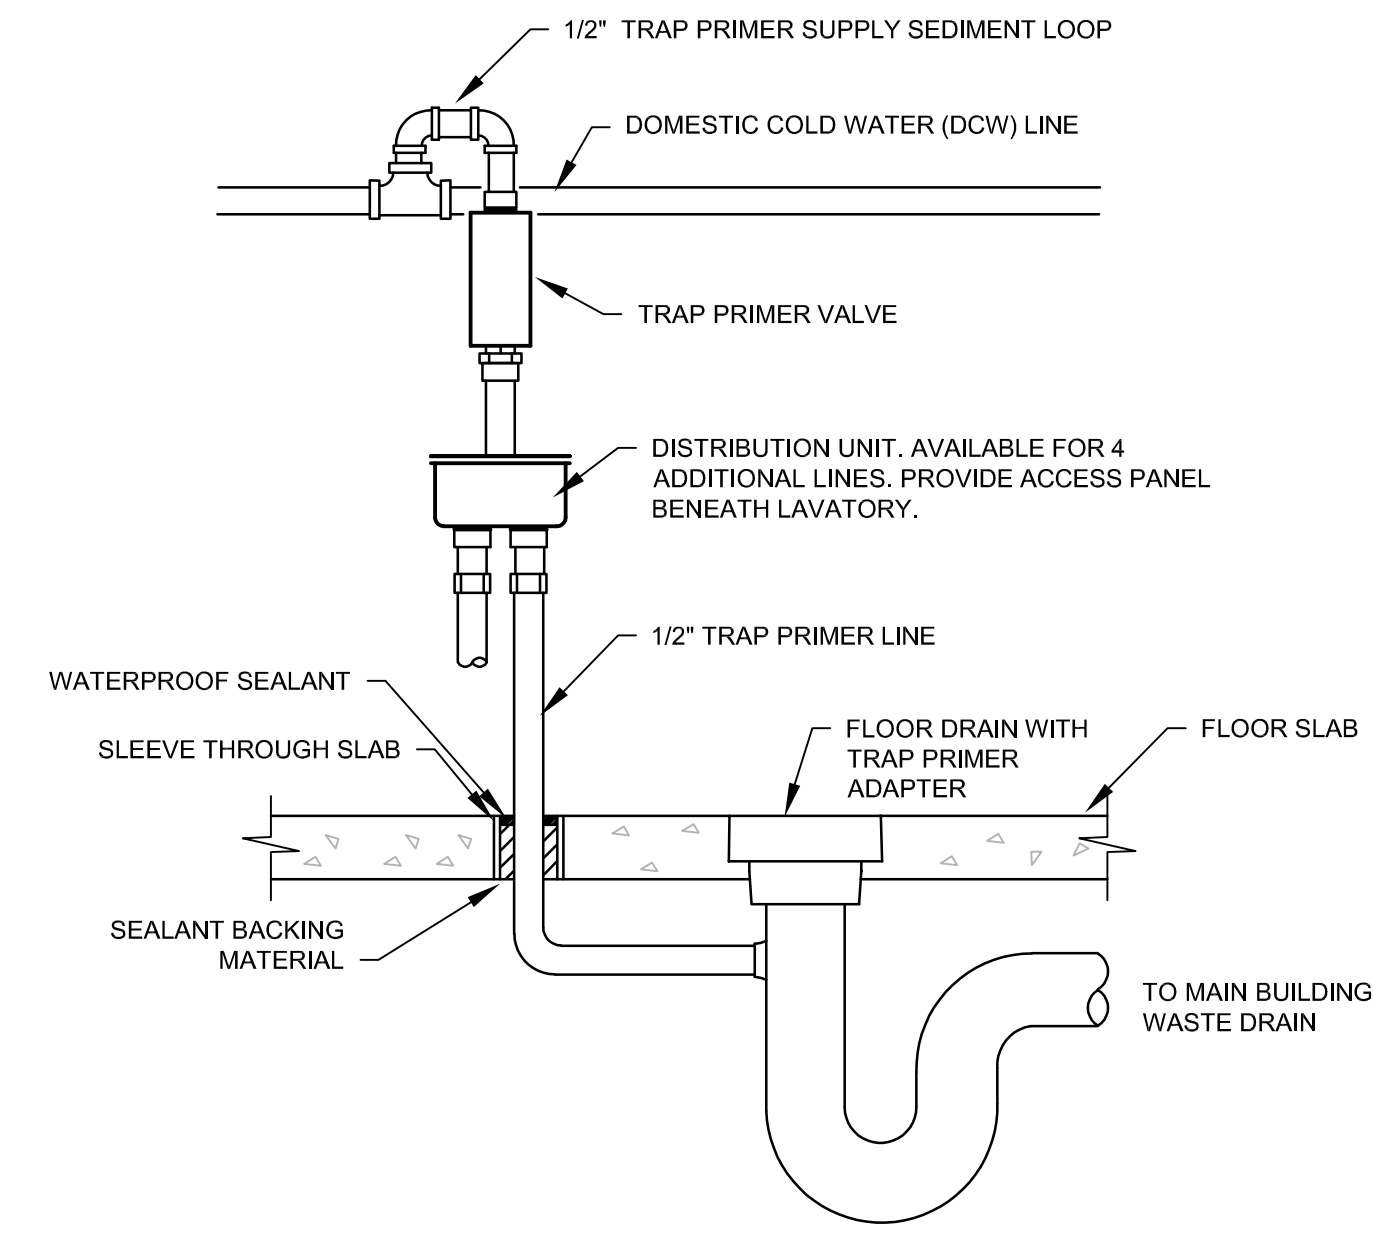

9 TRAP PRIMER NOT TO SCALE

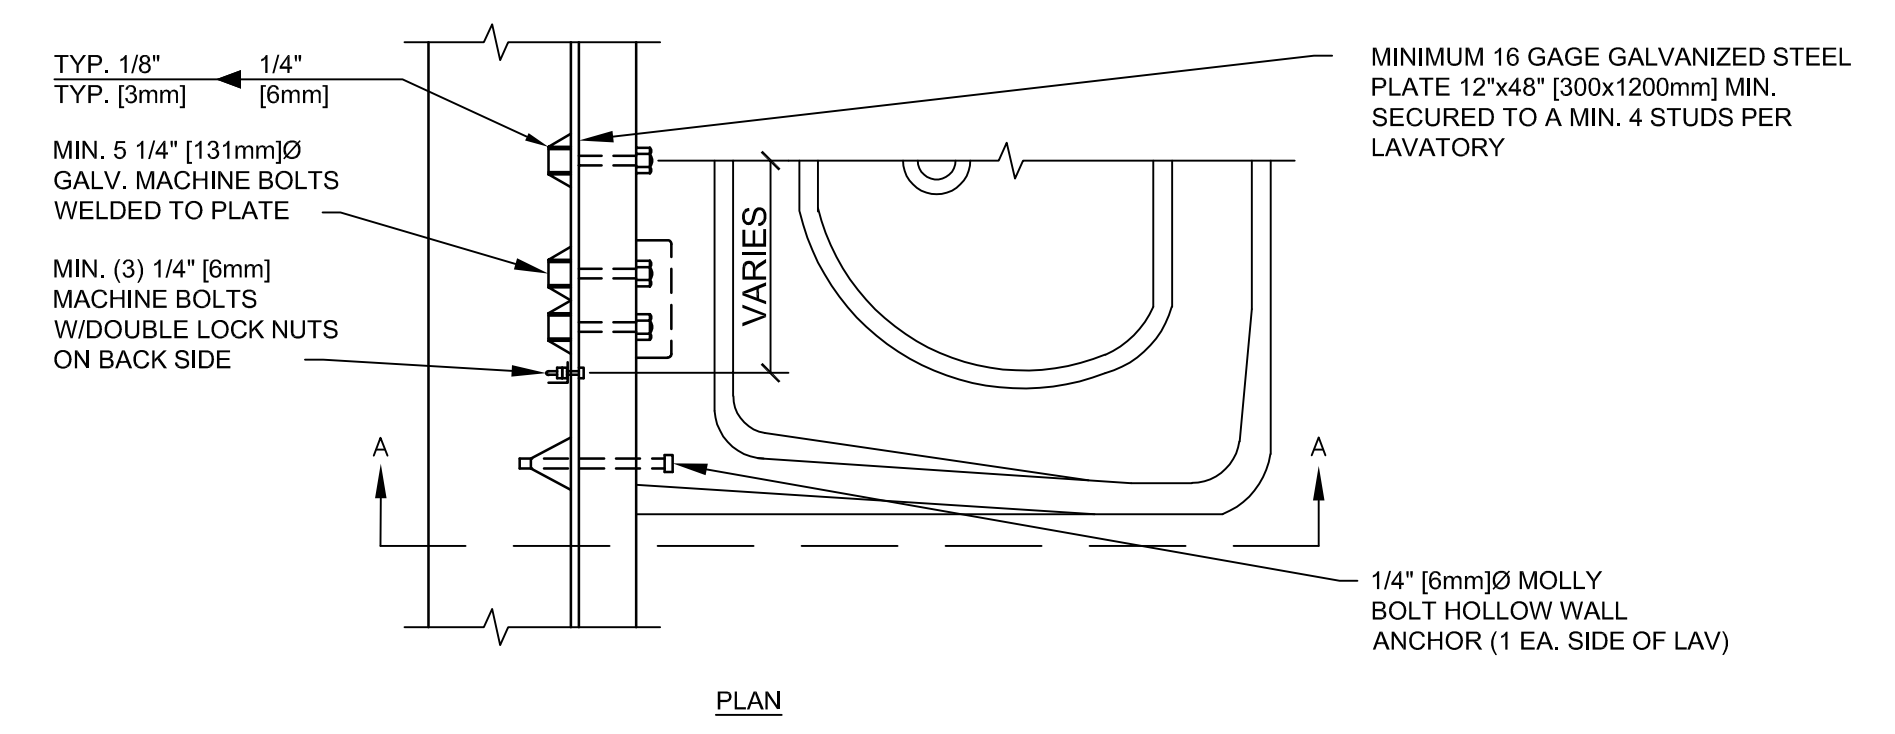


PLAN

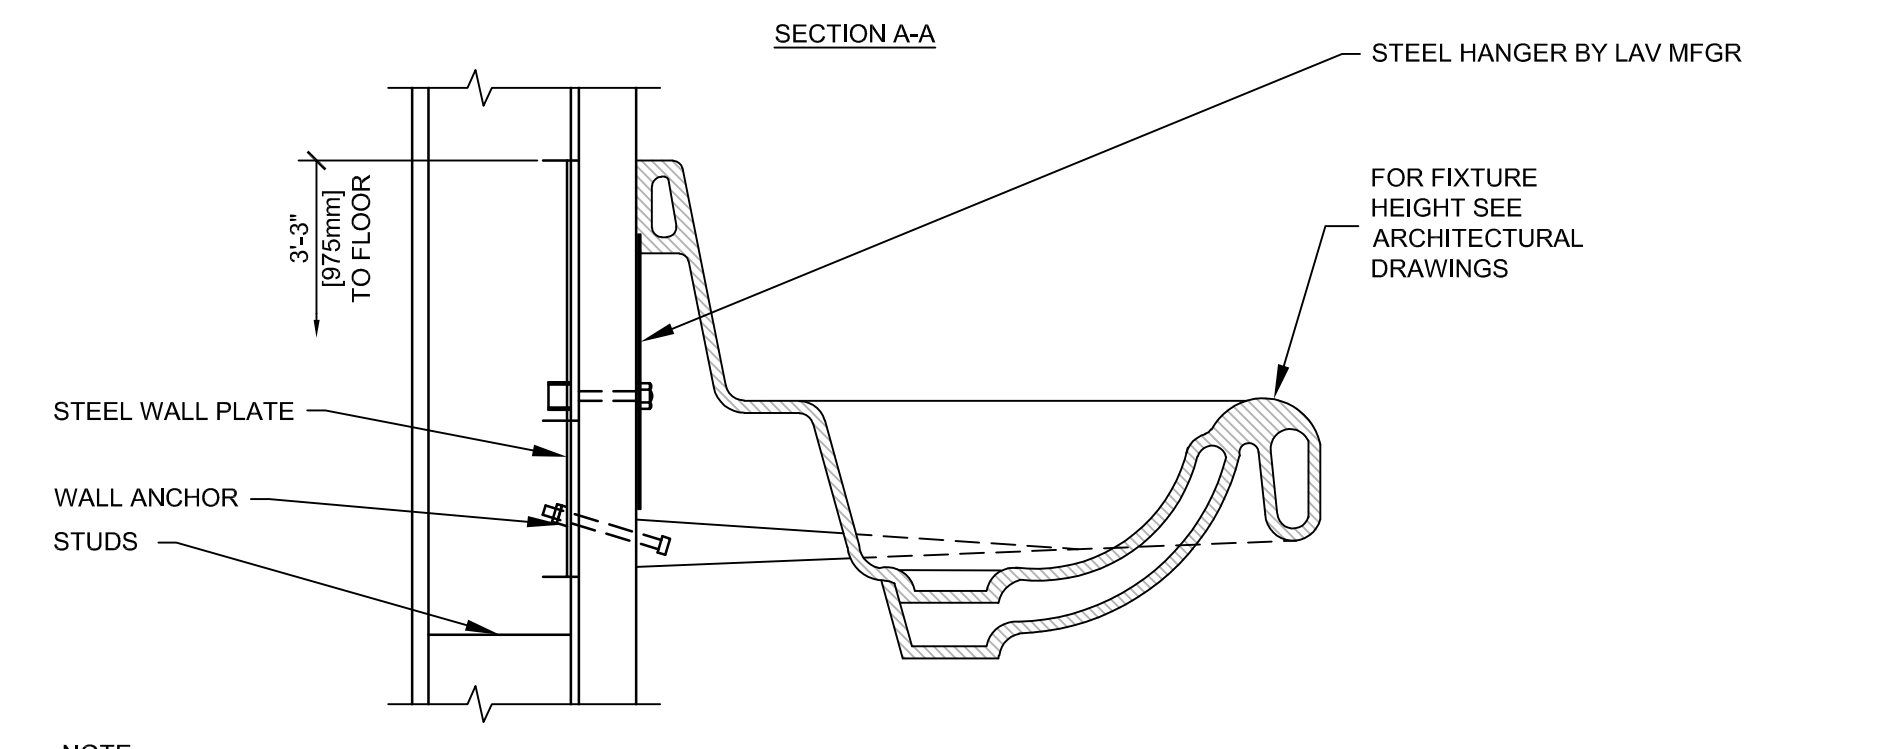


SECTION A-A

NOTE:
 1. AT LAVS WITH FOOT PEDAL CONTROLS PROVIDE AN ADDITIONAL 16 GAGE GALVANIZED STEEL PLATE 12"x16" (300x600mm) SECURED TO A MINIMUM OF 2 STUDS PER FOOT PEDAL.
 2. PROVIDE 20 GAGE STUDS WHEN HEIGHT EXCEEDS 12'-0" (3600mm)

4 LAVATORY MOUNTING DETAIL NOT TO SCALE

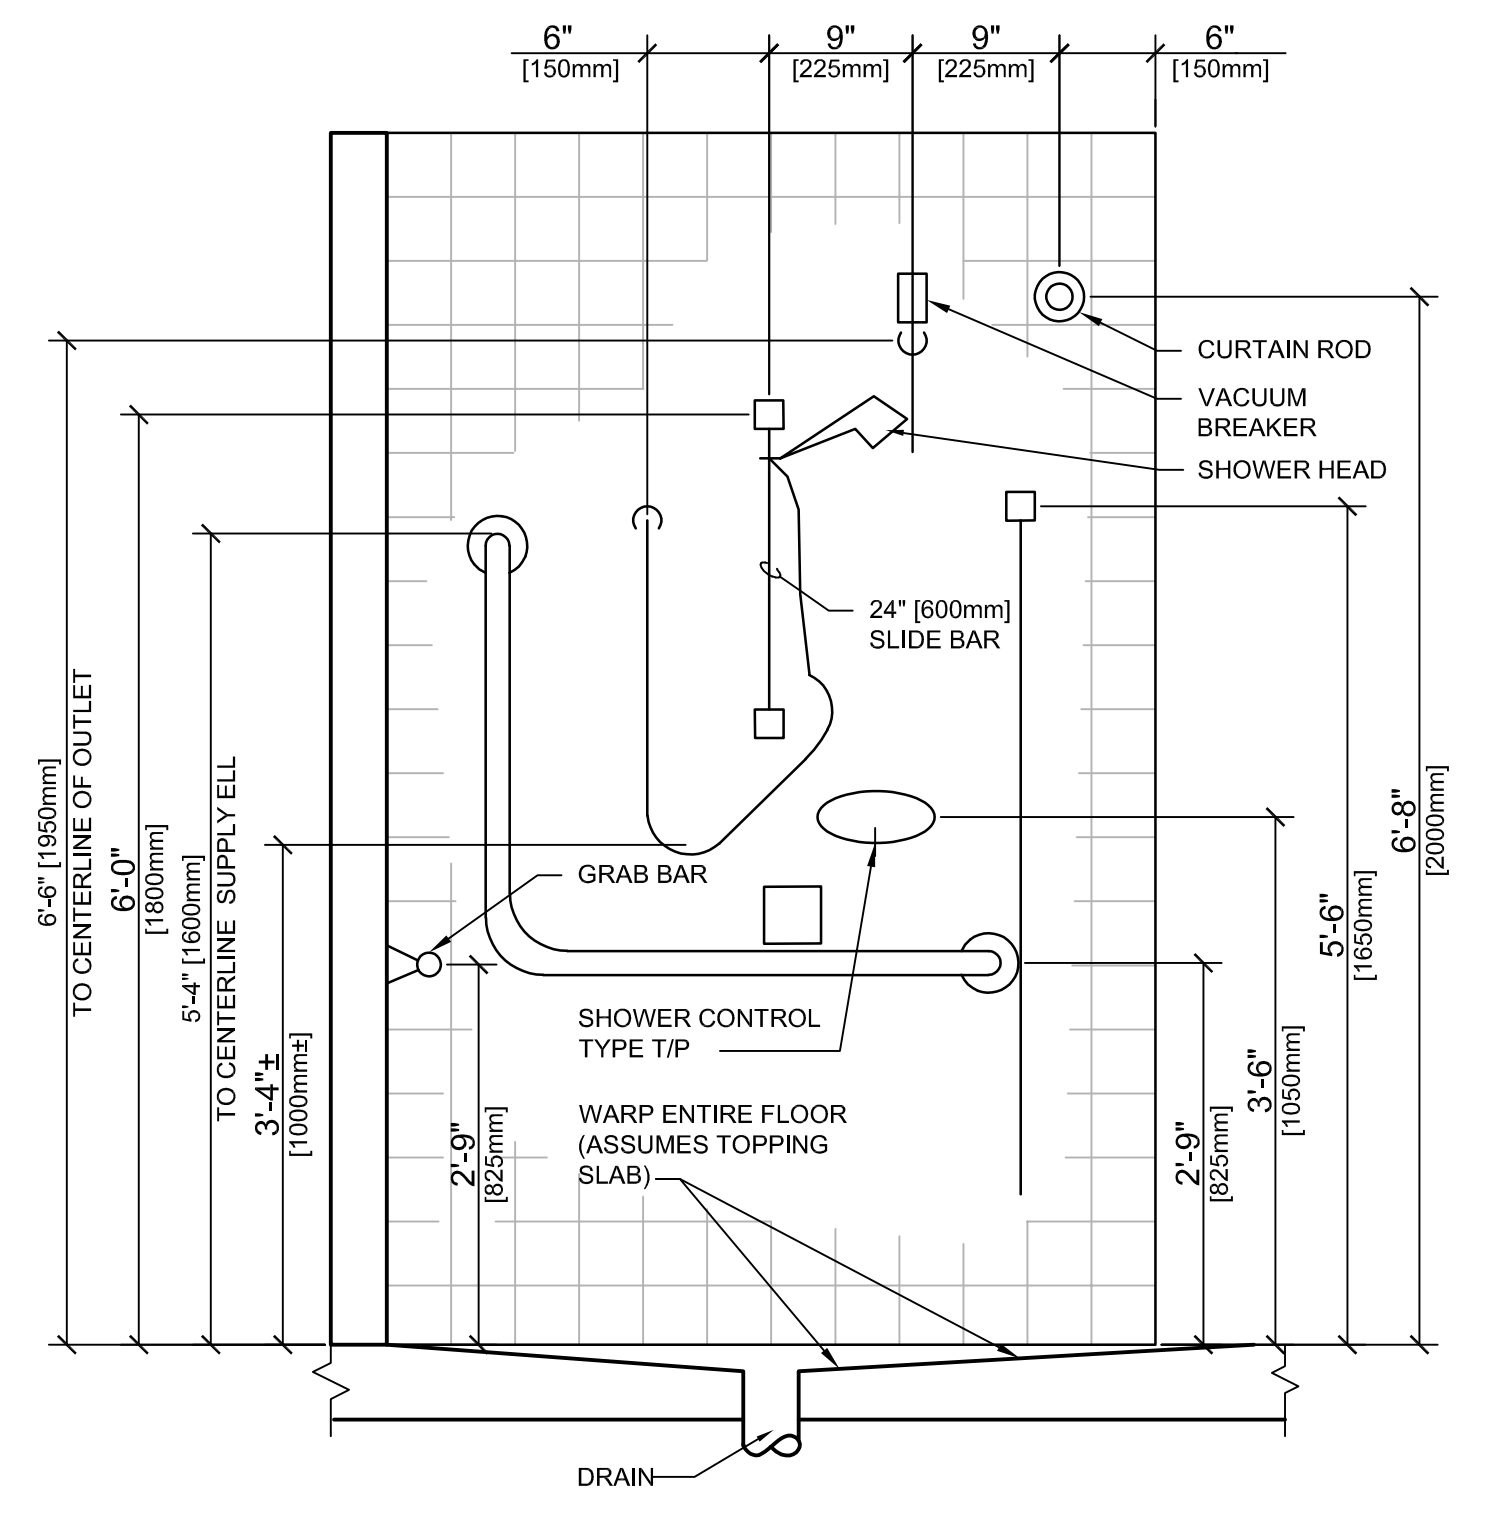


5 P-701 PATIENT SHOWER NOT TO SCALE

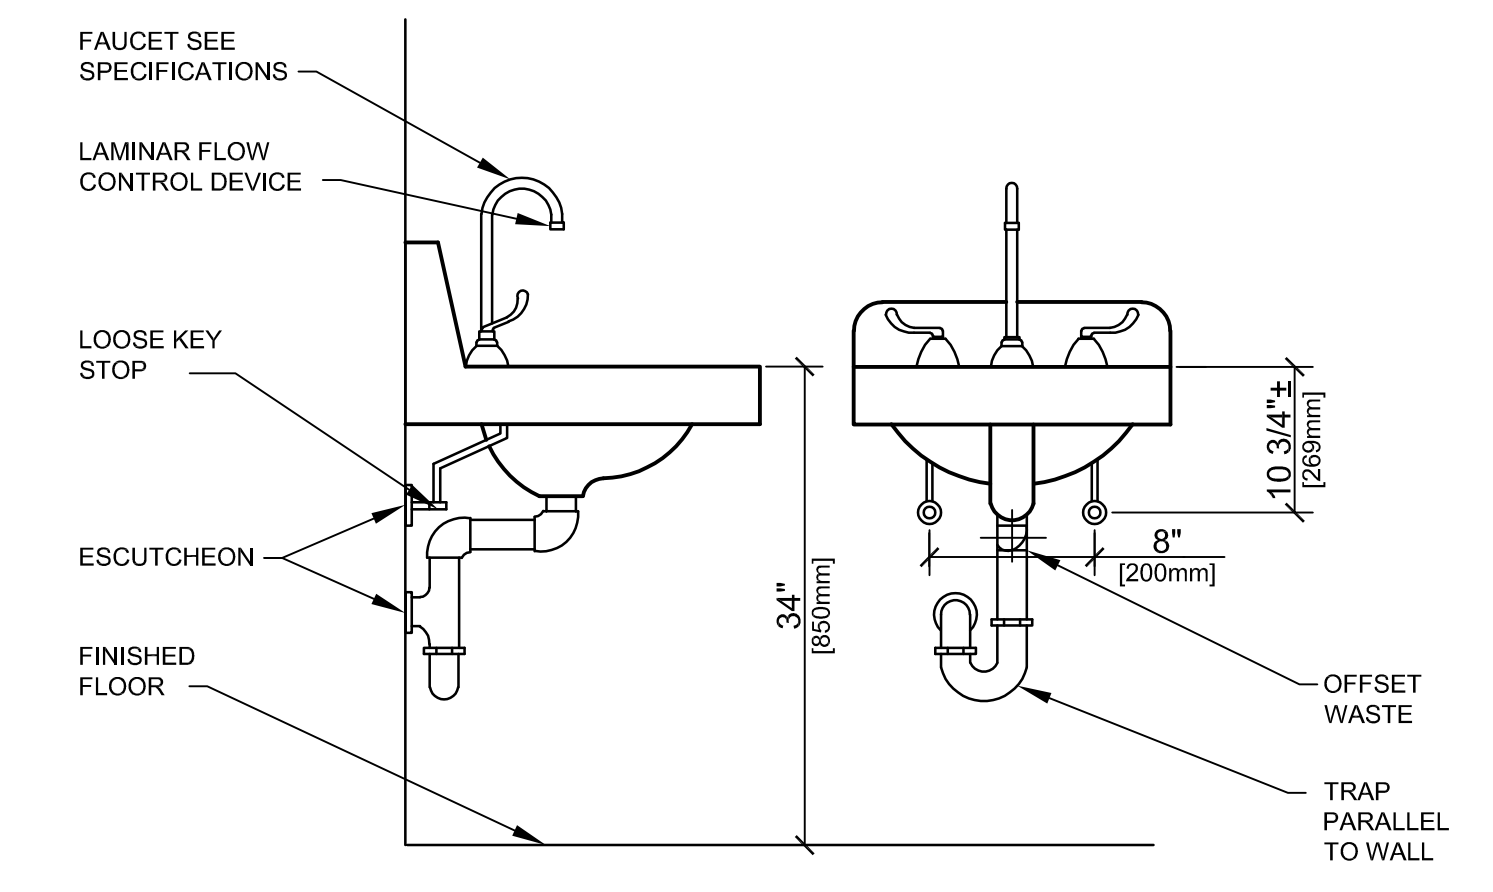


NOTE: FOR FIXTURE HEIGHTS SEE ARCHITECTURAL DRAWINGS


6 TYPICAL WHEELCHAIR LAVATORY DETAIL NOT TO SCALE

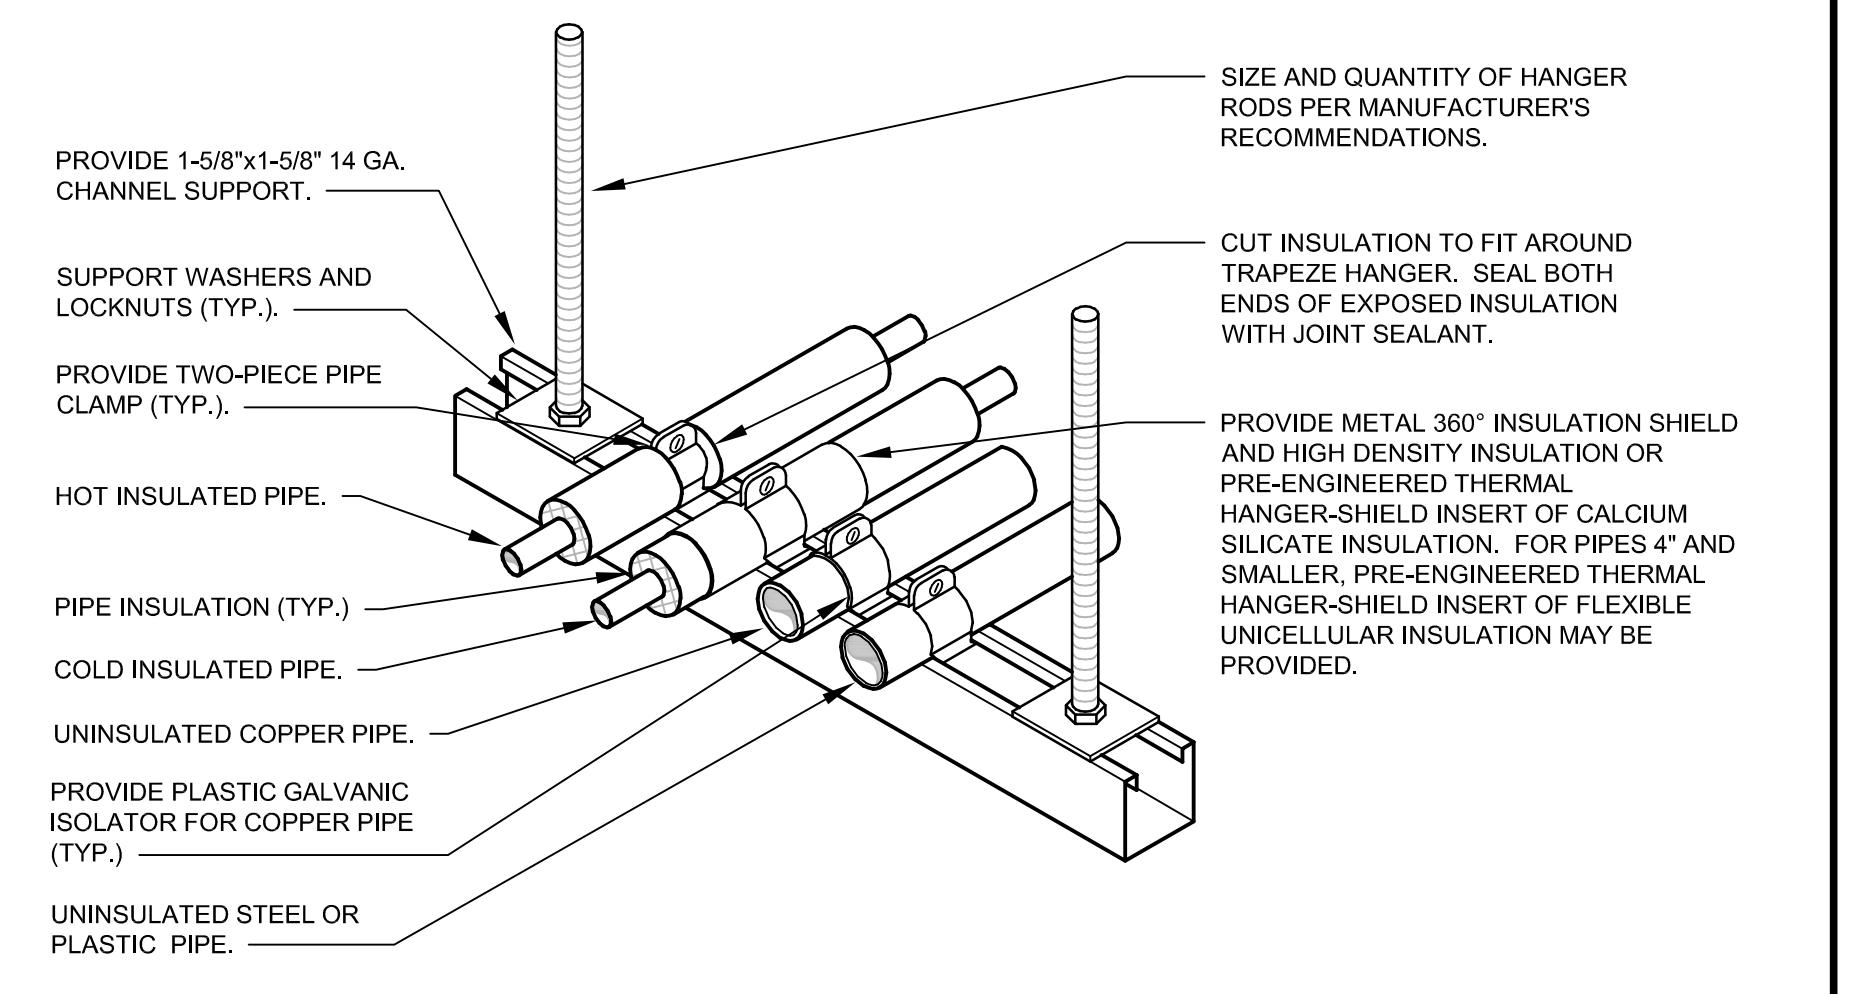

1 TRAPEZE PIPE HANGER NOT TO SCALE

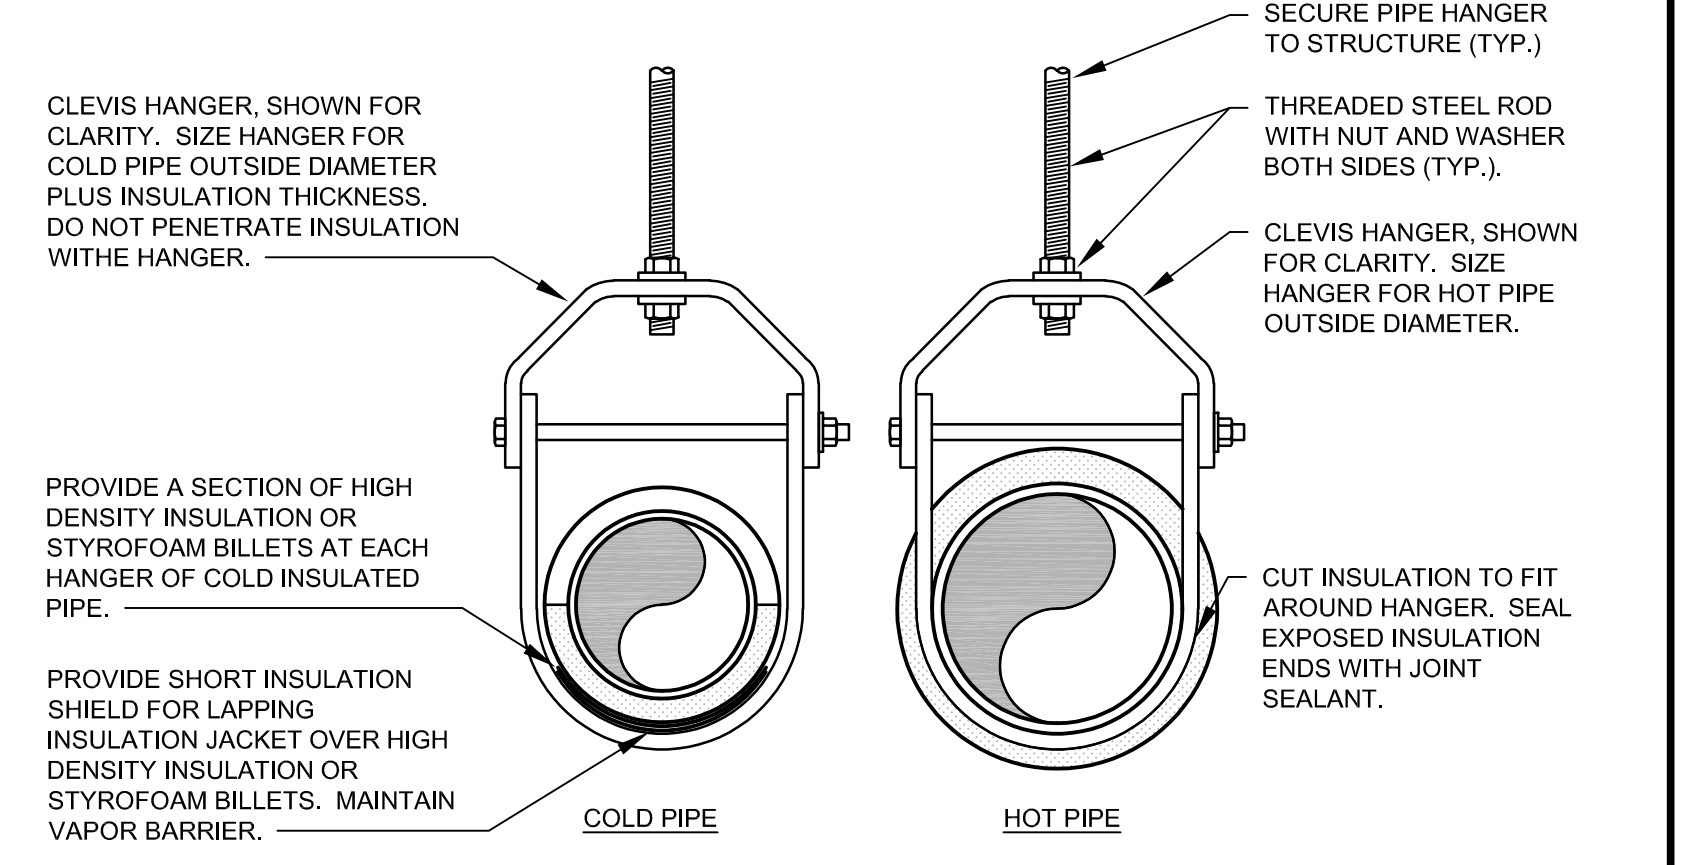

2 PIPE HANGER DETAIL NOT TO SCALE

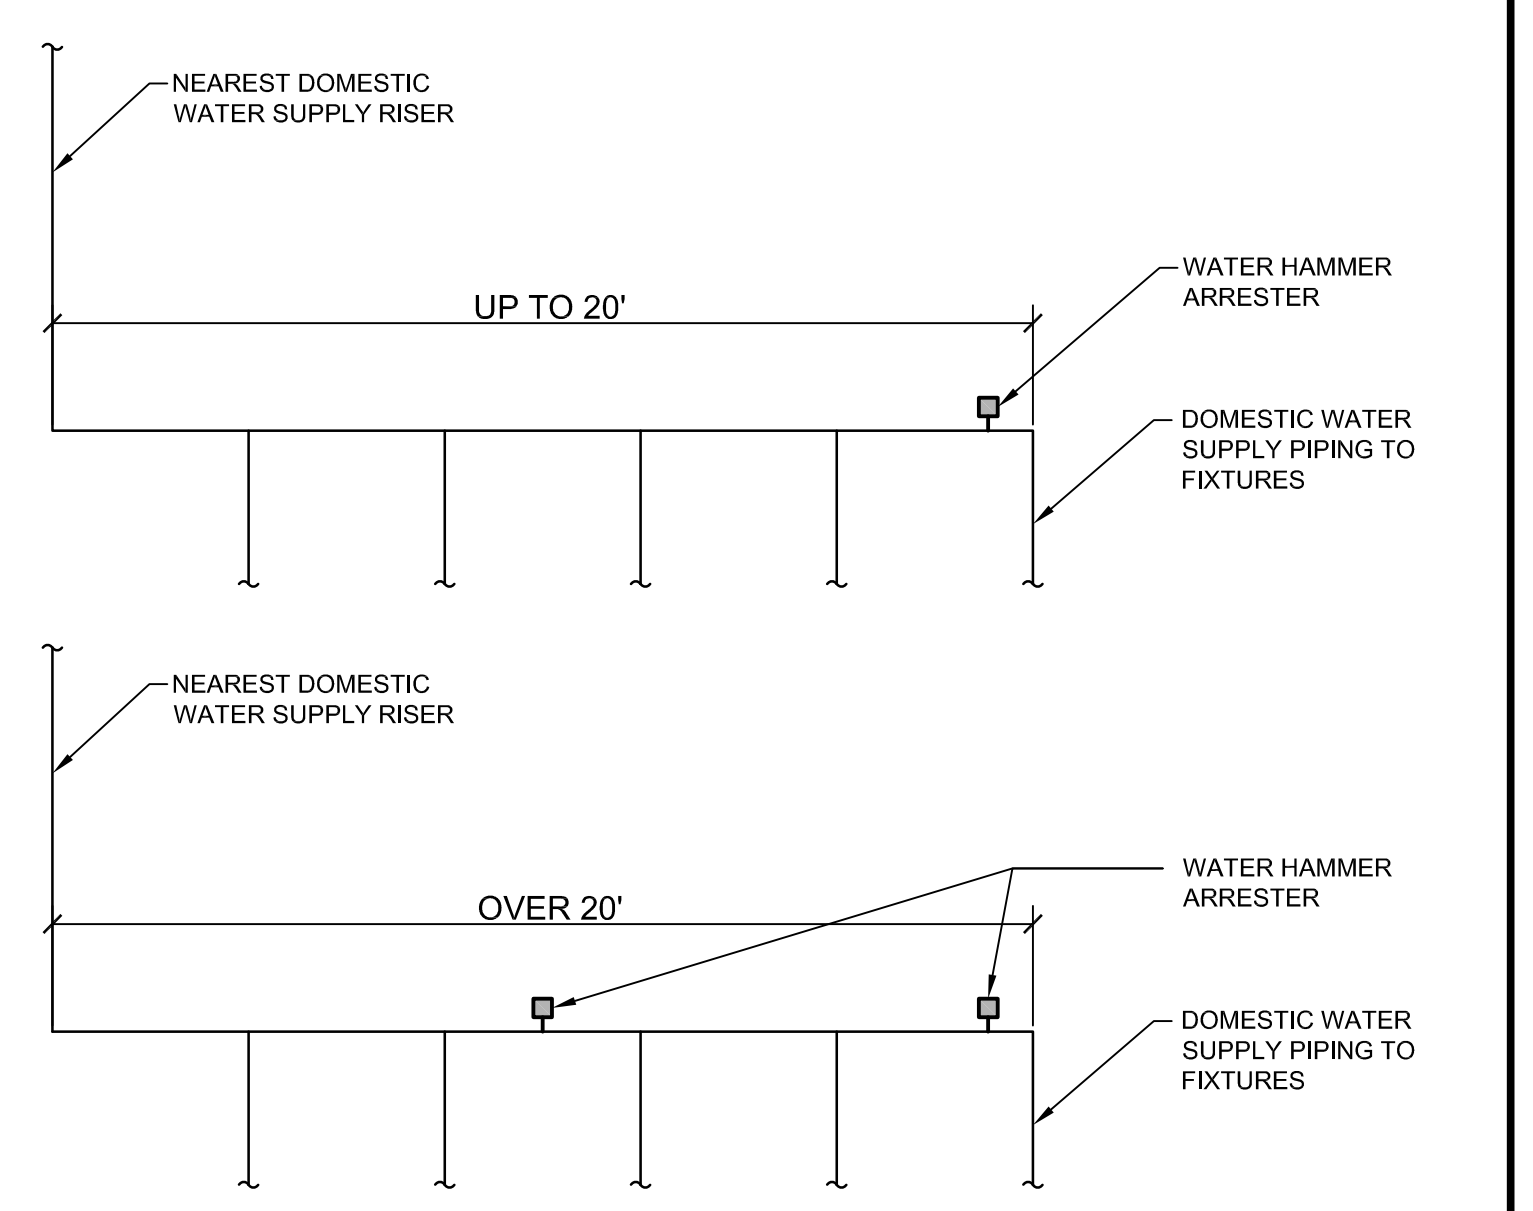

NOTE: PROVIDE ACCESS WHERE DEVICES ARE CONCEALED WITHIN PARTITIONS OR ABOVE CEILINGS. SEE SPECIFICATIONS 22 11 00 - 2.10

WATER HAMMER ARRESTOR SCHEDULE	
MARK	FIXTURE UNIT RATING
A	1 - 11
B	12 - 32
C	33 - 60
D	61 - 113
E	114 - 154
F	155 - 330

3 WATER HAMMER ARRESTOR DETAIL NOT TO SCALE

CONSULTANT INFORMATION

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 FIRE PROTECTION ENGINEER
 STAND STRUCTURAL ENGINEERING
 11827 W. 112TH STREET, SUITE 200
 OVERLAND PARK, KS 66210
 (913) 214-2169

ARCHITECT

Office of Construction and Facilities Management
 U.S. Department of Veteran Affairs

SHEET TITLE
 PLUMBING DETAILS I

APPROVED: PROJECT DIRECTOR

PROJECT PHASE
 BID DOCUMENTS

FULLY SPRINKLERED

PROJECT TITLE
 RENOVATE A & B WING BUILDING 6

PROJECT LOCATION
 2200 SW GAGE BLVD.
 TOPEKA, KS 66622

DATE
 07/10/2019

CHECKED BY
 JES

DRAWN BY
 RLC


VA PROJECT NUMBER
 589-A5-19-116

BUILDING NUMBER
 6


DRAWING NUMBER
 6-P-501

Dwg. 87 OF 160


three-quarters inch = one foot
 one-half inch = one foot
 one-quarter inch = one foot
 one-eighth inch = one foot

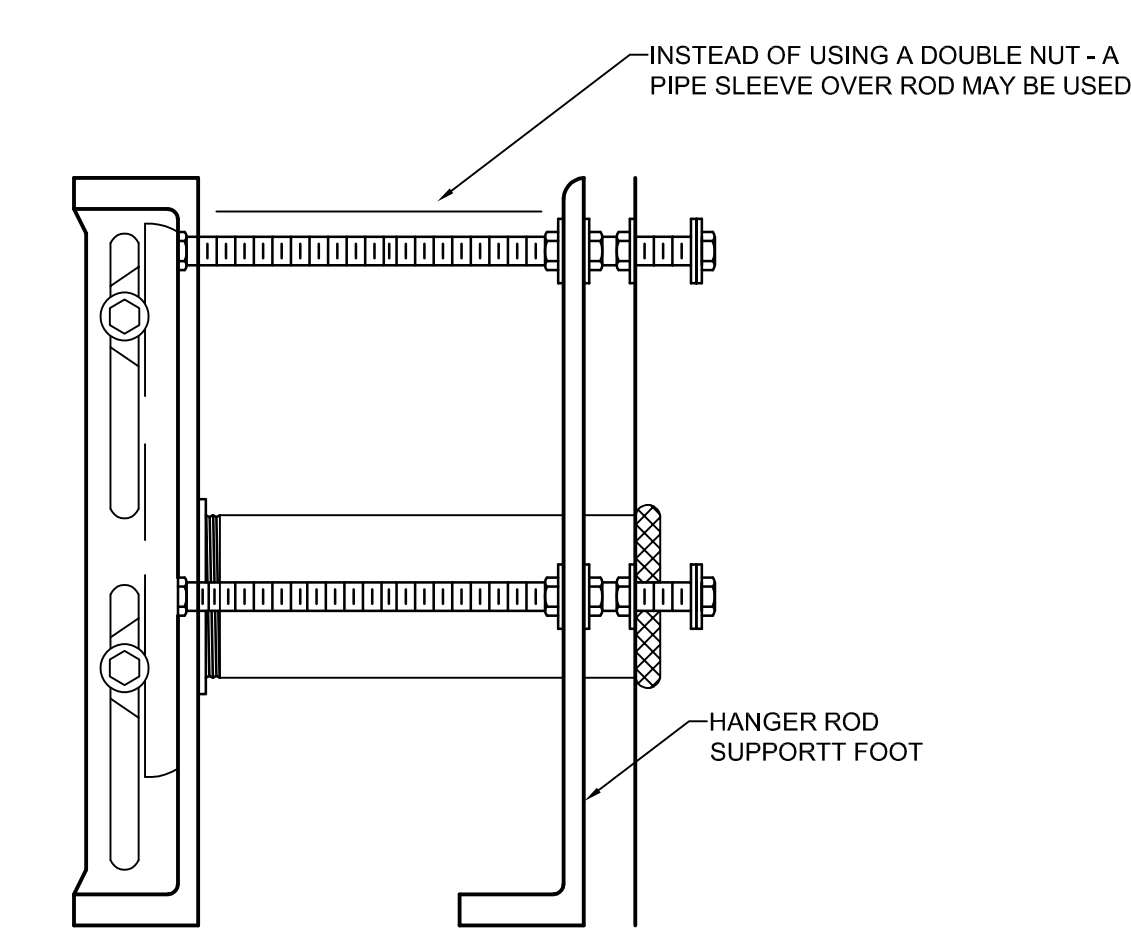

8 INSTALLATION OF HANGAR SUPPORT FOOT
NOT TO SCALE

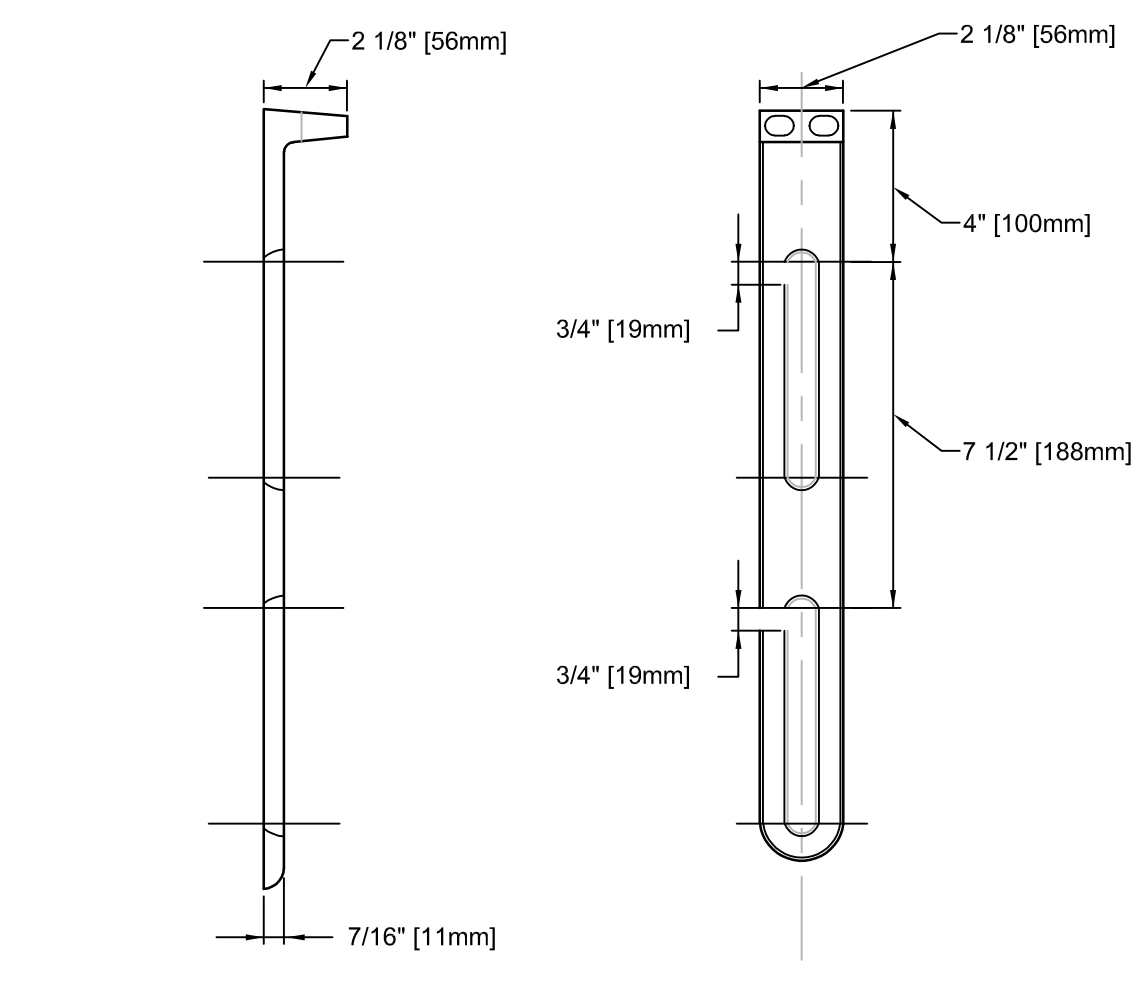


9 HANGER ROD SUPPORT FOOT
NOT TO SCALE

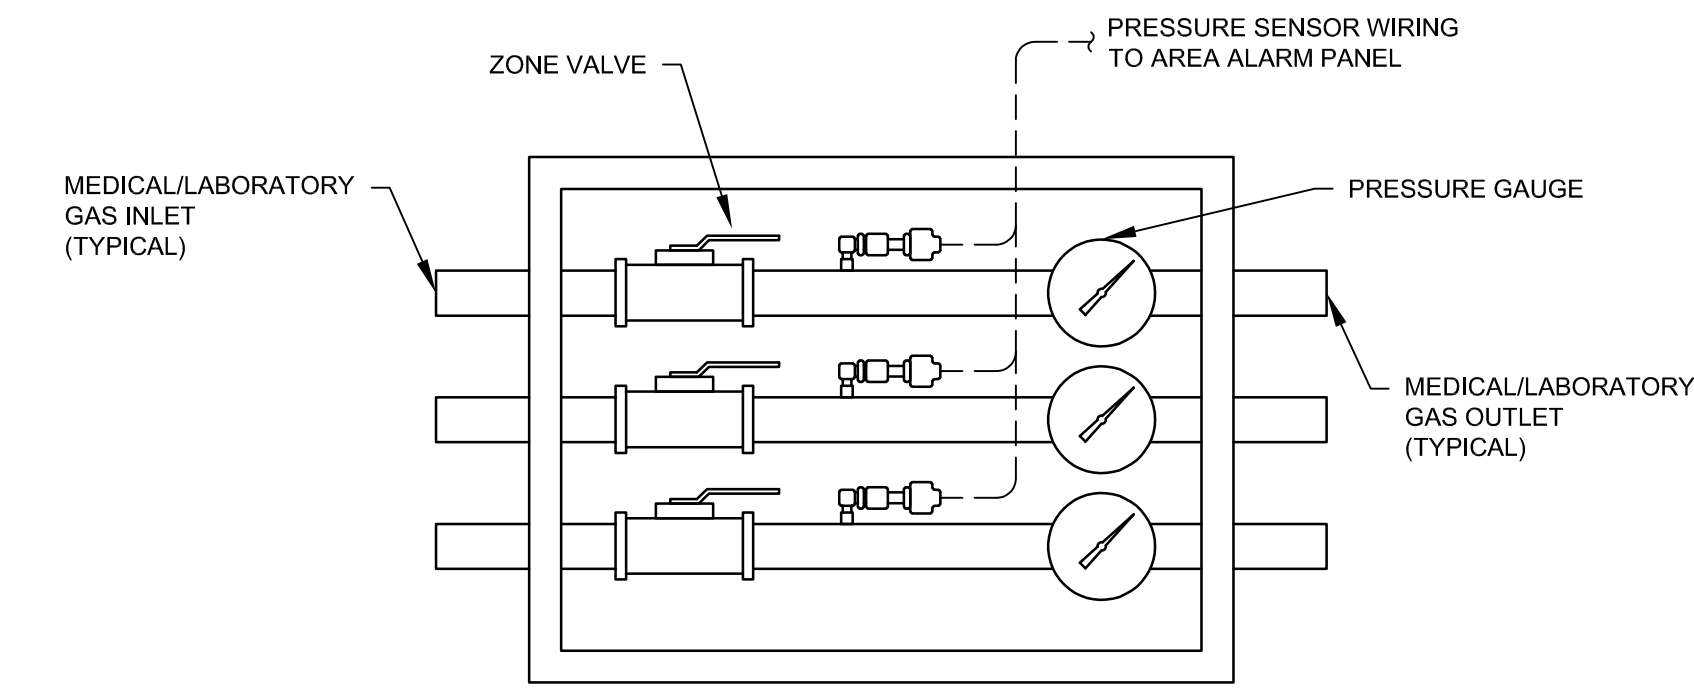


NOTE:
 1. REFER TO PLANS FOR EXACT NUMBER OF VALVES AND CONNECTIONS NEEDED.
 2. SEE M-701 FOR INFORMATION ON SENSOR WIRING TO AREA ALARM PANEL.


10 ZONE VALVE BOX
NOT TO SCALE

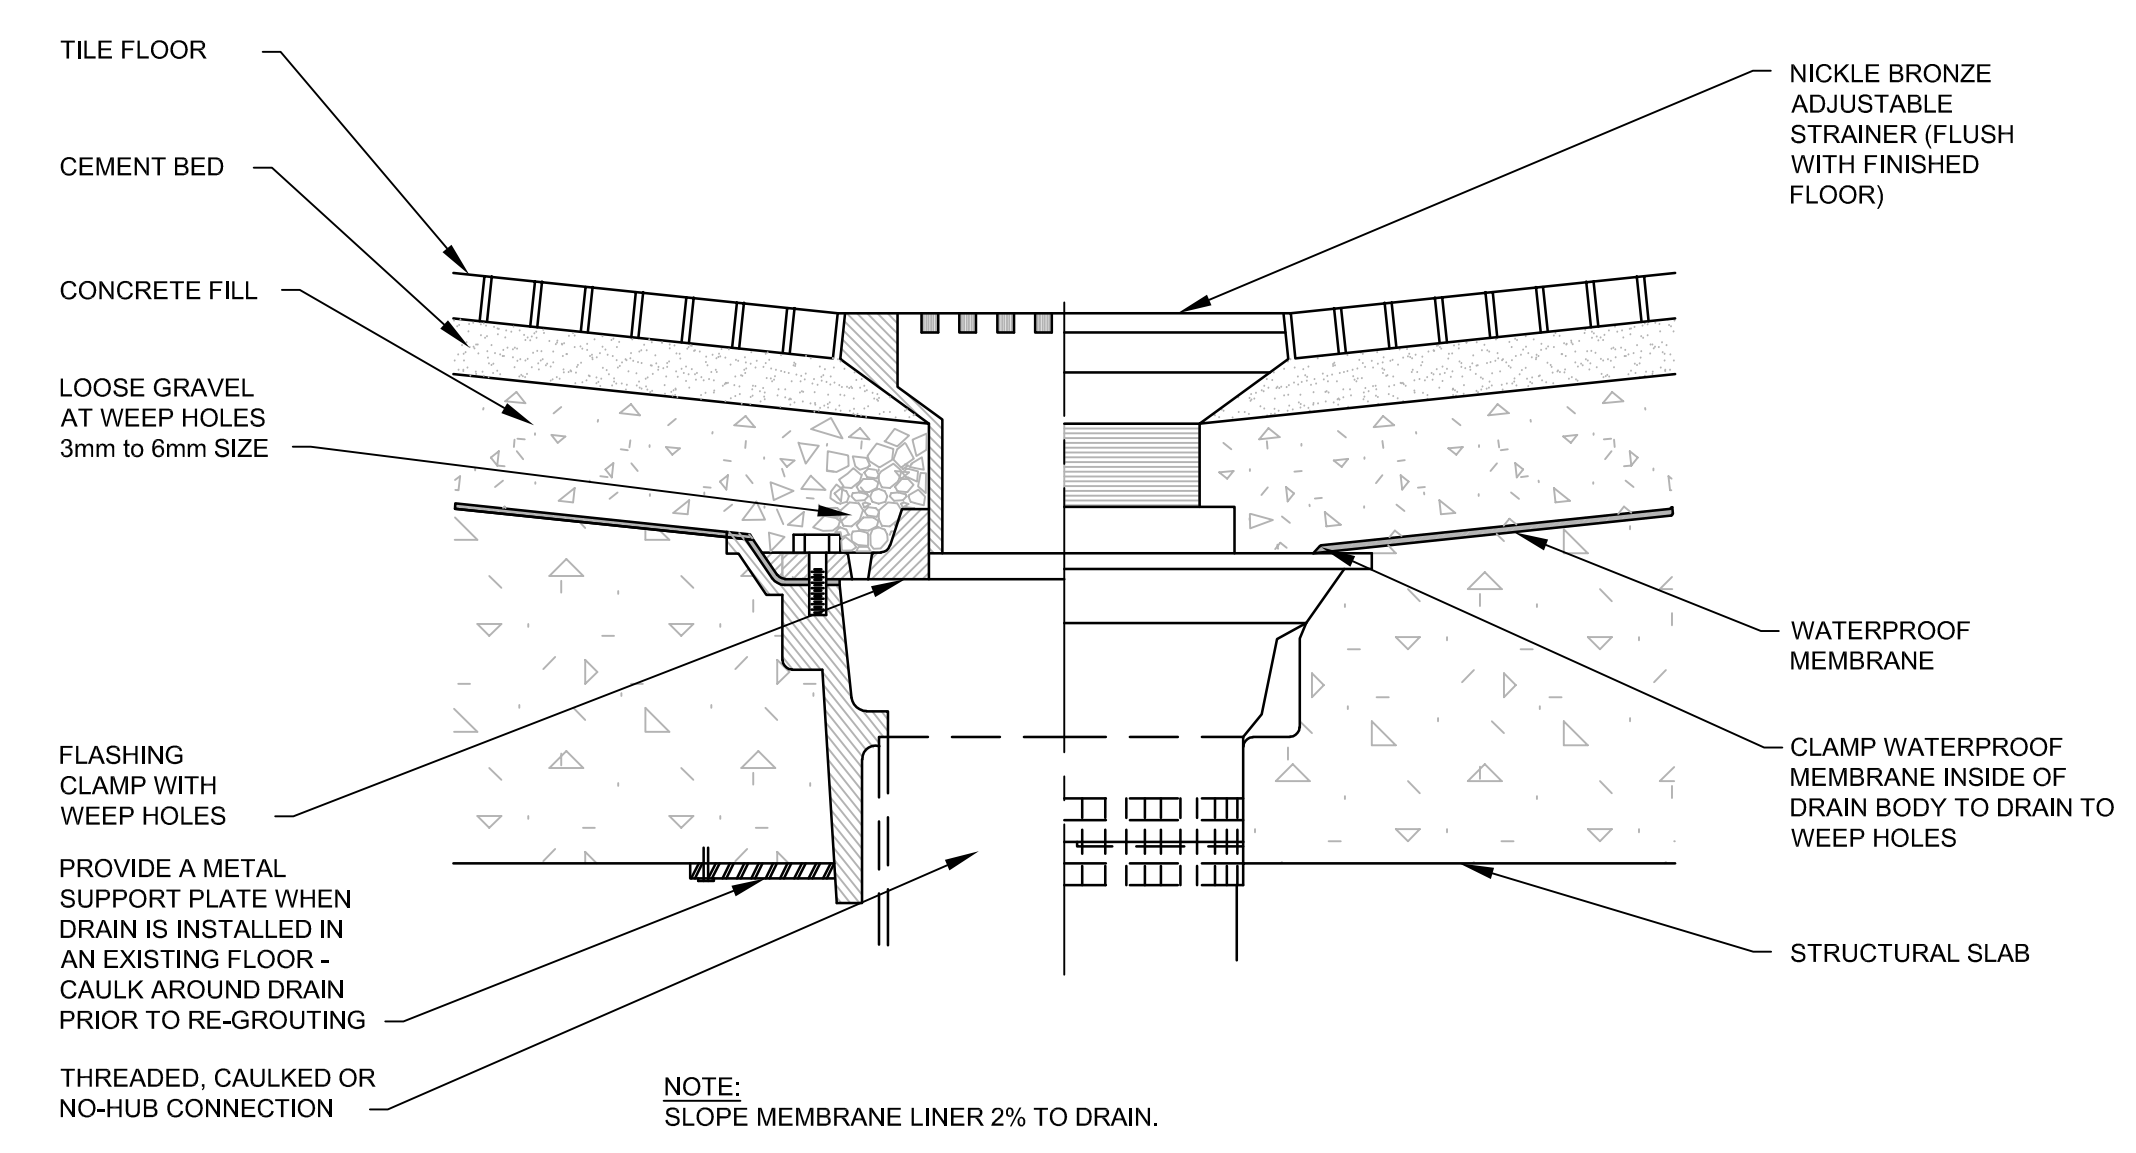


4 TYPE 'C' FLOOR DRAIN DETAIL
NOT TO SCALE

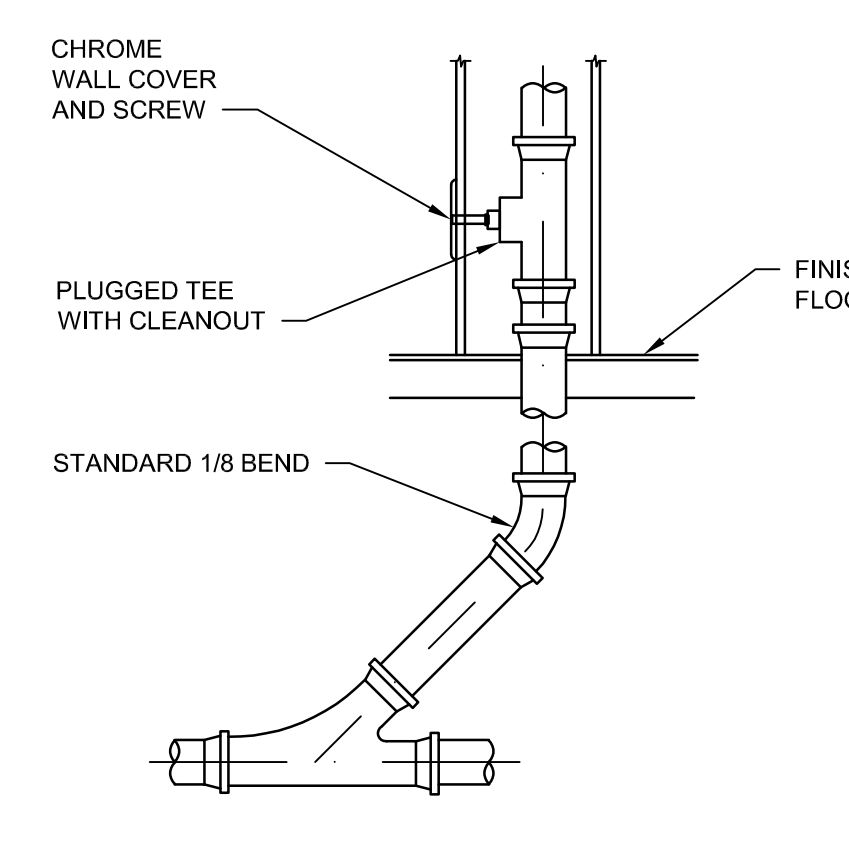

5 TYPICAL INTERIOR WALL CLEANOUT
NOT TO SCALE

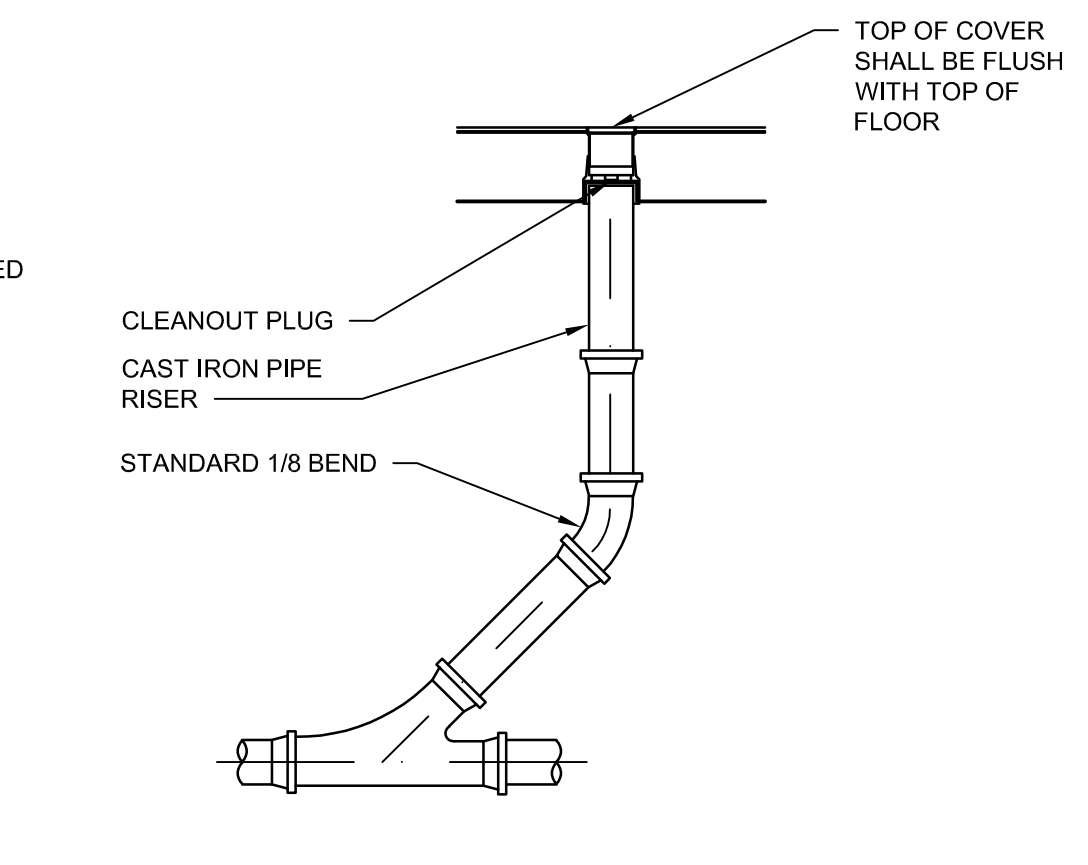


6 TYPICAL INTERIOR CLEANOUT
NOT TO SCALE

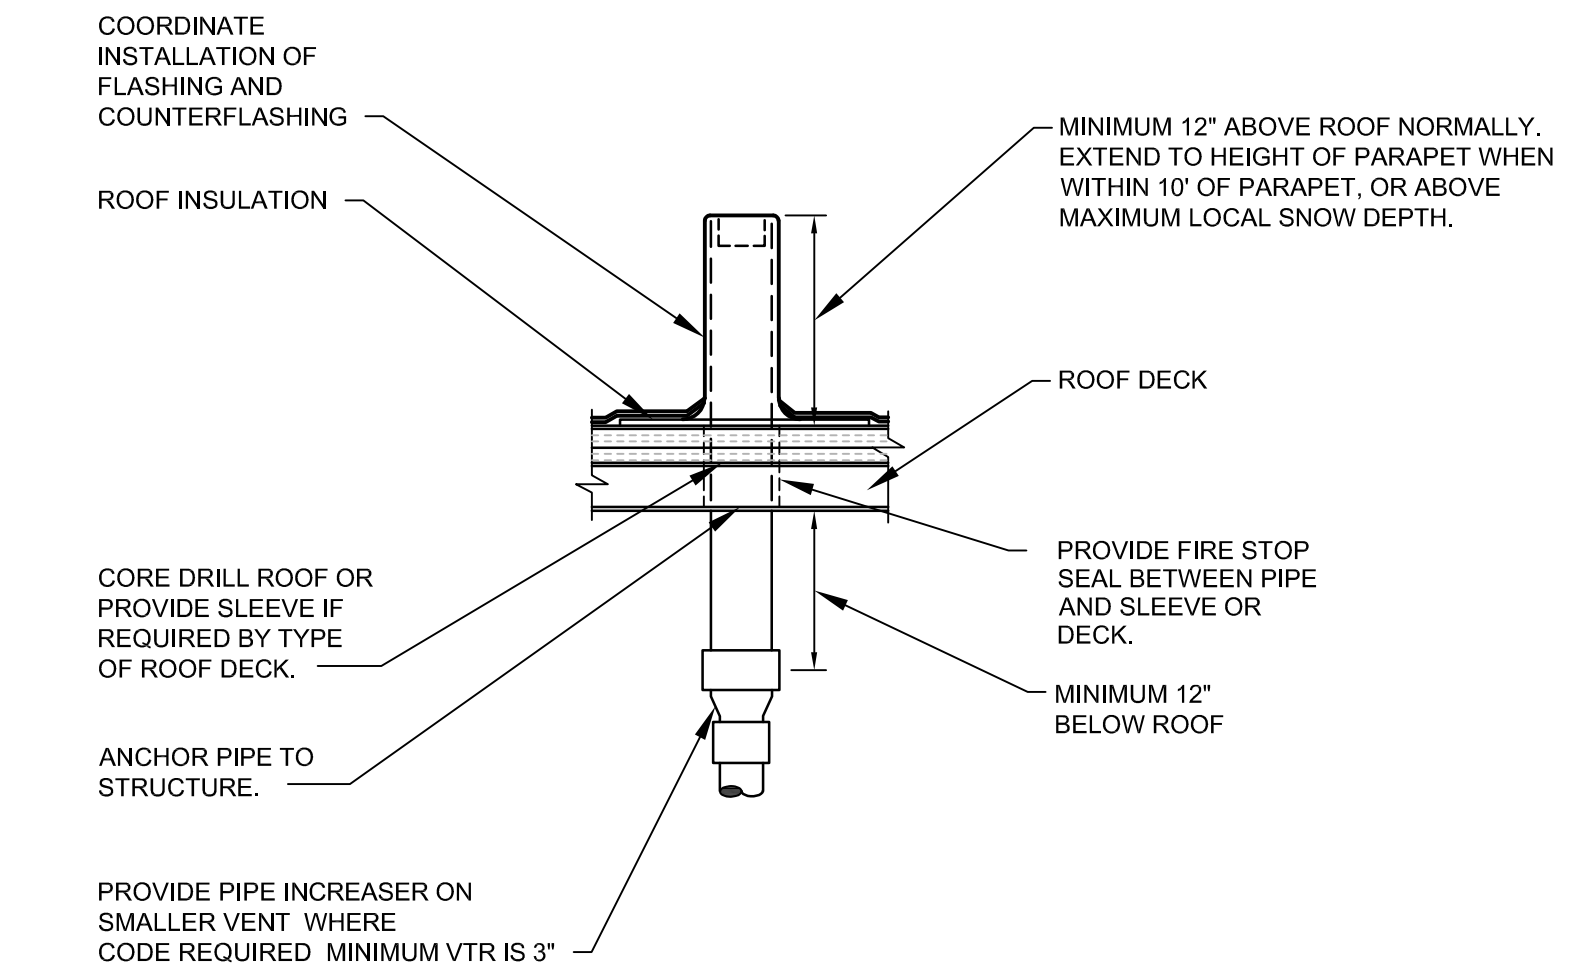


NOTE:
 1. LOCATE VTR MINIMUM 3'-0" FROM PROPERTY LINE, 10'-0" HORIZONTAL, OR 3'-0" VERTICAL ABOVE ANY BUILDING OPENING OR FRESH AIR INTAKE, 25'-0" FROM ANY OPENING OR FRESH AIR INTAKE IN MEDICAL FACILITIES AND 1'-0" FROM ANY VERTICAL SURFACE.
 2. REFER TO LOCAL CODES FOR OTHER VENT TERMINATION REQUIREMENTS.
 3. LOCATE VTR MINIMUM 18" FROM ADJACENT WALL, PARAPET, EXPANSION JOINT, ROOF DRAIN, EQUIPMENT CURB, OR OTHER ROOF FEATURE.
 4. OFFSET IN CEILING SPACE WHERE REQUIRED TO MEET THESE CONDITIONS.
 5. INSULATE LAST 6'-0" OF VENT PIPE INSIDE BUILDING PER SPECIFICATIONS.

7 VENT THROUGH ROOF DETAIL
NOT TO SCALE

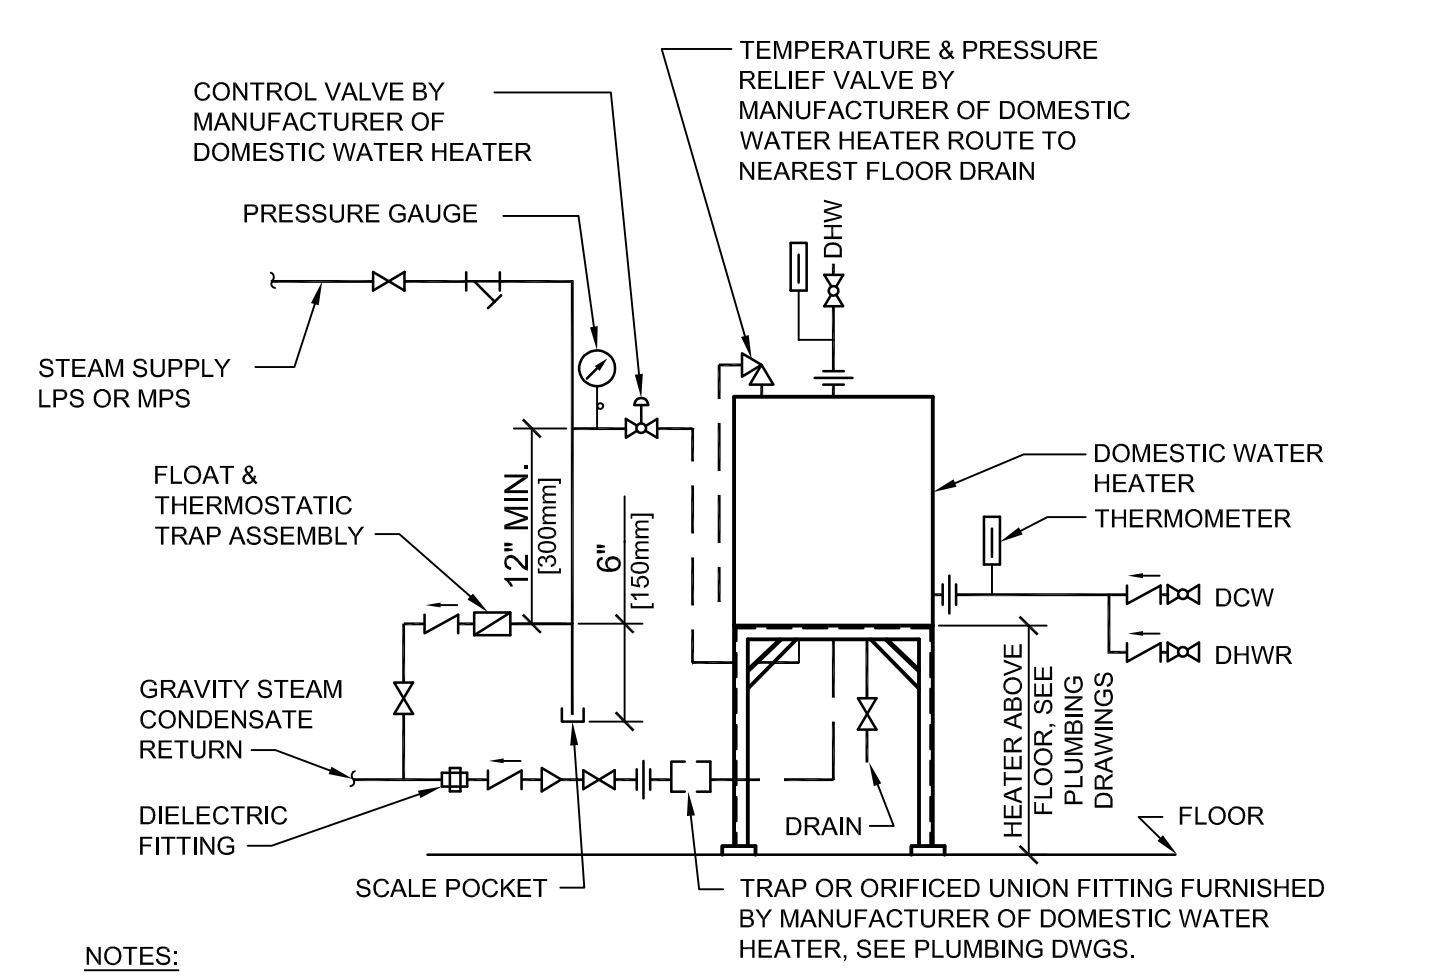


NOTES:
 1. VERTICAL COIL TYPE DOMESTIC WATER HEATER IS SHOWN. IF HORIZONTAL TUBE BUNDLE TYPE IS FURNISHED, PIPING SHALL BE SIMILAR.
 2. SEE PLUMBING DRAWINGS FOR PIPING CONNECTIONS.
 3. PIPING TO UPPER HEATER HEAD SHOULD BE PROVIDED WITH UNION OR FLANGES, LOCATED OUTSIDE THE OUTER DIAMETER OF HEAD TO FACILITATE REMOVAL OF HEAD AND SHELL.
 4. PIPING BETWEEN CONTROL VALVE AND HEATER CONNECTION SHOULD BE AS SHORT AS POSSIBLE.
 5. PROVIDE INTEGRAL OR EXTERNAL HEAT TRAPS.
 6. PROVIDE HOSE CONNECTION TO DRAIN.

1 CONNECTIONS TO DOMESTIC WATER HEATER
NOT TO SCALE

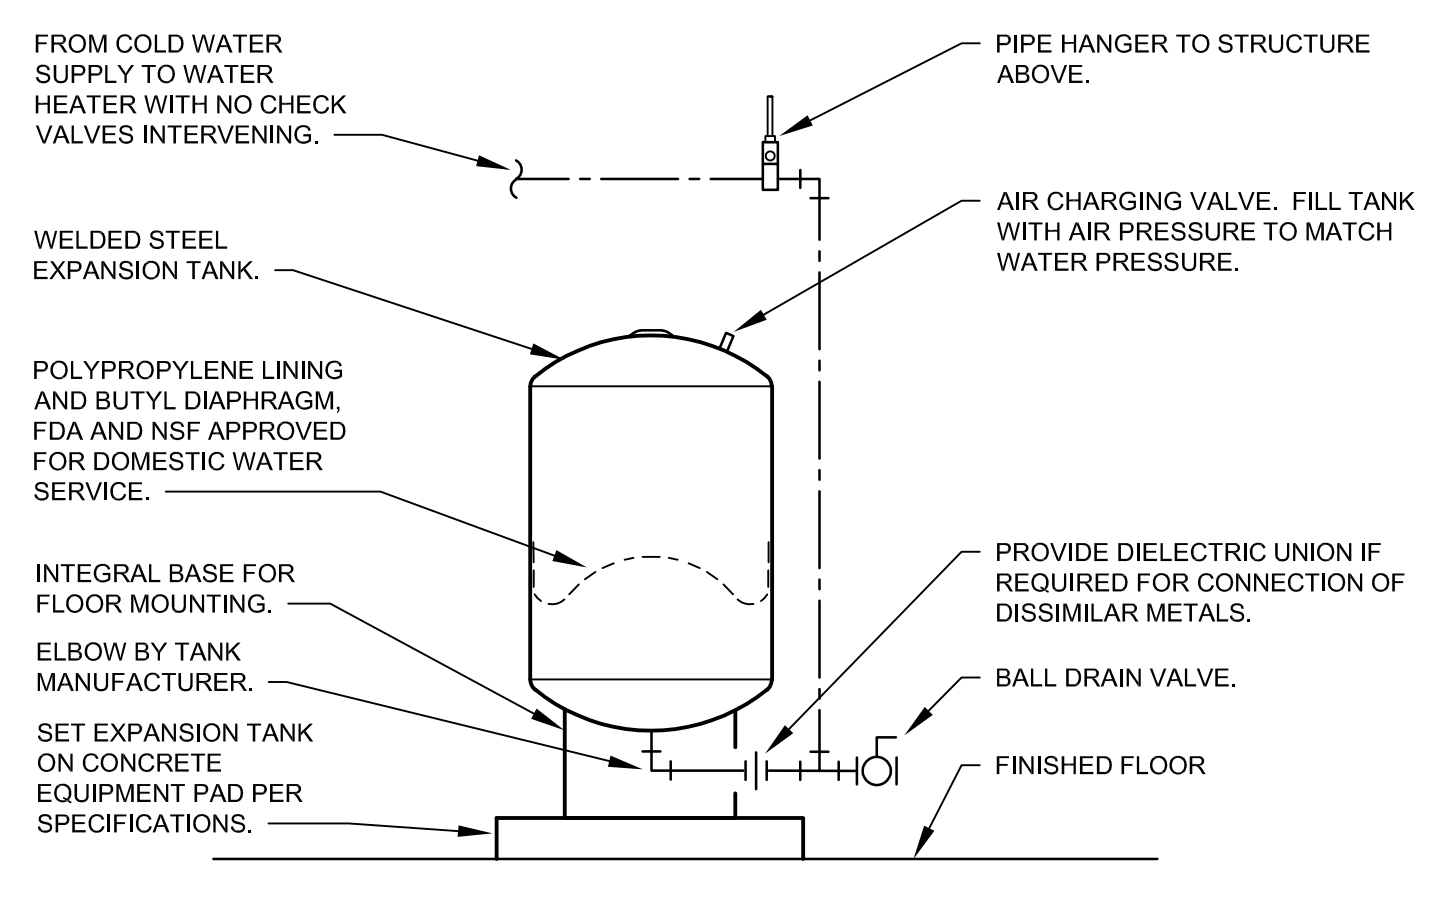

2 LARGE EXPANSION TANK
NOT TO SCALE

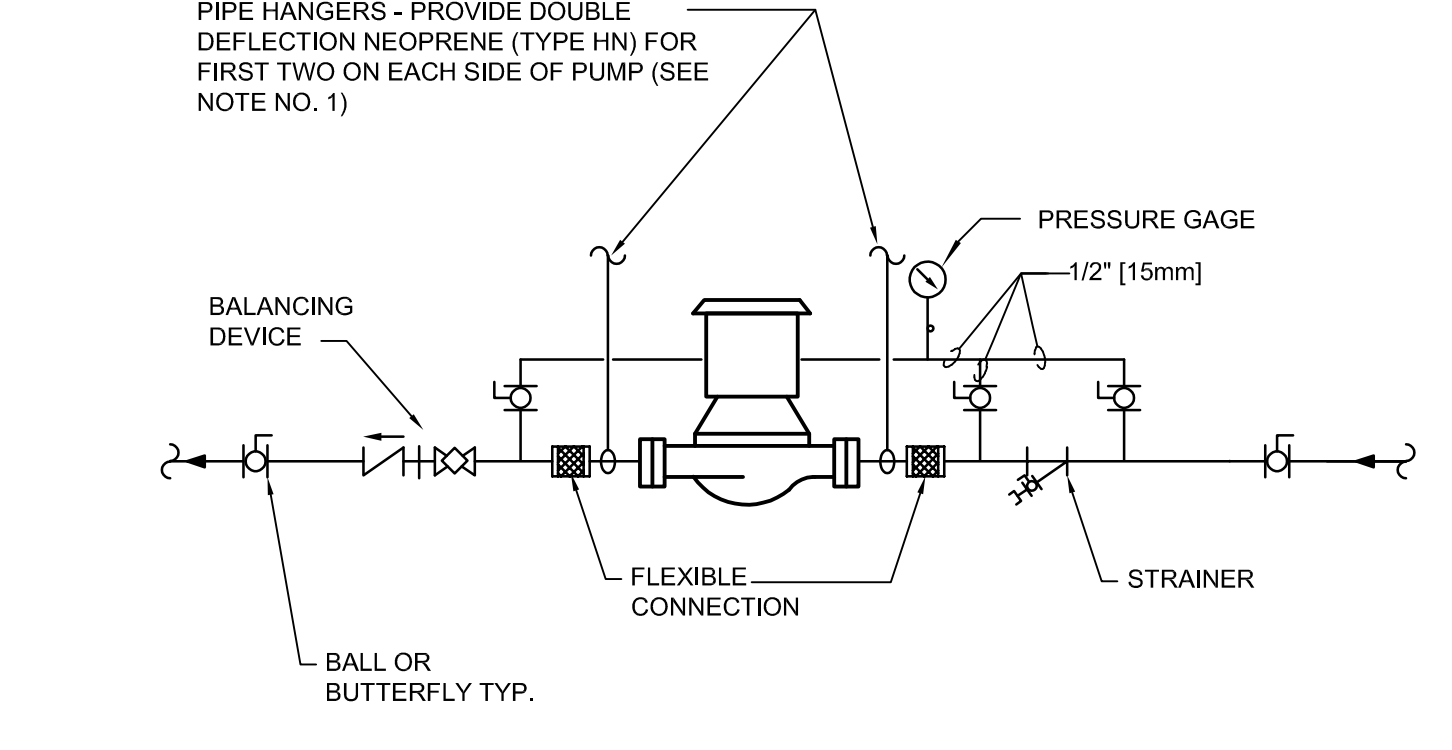

NOTES:
 1. SUPPORT PUMP FROM PIPING ONLY. DO NOT SUPPORT PUMP FROM MOTOR.

3 IN-LINE PUMPS - CONNECTIONS
NOT TO SCALE

CONSULTANT INFORMATION STRUCTURAL / CIVIL ENGINEER: STAND STRUCTURAL ENGINEERING, 11827 W. 112TH STREET, SUITE 200, OVERLAND PARK, KS 66210, (913) 214-2189 MECHANICAL / ELECTRICAL / PLUMBING / TECHNICAL ENGINEER: SPUR DESIGN, 11020 KING STREET, SUITE 350, OVERLAND PARK, KS 66210, (405) 842-6100 FIRE PROTECTION ENGINEER: POOLE FIRE PROTECTION, INC., 19910 W. 161ST STREET, OLATH, KS 66062, (913) 829-8650			ARCHITECT KS ARCH REG. NO. A-1139, EXP. 12/31/2019 KS ENGR REG. NO. E-2586, EXP. 12/31/2019		Office of Construction and Facilities Management VA U.S. Department of Veteran Affairs		SHEET TITLE: PLUMBING DETAILS II APPROVED: PROJECT DIRECTOR		PROJECT PHASE: BID DOCUMENTS FULLY SPRINKLERED		PROJECT TITLE: RENOVATE A & B WING BUILDING 6 PROJECT LOCATION: 2200 SW GAGE BLVD., TOPEKA, KS 66622 DATE: 07/10/2019 CHECKED BY: JES DRAWN BY: RLC		VA PROJECT NUMBER: 589-A5-19-116 BUILDING NUMBER: 6 DRAWING NUMBER: 6-P-502 Dwg. 88 OF 160	
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