

MECHANICAL ABBREVIATIONS

(NOTE: NOT ALL ABBREVIATIONS OR SYMBOLS MAY APPEAR ON DRAWINGS)

Table of mechanical abbreviations with columns for symbol, abbreviation, and description. Includes terms like ABANDONED, ARCHITECT, AUTOMATIC FUEL GAS SHUTOFF VALVE, etc.

PIPING SYMBOLS

Table of piping symbols with columns for symbol, description, and notes. Includes terms like DIRECTION OF PIPE PITCH (DOWN), ANCHOR, REDUCER OR INCREASER, etc.

PIPING SYMBOLS (CONTINUED)

Continuation of piping symbols table with columns for symbol, description, and notes. Includes terms like COMPRESSED AIR, BOILER BLOWOFF, BOILER WATER SAMPLE, etc.

GENERAL NOTES AND CONDITIONS

- List of general notes and conditions for the piping system, including requirements for installation, materials, and safety. Includes notes like 'THESE DRAWINGS WERE PREPARED FROM INFORMATION TAKEN FROM THE AVAILABLE BUILDING DRAWINGS...' and 'BIDDERS ARE TO VISIT THE SITE AND FAMILIARIZE THEMSELVES AS THE NATURE AND SCOPE OF THE WORK...'.

PIPING NOTES:

- Additional piping notes and specifications, including details on pipe materials, insulation, and support requirements. Includes notes like 'PIPING MUST BE IN ACCORDANCE WITH SPECIFICATION 23 21 11-BOILER PLANT PIPING SYSTEMS' and 'INSTALL ALL STEAM PIPING WITH A MINIMUM SLOPE OF 1/4" PER 10 FEET...'.

DRAWING SYMBOLS

Table of drawing symbols with columns for symbol, description, and notes. Includes terms like KEY NOTE SYMBOL, MULTIPLE KEY NOTES APPLYING TO THE SAME ITEM, etc.

SUPPORTS FOR PIPING, BOILER STACKS & BREECHING SYMBOLS AND ABBREVIATIONS

Table of support symbols with columns for symbol, description, and notes. Includes terms like ROLLER-TYPE HANGER, VARIABLE SPRING-TYPE HANGER, etc.

Table with columns for NO., DESCRIPTION, and DATE. Includes a note: 'PRINTS OF THIS DRAWING SHALL NOT BE USED FOR ANY PURPOSE WHATSOEVER WITHOUT THE SEAL AND SIGNATURE OF THE PROFESSIONAL ENGINEER.'

Table of consultants with columns for name, address, phone, and services. Includes 'HAZARDOUS MATERIALS MABBETT & ASSOCIATES, INC.', 'FIRE SUPPRESSION KOFFEL ASSOCIATES', and 'ELECTRONIC SECURITY MAGNA ENGINEERS'.

Logo and contact information for Miller-Remick LLC, Professional Engineer. Includes address: 1010 KINGS HIGHWAY NORTH, CHERRY HILL, NEW JERSEY 08034.

Logo and contact information for Office of Construction and Facilities Management, U.S. Department of Veterans Affairs. Includes address: 6010 W. 11th Street, Suite 100, Phoenix, AZ 85043.

Table with columns for Drawing Title, Phase, and Approved. Includes 'MECHANICAL ABBREVIATIONS & SYMBOLS', '100% BID SET', and 'Approved: Project Director'.

Table with columns for Project Title, Location, Issue Date, Checked, Drawn, and Drawing Number. Includes 'INSTALL NEW BOILERS IN BUILDING 13', 'ROBERT J. DOLE VA MEDICAL CENTER WICHITA, KANSAS', and 'M-001'.



Table with columns for Issue Date, Checked, Drawn, and Drawing Number. Includes '2021-09-03', 'JJM', 'GDS', and 'M-001'.

**GENERAL SHEET NOTES:**

1. REFER TO DRAWING M-001 FOR SYMBOLS, ABBREVIATIONS AND GENERAL AND DEMOLITION NOTES.
2. REFER TO MECHANICAL PLANS AND FLOW DIAGRAMS FOR FURTHER DETAILS.
3. CONTRACTOR SHALL FIELD VERIFY EXISTING CONDITIONS PRIOR TO PERFORMING ANY WORK.
4. CONTRACTOR SHALL SUBMIT A DETAILED LOCKOUT/TAGOUT PROCEDURE TO THE VA A MINIMUM OF 4 WORKING DAYS PRIOR TO PERFORMING ANY WORK ON ANY LIVE STEAM OR CONDENSATE SYSTEM.
5. ALL WORK REQUIRING SHUT-DOWNS SHALL BE COORDINATED WITH THE VA COR. ALL NEW EQUIPMENT/MATERIAL REQUIRED TO BRING THE SYSTEM FULLY BACK ON-LINE MUST BE ON-SITE READY FOR INSTALLATION. CONTRACTOR SHALL SUBMIT TO THE VA COR FOR APPROVAL - METHOD OF PROCEDURE (MOP) FOR SHUT-DOWN MINIMUM OF 4 WEEKS PRIOR TO SCHEDULED SHUT-DOWN. CONTRACTOR SHALL FULLY STAFF THE WORK 24/7 UNTIL ALL SYSTEMS ARE RESTORED TO FULL OPERATION.

**CONSTRUCTION PHASING/SHEET NOTES:**

- RELOCATION OF EXISTING STEAM UTILITY TUNNEL**
1. THE EXISTING STEAM UTILITY TUNNEL TO THE NORTH OF EXISTING BUILDING 13 SHALL BE REMOVED FROM THE EXISTING BUILDING 13 WALL TO POINT INDICATED ON DRAWING MS102. PIPING TO BE ISOLATED AND REMOVED. CONTRACTOR SHALL FIELD VERIFY LOCATIONS OF STEAM ISOLATION VALVES PRIOR TO STARTING ANY WORK. REFER TO GENERAL NOTES FOR ADDITIONAL DETAILS. REFER TO CIVIL DRAWINGS FOR ADDITIONAL DETAILS.
  2. NEW PRECAST CONCRETE PIPE TRENCH. REFER DRAWING MS102 AND CIVIL PLANS FOR ADDITIONAL INFORMATION.
  3. INSTALL NEW 5" HPS AND 3" CONDENSATE RETURN PIPING FROM NEW MANHOLE 13 TO NEW BASEMENT PUMP ROOM IN NEW BOILER PLANT (BUILDING 13 ADDITION). REFER TO DRAWING MP101.02 FOR CONTINUATION.
  4. NEW CONCRETE CAST-IN-PLACE STEAM MANHOLE. REFER DRAWING MS102 FOR ADDITIONAL DETAILS.
- EXISTING UNDERGROUND STORAGE TANKS**
5. CONTRACTOR SHALL REMOVE THE EXISTING FUEL-OIL FROM UNDERGROUND STORAGE TANKS (ONE AT A TIME), CLEAN THE TANK AND REFILL WITH FRESH FUEL OIL. THE CONTRACTOR IS RESPONSIBLE FOR RECYCLING/DISPOSAL OF THE OLD FUEL OIL.

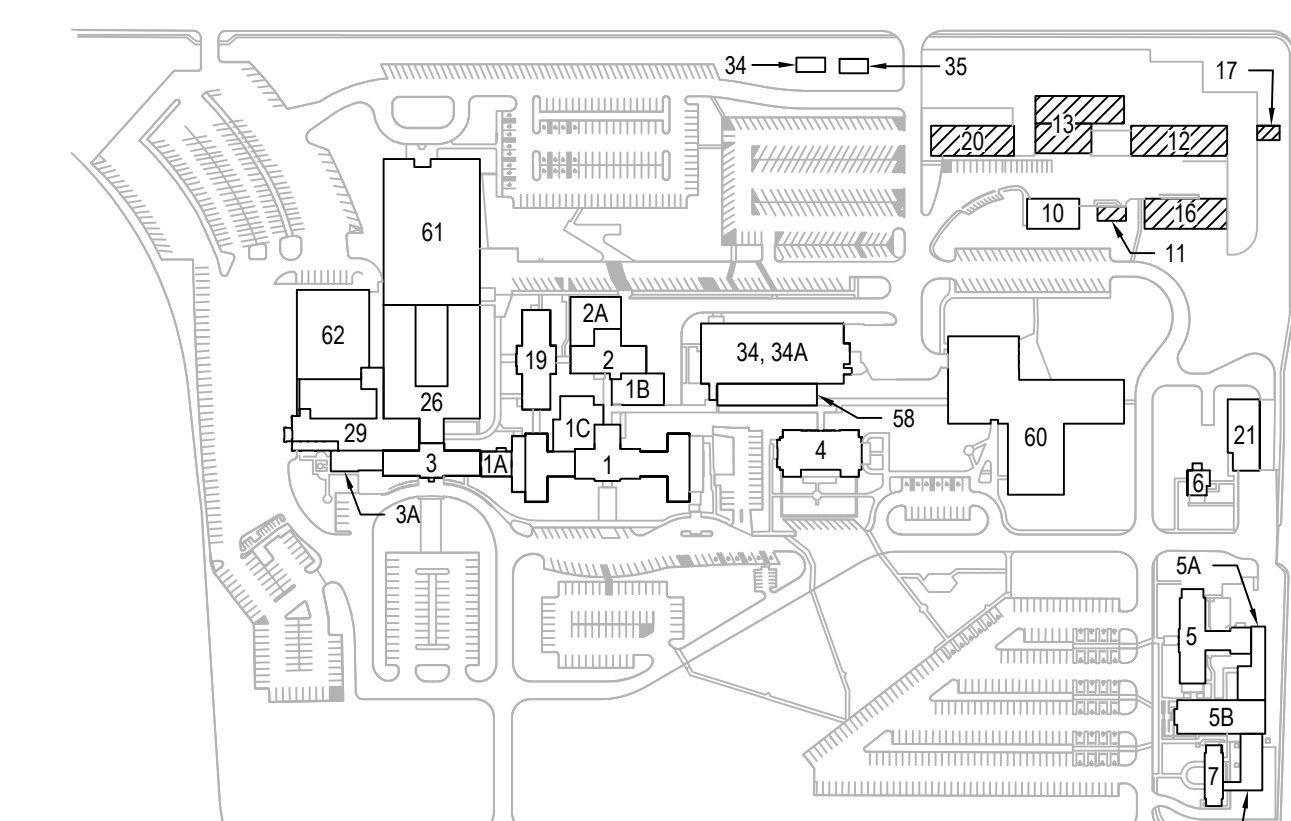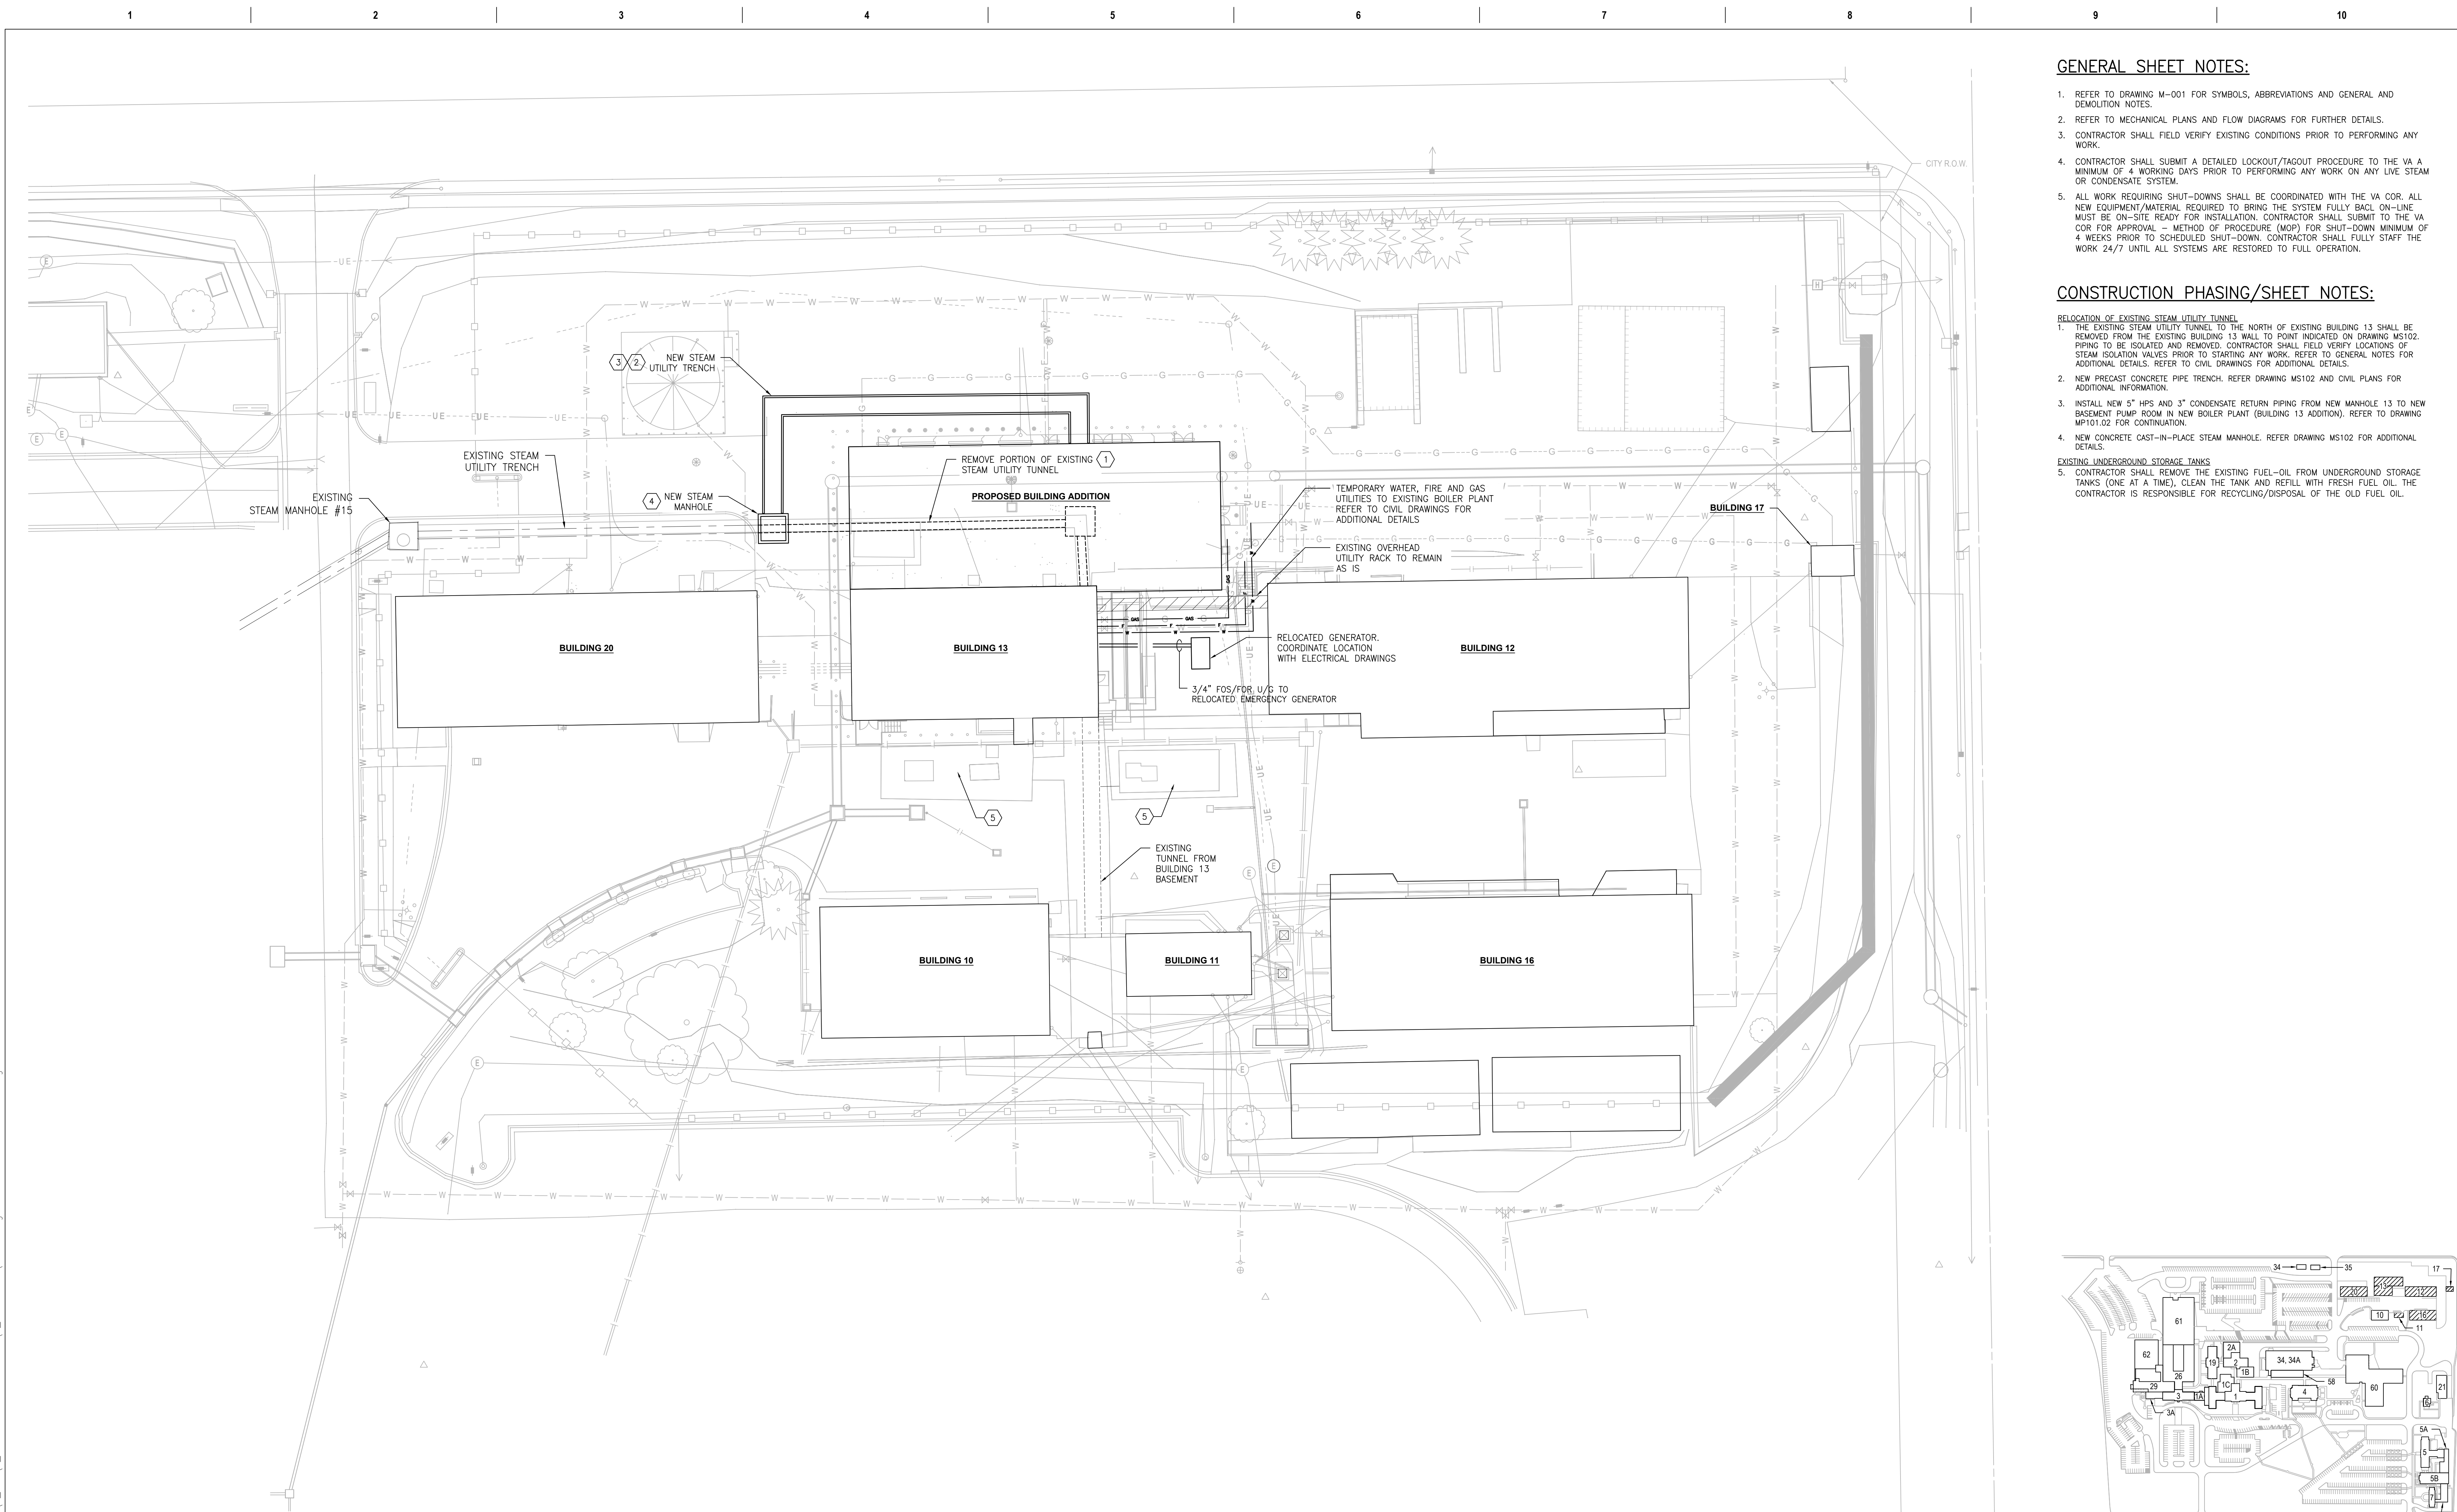

**1 SITE PLAN**  
SCALE: 1" = 20'-0"

PRINTS OF THIS DRAWING SHALL NOT BE USED FOR ANY PURPOSE WHATSOEVER WITHOUT THE SEAL AND SIGNATURE OF THE PROFESSIONAL ENGINEER.

NO.	DESCRIPTION	DATE

**CONSULTANTS**


<p><b>HAZARDOUS MATERIALS</b> MABBETT &amp; ASSOCIATES, INC. 105 CENTRAL STREET, STONEHAM, MA 02180 PHONE: (781)275-6550</p> <p><b>CIVIL/STRUCTURAL</b> PROFESSIONAL ENGINEERING CONSULTANTS, P.A. 303 SOUTH TOPEKA, WICHITA, KS 67202 PHONE: (316)282-2881</p> <p><b>ARCHITECTURAL</b> OCULUS INC. DRIVE, SUITE 1500, SAINT LOUIS, MO 63102 PHONE: (314)367-6100</p>	<p><b>FIRE SUPPRESSION</b> KOFFEL ASSOCIATES 8815 CENTRE PARK DRIVE, SUITE 200, COLUMBIA, MD 21045 PHONE: (410)729-2246</p> <p><b>ELECTRONIC SECURITY</b> MAGNA ENGINEERS 861 CORPORATE DRIVE, SUITE 210, LEXINGTON, KY 40503 PHONE: (859)306-2990</p> <p><b>PHYSICAL SECURITY</b> FORCE PROTECT 3210 GULF BLVD, UNIT 304, BELLEAIR BEACH, FL 33786 PHONE: (802)836-4232</p>
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**ENGINEER OF RECORD**


<p><b>Miller-Remick LLC</b> M.E.P. &amp; Structural Engineering A Service Disabled Veteran Owned Small Business</p> <p>1010 KINGS HIGHWAY SOUTH CHERRY HILL, NEW JERSEY 08034 PHONE: (856)429-4000 FAX: (856)429-5002 MR PROJECT NO: 0499-0121</p>	<p>MILLER-REMIK LLC PROFESSIONAL ENGINEER</p> <p>ANTHONY D. PAJARD LICENSED PROFESSIONAL ENGINEER KANSAS 26413 9.3.2021</p>
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<p><b>Office of Construction and Facilities Management</b></p> <p>VA U.S. Department of Veterans Affairs</p>	<p>Drawing Title <b>MECHANICAL SITE PLAN</b></p> <p>Approved: Project Director</p>
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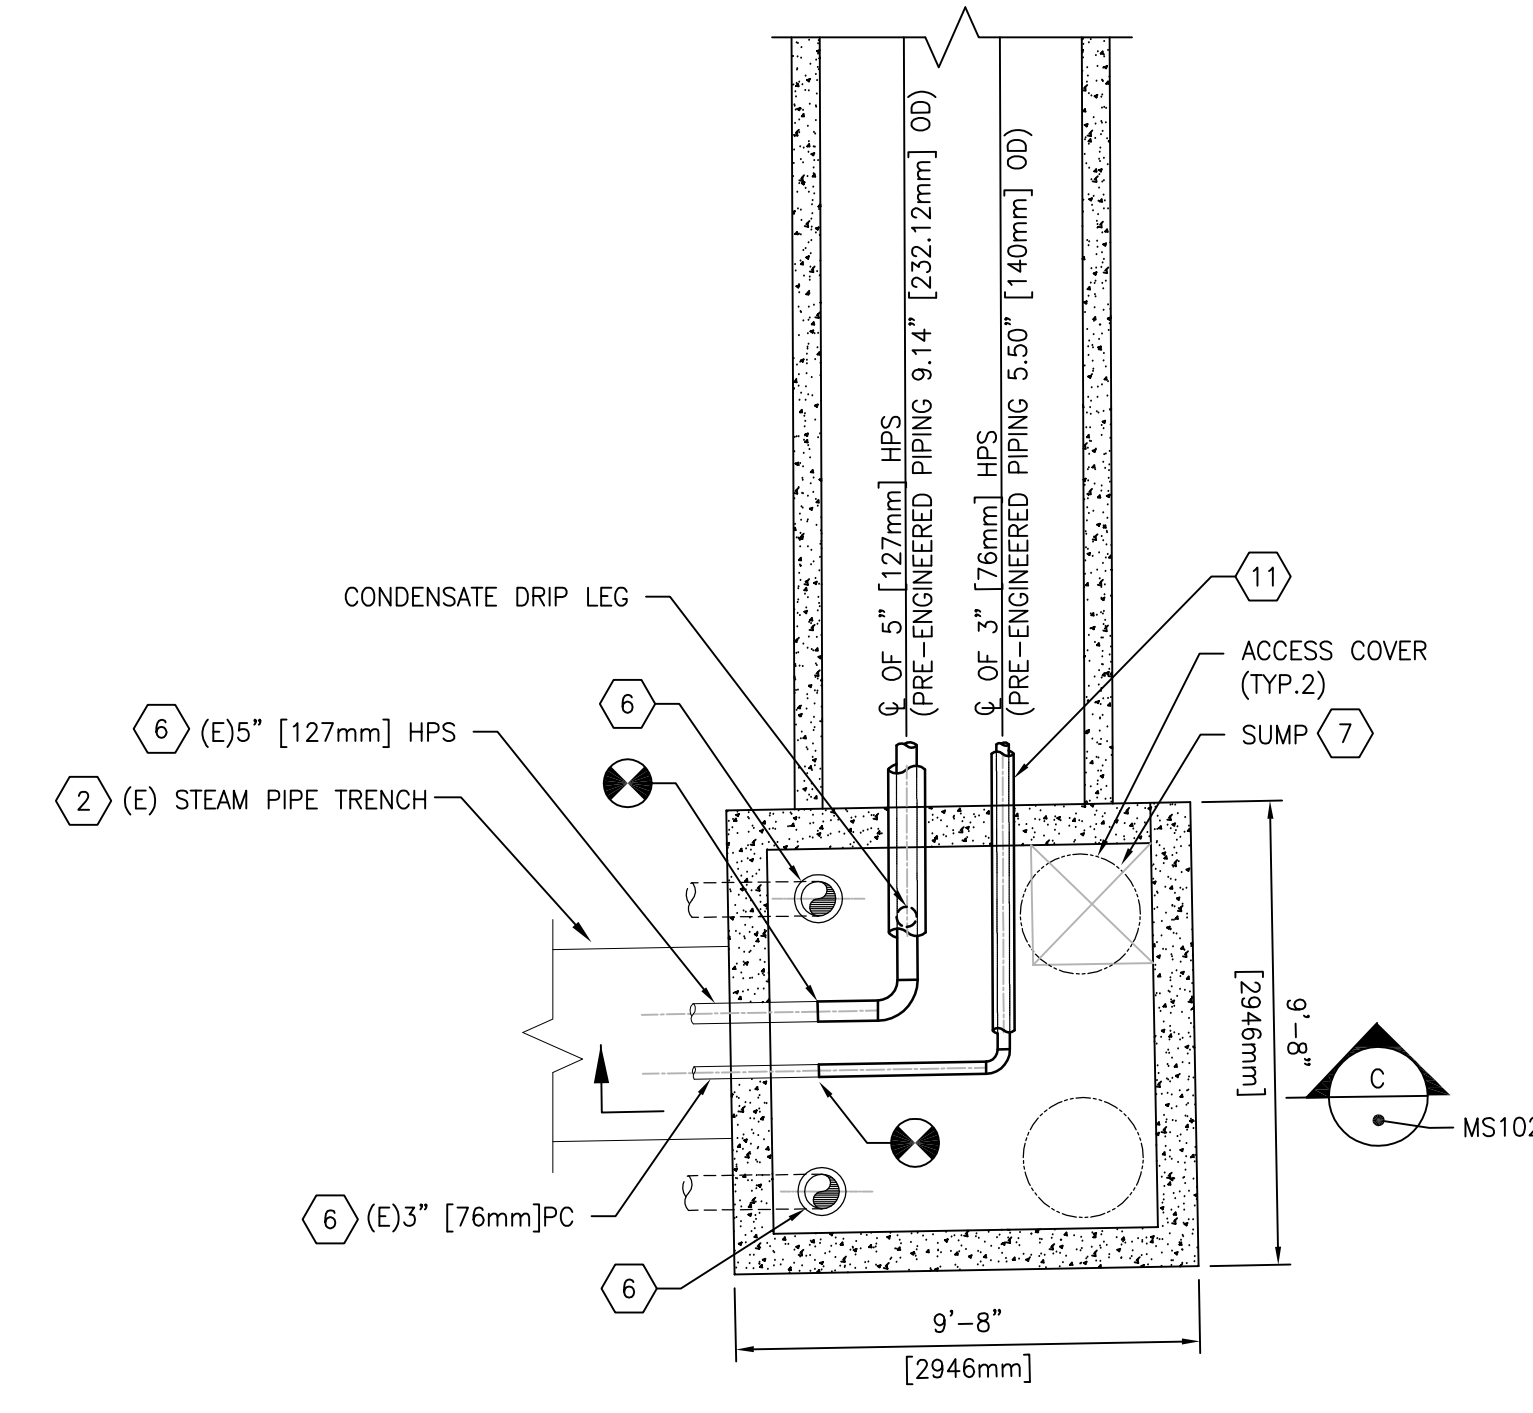
<p>Phase</p> <p><b>100% BID SET</b></p>	<p>Project Title</p> <p><b>INSTALL NEW BOILERS IN BUILDING 13</b></p>	<p>Project Number</p> <p><b>589A7-18-302</b></p>
<p><b>FULLY SPRINKLERED</b></p>	<p>Location</p> <p><b>ROBERT J. DOLE VA MEDICAL CENTER WICHITA, KANSAS</b></p>	<p>Building Number</p> <p><b>ENERGY CMLPX</b></p>
<p>Issue Date</p> <p><b>2021-09-03</b></p>	<p>Checked</p> <p><b>MH</b></p>	<p>Drawn</p> <p><b>GDS</b></p>
<p>Drawing Number</p> <p><b>MS101</b></p>	<p> </p>	<p> </p>



**B SECTION @ NEW STEAM PIPE TRENCH**  
SCALE: 1/4" = 1'-0"

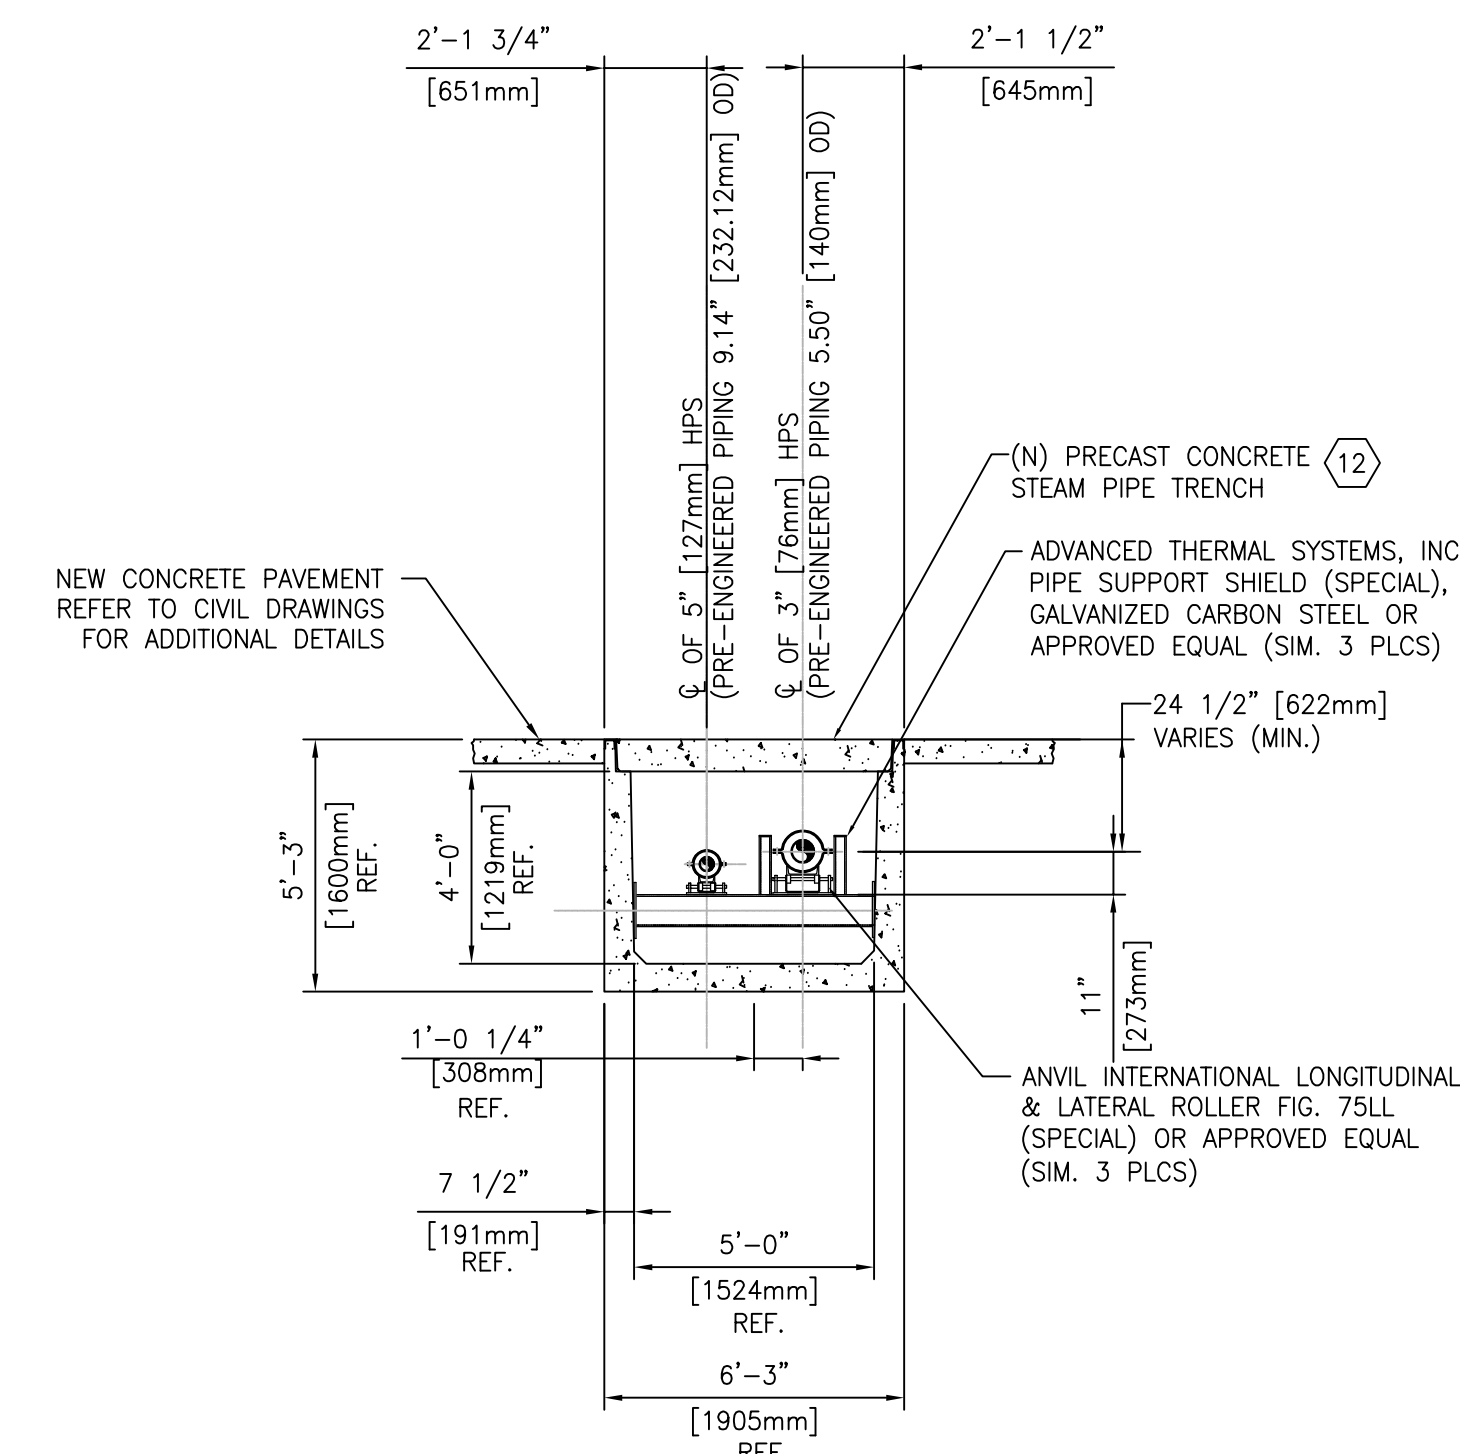

**C SECTION @ NEW STEAM MANHOLE**  
SCALE: 1/4" = 1'-0"

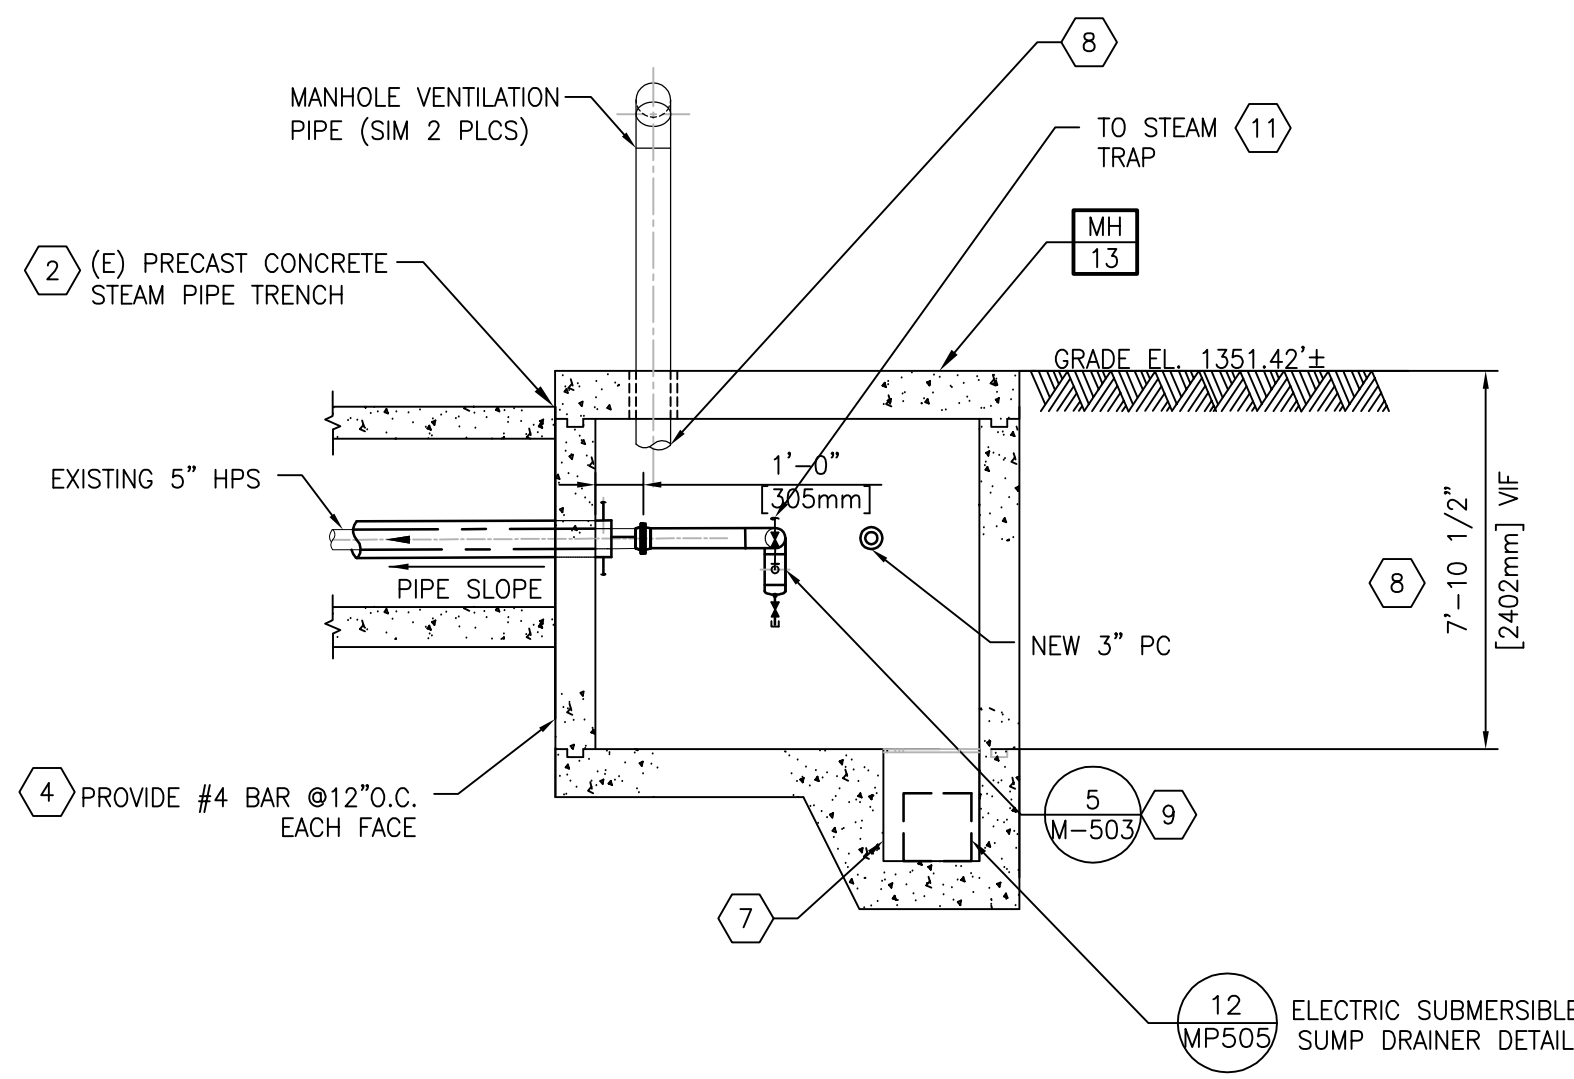


**D PLAN VIEW - NEW STEAM MANHOLE**  
SCALE: 1/4" = 1'-0"

**GENERAL SHEET NOTES:**


1. THE UNDERGROUND UTILITIES SHOWN ON THE PROJECT DOCUMENTS AND WITHIN THE PROJECT AREA AND TOPOGRAPHIC SURVEY WERE LOCATED AND REFERENCED FROM A SITE MARK-OUT PERFORMED BY PEC, P.A. DURING THE SUMMER OF 2020/2021.  
CONTACT INFORMATION:  
PROFESSIONAL ENGINEERING CONSULTANTS, P.A.  
303 SOUTH TOPEKA, WICHITA, KS 67202  
PHONE: (316) 262-2891
2. THE LOCATIONS OF UNDERGROUND UTILITIES FOUND AND SHOWN WITHIN THESE PROJECT DOCUMENTS, WERE CONDUCTED FOR DESIGN PURPOSES ONLY. PARTIAL FIELD INVESTIGATIONS WERE CONDUCTED TO DETERMINE DEPTHS OF SOME OF THE EXISTING UTILITIES. THEREFORE LOCATIONS SHOWN WITHIN THESE DESIGN DOCUMENTS ARE APPROXIMATE AND THE EXISTENCE AND LOCATION OF ANY UNDERGROUND OBSTRUCTION OR UTILITY CANNOT BE GUARANTEED. THEREFORE THE PROJECT AREA MUST BE FULLY INVESTIGATED AND VERIFIED IN THE FIELD BY THE CONTRACTOR PRIOR TO EXCAVATION/CONSTRUCTION.
3. PRIOR TO ANY EXCAVATION, THE CONTRACTOR IS RESPONSIBLE TO LOCATE AND IDENTIFY ANY PUBLIC OR PRIVATE UNDERGROUND UTILITY. FOR PUBLIC UTILITIES, CONTRACTORS MUST CONTACT THE KANSAS 811 UTILITY NOTIFICATION SYSTEM. THE CONTRACTOR IS RESPONSIBLE TO VERIFY THE LOCATION OF ALL PUBLIC UTILITIES AND ALL PRIVATE UTILITIES THAT MAY BE EXPOSED OR COULD BE IMPACTED BY THE WORK AND ARE WITHIN AND ADJACENT TO ANY EXCAVATIONS OR UNDERGROUND WORK. THE CONTRACTOR SHALL ENLIST THE ASSISTANCE OF THE COR OR APPOINTED FACILITY PERSONNEL TO OBTAIN THEIR OPINION AS TO THE LOCATIONS OF UNDERGROUND UTILITIES THAT MAY EXIST WITHIN THE CONSTRUCTION AREA AND THAT MAY OR MAY NOT BE PRESENTED IN THE CONTRACT DOCUMENTS.
4. THE CONTRACTOR IS RESPONSIBLE FOR ANY DAMAGE TO EXISTING UTILITIES EVEN IF THE UTILITIES ARE NOT SHOWN ON THE DRAWINGS. THE CONTRACTOR SHALL REPAIR ALL DAMAGES AT THEIR OWN EXPENSE AND WILL BE RESPONSIBLE FOR ANY ADDITIONAL DAMAGES CAUSED BY A SYSTEM BEING DOWN.
5. HPS STEAM PIPING SHALL BE SLOPED 1/2" IN 10' FEET IN DIRECTION OF FLOW.
6. INSTALLATION MUST MEET ALL VA STEAM DISTRIBUTION SYSTEM REQUIREMENTS.

**SHEET KEYNOTES:**

1. CONTRACTOR SHALL FIELD VERIFY DEPTH & WIDTH OF EXISTING UTILITY TRENCH.
2. CONTRACTOR SHALL SAW-CUT EXISTING CONCRETE AT POINT INDICATED.
3. NEW PRECAST CONCRETE UTILITY TRENCH.
4. NEW CAST-IN PLACE CONCRETE MANHOLE. REFER TO DETAILS ON THIS DRAWING FOR ADDITIONAL DETAILS. REFER TO STRUCTURAL GENERAL NOTES AND DRAWING S-401 FOR TYPICAL CONCRETE REINFORCING DETAILS.
5. CONTRACTOR SHALL FIELD VERIFY EXISTING ELEVATION AND SPACING OF UTILITY PIPES.
6. PROVIDE VENTILATION PIPES FROM THE MANHOLE TO A LOCATION OUTSIDE THE ROADWAY. TERMINATE ONE, 12 INCHES ABOVE THE BOTTOM OF THE MANHOLE AND THE OTHER 12 INCHES BELOW THE MANHOLE COVER. BOTH PIPES SHALL TERMINATE 18 INCHES ABOVE FINISH GRADE IN A GOOSENECK CONFIGURATION, PAINTED SAFETY YELLOW AND LABEL "MANHOLE VENT."
7. PROVIDE 30 INCH SQUARE x 36" DEEP SUMP IN FLOOR AND SLOPE MANHOLE FLOOR TO SUMP. PROVIDE SUBMERSIBLE PUMP. REFER TO DETAIL 12 ON DRAWING M-506.
8. MANHOLE DEPTH SHALL BE FIELD VERIFIED WITH EXISTING ELEVATION OF TOP AND BOTTOM OF EXISTING UTILITY TRENCH. MANHOLE DEPTH SHALL BE DEEP ENOUGH TO ALLOW FOR INSTALLATION AND MAINTENANCE OF PIPES, EQUIPMENT, ETC.
9. INSTALL STEAM TRAP UP HIGH IN MANHOLE CLOSE TO ACCESS COVER. CONNECT TRAP DISCHARGE PIPE INTO PUMPED CONDENSATE LINE PER DETAIL 12 ON M-503.
10. MANHOLE & TRENCH SHALL MEET ASHTO HS20 (32,000 LBS/AXLE).
11. PRE-ENGINEERED PIPE SYSTEM BASIS OF DESIGN: PERMA PIPE POLY-THERM GOLD.
12. NEW 6" NATURAL GAS MAIN. REFER TO CIVIL DRAWINGS AND DRAWING MP606 FOR ADDITIONAL DETAILS.
13. INSTALL NEW PIPE ANCHOR TO FOUNDATION WALL. REFER TO DETAIL 15 ON STRUCTURAL DRAWING S-502.

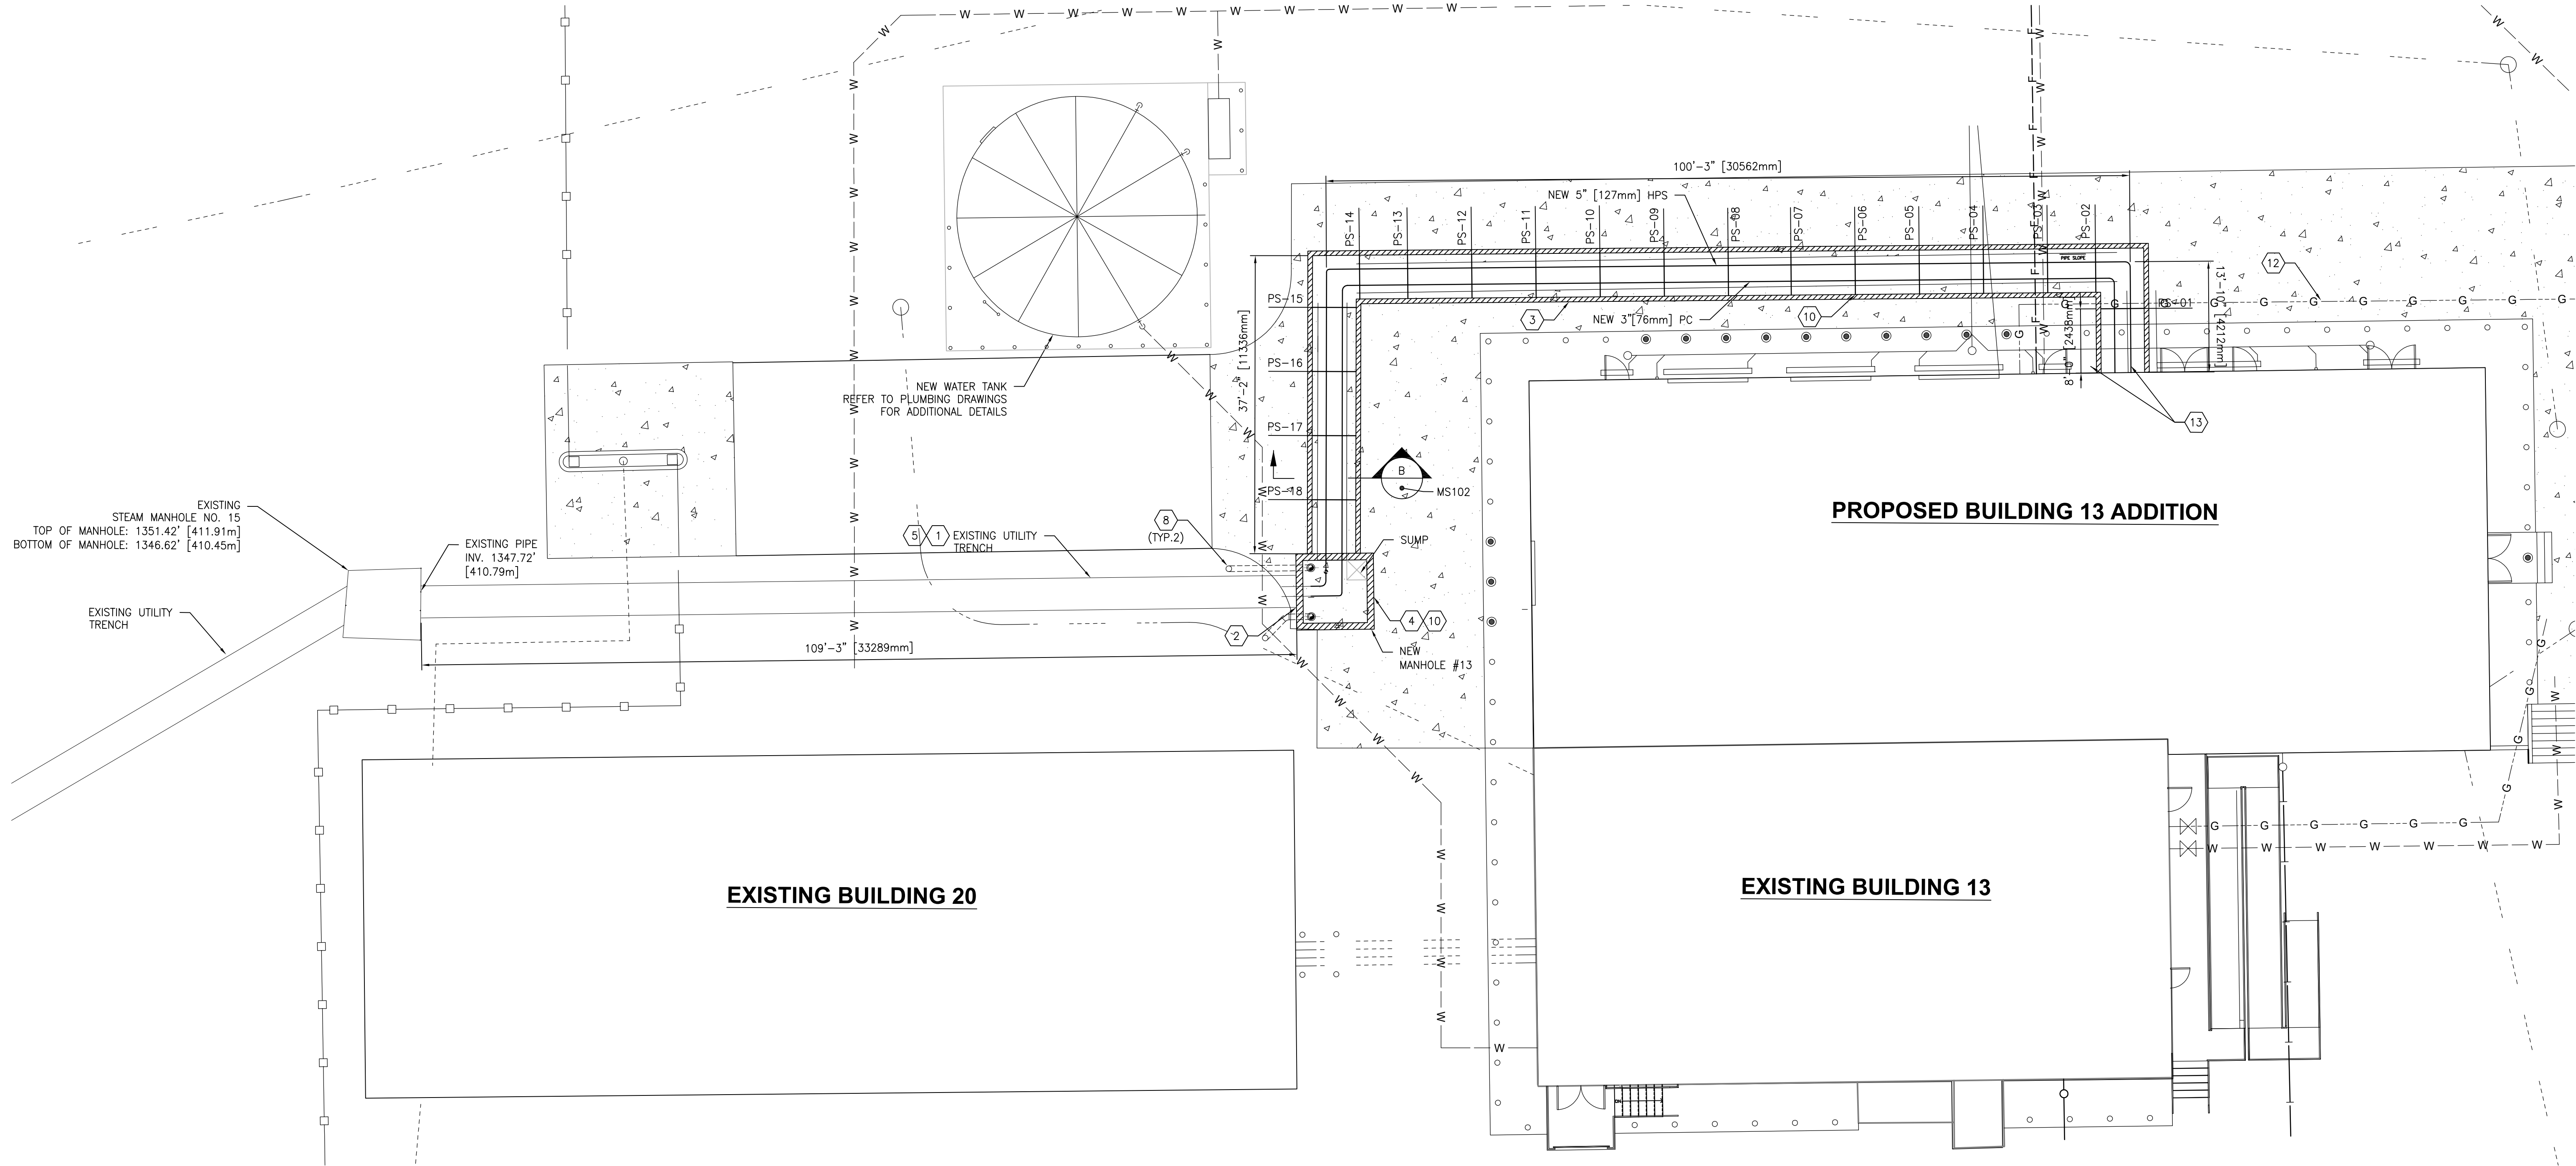

**1 SITE PLAN - NEW STEAM PIPE TRENCH**  
SCALE: 1" = 10'

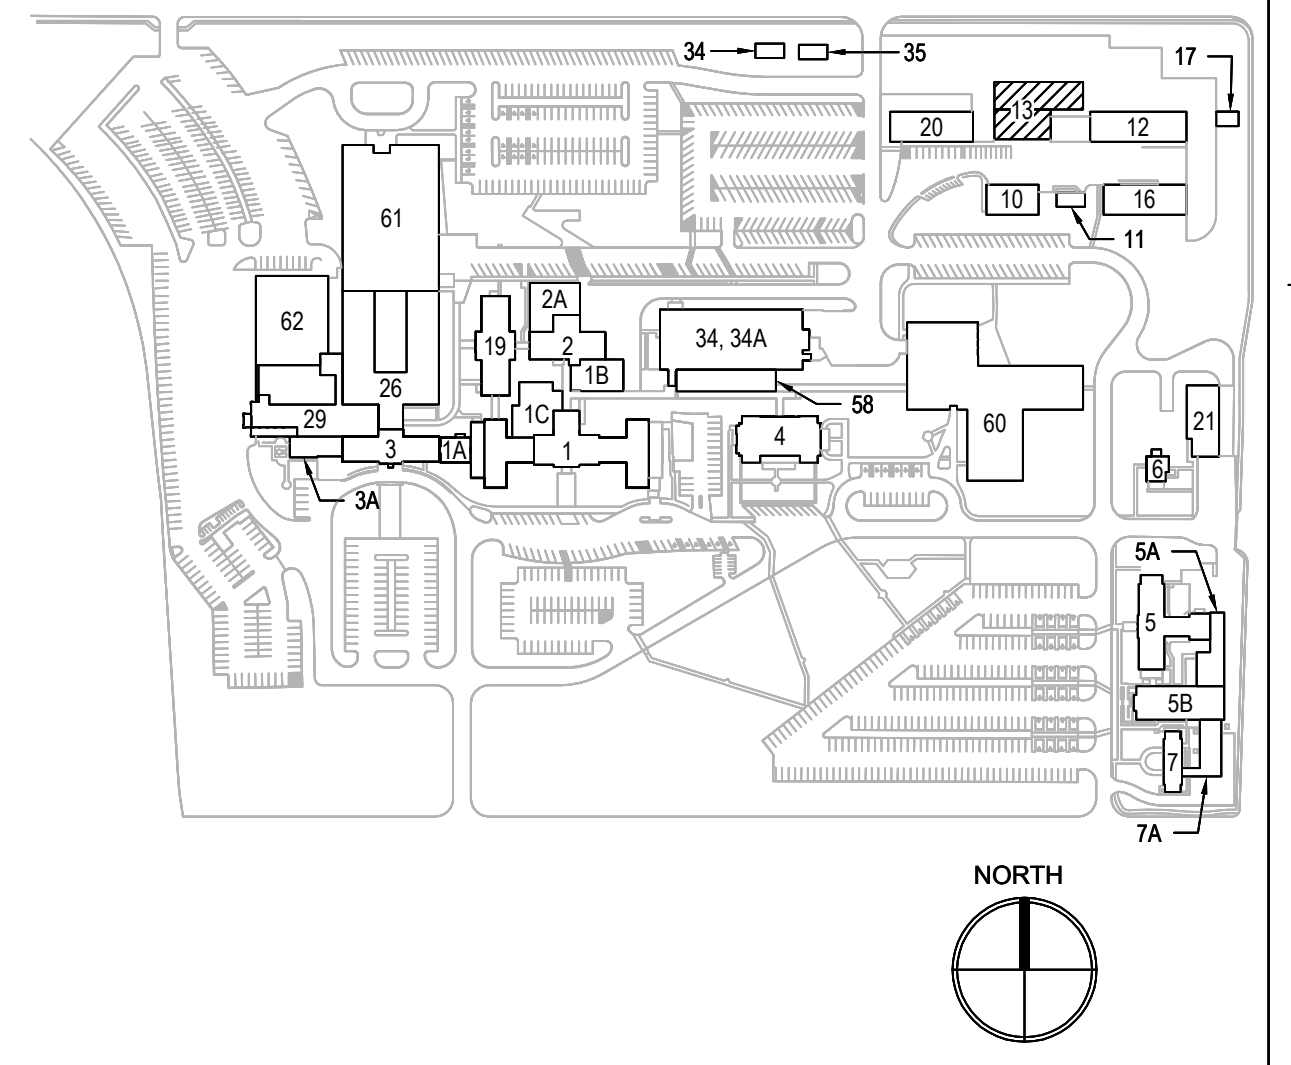

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NO.	DESCRIPTION	DATE

CONSULTANTS	
<b>HAZARDOUS MATERIALS</b> <b>MABBETT &amp; ASSOCIATES, INC.</b> 105 CENTRAL STREET, STONEHAM, MA 02180 PHONE: (781)275-6550	<b>FIRE SUPPRESSION</b> <b>KOFFEL ASSOCIATES</b> 8815 CENTRE PARK DRIVE, SUITE 200, COLUMBIA, MD 21045 PHONE: (410)759-2246
<b>CIVIL/STRUCTURAL</b> <b>PROFESSIONAL ENGINEERING CONSULTANTS, P.A.</b> 303 SOUTH TOPEKA, WICHITA, KS 67202 PHONE: (316)262-2891	<b>ELECTRONIC SECURITY</b> <b>MAGNA ENGINEERS</b> 861 CORPORATE DRIVE, SUITE 210, LEXINGTON, KY 40503 PHONE: (859)306-2990
<b>ARCHITECTURAL</b> <b>OCLULUS INC.</b> 1 SOUTH MEMORIAL DRIVE, SUITE 1500, SAINT LOUIS, MO 63102 PHONE: (314)367-6100	<b>PHYSICAL SECURITY</b> <b>FORCE PROTECT</b> 3210 GULF BLVD, UNIT 304, BELLEAIR BEACH, FL 33786 PHONE: (888)836-4232

**ENGINEER OF RECORD**

**Miller-Remick LLC**  
M.E.P. & Structural Engineering  
A Service Disabled Veteran Owned Small Business

1010 KINGS HIGHWAY SOUTH  
CHERRY HILL, NEW JERSEY 08034  
PHONE: (856)429-4000  
FAX: (856)429-9002  
MR PROJECT NO: 0499-0121

MILLER-REMICK LLC  
PROFESSIONAL ENGINEER

ANTHONY D. PACIARO  
LICENSED PROFESSIONAL ENGINEER  
KANSAS  
26413  
9.3.2021

Office of Construction and Facilities Management

VA U.S. Department of Veterans Affairs

Drawing Title  
**MECHANICAL SITE STEAM TRENCH ARRANGMENT PLAN & SECTION**

Approved: Project Director

Phase  
**100% BID SET**

**FULLY SPRINKLERED**

Project Title  
**INSTALL NEW BOILERS IN BUILDING 13**

Location  
**ROBERT J. DOLE VA MEDICAL CENTER WICHITA, KANSAS**

Issue Date  
**2021-09-03**

Checked  
**AP**

Drawn  
**GDS**

Project Number  
**589A7-18-302**

Building Number  
**13**


Drawing Number  
**MS102**

**GENERAL SHEET NOTES:**


1. REFER TO DRAWING M-001 FOR NOTES, SYMBOLS AND ABBREVIATIONS.
2. REFER TO DRAWINGS MP601, MP602, MP603 AND MP604 FOR SYSTEM FLOW DIAGRAMS.
3. REFER TO DRAWINGS M-701, M-702, M-703 AND M-704 FOR EQUIPMENT SCHEDULES.
4. CONTRACTOR SHALL SUBMIT A DETAILED LOCKOUT/TAGOUT PROCEDURE TO THE VA A MINIMUM OF 4 WORKING DAYS PRIOR TO PERFORMING ANY WORK ON ANY LIVE STEAM OR STEAM CONDENSATE SYSTEM.
5. ALL VALVE HANDLES LOCATED GREATER THAN 7'-0" ABOVE ANY WALKING SURFACE SHALL BE FITTED WITH A CHAIN WHEEL OPERATOR AND CHAIN. PROVIDE HOOKS TO STORE CHAIN IN SUITABLE LOCATION.

**SHEET KEYNOTES:**


1. DISCONNECT AND REMOVE EXISTING RADIANT CEILING PANEL, ASSOCIATED PIPING, VALVES, CONTROLS, THERMOSTAT. REMOVE PIPING BACK TO RESPECTIVE MAINS. PROVIDE BALL VALVES WITH CAPS/PLUGS.
2. DISCONNECT AND REMOVE AIR DEVICE AND ASSOCIATED SUPPLY BRANCH DUCTWORK BACK TO POINT SHOWN FOR CONNECTION IN NEW WORK.
3. 3/4" DIA CONDENSATE DRAIN PIPING, PITCH DOWNWARD IN DIRECTION OF FLOW MINIMUM 1/8 INCH PER FOOT. ROUTE TO NEW INDIRECT WASTE DRAIN ABOVE CEILING IN TOILET 109A-3. TERMINATE TO SANITARY DISCHARGE WITH AIR GAP.
4. PROVIDE 6" CONCRETE EQUIPMENT PAD ON GRADE. REFER TO MECHANICAL DETAIL FOR ADDITIONAL INFORMATION.
5. REFRIGERANT PIPING (SUCTION & LIQUID) THRU WALL SLEEVE ABOVE CEILING. ROUTE PER MANUFACTURER'S RECOMMENDATIONS. PROVIDE SUPPORTS AS REQUIRED. SEAL WEATHERTIGHT.
6. REBALANCE EXISTING TERMINAL REHEAT UNIT TO AIRFLOW INDICATED.
7. CONTRACTOR SHALL PROVIDE (N+1) COMPLETE HVAC SYSTEMS FOR SECURITY EQUIPMENT ROOM 102-X.

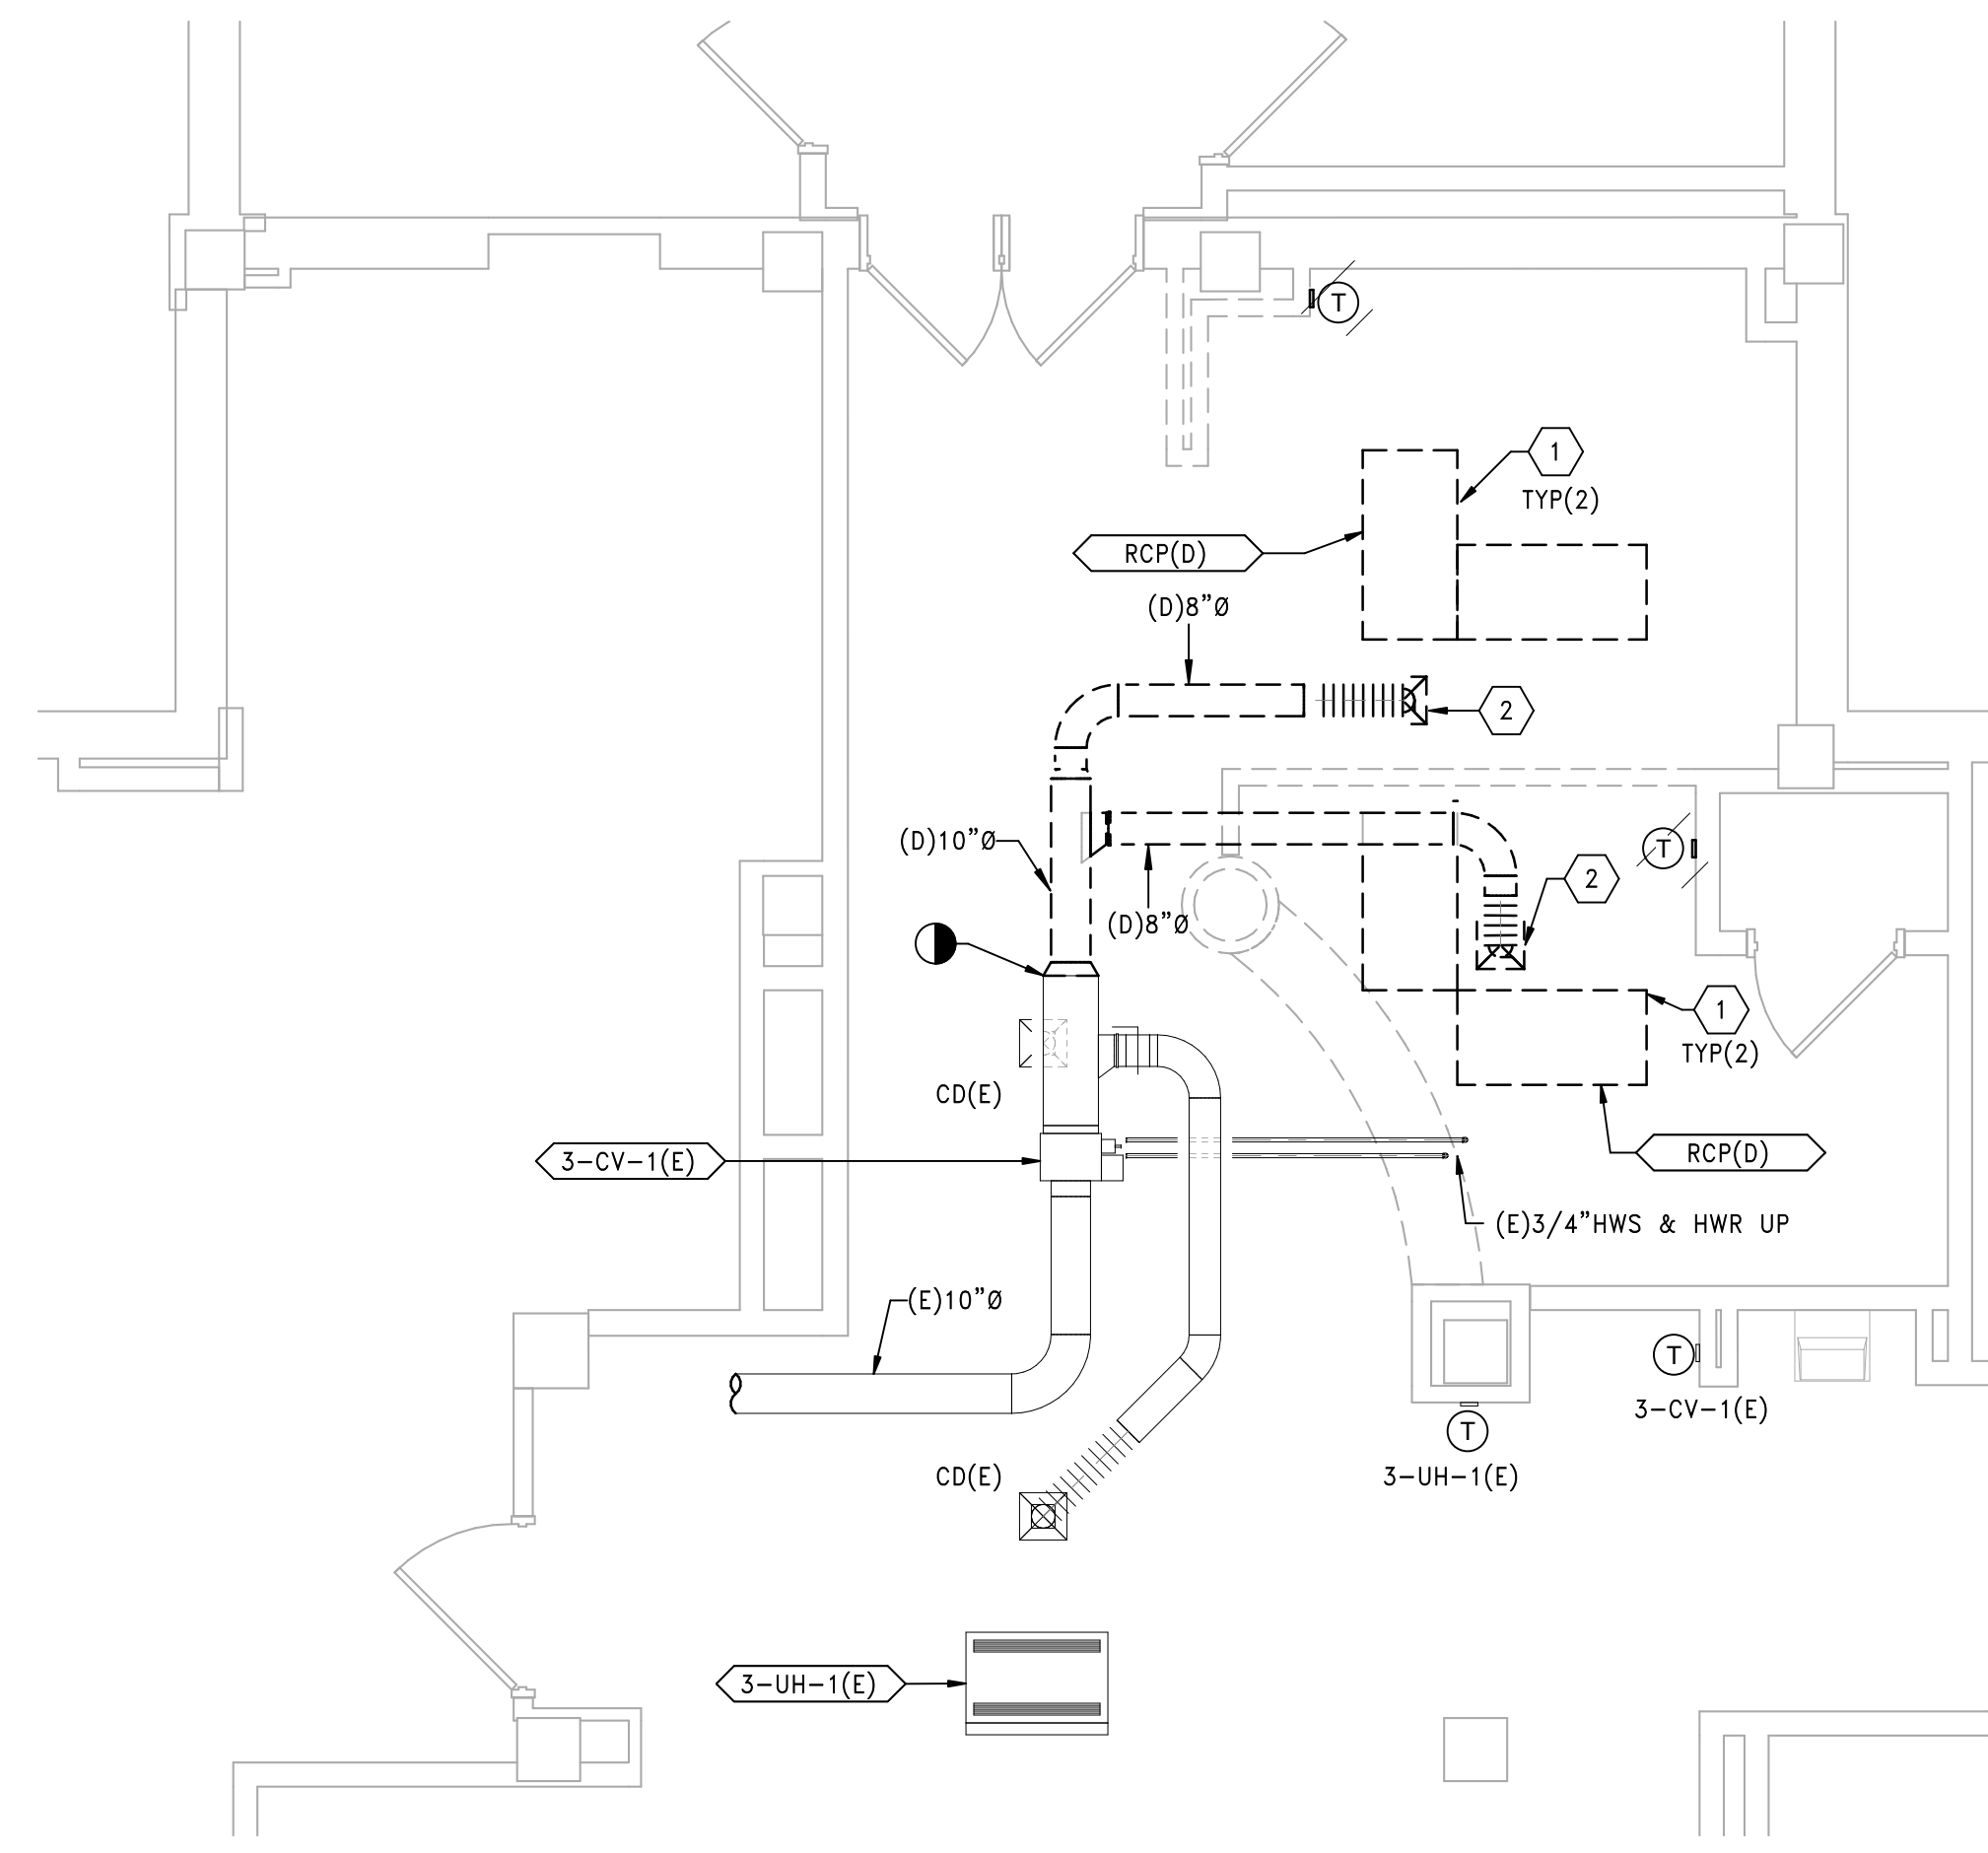

**1 MECHANICAL DEMOLITION PLAN - FIRST FLOOR**  
SCALE: 1/4" = 1'-0"

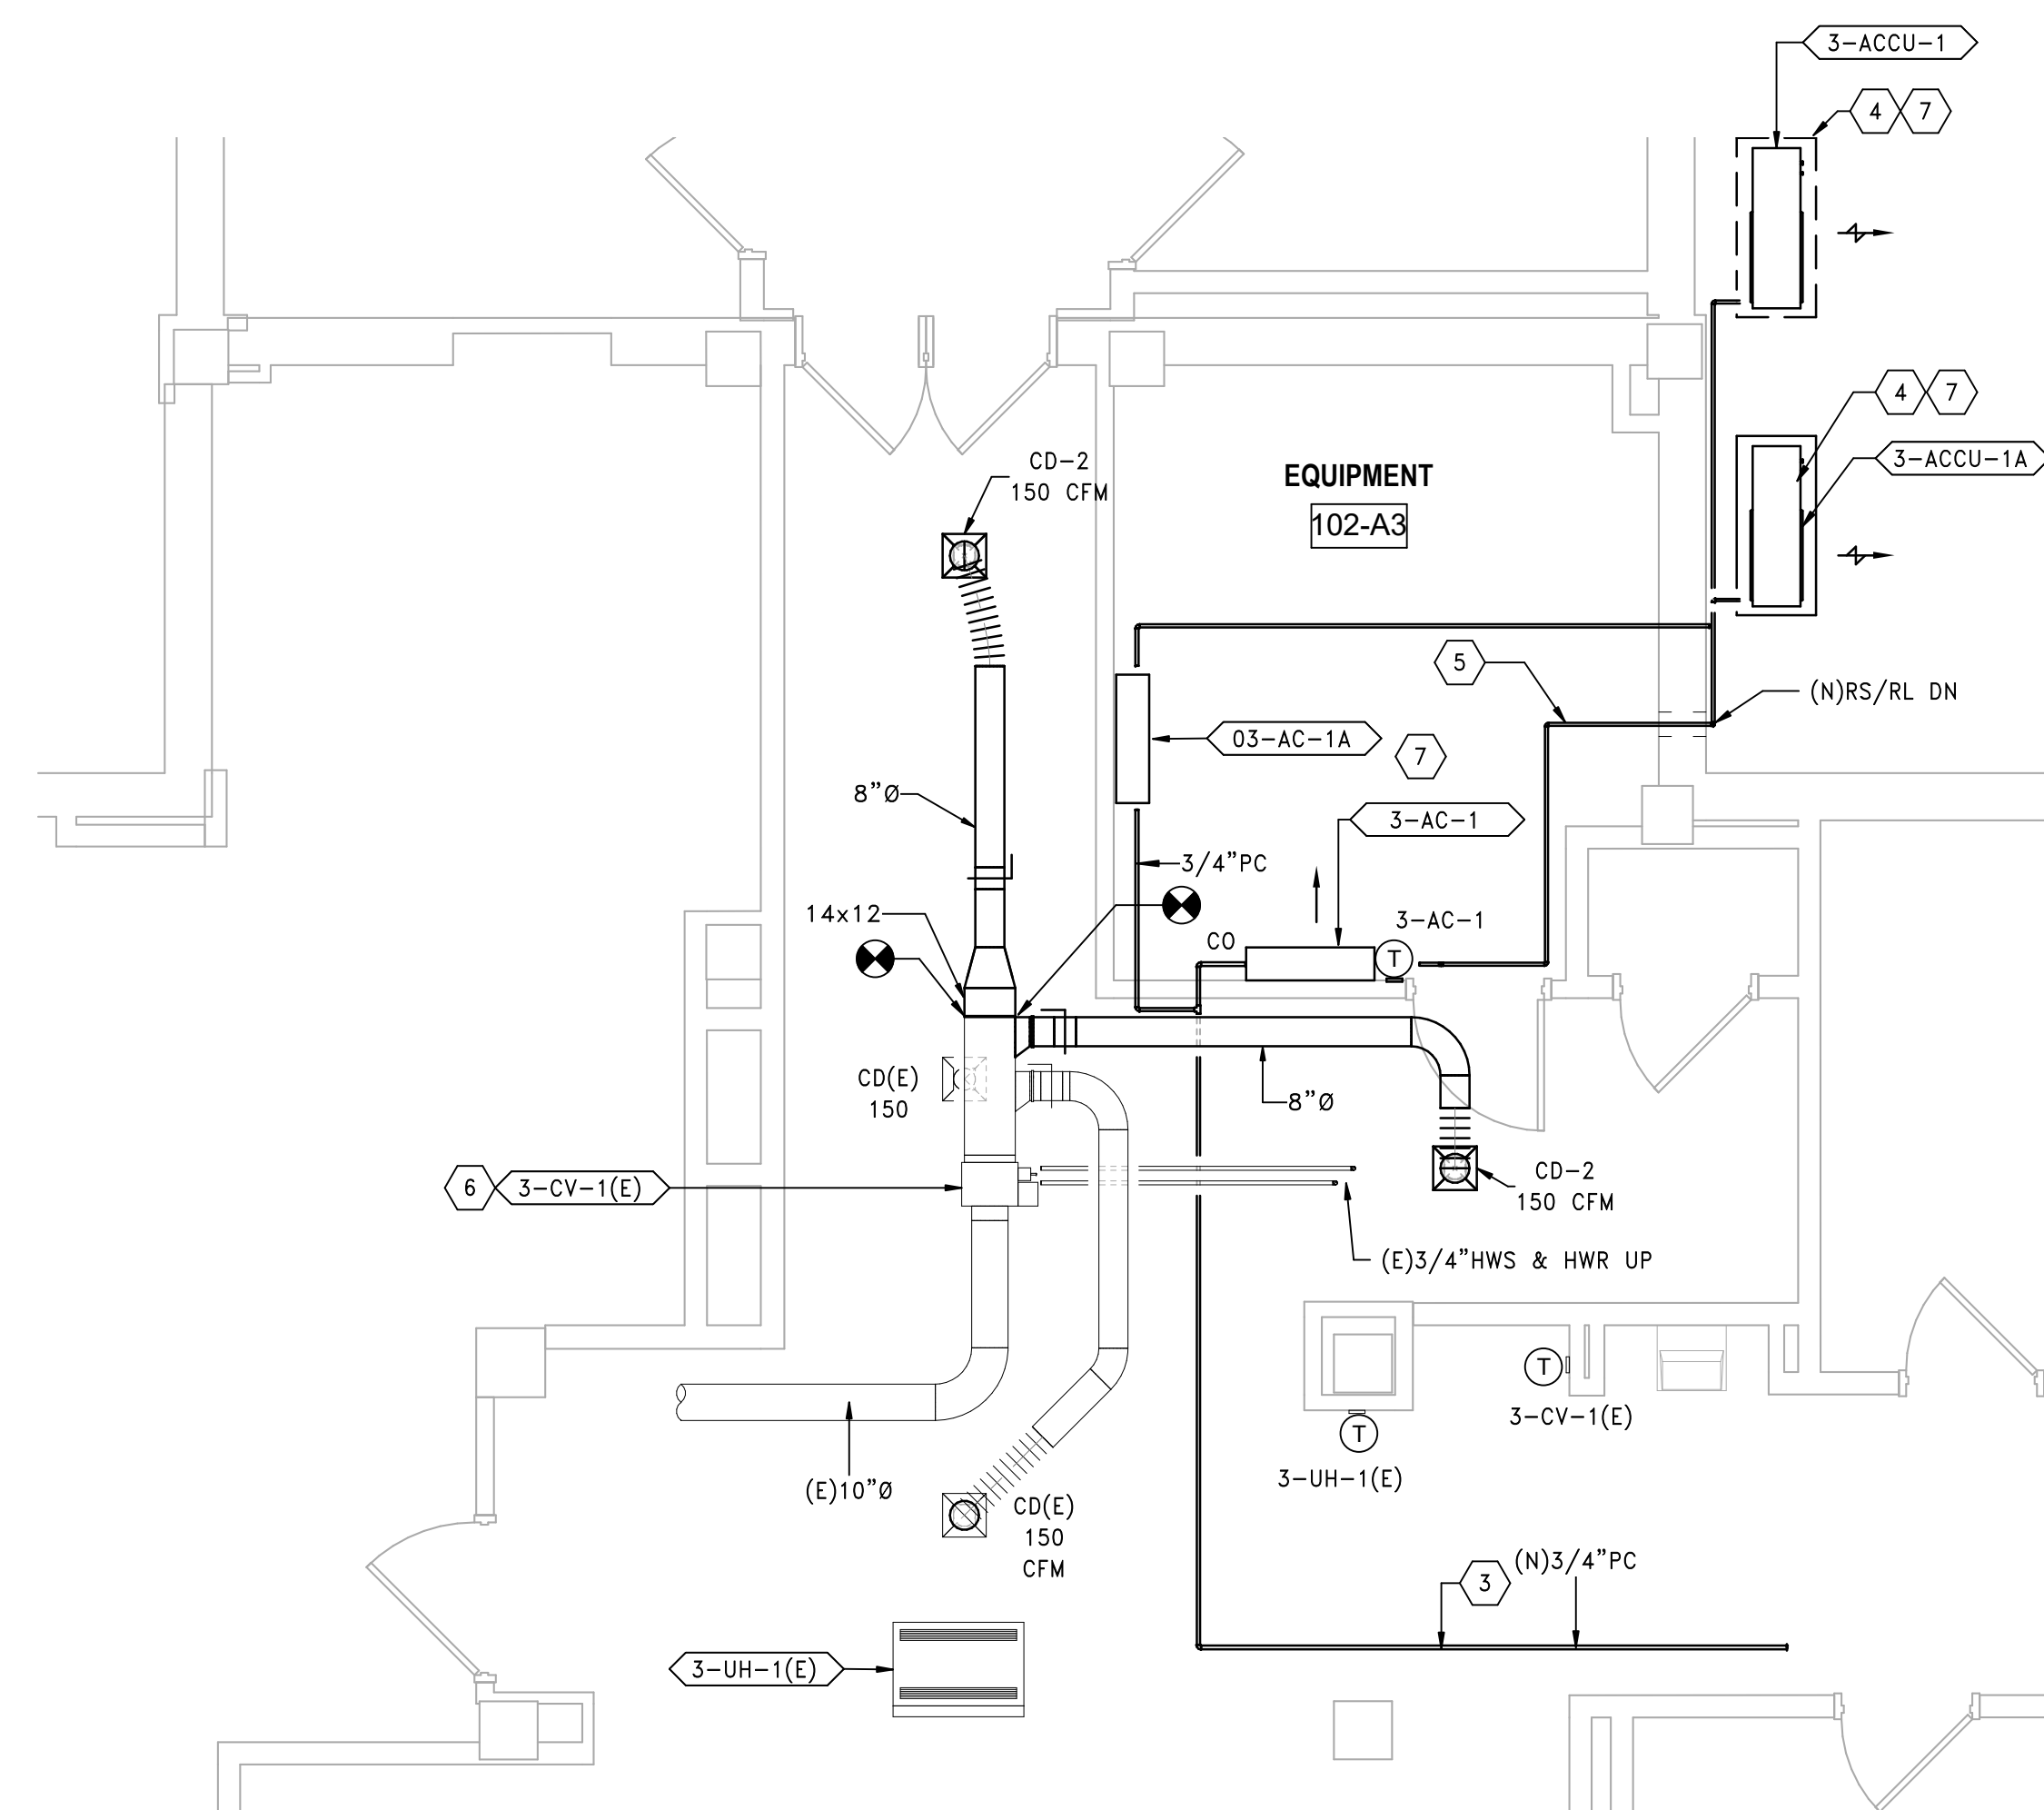


**2 MECHANICAL NEW WORK PLAN - FIRST FLOOR**  
SCALE: 1/4" = 1'-0"

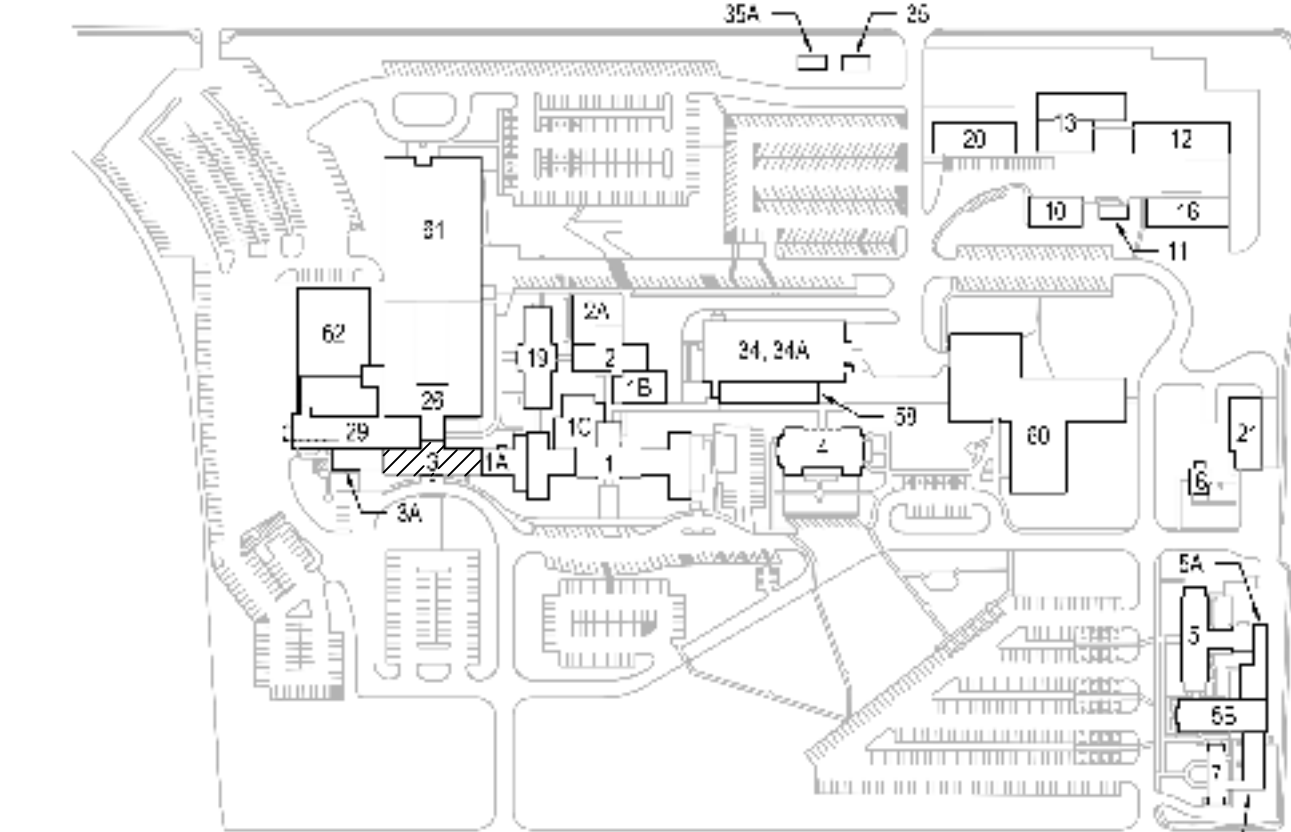

**KEYPLAN**

NORTH

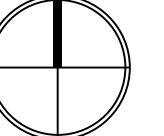

PRINTS OF THIS DRAWING SHALL NOT BE USED FOR ANY PURPOSE WHATSOEVER WITHOUT THE SEAL AND SIGNATURE OF THE PROFESSIONAL ENGINEER		
NO.	DESCRIPTION	DATE

CONSULTANTS	
<b>HAZARDOUS MATERIALS</b> MABBETT & ASSOCIATES, INC. 105 CENTRAL STREET, STONEHAM, MA 02180 PHONE: (781)275-8050	<b>FIRE SUPPRESSION</b> KOFFEL ASSOCIATES 8815 CENTRE PARK DRIVE, SUITE 200, COLUMBIA, MD 21045 PHONE: (410)753-2246
<b>CIVIL/STRUCTURAL</b> PROFESSIONAL ENGINEERING CONSULTANTS, P.A. 303 SOUTH TOPEKA, WICHITA, KS 67202 PHONE: (316)262-2691	<b>ELECTRONIC SECURITY</b> MAGNA ENGINEERS 861 CORPORATE DRIVE, SUITE 210, LEXINGTON, KY 40503 PHONE: (859)309-2990
<b>ARCHITECTURAL</b> OCULUS INC. 1 SOUTH MEMORIAL DRIVE, SUITE 1500, SAINT LOUIS, MO 63102 PHONE: (314)367-6100	<b>PHYSICAL SECURITY</b> FORCE PROTECT 3210 GULF BLVD, UNIT 304, BELLAIR BEACH, FL 33786 PHONE: (502)836-4232

ENGINEER OF RECORD	
<b>Miller-Remick LLC</b> M.E.P. & Structural Engineering A Service Disabled Veteran Owned Small Business 1010 KINGS HIGHWAY SOUTH CHERRY HILL, NEW JERSEY 08034 PHONE: (856)424-4000 FAX: (856)420-8002 MR PROJECT NO: 0499-0121	MILLER-REMIK LLC PROFESSIONAL ENGINEER ANTHONY D. PAKOWSKI LICENSED PROFESSIONAL ENGINEER 29413 KANSAS 9.3.2021

Office of Construction and Facilities Management VA U.S. Department of Veterans Affairs
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Drawing Title <b>MECHANICAL BUILDING 3 SECURITY EQ. CLOSET</b> Approved: Project Director
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Phase 100% BID SET FULLY SPRINKLERED
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Project Title INSTALL NEW BOILERS IN BUILDING 13 Location ROBERT J. DOLE VA MEDICAL CENTER WICHITA, KANSAS Issue Date 2021-09-03 Checked AP Drawn MK
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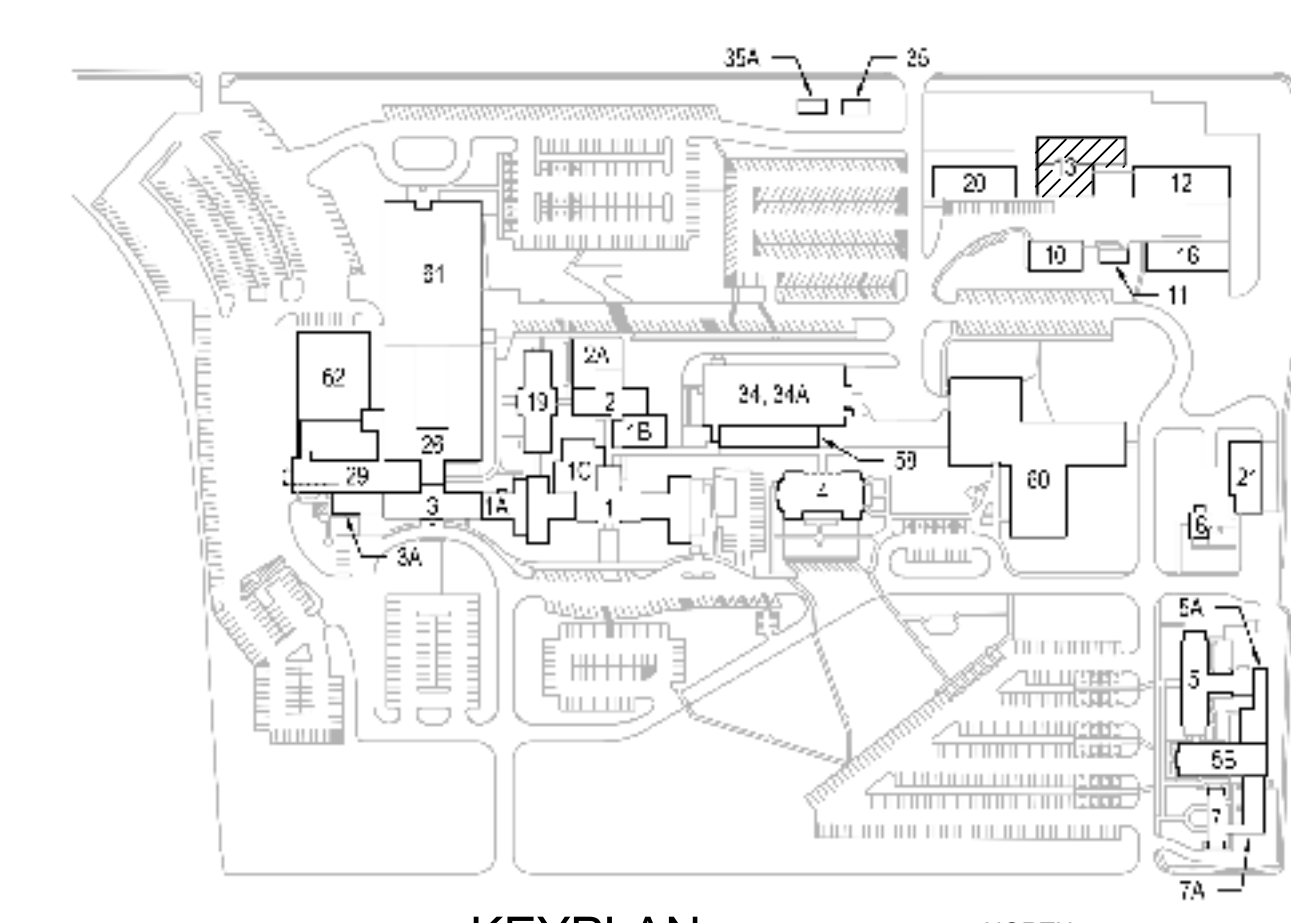
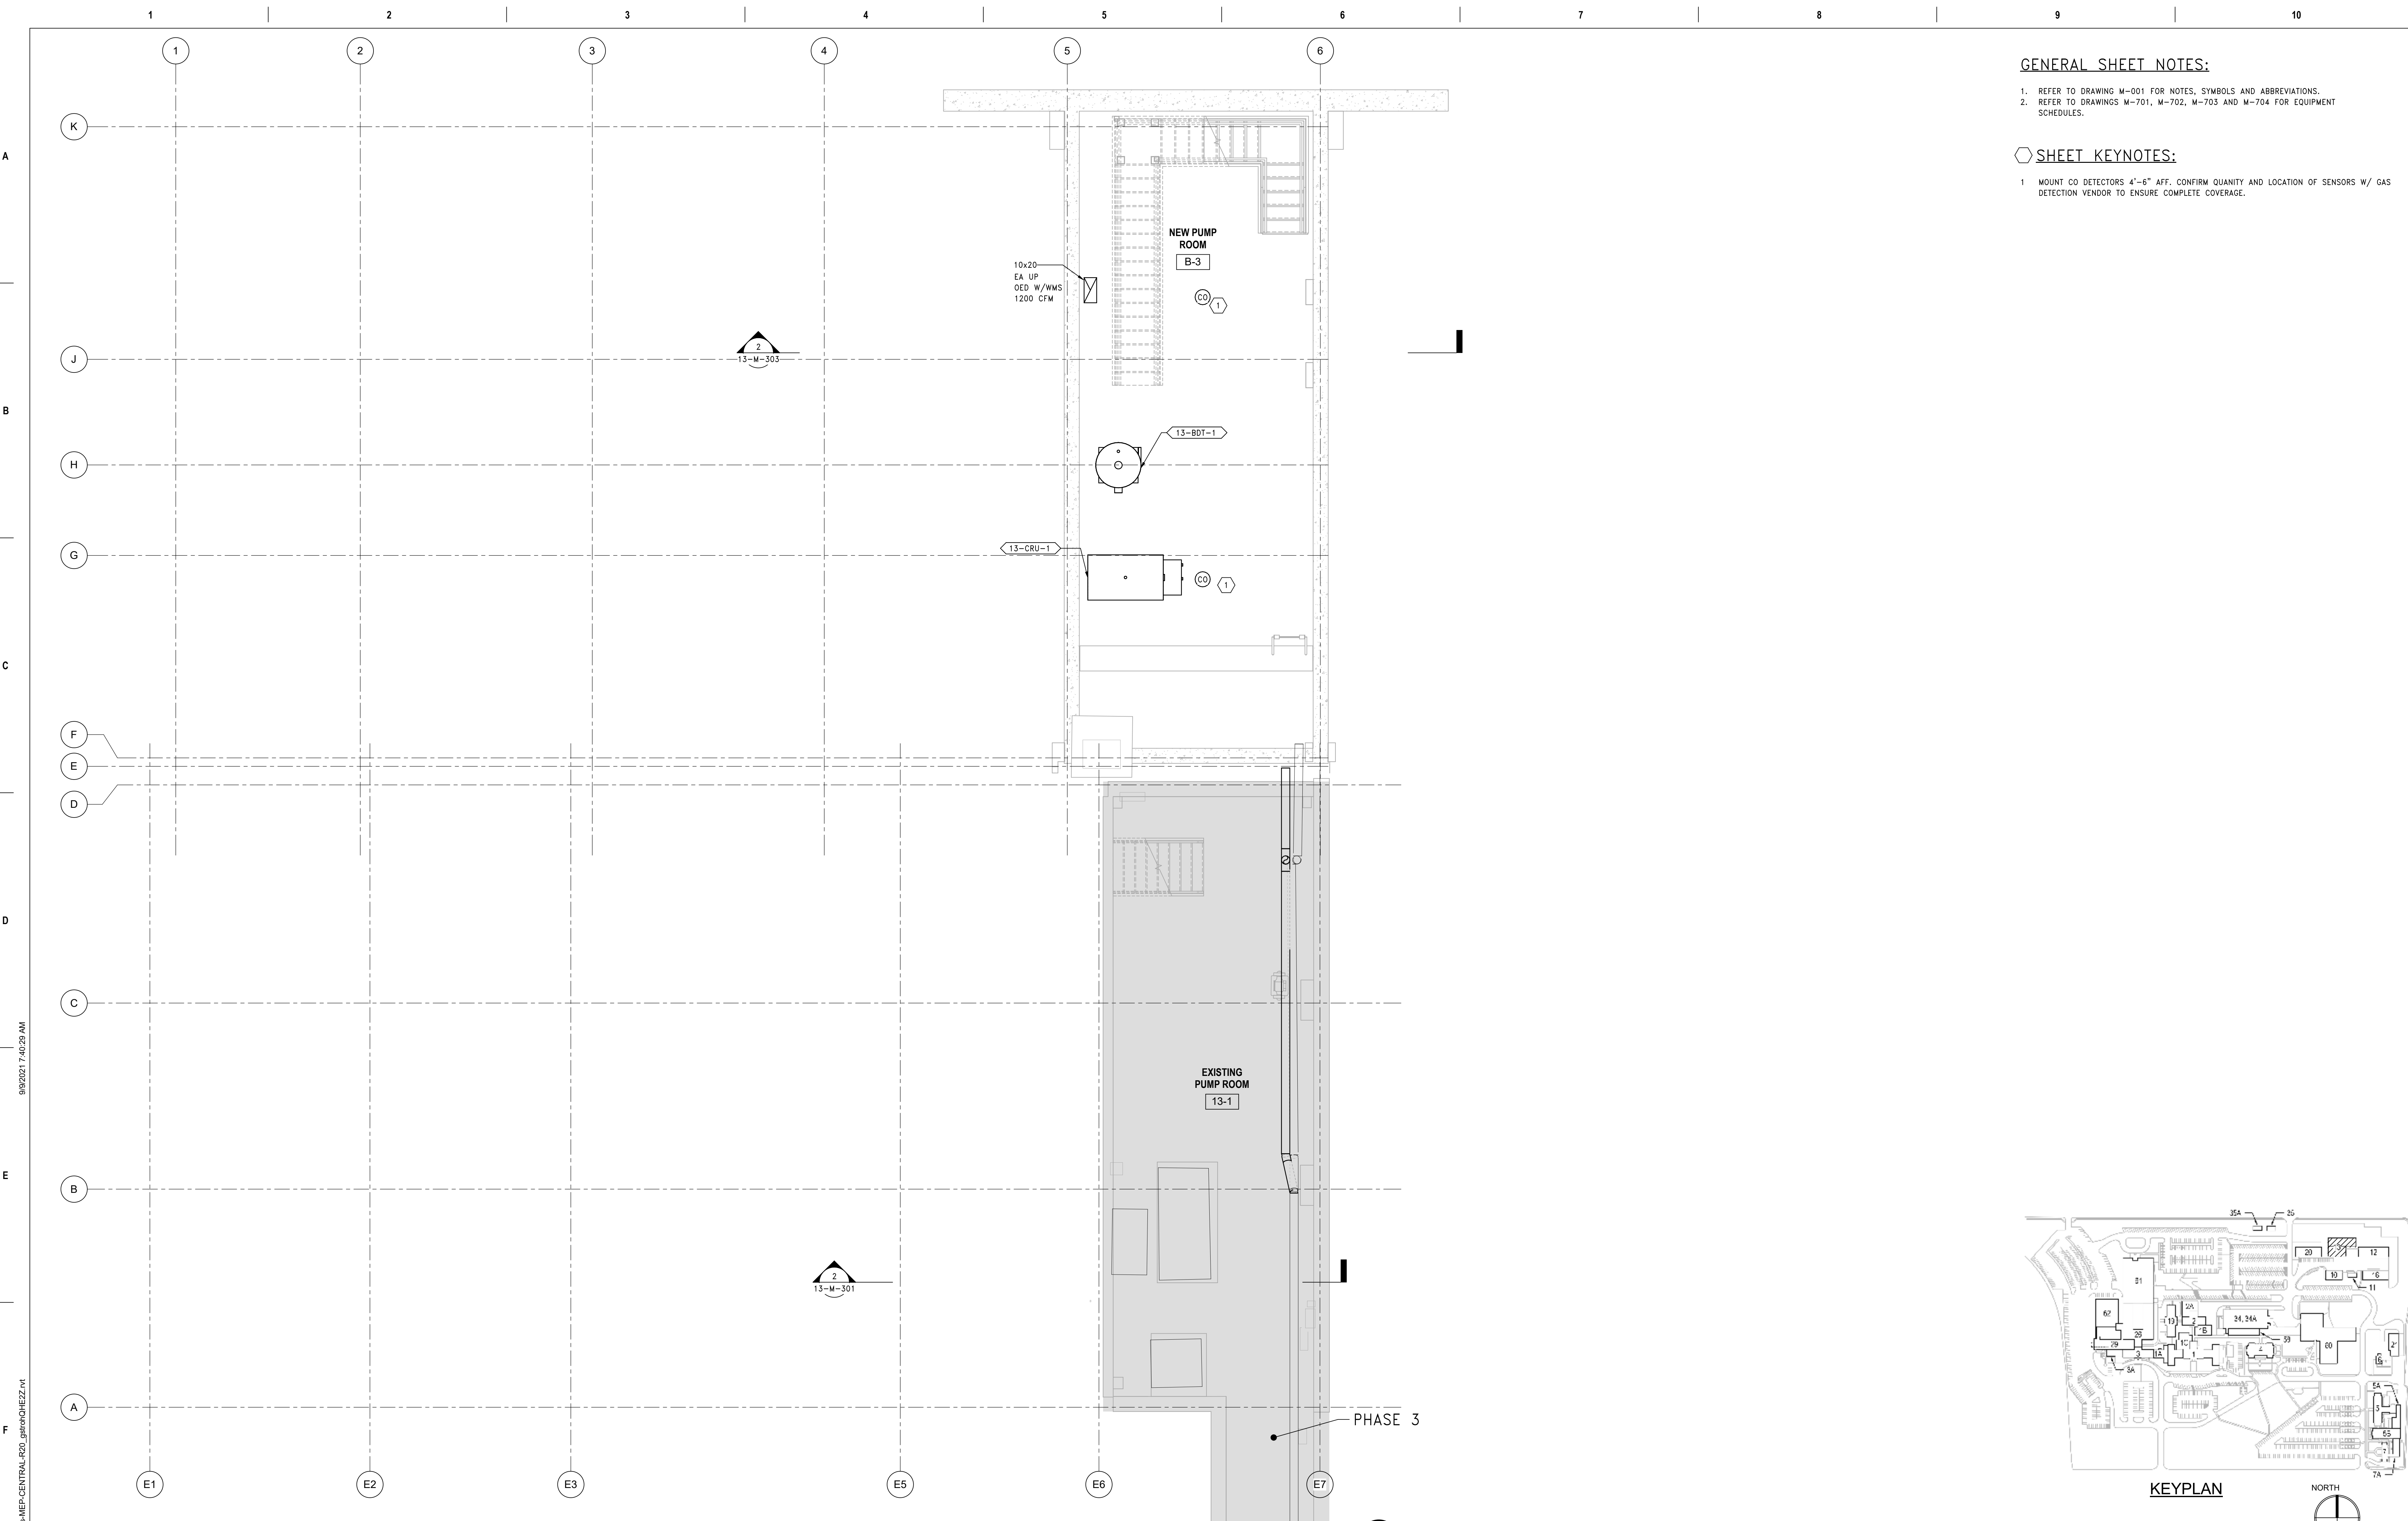
Project Number 589A7-18-302 Building Number 3 Drawing Number 03-M-111
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**GENERAL SHEET NOTES:**

1. REFER TO DRAWING M-001 FOR NOTES, SYMBOLS AND ABBREVIATIONS.
2. REFER TO DRAWINGS M-701, M-702, M-703 AND M-704 FOR EQUIPMENT SCHEDULES.

**SHEET KEYNOTES:**

- 1 MOUNT CO DETECTORS 4'-6" AFF. CONFIRM QUANTITY AND LOCATION OF SENSORS W/ GAS DETECTION VENDOR TO ENSURE COMPLETE COVERAGE.



**1 DUCTWORK PLAN - TUNNEL & BASEMENT LEVELS, PHASE 2**  
SCALE: 1/4" = 1'-0"


PRINTS OF THIS DRAWING SHALL NOT BE USED FOR ANY PURPOSE WHATSOEVER WITHOUT THE SEAL AND SIGNATURE OF THE PROFESSIONAL ENGINEER.			<b>CONSULTANTS</b> <b>HAZARDOUS MATERIALS</b> MABBETT & ASSOCIATES, INC. 105 CENTRAL STREET, STONEHAM, MA 02180 PHONE: (781)275-8050 <b>CIVIL / STRUCTURAL</b> PROFESSIONAL ENGINEERING CONSULTANTS, P.A. 303 SOUTH TOPEKA, WICHITA, KS 67202 PHONE: (316)262-2691 <b>ARCHITECTURAL</b> OCULUS INC. 1 SOUTH MEMORIAL DRIVE, SUITE 1500, SAINT LOUIS, MO 63102 PHONE: (314)367-6100		<b>FIRE SUPPRESSION</b> KOFFEL ASSOCIATES 8815 CENTRE PARK DRIVE, SUITE 200, COLUMBIA, MD 21045 PHONE: (410)753-2246 <b>ELECTRONIC SECURITY</b> MAGNA ENGINEERS 861 CORPORATE DRIVE, SUITE 210, LEXINGTON, KY 40503 PHONE: (859)309-2990 <b>PHYSICAL SECURITY</b> FORCE PROTECT 3210 GULF BLVD, UNIT 304, BELLAIR BEACH, FL 33786 PHONE: (502)836-4232		<b>ENGINEER OF RECORD</b> <b>Miller-Remick LLC</b> M.E.P. & Structural Engineering A Service Disabled Veteran Owned Small Business 1010 KINGS HIGHWAY SOUTH CHERRY HILL, NEW JERSEY 08034 PHONE: (856)424-4000 FAX: (856)420-8002 MR PROJECT NO: 0499-0121		MILLER-REMIK LLC PROFESSIONAL ENGINEER 		Office of Construction and Facilities Management U.S. Department of Veterans Affairs		Drawing Title <b>MECHANICAL                  DUCTWORK PLAN                  TUNNEL &amp; BSMT LEVELS, PHASE 2</b> Approved: Project Director		Phase 100% BID SET FULLY SPRINKLERED		Project Title INSTALL NEW BOILERS IN BUILDING 13 Location ROBERT J. DOLE VA MEDICAL CENTER WICHITA, KANSAS Issue Date 2021-09-03 Checked AP Drawn GDS		Project Number 589A7-18-302 Building Number 13 Drawing Number 13-MH101.02	
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**GENERAL SHEET NOTES:**


- REFER TO DRAWING M-001 FOR NOTES, SYMBOLS AND ABBREVIATIONS.
- REFER TO DRAWINGS MP601, MP602, MP603 AND MP604 FOR SYSTEM FLOW DIAGRAMS.
- REFER TO DRAWINGS M-701, M-702, M-703 AND M-704 FOR EQUIPMENT SCHEDULES.
- CONTRACTOR SHALL SUBMIT A DETAILED LOCKOUT/TAGOUT PROCEDURE TO THE VA A MINIMUM OF 4 WORKING DAYS PRIOR TO PERFORMING ANY WORK ON ANY LIVE STEAM OR STEAM CONDENSATE SYSTEM.
- ALL VALVE HANDLES MUST BE ACCESSIBLE FROM A WALKABLE SURFACE. COORDINATE LOCATION WITH ALL TRADES.

**SHEET KEYNOTES:**

- INSTALL NEW TEMPORARY 4" DIA NATURAL GAS PIPING IN PHASE 1. REFER TO CIVIL DRAWINGS FOR CONTINUATION. NATURAL GAS PIPE TO BE A MINIMUM OF 24" BELOW RAMP FOOTINGS. COORDINATE WITH STRUCTURAL DRAWINGS.
- MOUNT CO DETECTORS 4'-6" AFF. CONFIRM QUANTITY AND LOCATION OF SENSORS W/ GAS DETECTION VENDOR TO ENSURE COMPLETE COVERAGE.
- BOTTOM OF DUCTWORK AND SUPPLY GRILLE SHALL BE MOUNTED MINIMUM 8'-0" AFF. DIRECT SUPPLY GRILLE AIR DOWNWARD 45 DEG. TOWARD FLOOR.
- 3/4" DIA CONDENSATE DRAIN PIPING: PITCH DOWNWARD IN DIRECTION OF FLOW MINIMUM 1/8 INCH PER FOOT. ROUTE DOWN TO WOP SINK. TERMINATE WITH AIR GAP.
- TRANSITION DUCTED LOUVER CONNECTION TO NEW GENERATOR PER MANUFACTURER'S RECOMMENDATIONS. FILED VERIFY OFFSET AND FINAL DIMENSIONS. REFER TO CONTROLS DETAIL FOR ADDITIONAL INFORMATION.
- PROVIDE NEW ATC PANEL WITH DEDICATED POWER THIS LOCATION. REFER TO ELECTRICAL DRAWINGS FOR ADDITIONAL INFORMATION.
- REFRIGERANT PIPING (SUCTION & LIQUID) UP THRU ROOF PIPE PORTAL. PROVIDE SEPARATE BOOT FOR EACH PIPE. ROUTE PER MANUFACTURER'S RECOMMENDATIONS. PROVIDE SUPPORTS AS REQUIRED.
- BOTTOM OF DUCT TO BE 6 INCHES ABOVE THE TOP OF THE OVERHEAD DOOR.
- INSTALL THERMOSTAT 52" AFF.
- CONTRACTOR SHALL PROVIDE (N+1) COMPLETE HVAC SYSTEMS FOR SECURITY M-10 AND IT ROOM M-12.
- GENERATOR EXHAUST MUFFLER.
- GENERATOR EXHAUST DISCHARGES UP. REFER TO DETAIL 12 ON DRAWING M-503. REFER TO STRUCTURAL DRAWINGS FOR SUPPORT DETAILS.

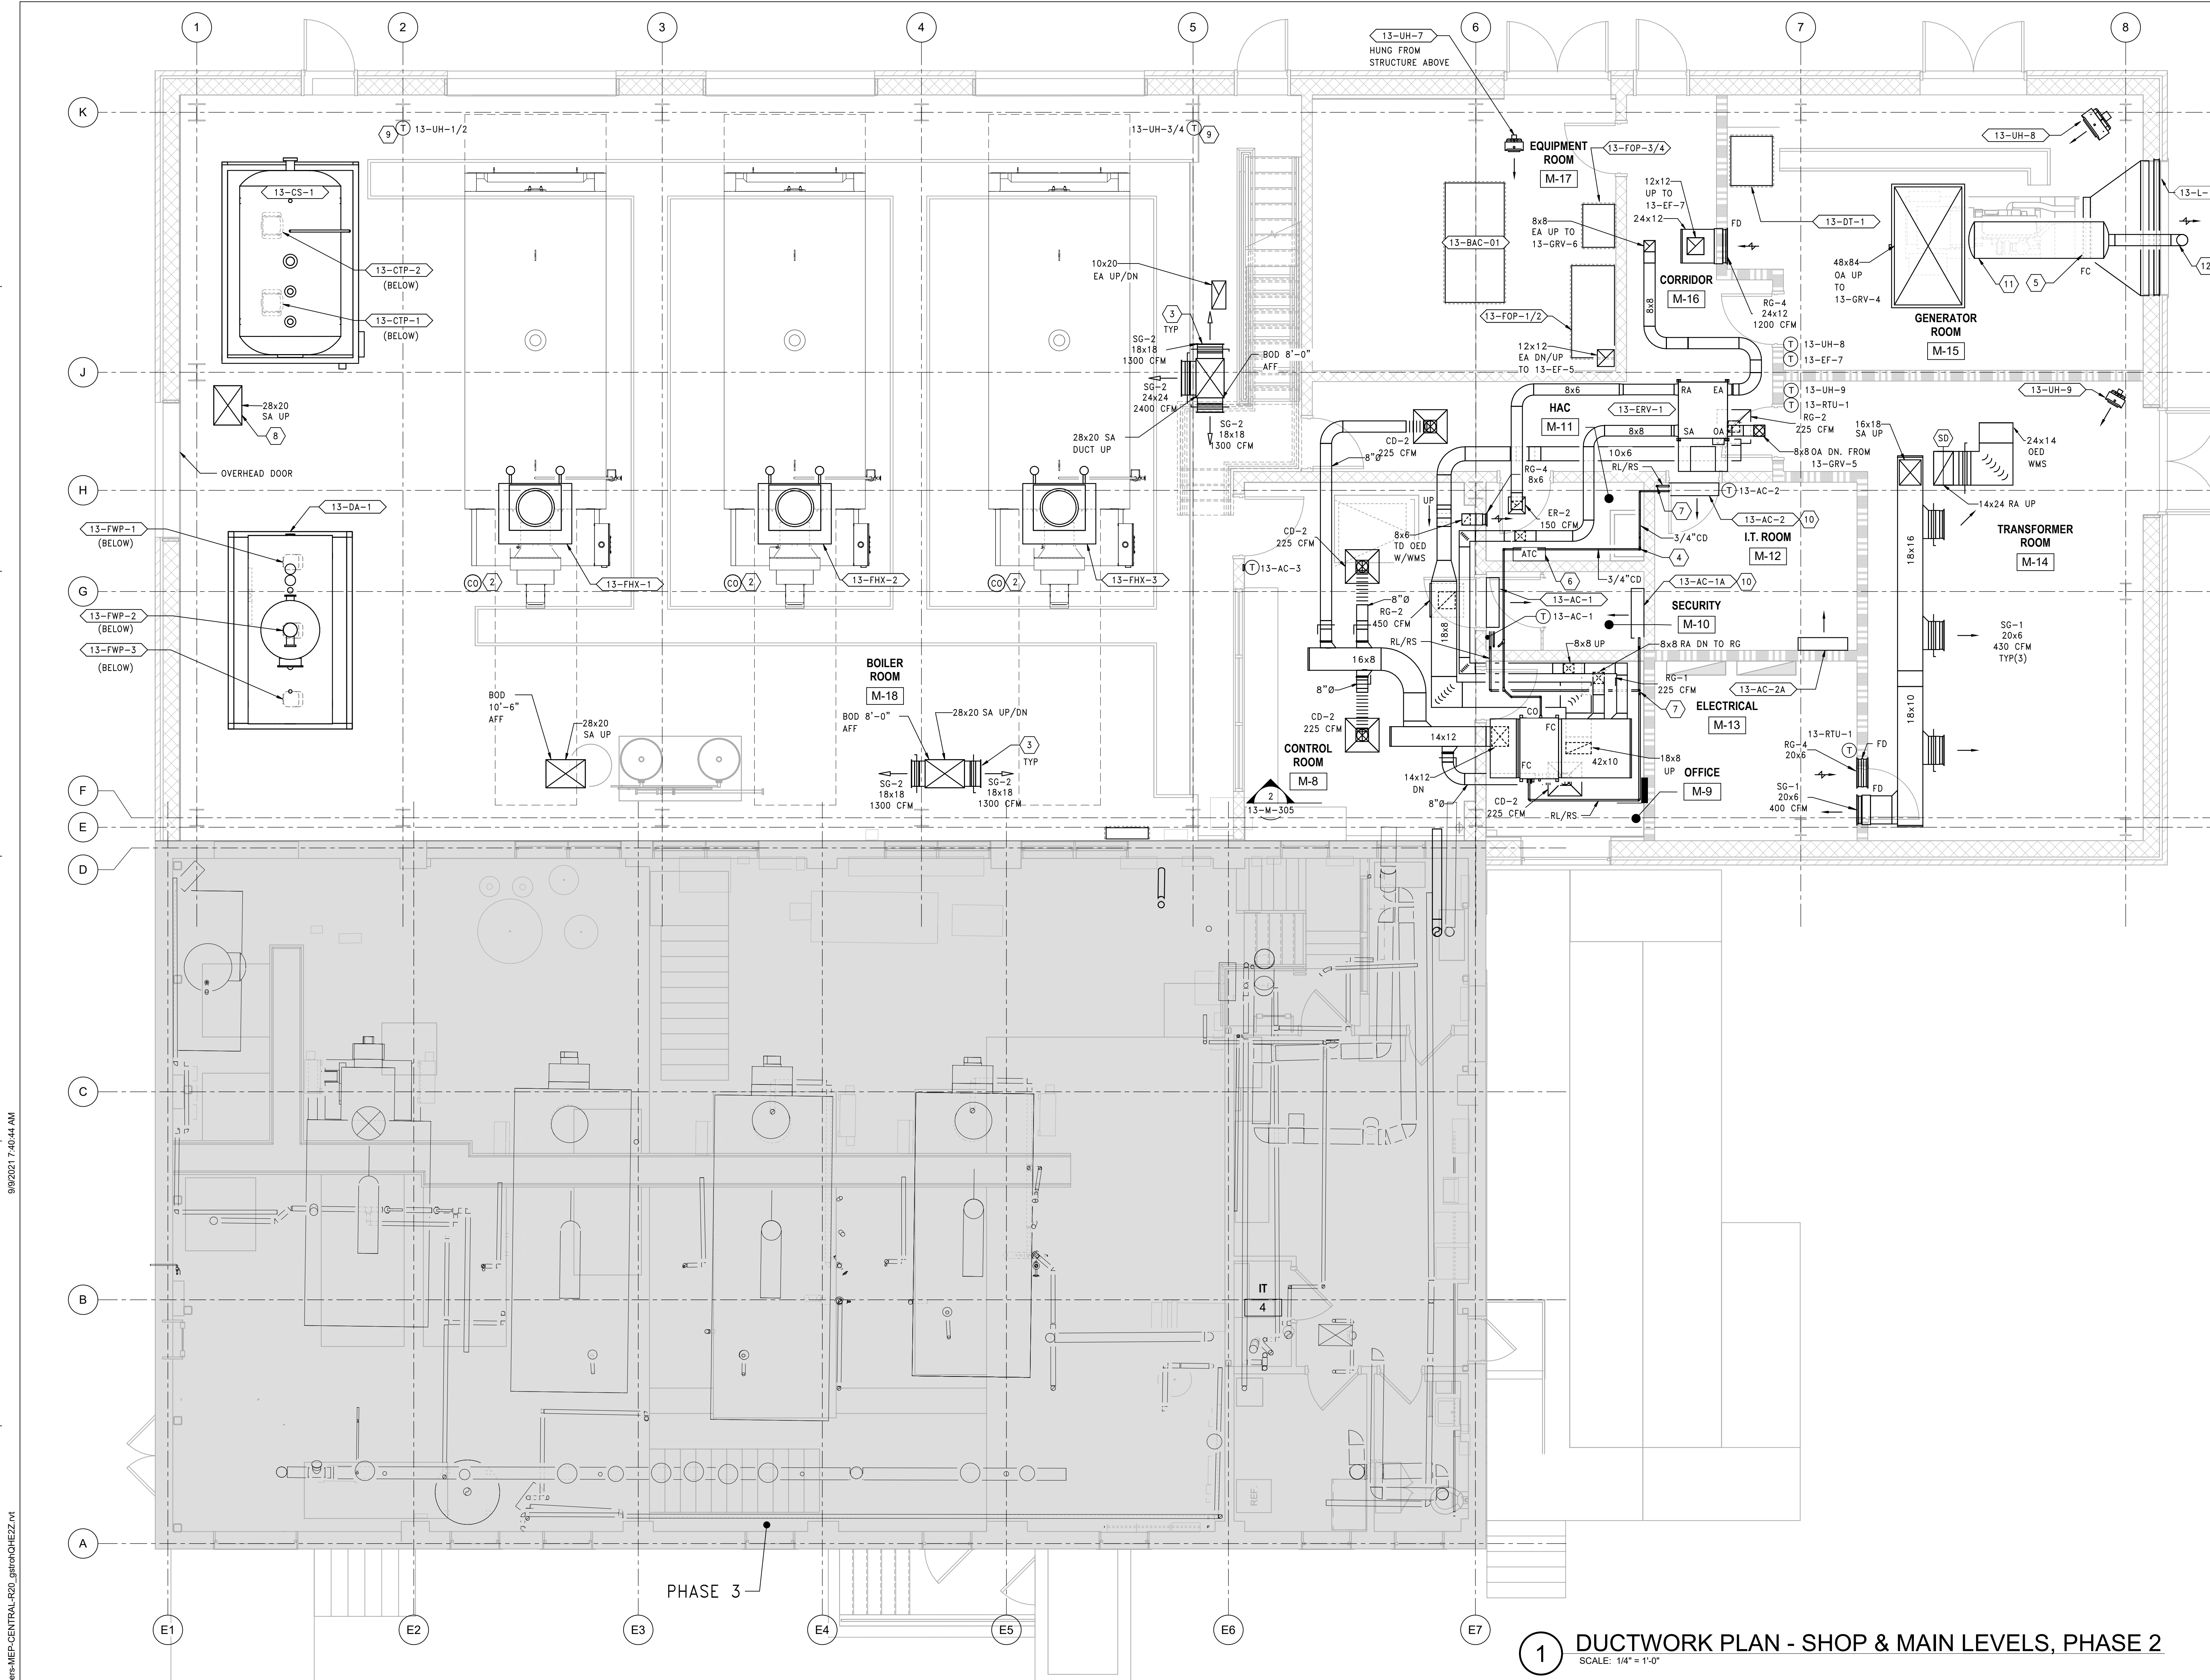

**1 DUCTWORK PLAN - SHOP & MAIN LEVELS, PHASE 2**  
SCALE: 1/4" = 1'-0"

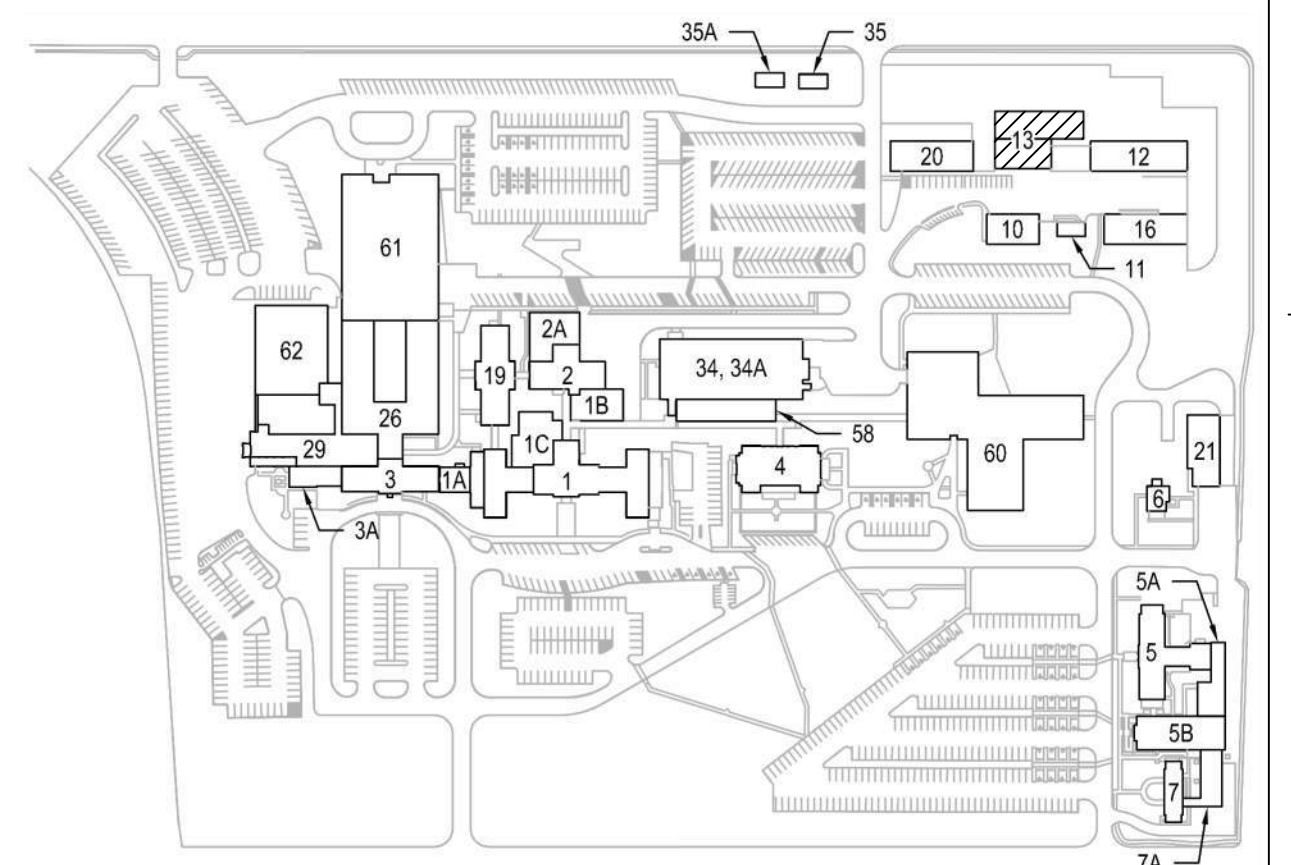

**KEYPLAN**

PRINTS OF THIS DRAWING SHALL NOT BE USED FOR ANY PURPOSE WHATSOEVER WITHOUT THE SEAL AND SIGNATURE OF THE PROFESSIONAL ENGINEER

NO.	DESCRIPTION	DATE

**CONSULTANTS**

<p><b>HAZARDOUS MATERIALS</b> MABBETT &amp; ASSOCIATES, INC. 105 CENTRAL STREET, STONEHAM, MA 02180 PHONE: (781)275-8050</p> <p><b>CIVIL/STRUCTURAL</b> PROFESSIONAL ENGINEERING CONSULTANTS, P.A. 303 SOUTH TOPEKA, WICHITA, KS 67202 PHONE: (316)262-2691</p> <p><b>ARCHITECTURAL</b> OCULUS INC. 1 SOUTH MEMORIAL DRIVE, SUITE 1500, SAINT LOUIS, MO 63102 PHONE: (314)367-6100</p>	<p><b>FIRE SUPPRESSION</b> KOFFEL ASSOCIATES 8815 CENTRE PARK DRIVE, SUITE 200, COLUMBIA, MD 21045 PHONE: (410)753-2246</p> <p><b>ELECTRONIC SECURITY</b> MAGNA ENGINEERS 861 CORPORATE DRIVE, SUITE 210, LEXINGTON, KY 40503 PHONE: (859)309-2990</p> <p><b>PHYSICAL SECURITY</b> FORCE PROTECT 3210 GULF BLVD, UNIT 304, BELLAIR BEACH, FL 33786 PHONE: (502)836-4232</p>
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**ENGINEER OF RECORD**

**Miller-Remick LLC**  
M.E.P. & Structural Engineering  
A Service Disabled Veteran Owned Small Business

1010 KINGS HIGHWAY SOUTH  
CHERRY HILL, NEW JERSEY 08034  
PHONE: (856)429-4000  
FAX: (856)429-5002  
MR PROJECT NO: 0499-0121

**MILLER-REMICK LLC**  
PROFESSIONAL ENGINEER

WIMONY D. PAKAR  
LICENSED PROFESSIONAL ENGINEER  
KANSAS  
26413  
9.3.2021

**Office of Construction and Facilities Management**

VA U.S. Department of Veterans Affairs

Drawing Title  
**MECHANICAL DUCTWORK PLAN SHOP & MAIN LEVELS, PHASE 2**

Approved: Project Director

Phase  
**100% BID SET**

**FULLY SPRINKLERED**

Project Title  
**INSTALL NEW BOILERS IN BUILDING 13**

Location  
ROBERT J. DOLE VA MEDICAL CENTER  
WICHITA, KANSAS

Issue Date  
2021-09-03

Checked  
AP

Drawn  
GDS

Project Number  
**589A7-18-302**

Building Number  
**13**


Drawing Number  
**13-MH111.02**

**GENERAL SHEET NOTES:**

1. REFER TO DRAWING M-001 FOR NOTES, SYMBOLS AND ABBREVIATIONS.
2. REFER TO DRAWINGS MP601, MP602, MP603 AND MP604 FOR SYSTEM FLOW DIAGRAMS.
3. REFER TO DRAWINGS M-701, M-702, M-703 AND M-704 FOR EQUIPMENT SCHEDULES.
4. CONTRACTOR SHALL SUBMIT A DETAILED LOCKOUT/TAGOUT PROCEDURE TO THE VA A MINIMUM OF 4 WORKING DAYS PRIOR TO PERFORMING ANY WORK ON ANY LIVE STEAM OR STEAM CONDENSATE SYSTEM.
5. ALL VALVE HANDLES MUST BE ACCESSIBLE FROM A WALKABLE SURFACE. COORDINATE LOCATION WITH ALL TRADES.

**SHEET KEYNOTES:**

1. MOUNT CO DETECTORS 4'-6" AFF. CONFIRM QUANTITY AND LOCATION OF SENSORS W/ GAS DETECTION VENDOR TO ENSURE COMPLETE COVERAGE.
2. MOUNT NATURAL GAS DETECTOR 12" BELOW CEILING. CONFIRM QUANTITY AND LOCATION OF SENSORS WITH GAS DETECTION VENDOR TO ENSURE COMPLETE COVERAGE.
3. INSTALL CO DETECTS AT BREATHING LEVEL ABOVE THE NEW CATWALK. CONFIRM QUANTITY AND LOCATION OF SENSORS WITH GAS DETECTION VENDOR TO ENSURE COMPLETE COVERAGE.
4. COORDINATE ROUTING OF DUCTWORK WITH ALL TRADES.
5. PROVIDE 3" DIA INTAKE AND EXHAUST CPVC PIPE CONNECTIONS TO 4" DIA CPVC CONCENTRIC VENT KIT FOR NEW CONDENSING HOT WATER HEATER. ROUTE AND INSTALL PER HOT WATER HEATER MANUFACTURER'S RECOMMENDATIONS AND INTERNATIONAL FUEL GAS CODE. EXTEND THRU ROOF MINIMUM 12". TERMINATE WITH RAIN CAP.
6. REFER TO SHEET 13-M-131.02 FOR ROOF PLAN NEW WORK THIS AREA.
7. INSTALL THERMOSTAT 52" AFF.

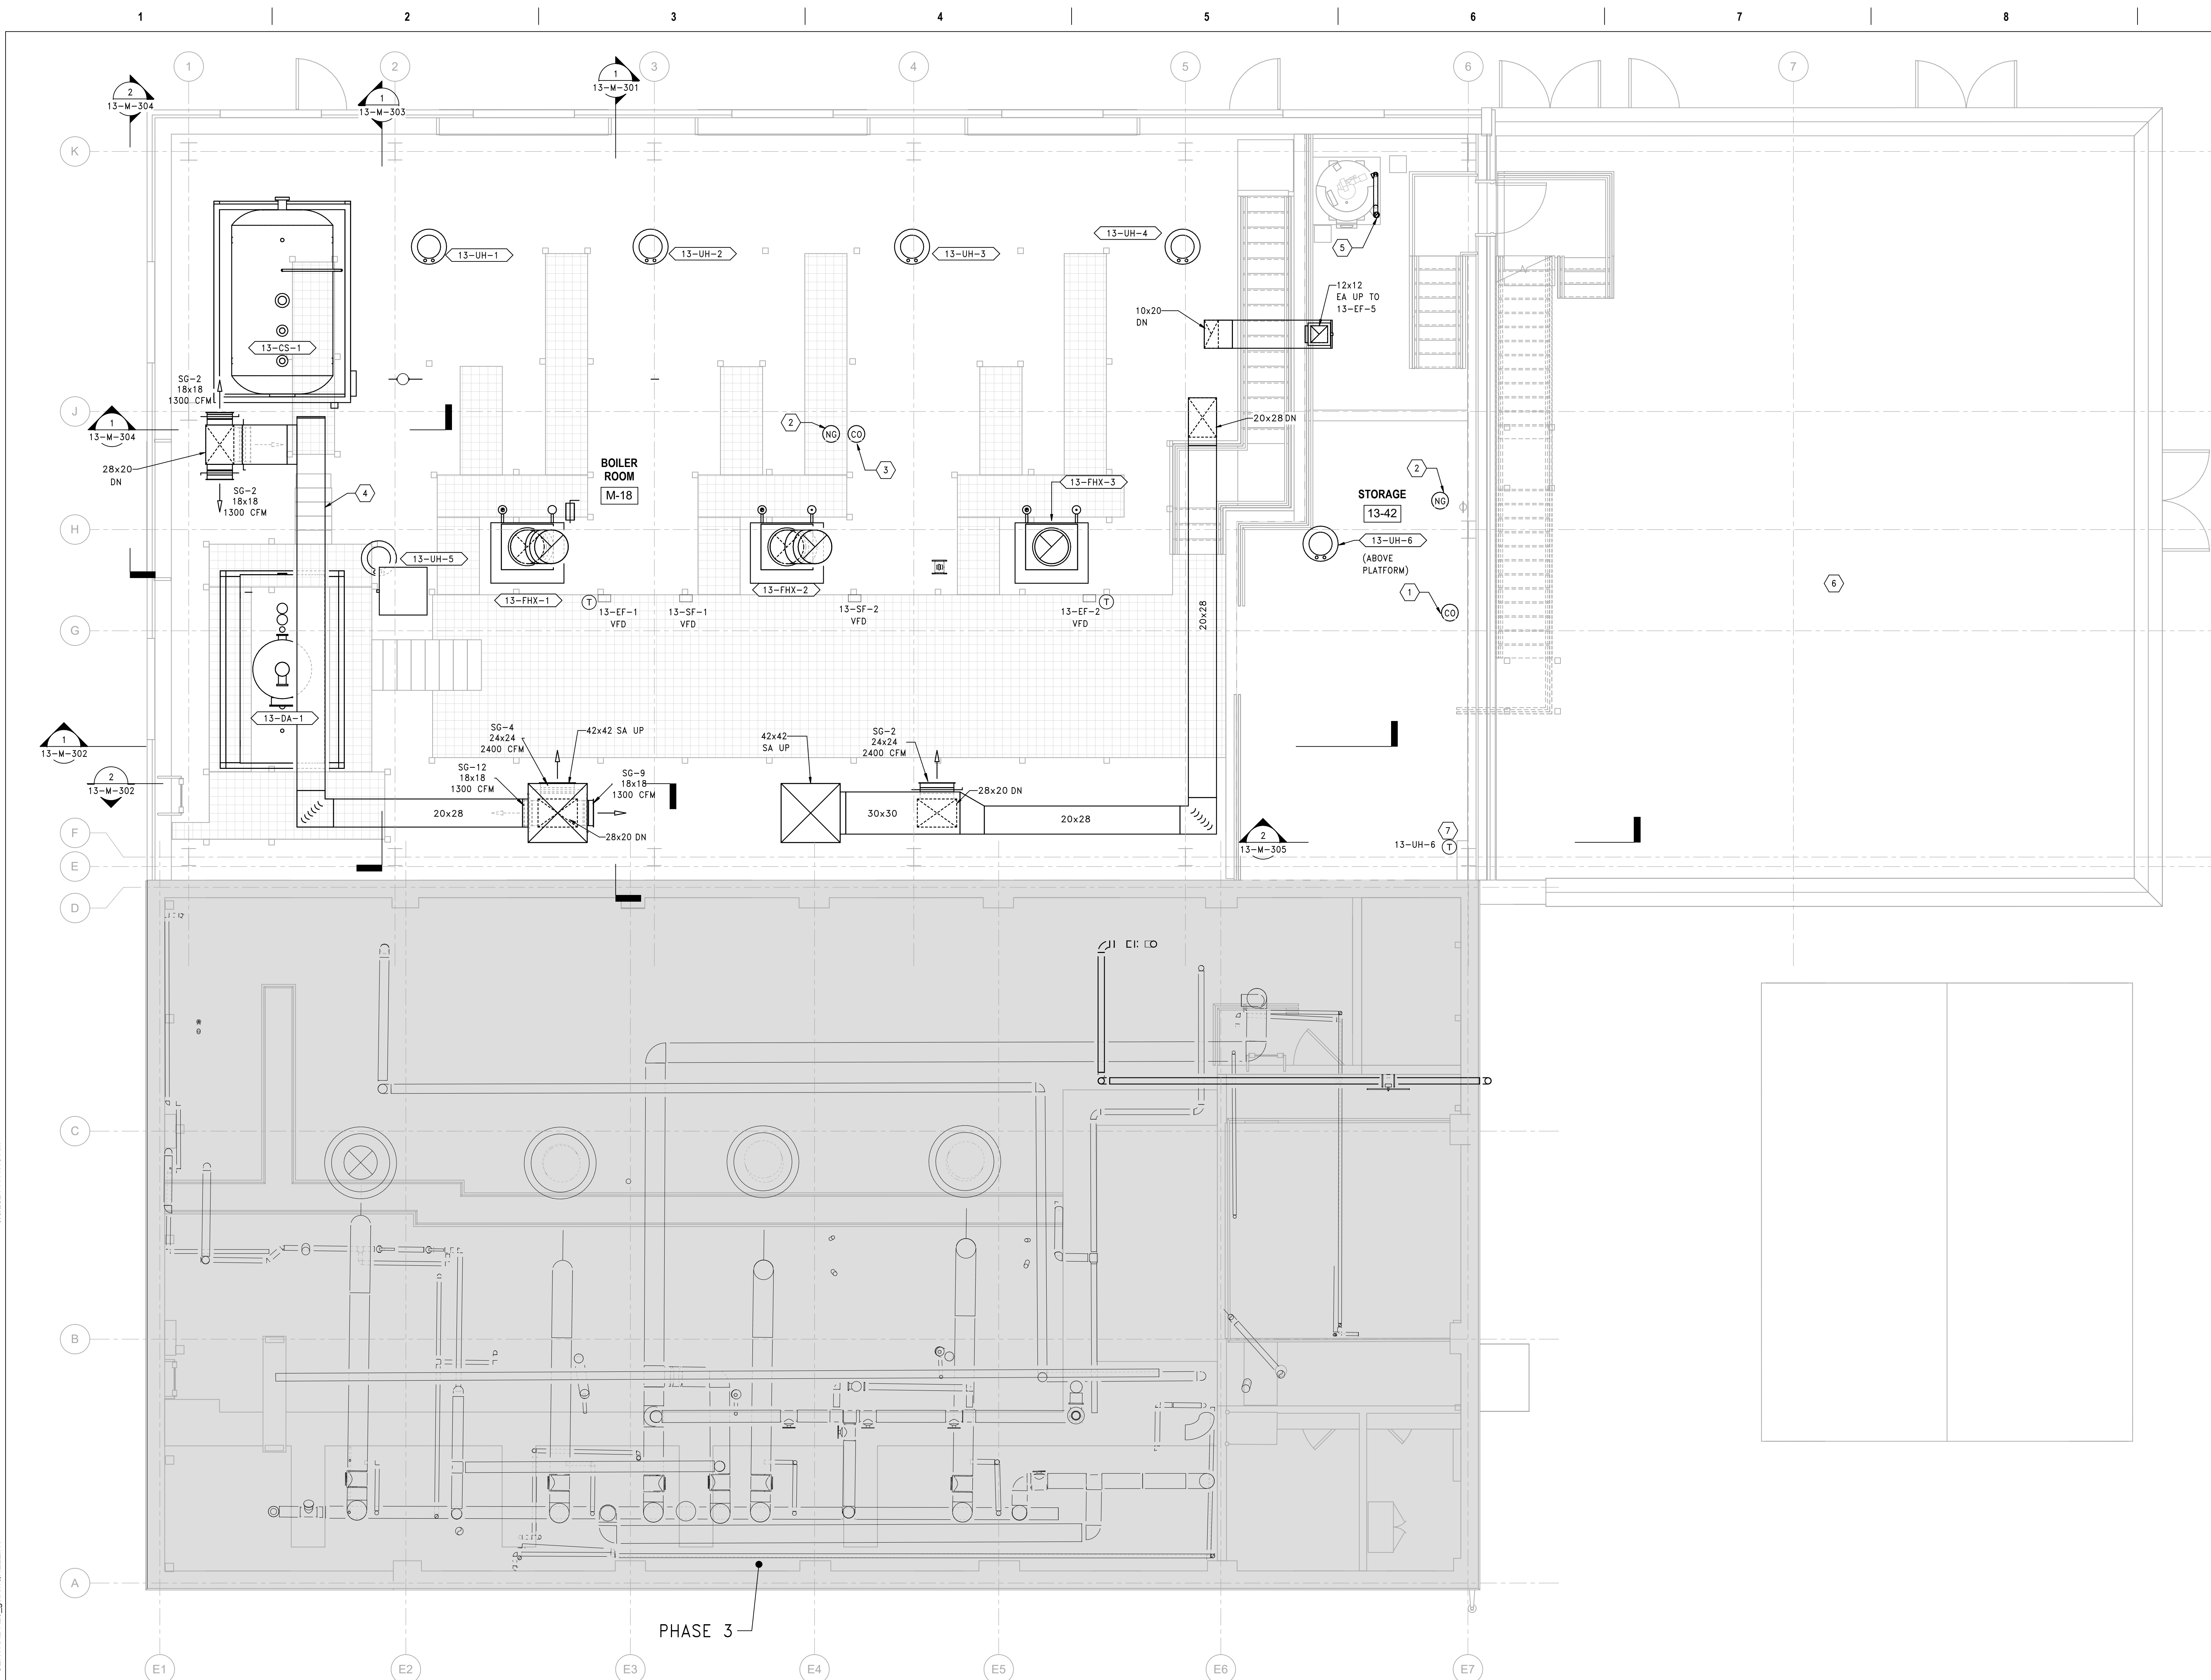

**1 DUCTWORK PLAN - EXISTING CATWALK & CATWALK LEVELS, PHASE 2**  
SCALE: 1/4" = 1'-0"

PRINTS OF THIS DRAWING SHALL NOT BE USED FOR ANY PURPOSE WHATSOEVER WITHOUT THE SEAL AND SIGNATURE OF THE PROFESSIONAL ENGINEER

NO.	DESCRIPTION	DATE

**CONSULTANTS**

<p><b>HAZARDOUS MATERIALS</b> MABBETT &amp; ASSOCIATES, INC. 105 CENTRAL STREET, STONEHAM, MA 02180 PHONE: (781)275-8050</p> <p><b>CIVIL / STRUCTURAL</b> PROFESSIONAL ENGINEERING CONSULTANTS, P.A. 303 SOUTH TOPEKA, WICHITA, KS 67202 PHONE: (316)262-2691</p> <p><b>ARCHITECTURAL</b> OCULUS INC. 1 SOUTH MEMORIAL DRIVE, SUITE 1500, SAINT LOUIS, MO 63102 PHONE: (314)367-6100</p>	<p><b>FIRE SUPPRESSION</b> KOFFEL ASSOCIATES 8815 CENTRE PARK DRIVE, SUITE 200, COLUMBIA, MD 21045 PHONE: (410)753-2246</p> <p><b>ELECTRONIC SECURITY</b> MAGNA ENGINEERS 861 CORPORATE DRIVE, SUITE 210, LEXINGTON, KY 40503 PHONE: (859)309-2990</p> <p><b>PHYSICAL SECURITY</b> FORCE PROTECT 3210 GULF BLVD, UNIT 304, BELLAIR BEACH, FL 33786 PHONE: (502)836-4232</p>
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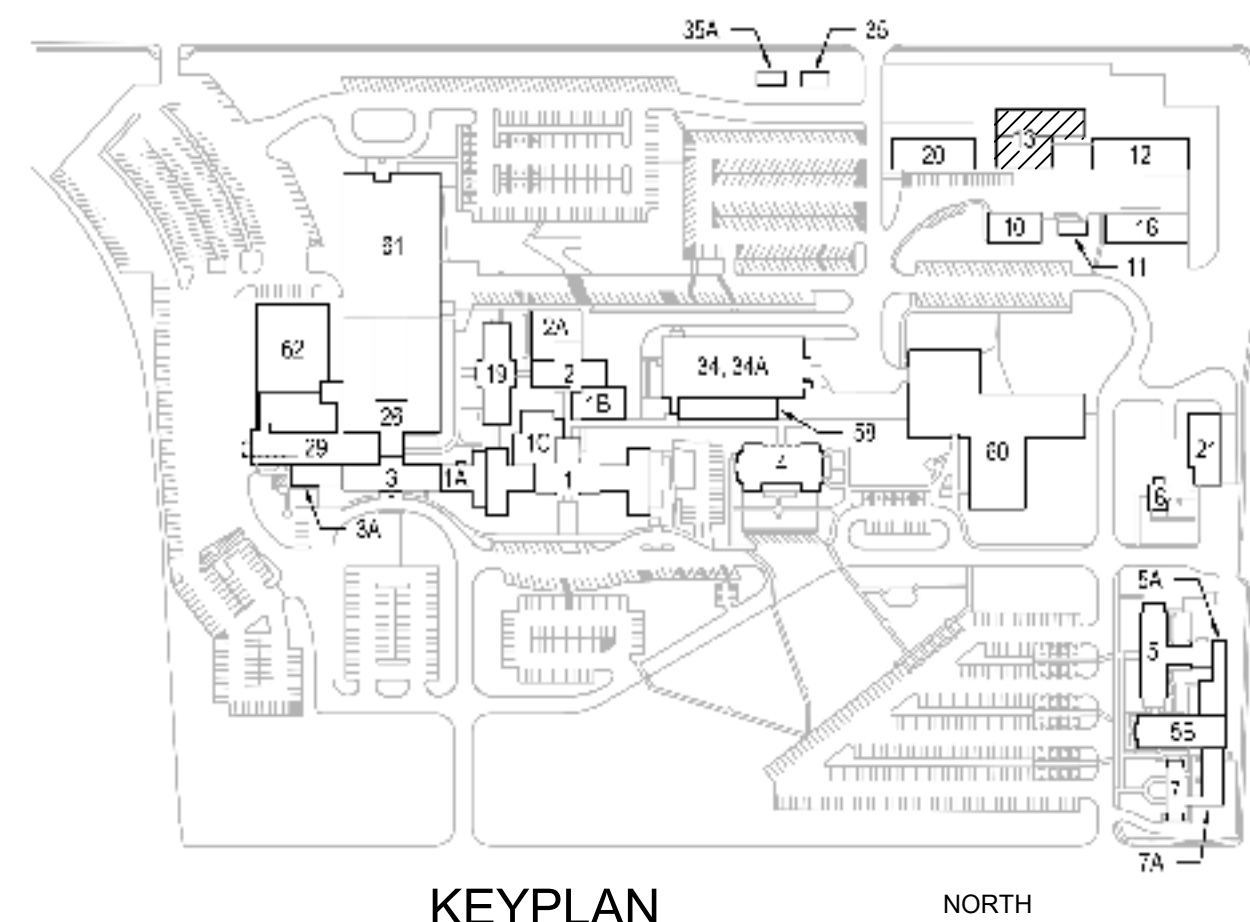
**ENGINEER OF RECORD**

<p><b>Miller-Remick LLC</b> M.E.P. &amp; Structural Engineering A Service Disabled Veteran Owned Small Business 1010 KINGS HIGHWAY SOUTH CHERRY HILL, NEW JERSEY 08034 PHONE: (856)424-4000 FAX: (856)420-8002 MR PROJECT NO: 0499-0121</p>	<p><b>MILLER-REMIK LLC</b> PROFESSIONAL ENGINEER ANTHONY D. PACIPO LICENSED PROFESSIONAL ENGINEER KANSAS 09-3-2021</p>
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<p><b>Office of Construction and Facilities Management</b> VA U.S. Department of Veterans Affairs</p>	<p>Phase 100% BID SET</p>
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<p>Drawing Title <b>MECHANICAL DUCTWORK PLAN EX CATWALK &amp; CATWALK LVLS, PH 2</b></p> <p>Approved: Project Director</p>	<p>Project Title <b>INSTALL NEW BOILERS IN BUILDING 13</b></p> <p>Location ROBERT J. DOLE VA MEDICAL CENTER WICHITA, KANSAS</p> <p>Issue Date 2021-09-03</p> <p>Checked AP</p> <p>Drawn GDS</p>
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<p>Project Number 589A7-18-302</p> <p>Building Number 13</p> <p>Drawing Number 13-MH121.02</p>
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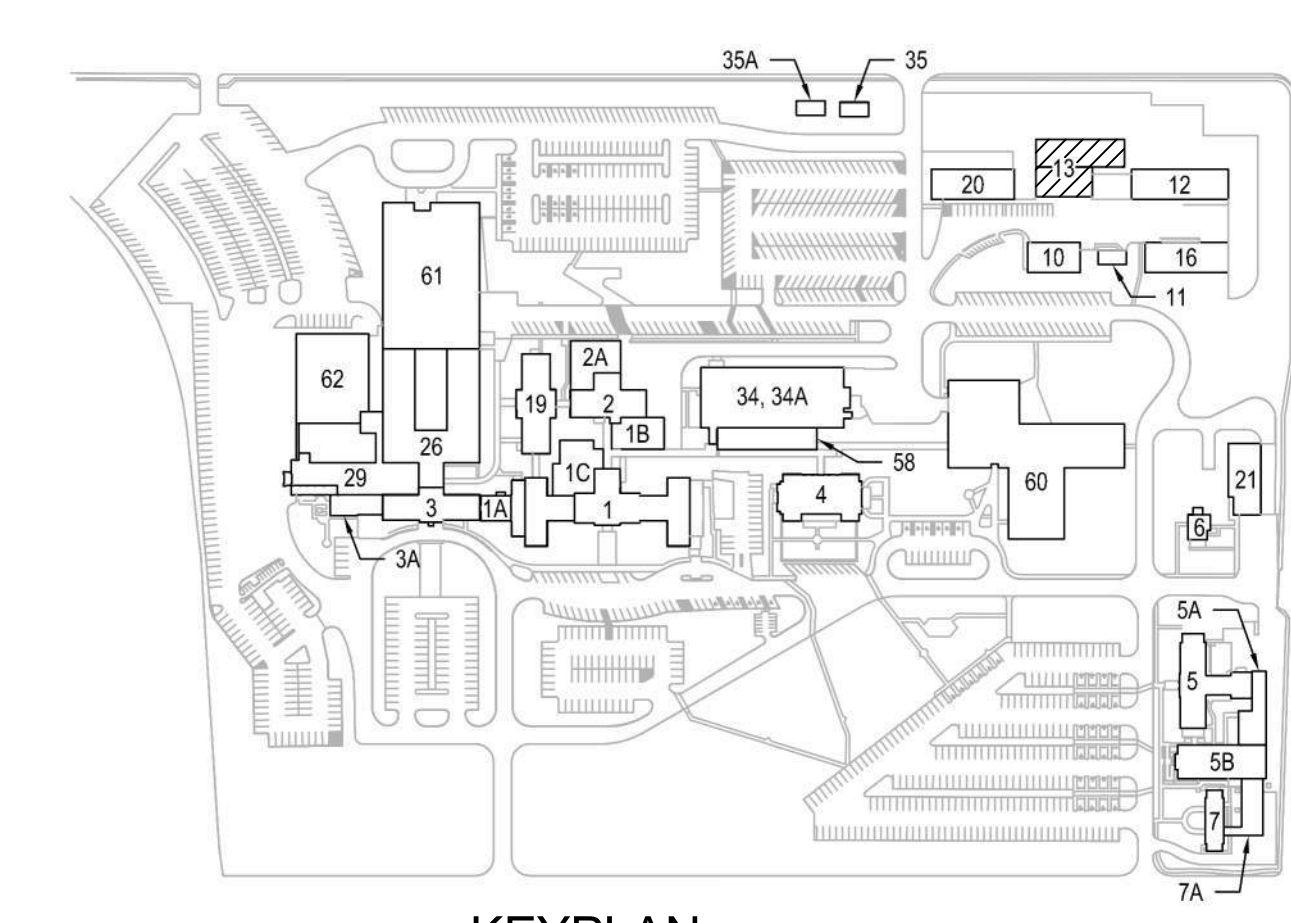
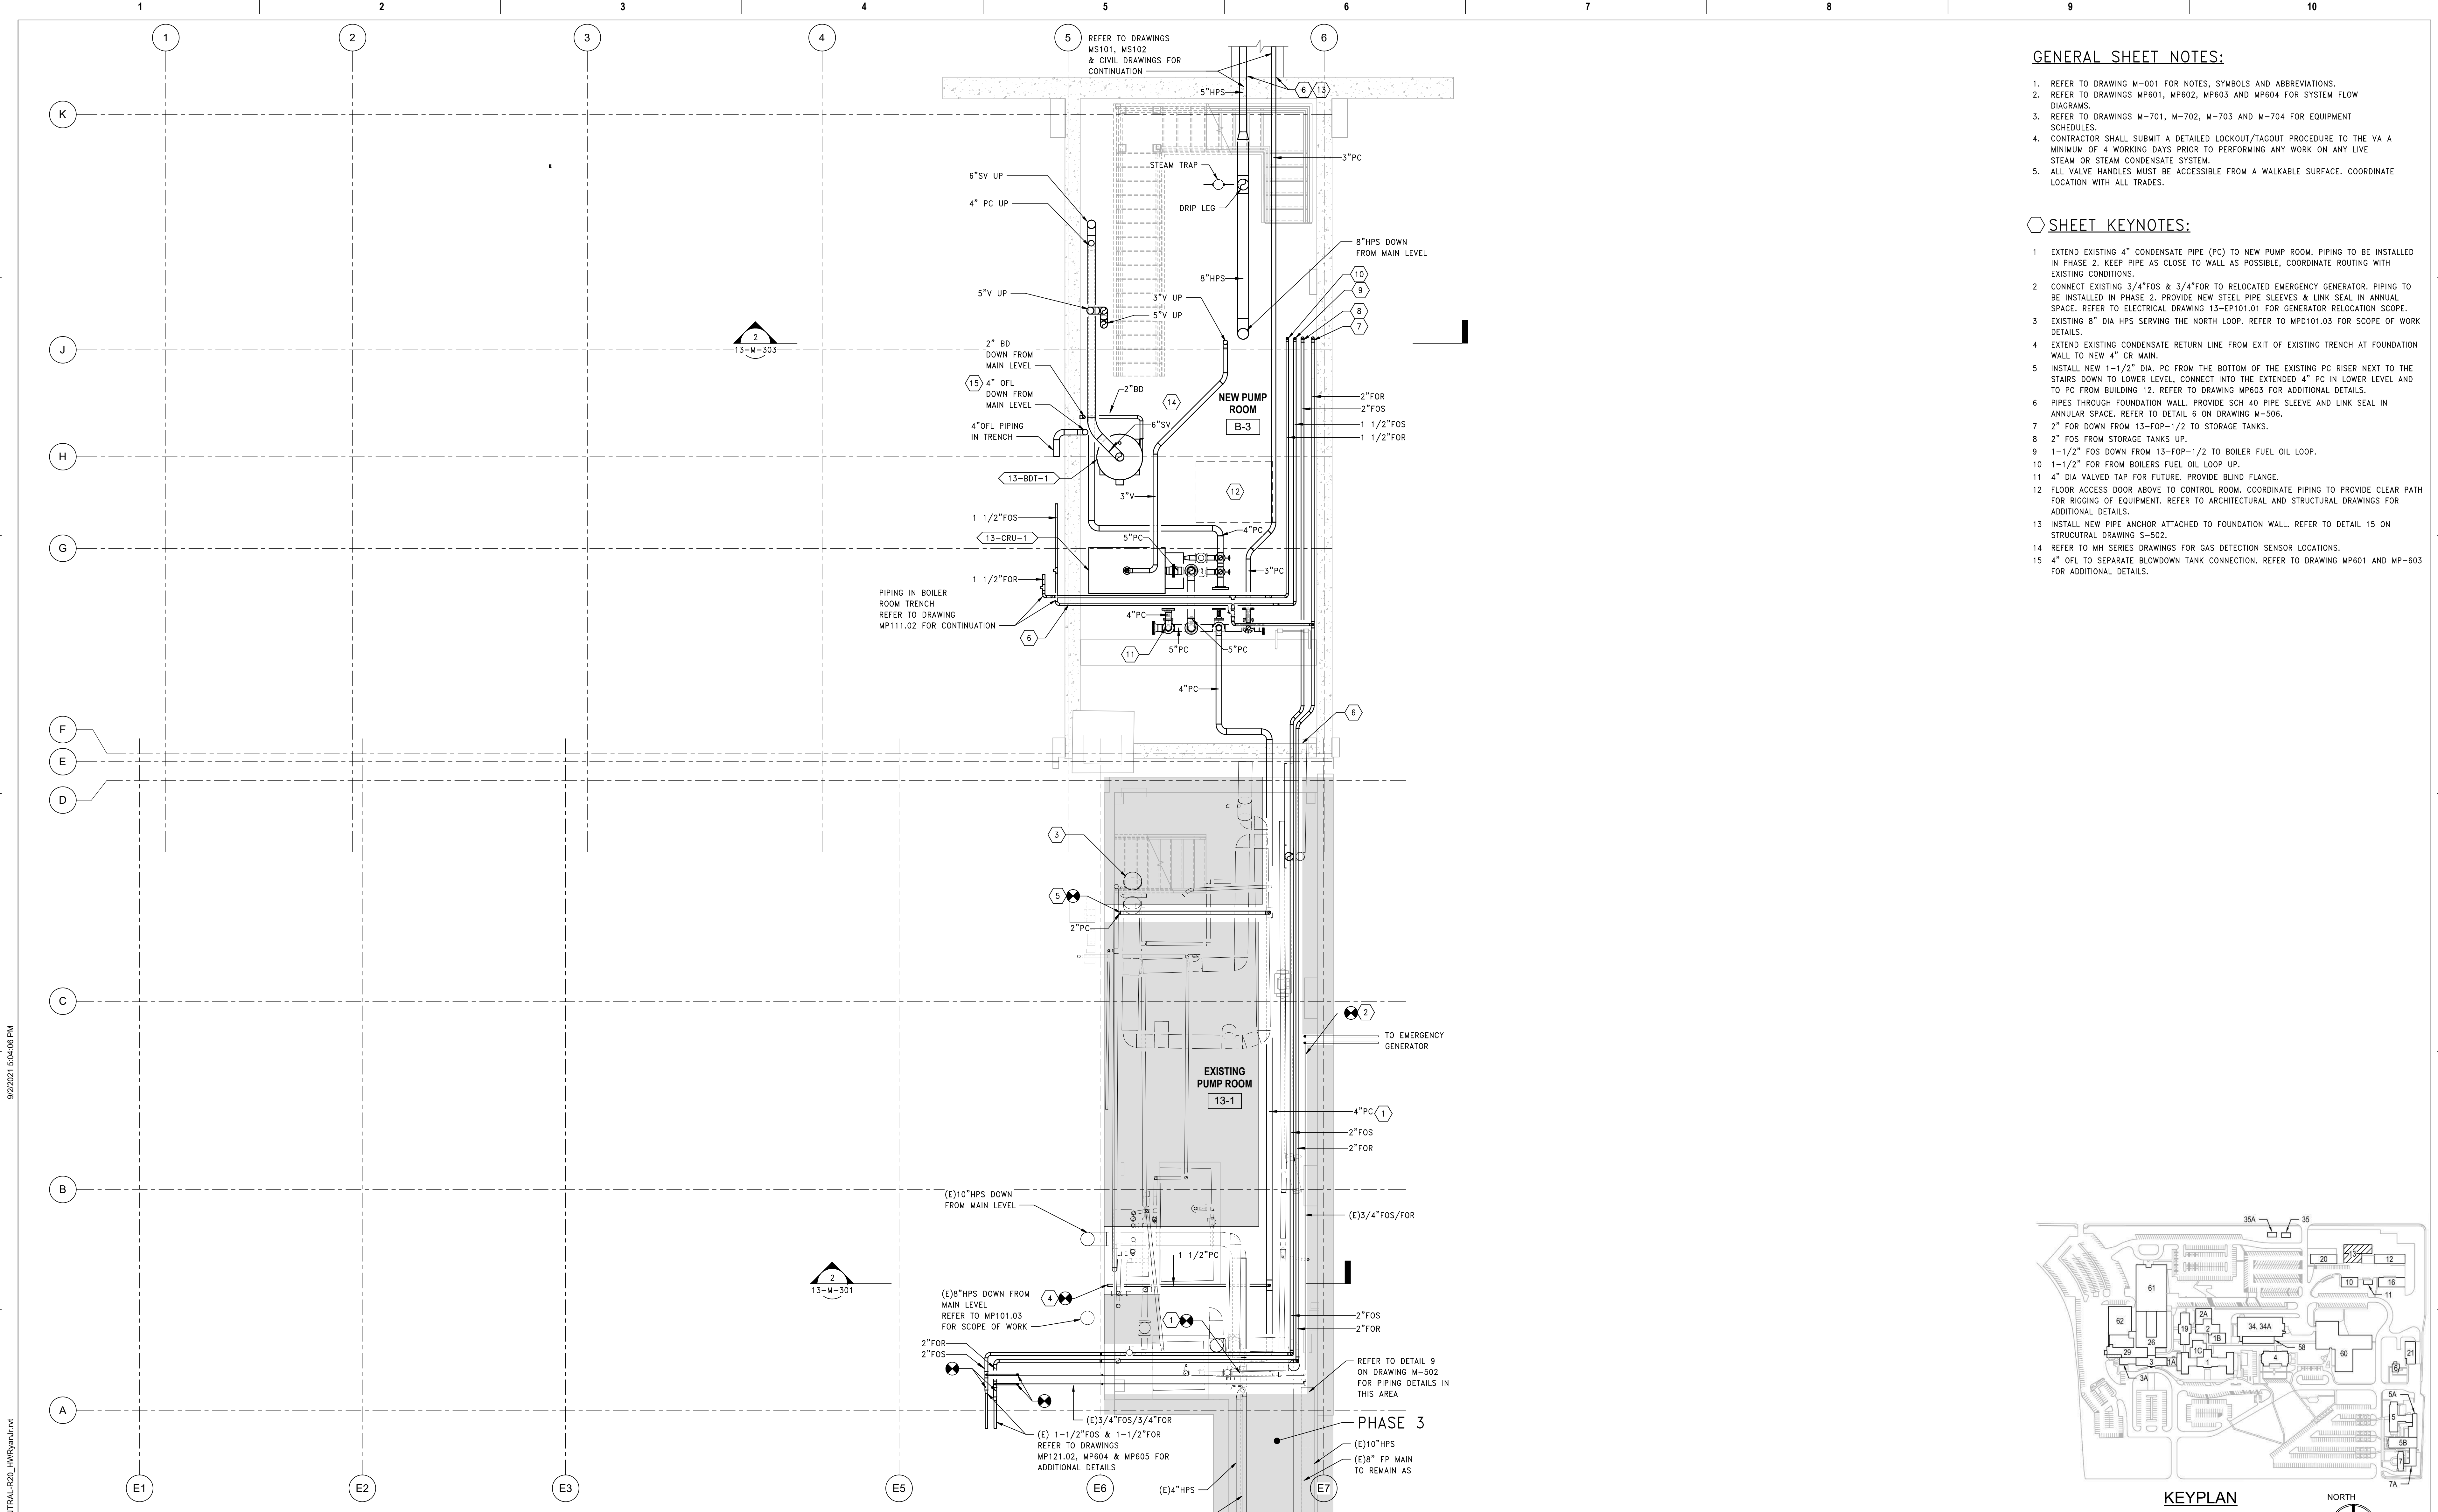
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 twenty seven inches = one foot  
 twenty eight inches = one foot  
 twenty nine inches = one foot  
 thirty inches = one foot

**GENERAL SHEET NOTES:**

- REFER TO DRAWING M-001 FOR NOTES, SYMBOLS AND ABBREVIATIONS.
- REFER TO DRAWINGS MP601, MP602, MP603 AND MP604 FOR SYSTEM FLOW DIAGRAMS.
- REFER TO DRAWINGS M-701, M-702, M-703 AND M-704 FOR EQUIPMENT SCHEDULES.
- CONTRACTOR SHALL SUBMIT A DETAILED LOCKOUT/TAGOUT PROCEDURE TO THE VA A MINIMUM OF 4 WORKING DAYS PRIOR TO PERFORMING ANY WORK ON ANY LIVE STEAM OR STEAM CONDENSATE SYSTEM.
- ALL VALVE HANDLES MUST BE ACCESSIBLE FROM A WALKABLE SURFACE. COORDINATE LOCATION WITH ALL TRADES.

**SHEET KEYNOTES:**

- EXTEND EXISTING 4" CONDENSATE PIPE (PC) TO NEW PUMP ROOM. PIPING TO BE INSTALLED IN PHASE 2. KEEP PIPE AS CLOSE TO WALL AS POSSIBLE, COORDINATE ROUTING WITH EXISTING CONDITIONS.
- CONNECT EXISTING 3/4" FOS & 3/4" FOR TO RELOCATED EMERGENCY GENERATOR. PIPING TO BE INSTALLED IN PHASE 2. PROVIDE NEW STEEL PIPE SLEEVES & LINK SEAL IN ANNUAL SPACE. REFER TO ELECTRICAL DRAWING 13-EP101.01 FOR GENERATOR RELOCATION SCOPE.
- EXISTING 8" DIA HPS SERVING THE NORTH LOOP. REFER TO MPD101.03 FOR SCOPE OF WORK DETAILS.
- EXTEND EXISTING CONDENSATE RETURN LINE FROM EXIT OF EXISTING TRENCH AT FOUNDATION WALL TO NEW 4" CR MAIN.
- INSTALL NEW 1-1/2" DIA. PC FROM THE BOTTOM OF THE EXISTING PC RISER NEXT TO THE STAIRS DOWN TO LOWER LEVEL, CONNECT INTO THE EXTENDED 4" PC IN LOWER LEVEL AND TO PC FROM BUILDING 12. REFER TO DRAWING MP603 FOR ADDITIONAL DETAILS.
- PIPES THROUGH FOUNDATION WALL: PROVIDE SCH. 40 PIPE SLEEVE AND LINK SEAL IN ANNUAL SPACE. REFER TO DETAIL 6 ON DRAWING M-506.
- 2" FOR DOWN FROM 13-FOP-1/2 TO STORAGE TANKS.
- 2" FOS FROM STORAGE TANKS UP.
- 1-1/2" FOS DOWN FROM 13-FOP-1/2 TO BOILER FUEL OIL LOOP.
- 1-1/2" FOS FROM BOILERS FUEL OIL LOOP UP.
- 4" DIA VALVED TAP FOR FUTURE. PROVIDE BLIND FLANGE.
- FLOOR ACCESS DOOR ABOVE TO CONTROL ROOM. COORDINATE PIPING TO PROVIDE CLEAR PATH FOR RIGGING OF EQUIPMENT. REFER TO ARCHITECTURAL AND STRUCTURAL DRAWINGS FOR ADDITIONAL DETAILS.
- INSTALL NEW PIPE ANCHOR ATTACHED TO FOUNDATION WALL. REFER TO DETAIL 15 ON STRUCTURAL DRAWING S-502.
- REFER TO MH SERIES DRAWINGS FOR GAS DETECTION SENSOR LOCATIONS.
- 4" OFL TO SEPARATE BLOWDOWN TANK CONNECTION. REFER TO DRAWING MP601 AND MP-603 FOR ADDITIONAL DETAILS.



**1 PIPING PLAN - TUNNEL & BASEMENT LEVELS, PHASE 2**  
SCALE: 1/4" = 1'-0"

PRINTS OF THIS DRAWING SHALL NOT BE USED FOR ANY PURPOSE WHATSOEVER WITHOUT THE SEAL AND SIGNATURE OF THE PROFESSIONAL ENGINEER

NO.	DESCRIPTION	DATE

CONSULTANTS	
<b>HAZARDOUS MATERIALS</b> MABBETT & ASSOCIATES, INC. 105 CENTRAL STREET, STONEHAM, MA 02180 PHONE: (781)275-8555 <b>CIVIL / STRUCTURAL</b> PROFESSIONAL ENGINEERING CONSULTANTS, P.A. 303 SOUTH TOPEKA, WICHITA, KS 67202 PHONE: (316)262-2691 <b>ARCHITECTURAL</b> OCULUS INC. 1 SOUTH MEMORIAL DRIVE, SUITE 1500, SAINT LOUIS, MO 63102 PHONE: (314)367-8100	<b>FIRE SUPPRESSION</b> KOFFEL ASSOCIATES 8815 CENTRE PARK DRIVE, SUITE 200, COLUMBIA, MD 21045 PHONE: (410)759-2246 <b>ELECTRONIC SECURITY</b> MAGNA ENGINEERS 861 CORPORATE DRIVE, SUITE 210, LEXINGTON, KY 40503 PHONE: (859)309-2990 <b>PHYSICAL SECURITY</b> FORCE PROTECT 3210 GULF BLVD, UNIT 304, BELLEAIR BEACH, FL 33786 PHONE: (502)836-4232

**ENGINEER OF RECORD**

**Miller-Remick LLC**  
 M.E.P. & Structural Engineering  
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 FAX: (856)439-9002  
 MR PROJECT NO: 0499-0121

**MILLER-REMICK LLC**  
 PROFESSIONAL ENGINEER

ANTHONY D. PACIARO  
 LICENSED PROFESSIONAL ENGINEER  
 26413  
 2/3/2021

**Office of Construction and Facilities Management**

**VA** U.S. Department of Veterans Affairs

Drawing Title  
**MECHANICAL PIPING PLAN TUNNEL & BSMT LEVELS, PHASE 2**

Approved: Project Director

Phase  
**100% BID SET**

**FULLY SPRINKLERED**

Project Title  
**INSTALL NEW BOILERS IN BUILDING 13**

Location  
**ROBERT J. DOLE VA MEDICAL CENTER WICHITA, KANSAS**

Issue Date  
**2021-09-03**

Checked  
**AP**


Drawn  
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Project Number  
**589A7-18-302**

Building Number  
**13**


Drawing Number  
**13-MP101.02**



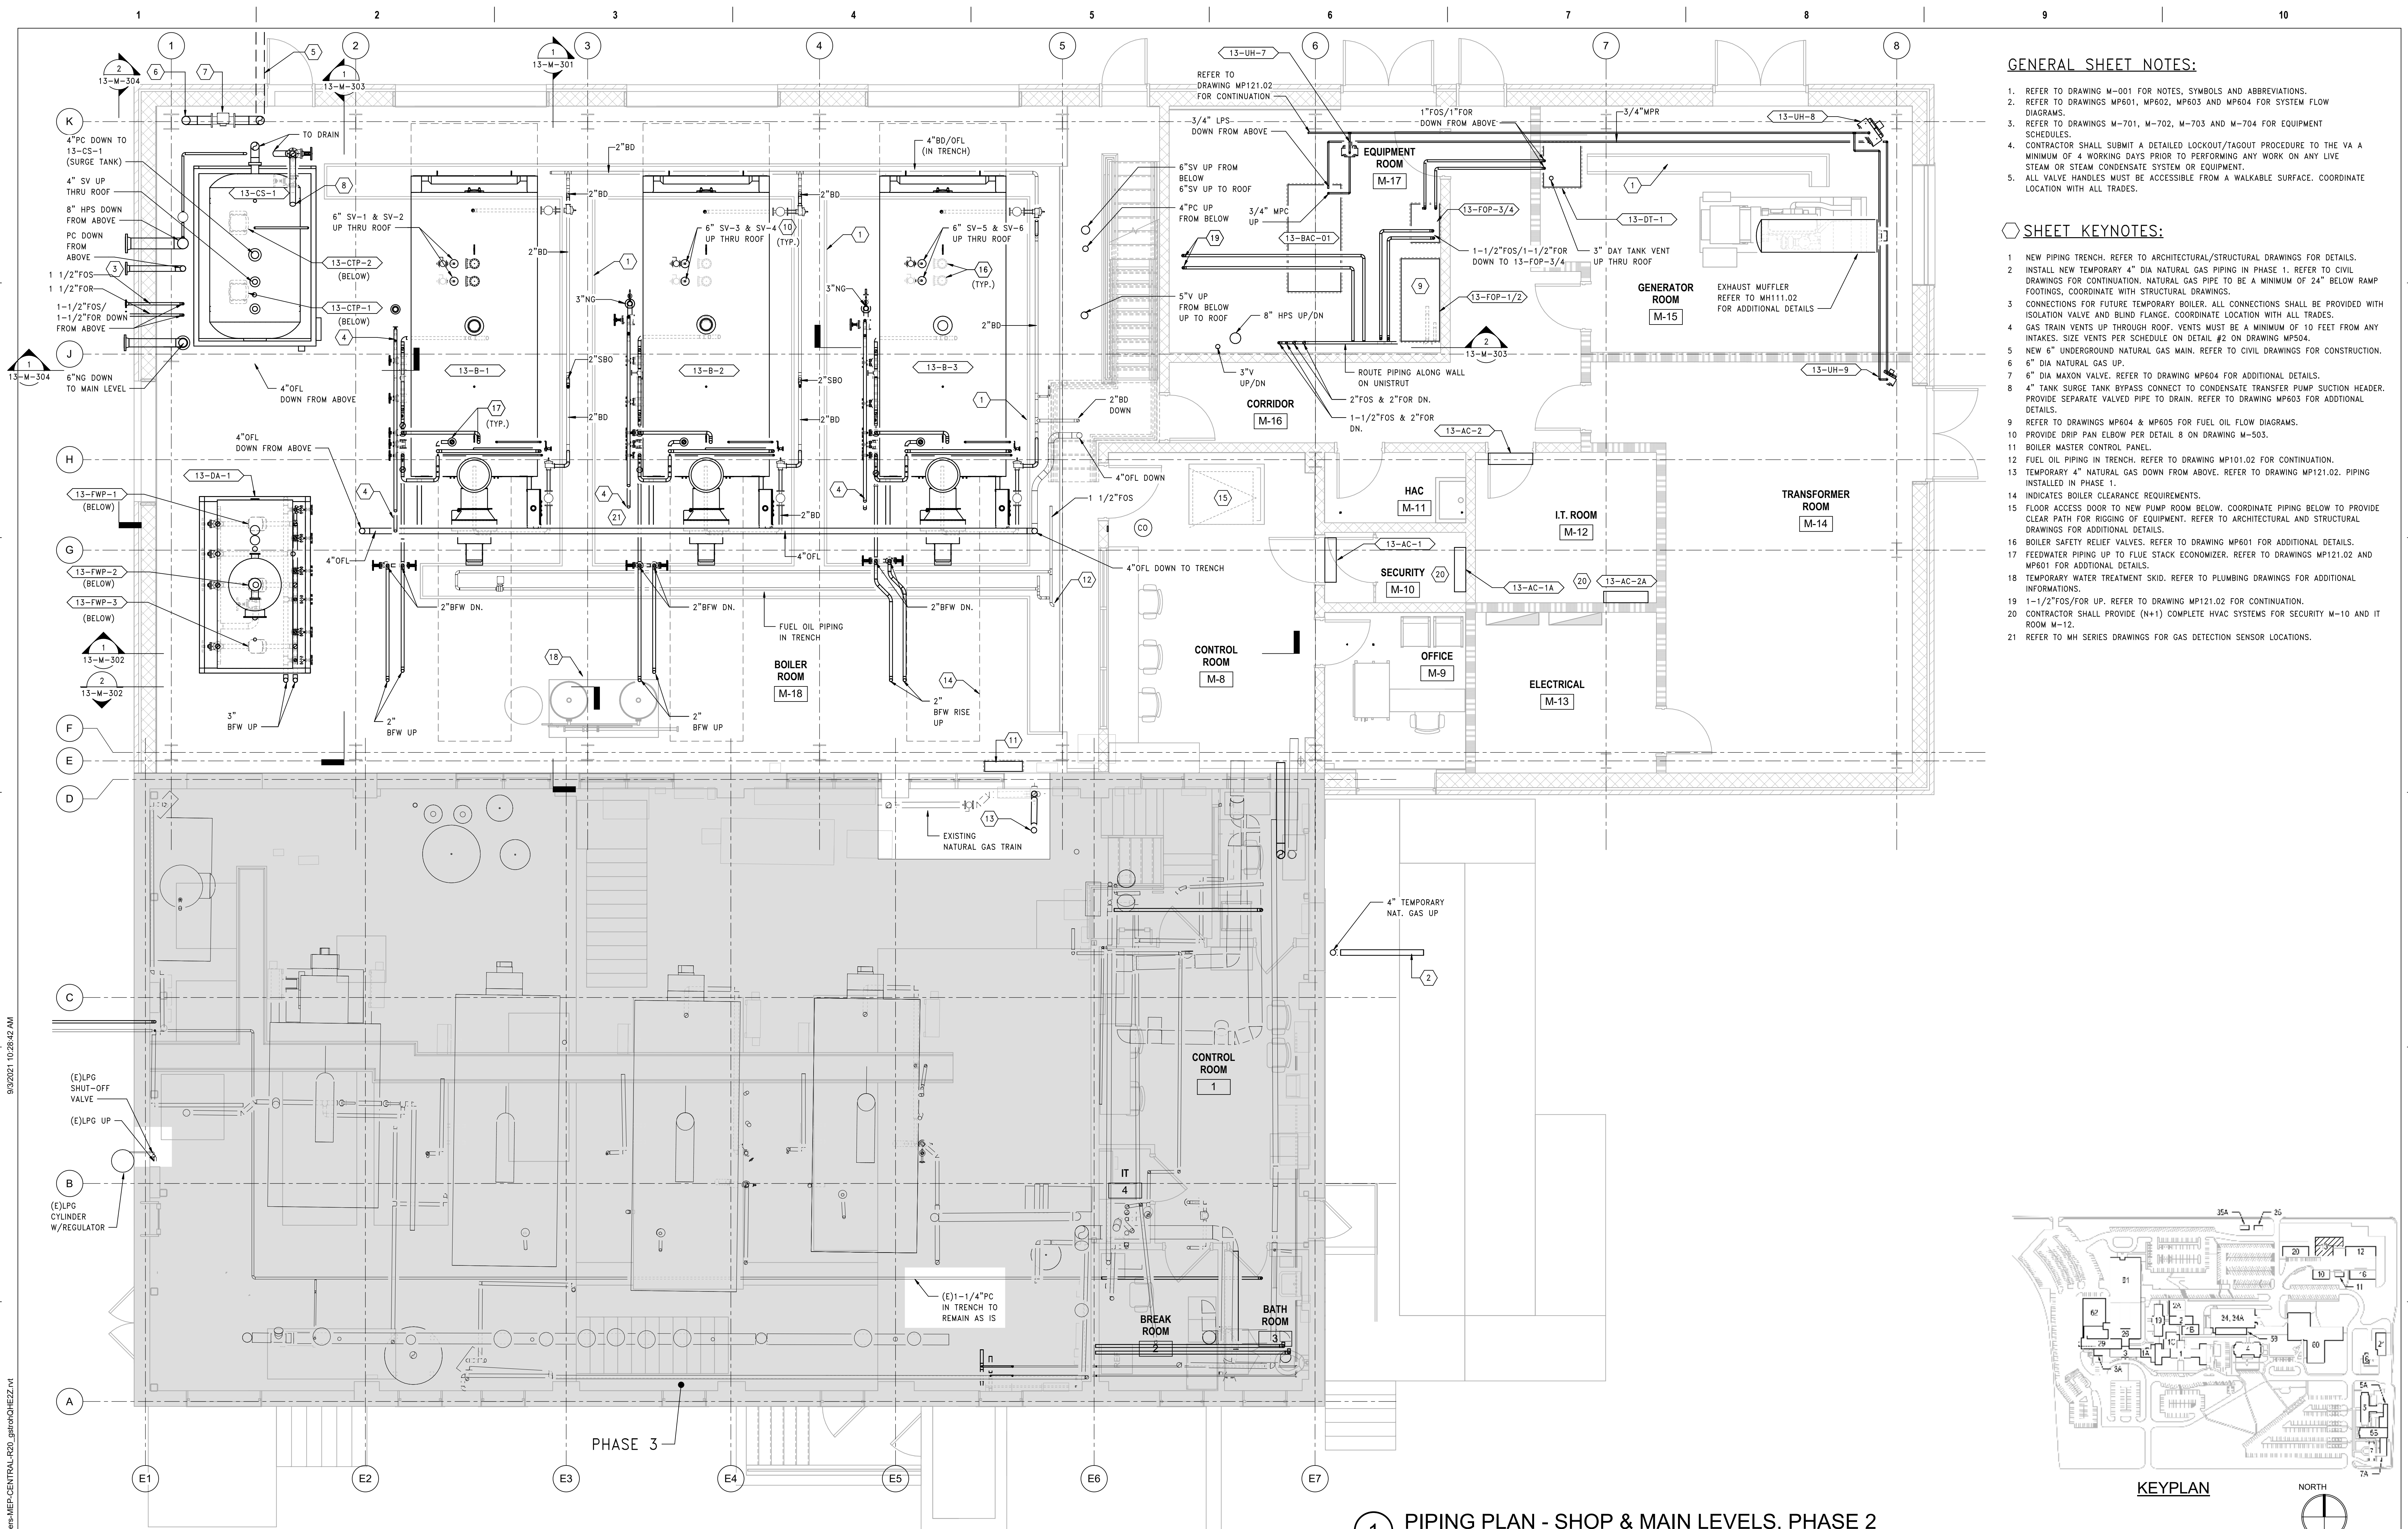

**GENERAL SHEET NOTES:**

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  - REFER TO DRAWINGS MP601, MP602, MP603 AND MP604 FOR SYSTEM FLOW DIAGRAMS.
  - REFER TO DRAWINGS M-701, M-702, M-703 AND M-704 FOR EQUIPMENT SCHEDULES.
  - CONTRACTOR SHALL SUBMIT A DETAILED LOCKOUT/TAGOUT PROCEDURE TO THE VA A MINIMUM OF 4 WORKING DAYS PRIOR TO PERFORMING ANY WORK ON ANY LIVE STEAM OR STEAM CONDENSATE SYSTEM OR EQUIPMENT.
  - ALL VALVE HANDLES MUST BE ACCESSIBLE FROM A WALKABLE SURFACE. COORDINATE LOCATION WITH ALL TRADES.
- SHEET KEYNOTES:**
- NEW PIPING TRENCH. REFER TO ARCHITECTURAL/STRUCTURAL DRAWINGS FOR DETAILS.
  - INSTALL NEW TEMPORARY 4" DIA NATURAL GAS PIPING IN PHASE 1. REFER TO CIVIL DRAWINGS FOR CONTINUATION. NATURAL GAS PIPE TO BE A MINIMUM OF 24" BELOW RAMP FOOTINGS, COORDINATE WITH STRUCTURAL DRAWINGS.
  - CONNECTIONS FOR FUTURE TEMPORARY BOILER. ALL CONNECTIONS SHALL BE PROVIDED WITH ISOLATION VALVE AND BLIND FLANGE. COORDINATE LOCATION WITH ALL TRADES.
  - GAS TRAIN VENTS UP THROUGH ROOF. VENTS MUST BE A MINIMUM OF 10 FEET FROM ANY INTAKES. SIZE VENTS PER SCHEDULE ON DETAIL #2 ON DRAWING MP504.
  - NEW 6" UNDERGROUND NATURAL GAS MAIN. REFER TO CIVIL DRAWINGS FOR CONSTRUCTION.
  - 6" DIA NATURAL GAS UP.
  - 6" DIA MAXON VALVE. REFER TO DRAWING MP604 FOR ADDITIONAL DETAILS.
  - 4" TANK SURGE TANK BYPASS CONNECT TO CONDENSATE TRANSFER PUMP SUCTION HEADER. PROVIDE SEPARATE VALVED PIPE TO DRAIN. REFER TO DRAWING MP603 FOR ADDITIONAL DETAILS.
  - REFER TO DRAWINGS MP604 & MP605 FOR FUEL OIL FLOW DIAGRAMS.
  - PROVIDE DRIP PAN ELBOW PER DETAIL B ON DRAWING M-503.
  - BOILER MASTER CONTROL PANEL.
  - FUEL OIL PIPING IN TRENCH. REFER TO DRAWING MP101.02 FOR CONTINUATION.
  - TEMPORARY 4" NATURAL GAS DOWN FROM ABOVE. REFER TO DRAWING MP121.02. PIPING INSTALLED IN PHASE 1.
  - INDICATES BOILER CLEARANCE REQUIREMENTS.
  - FLOOR ACCESS DOOR TO NEW PUMP ROOM BELOW. COORDINATE PIPING BELOW TO PROVIDE CLEAR PATH FOR RIGGING OF EQUIPMENT. REFER TO ARCHITECTURAL AND STRUCTURAL DRAWINGS FOR ADDITIONAL DETAILS.
  - BOILER SAFETY RELIEF VALVES. REFER TO DRAWING MP601 FOR ADDITIONAL DETAILS.
  - FEEDWATER PIPING UP TO FLUE STACK ECONOMIZER. REFER TO DRAWINGS MP121.02 AND MP601 FOR ADDITIONAL DETAILS.
  - TEMPORARY WATER TREATMENT SKID. REFER TO PLUMBING DRAWINGS FOR ADDITIONAL INFORMATION.
  - 1-1/2" FOS/UP. REFER TO DRAWING MP121.02 FOR CONTINUATION.
  - CONTRACTOR SHALL PROVIDE (N+1) COMPLETE HVAC SYSTEMS FOR SECURITY M-10 AND IT ROOM M-12.
  - REFER TO MH SERIES DRAWINGS FOR GAS DETECTION SENSOR LOCATIONS.

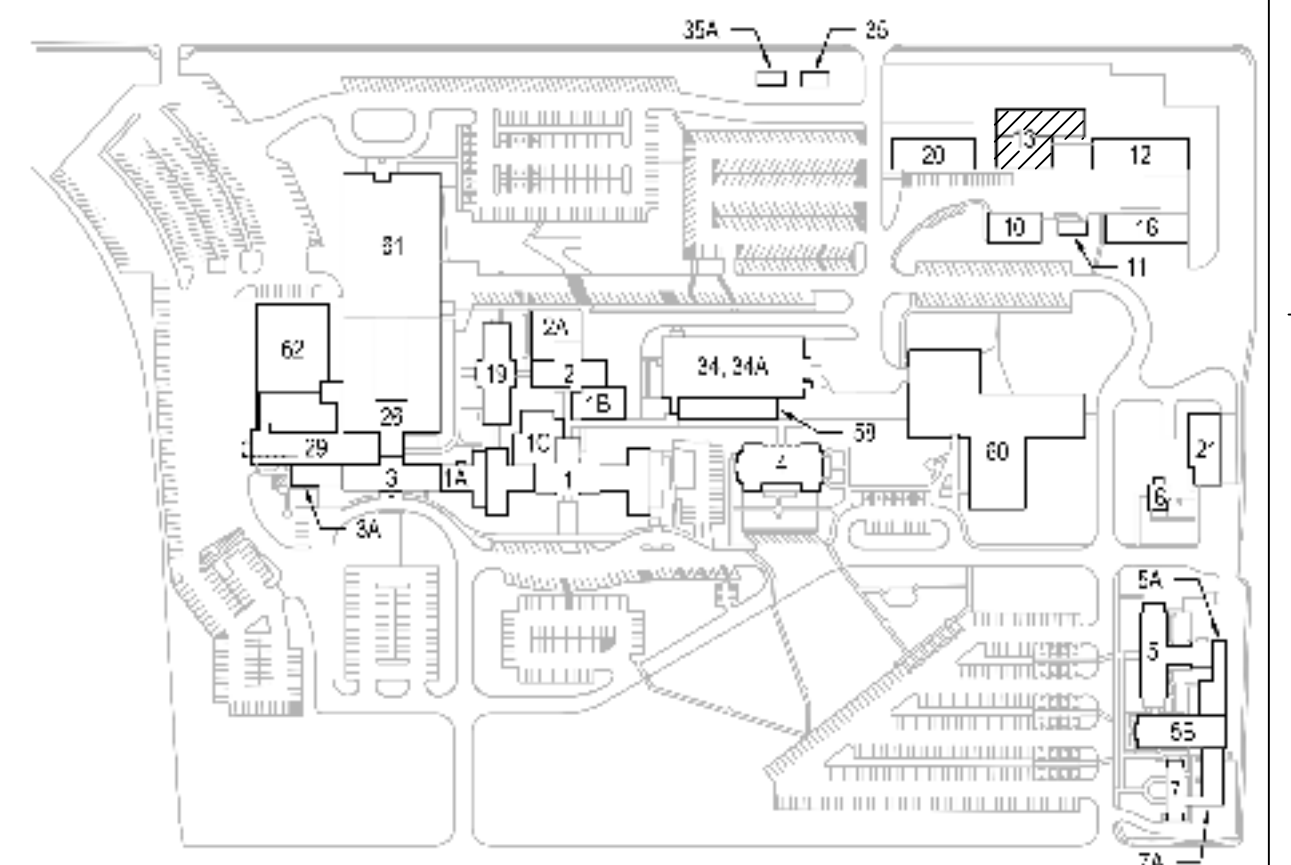

**1 PIPING PLAN - SHOP & MAIN LEVELS, PHASE 2**  
SCALE: 1/4" = 1'-0"


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- ALL VALVE HANDLES MUST BE ACCESSIBLE FROM A WALKABLE SURFACE. COORDINATE LOCATION WITH ALL TRADES.

**SHEET KEYNOTES:**

- EXISTING UTILITY RACK TO REMAIN AS IS. PROTECT DURING CONSTRUCTION.
- CONNECT NEW 1-1/2" DIA HPS TO EXISTING STEAM FEEDING BUILDING 12.
- CONNECT NEW 1-1/2" HPS TO EXISTING 1-1/2" HPS FEEDING BUILDING 20. COORDINATE ROUTING WITH EXISTING CONDITIONS.
- COORDINATE ROUTING OF TEMPORARY 4" DIA. GAS LINE THROUGH EXISTING PLANT WITH EXISTING CONDITIONS.
- SLOPE DEARATOR OVERFLOW TO CONDENSATE SURGE TANK. SLOPE 1/8" PER FT.
- DOWN TO FEEDWATER PUMP SUCTION HEADER. (DEAERATOR BYPASS). REFER TO DRAWING MP602 FOR ADDITIONAL DETAILS.
- 4"PC (SURGE TANK BYPASS TO DEAERATOR). REFER TO DRAWING MP602 & MP603 FOR ADDITIONAL DETAILS.
- 4" DIA SURGE TANK BYPASS. REFER TO DRAWING MP603 FOR ADDITIONAL DETAILS.
- ALL ISOLATION VALVES MUST BE ACCESSIBLE FROM A WALKABLE SURFACE.
- INSTALL PIPE THROUGH THE WALL INTO THE EXISTING PLANT IN PHASE 2. PROVIDE TEMPORARY CAP.
- MOUNT NATURAL GAS DETECTOR 12" BELOW CEILING. CONFIRM QUANTITY AND LOCATION OF SENSORS WITH GAS DETECTION VENDOR TO ENSURE COMPLETE COVERAGE.
- 1/4" STAINLESS STEEL TUBING CONNECTIONS FOR SAMPLE COOLER LOCATED AT SINK.
- 6" DIA NATURAL GAS PIPE UP FROM BELOW.
- PROVIDE DRIP PAN ELBOW PER DETAIL 8 ON DRAWING M-503.
- 4" TANK SURGE TANK BYPASS CONNECT TO CONDENSATE TRANSFER PUMP SUCTION HEADER. PROVIDE SEPARATE VALVED PIPE TO DRAIN. REFER TO DRAWING MP603 FOR ADDITIONAL DETAILS.
- NATURAL GAS PRESSURE REGULATOR 10 PSIG TO 12" W.C. FOR 13-DHWG-01. PROVIDE RELIEF VENT UP THROUGH ROOF.
- REFER TO PLUMBING DRAWINGS FOR VENTING FOR GAS FIRED DOMESTIC WATER HEATER.
- GAS TRAP VENTS UP THROUGH ROOF. VENTS MUST BE A MINIMUM OF 10 FEET FROM ANY INTAKES. SIZE VENTS PER SCHEDULE ON DETAIL #2 ON DRAWING MP504.
- PRV STATION FOR DEAERATOR. REFER TO DRAWING MP602 FOR FLOW DIAGRAM.
- 6" DIA VALVED SPARE CONNECTION WITH 300# BLIND FLANGE.
- STEAM FLOW METER. REFER TO DRAWING MP601 FOR PIPING DETAILS. INSTALL SHALL MEET THE MANUFACTURERS REQUIREMENTS FOR UPSTREAM AND DOWNSTREAM STRAIGHT PIPE.
- CONNECT TO EXISTING 10" DIA HPS LINE AT THE ELBOW AT THE TOP OF RISER. WORK TO BE PERFORMED AFTER THE NORTH LOOP WORK HAS BEEN COMPLETED AND PLACED IN SERVICE.
- CONTRACTOR SHALL EXTEND THE EXISTING LPG GAS PIPING, AS INDICATED ON THE PLANS IN THE EXISTING BOILER PLANT TO NEW BOILERS. REFER TO DETAIL 2 ON DRAWING MP604 FOR ADDITIONAL DETAILS. ALL LPG PIPING SHALL MEET ALL NFPA 58 REQUIREMENTS. COORDINATE ROUTING WITH EXISTING CONDITIONS.
- ALL MAIN STEAM VALVES TO HAVE 1" BYPASS LINE WITH GLOBE VALVE FOR WARM-UP. NOT SHOWN FOR CLARITY.
- 1-1/2" FOS/UP. REFER TO DRAWING MP111.02 FOR CONTINUATION.
- 3" CPTD - DA TANK BYPASS DOWN TO FEEDWATER PUMP SUCTION HEADER.



**1 PIPING PLAN - EXISTING CATWALK & CATWALK LEVELS, PHASE 2**  
SCALE: 1/4" = 1'-0"

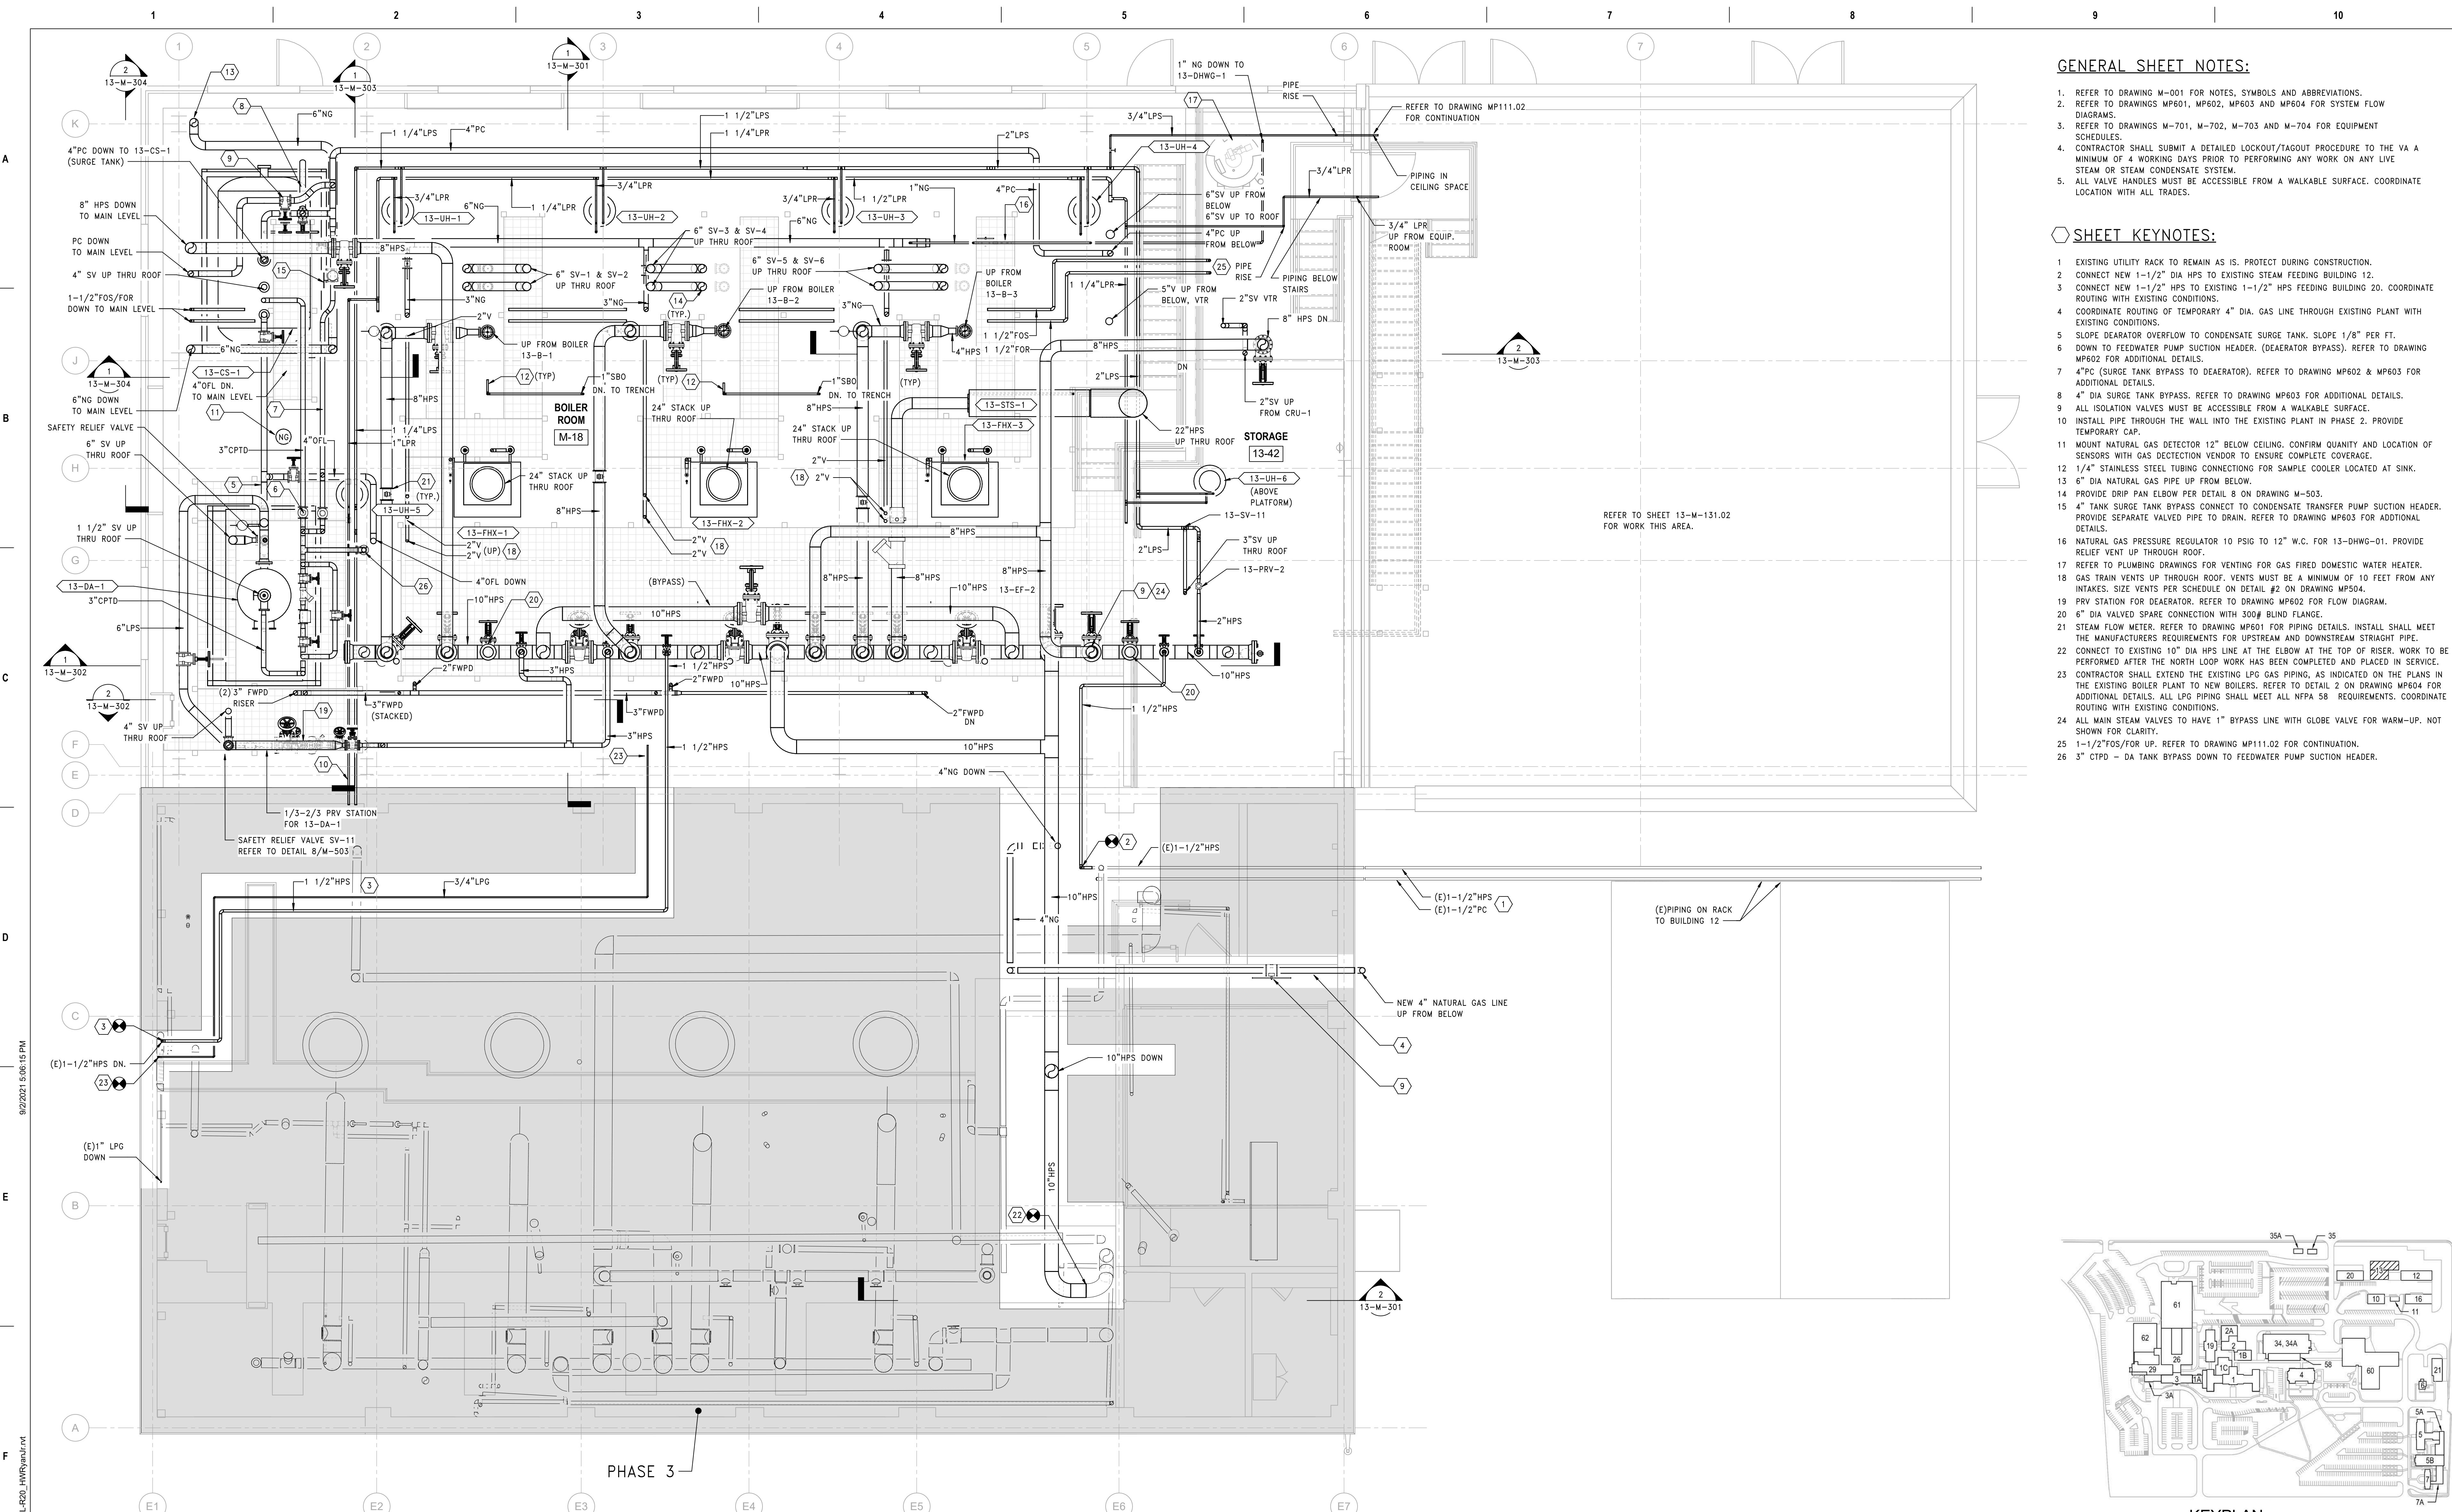PRINTS OF THIS DRAWING SHALL NOT BE USED FOR ANY PURPOSE WHATSOEVER WITHOUT THE SEAL AND SIGNATURE OF THE PROFESSIONAL ENGINEER

NO.	DESCRIPTION	DATE

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26413  
9.3.2021

**Office of Construction and Facilities Management**

**VA** U.S. Department of Veterans Affairs

Drawing Title  
**MECHANICAL PIPING PLAN EX CATWALK & CATWALK LVLS, PH 2**

Approved: Project Director

Phase  
**100% BID SET**

**FULLY SPRINKLERED**

Project Title  
**INSTALL NEW BOILERS IN BUILDING 13**

Location  
**ROBERT J. DOLE VA MEDICAL CENTER WICHITA, KANSAS**

Issue Date  
**2021-09-03**


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Drawn  
**GDS**


Project Number  
**589A7-18-302**

Building Number  
**13**

Drawing Number  
**13-MP121.02**

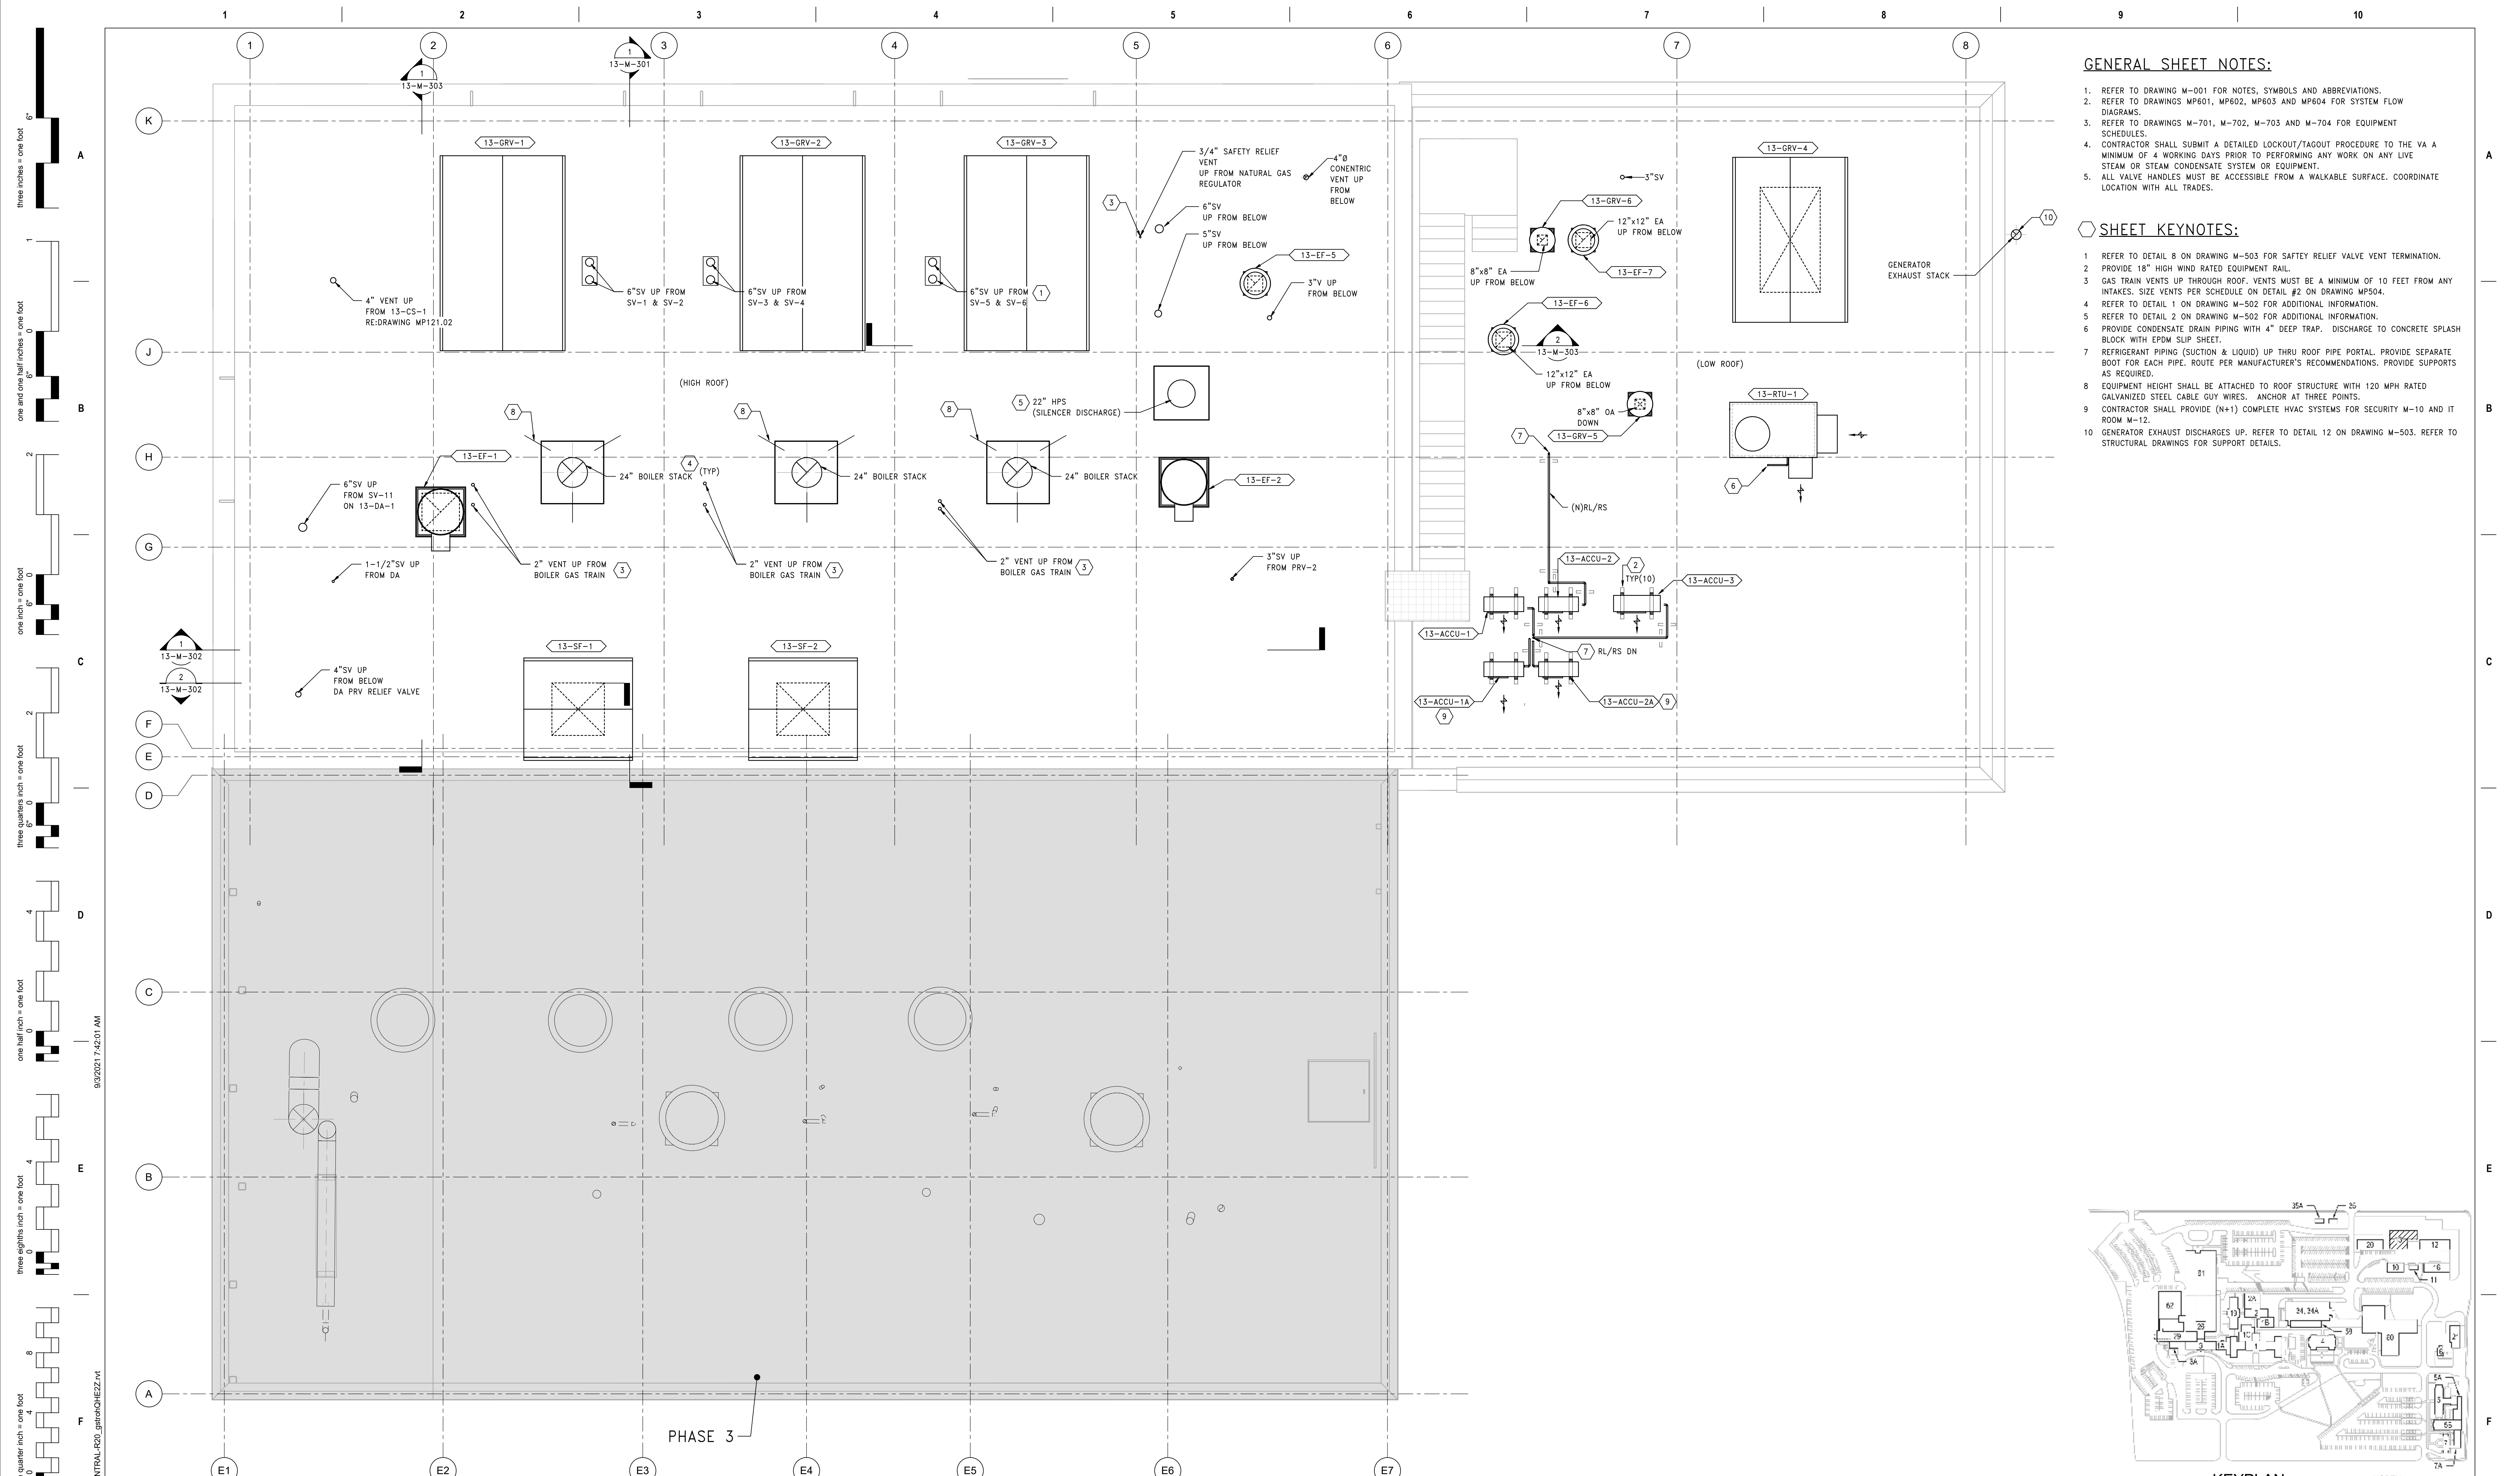

- GENERAL SHEET NOTES:**
- REFER TO DRAWING M-001 FOR NOTES, SYMBOLS AND ABBREVIATIONS.
  - REFER TO DRAWINGS MP601, MP602, MP603 AND MP604 FOR SYSTEM FLOW DIAGRAMS.
  - REFER TO DRAWINGS M-701, M-702, M-703 AND M-704 FOR EQUIPMENT SCHEDULES.
  - CONTRACTOR SHALL SUBMIT A DETAILED LOCKOUT/TAGOUT PROCEDURE TO THE VA A MINIMUM OF 4 WORKING DAYS PRIOR TO PERFORMING ANY WORK ON ANY LIVE STEAM OR STEAM CONDENSATE SYSTEM OR EQUIPMENT.
  - ALL VALVE HANDLES MUST BE ACCESSIBLE FROM A WALKABLE SURFACE. COORDINATE LOCATION WITH ALL TRADES.
- SHEET KEYNOTES:**
- REFER TO DETAIL 8 ON DRAWING M-503 FOR SAFETY RELIEF VALVE VENT TERMINATION.
  - PROVIDE 18\"/>

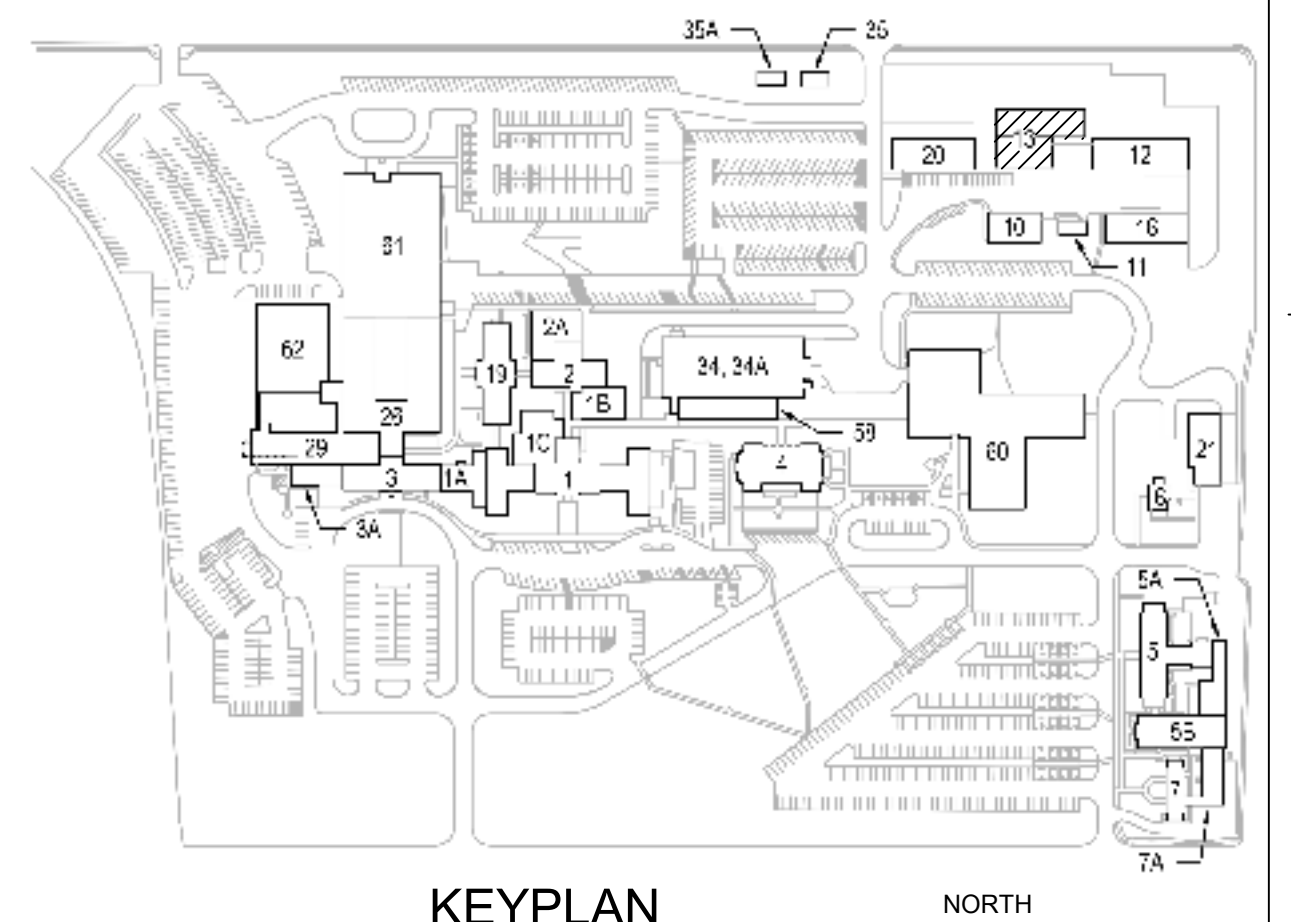

**1 MECHANICAL NEW WORK PLAN - ROOF, PHASE 2**  
SCALE: 1/4" = 1'-0"

PRINTS OF THIS DRAWING SHALL NOT BE USED FOR ANY PURPOSE WHATSOEVER WITHOUT THE SEAL AND SIGNATURE OF THE PROFESSIONAL ENGINEER

NO.	DESCRIPTION	DATE

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**Office of Construction and Facilities Management**

**VA** U.S. Department of Veterans Affairs

Drawing Title  
**MECHANICAL NEW WORK PLAN ROOF, PHASE 2**

Approved: Project Director

Phase  
**100% BID SET**

**FULLY SPRINKLERED**

Project Title  
**INSTALL NEW BOILERS IN BUILDING 13**

Location  
**ROBERT J. DOLE VA MEDICAL CENTER WICHITA, KANSAS**

Issue Date  
**2021-09-03**

Checked  
**AP**

Drawn  
**GDS**

Project Number  
**589A7-18-302**

Building Number  
**13**

Drawing Number  
**13-M-131.02**

**GENERAL SHEET NOTES:**


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2. REFER TO DRAWINGS MP601, MP602, MP603 AND MP604 FOR SYSTEM FLOW DIAGRAMS.
3. REFER TO DRAWINGS M-701, M-702, M-703 AND M-704 FOR EQUIPMENT SCHEDULES.
4. CONTRACTOR SHALL SUBMIT A DETAILED LOCKOUT/TAGOUT PROCEDURE TO THE VA A MINIMUM OF 4 WORKING DAYS PRIOR TO PERFORMING ANY WORK ON ANY LIVE STEAM OR STEAM CONDENSATE SYSTEM OR EQUIPMENT.
5. ALL VALVE HANDLES MUST BE ACCESSIBLE FROM A WALKABLE SURFACE. COORDINATE LOCATION WITH ALL TRADES.

**SHEET KEYNOTES:**

- 1 EXISTING FUEL OIL PIPING TO EXISTING EXTERIOR GENERATOR SHALL BE DISCONNECTED AND REMOVED. GENERATOR TO BE RELOCATED. REFER TO ELECTRICAL DRAWINGS 13-ED101.01 AND 13-EP111 FOR GENERATOR RELOCATION SCOPE.
- 2 EXISTING 1-1/2"HPS DOWN FROM ABOVE INTO EXISTING PIPE TRENCH TO BUILDING 20. REFER TO PHASE 2 DRAWING MP101.02 FOR NEW WORK SCOPE.
- 3 EXISTING 4" DIA HPS SHALL BE DISCONNECTED AND REMOVED. REFER TO DETAIL 9 ON DRAWING M-502 FOR ADDITIONAL DETAILS.
- 4 AFTER THE NORTH LOOP IS OPERATIONAL FROM THE NEW BOILER PLANT HEADER, DISCONNECT AND REMOVE EXISTING 5"HPS AND ASSOCIATED CONDENSATE PIPING WITHIN THE EXISTING BOILER PLANT TO POINT OF CONNECTION FROM NEW.
- 5 UNDERGROUND FUEL-OIL PIPING TO BE DOUBLE CONTAINMENT.
- 6 ONCE NEW BOILER PLANT IS OPERATIONAL AND PRIOR TO INSTALLATION OF NEW RAMP, DISCONNECT AND REMOVE EXISTING 4" DIA NATURAL GAS BACK TO SHUTOFF VALVE AND CAP. REFER TO DRAWING MP101.02 FOR ADDITIONAL DETAILS.
- 7 EXISTING FUEL OIL PIPING IN LOWER LEVEL INSTALLED IN PHASE 2.
- 8 DISCONNECT AND REMOVE EXISTING CONDENSATE RECEIVER, PUMPS AND ASSOCIATED PIPING.



**MECHANICAL DEMOLITION PLAN - TUNNEL & BASEMENT LEVELS, PHASE 3**  
 SCALE: 1/4" = 1'-0"

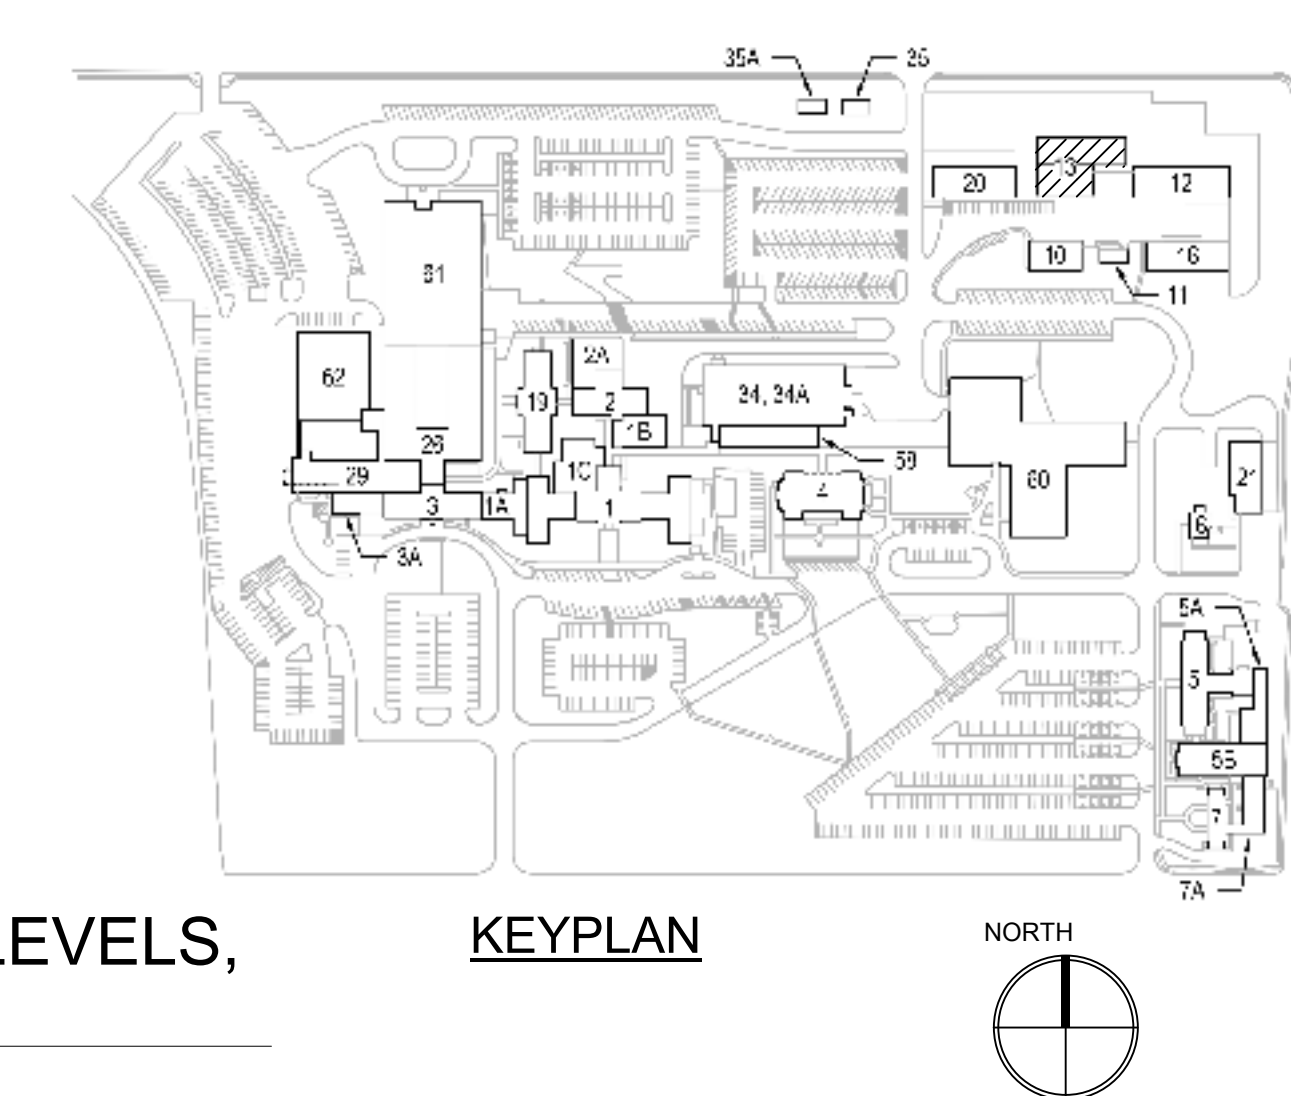

NO.	DESCRIPTION	DATE

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Office of Construction and Facilities Management
VA U.S. Department of Veterans Affairs

Drawing Title
MECHANICAL DEMOLITION PLAN TUNNEL & BSMT LEVELS, PHASE 3
Approved: Project Director

Phase
100% BID SET
FULLY SPRINKLERED

Project Title
INSTALL NEW BOILERS IN BUILDING 13
Location ROBERT J. DOLE VA MEDICAL CENTER WICHITA, KANSAS
Issue Date 2021-09-03
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Drawn GDS

Project Number
589A7-18-302
Building Number
13
Drawing Number
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