GENERAL ABBREVIATIONS

ACOUS.

ADH.

A.F.F.

AGGR.

APPD.

ARCH.

ASPH.

AUTO.

BITUM.

BLDG.

BLKG.

BRKT.

BSMT.

BTWN.

C. BD.

CEM.

CER.

COL.

C.O.

DET

DIA

DIM

DBL

DWG

Downspout

Drinking Fountain

Drawing

HDWR

HORIZ

JAN.

K.D.

JST. BR.

HVAC

H/D

Hardware

Heavy Duty

Hollow Core

Hollow Metal

Joist Bearing

Knock Down

Horizontal

Janitor

Joist

Joint

Kitchen

Heating, Ventilation, Air Cond.

BLK.

Expansion Joint ELEC. Electrical LAV. Centerline Emergency Diameter or Round Enclosure Pound or Number ENGR. L.LV. Engineer ENT. Entrance, Enter Existing LONG. E.P. Electrical Panelboard **Anchor Bolt Equally Spaced** LVR. Acoustical Equipment Area Drain EQUIP. Equivalent Additional EQUIV. Each Way Adhesive Electric Water Adjacent/Adjustable E.W.C. M.B. Above Floor Finish EXC. Aggregate **Exhaust** EXIST. Alternate EXPO. Exposed EXP. Expansion M.H. Access Panel EXT. Exterior Approved Approximate Fahrenheit MIR. Architectural Fire Alarm MISC. Asphalt FABR. Fabricate M.M. Automatic FAST Fasten(er) M.O. MOD. Floor Drain M.S. Board Foundation MTD. Bottom Face Fire Extinguisher MTL. Bituminous Fire Extinguisher Bracket Building MUL. F.E.C. Fire Extinguisher Cabinet Block Finish Floor Blocking Finish Face Bench Mark Finish Grade N.I.C. Fire Hydrant/Hose Bottom of Curb Fire Hose Cabinet NOM. F.H.S Flatheaded Screw Bearing FIN. Finish N.R.C. Fixture Basement N.T.S. Flow Line FLEX. Flexible N.W. FLR. FLSHG. Flashing Course(s) FLUOR. Fluorescent OBS. Cabinet Face of Column Catch Basin F.O.C. Face of Concrete Chalk Board F.O.F. Face of Finish Center to Center F.O.M. Face of Masonry Cement F.O.S. Face of Studs Ceramic F.O.W. Face of Wall O.H.S. Corner Guard FPRF. Fireproof O.T.S. Cast Iron Cast Iron Pipe Full Size Column Foot or Feet PART BD Construction Joint FTG. PERP FURN. Control Joint FUT. PLAS Future Centerline PLAM Concrete Opening PLWD Depth Galvanized PSF Detail GA Gauge PSI Diameter General Contractor Dimension PREFAB Door GYP. BD. Gypsum Wall Board Double Down

Laboratory Laminate

Lavatory

Long Leg Vertical

Locate, Location

Longitudinal

SLF.

S.P.

SPECD.

SPECS.

SPKR.

SPLY.

S. SK.

S.T.C.

STD.

STIF.

STL.

STRUC.

ST. STL.

S.W.

SYM.

T. & B.

T.B.R.

THK.

THRD.

T.O.P.

T.O.W.

T.W.F.

U.N.O.

VCT

VERT.

VHI

WC

WD.

W.R.

WT.

WSCOT.

VEST.

VWC.

THERMO.

SQ.

Shelf

Standpipe

Specified

Supply

Square

Standard

Stiffener

Storage

Straight

Structures

Surface

Suspended

Southwest

Symmetrial

variation)

Towel Bar

Tackboard

Telephone

Thermostat

Top of Beam

Top of Deck

Top of Footing

Top of Pier

Top of Steel

Top of Wall

Thru Wall Flashing

Underwriter's Laboratory

Unless Noted Otherwise

Vinyl Composition floor Tile

To Remain

Vertical

Vestibule

Very High Impact

Vinyl Wall Covering

Vapor Barrier

Water Closet

Water Resistant

Welded Wire Fabric

Wood

Wainscot

Weight

Note: () Specific for this project.

Threaded

Concrete

Terrazzo

Thick

Top and Bottom

To Be Removed

Tongue and Groove

Top of Curb / Top of

Tread

Surface 4 Sides (+

Stainless Steel

Steel

Short Leg Vertical

Sheet Metal Screw

Smoke Partition

Specifications

Splash Block

Service Sink

Sound Transmission Class

Spaces (Spacing)

Length

Light

Louver

Masonrv

Maximum

Machine Bolt

Mechanical

Manufacturer

Miscellaneous

Masonry Opening

Machine Screw

1/1000 of 1" (.001")

Membrane

Mirror

Metal

Mullion

North

Northeast

Number

Nominal

Not Rated

Not to Scale

Northwest

On Center

Outside Face

Opposite Hand

Particle Board

Perpendicular

Plastic Laminate

Polyvinyl Chloride

Pounds Per Square Foot

Pounds Per Square Inch

Plaster

Plywood

Power Pole

Plate

Radius

REINF

REQ

REV

RFG

R.O.

RM

Recessed

Reference

Refrigerator

Reinforcing

Resilient Tile

Roof Drain

Rough Opening

Roofing

Room

Revision or Reverse

Required

Prefabricated

Pressure Treated

Portland Cement

Oval Head Screw

Open to Structure

Overall

Office

Not in Contract

Noise Reduction Coefficient

Outside Diameter (Dim)

Millimeter

Medicine Cabinet

GENERAL ARCHITECTURAL NOTES Square feet I. THE CONTRACTOR SHALL INSPECT THE SITE, STUDY EXISTING CONDITIONS, REVIEW DRAWINGS AND SPECIFICATIONS. CONTRACTOR SHALL ADJUST FOR ACTUAL FIELD CONDITIONS AT NO ADDITIONAL EXPENSE TO THE OWNER. SHTHG. Sheathing Shower

2. CONTRACTOR SHALL TAKE ALL MEASUREMENTS FOR THE WORK AND BE RESPONSIBLE FOR SAME. COORDINATE THE WORK AND SHOP DRAWINGS WITH ALL OTHER TRADES AFFECTED AND MAKE ANY NECESSARY OFFSETS TO CONCEAL PIPING AND DUCTWORK AND TO CLEAR EQUIPMENT, STRUCTURAL MEMBERS AND OTHER OBSTRUCTIONS.

3. ALL UTILITIES AND SERVICES SHALL BE KEPT IN CONTINUOUS OPERATION UNLESS WRITTEN PERMISSION IS OTHERWISE GRANTED BY THE OWNER.

3.1. MINOR SHUTDOWNS OF LESS THAN 48 HOURS REQUIRE 7 TO 14 DAYS' NOTICE; 3.2. MAJOR SHUTDOWNS OF MORE THAN 48 HOURS REQUIRE 14 DAYS' NOTICE. 3.3. CONTRACTOR MUST CONTACT VA'S COR PRIOR TO ANY SHUTDOWNS.

4. TEMPORARY ALTERATIONS AND CONNECTIONS REQUIRED BY THIS CONTRACT SHALL BE MADE SO THAT ALL BUILDING SERVICES ARE MAINTAINED WITH MINIMUM INTERRUPTION. SCHEDULE ALL ELECTRICAL/MECHANICAL OUTAGES 14 DAYS IN ADVANCE WITH THE OWNER.

5. PROTECT ALL WORK, MATERIALS AND EQUIPMENT. CAP OR PLUG TEMPORARY OPENINGS. DELIVER ALL WORK TO THE OWNER CLEAN AND IN GOOD CONDITION.

6. WHEN DEMOLITION IS COMPLETE, NOTIFY ARCHITECT AND OWNER FOR A SCHEDULED MEETING TO REVIEW EXISTING CONDITIONS AND ANY CONCERNS REGARDING NEW WORK.

7. CUTTING AND PATCHING OF EXISTING WALLS, FLOORS OR CEILINGS REQUIRED BY NEW WORK SHALL BE INCLUDED AS WORK PROVIDED UNDER THIS CONTRACT.

8. CUTTING SHALL BE DONE WITH CARE SO AS NOT TO DAMAGE EXISTING EQUIPMENT,

CONNECTIONS, CONTROLS, ETC. 9. DAMAGE CAUSED BY SUCH CUTTING SHALL BE REPLACED OR REPAIRED TO ORIGINAL CONDITION BY CONTRACTOR AT NO COST TO THE OWNER, UNLESS UNFORESEEN EXISTING CONDITIONS ARE DISCOVERED AND OWNER IS NOTIFIED.

10. ALL OCCUPIED WORK AREAS, BUILDING CORRIDORS AND EXTERIOR AREAS SHALL BE KEPT CLEAR OF DEBRIS.

11. ALL MATERIALS AND EQUIPMENT SHALL BE NEW, OF THE BEST QUALITY AND FREE FROM DEFECTS.

12. MANUFACTURER AND MODEL NUMBERS SPECIFIED ESTABLISH THE TYPE AND QUALITY REQUIRED, UNLESS OTHERWISE NOTED. 13. ALL WORK SHALL COMPLY WITH APPLICABLE REGULATIONS, CODES AND ORDINANCES.

14. THE CONTRACTOR SHALL PERFORM ALL TESTS AS SPECIFIED OR AS NECESSARY TO DEMONSTRATE A COMPLETE AND

15. ALL EXPOSED PENETRATIONS MADE THROUGH EXISTING ROOFS, FLOORS, AND WALLS SHALL BE PATCHED WITH LIKE MATERIALS TO MATCH THE SURROUNDING AREAS, AND FILLED AS CLOSE AS POSSIBLE TO THE NEW PIPING OR DUCTWORK.

15.1. ALL EXPOSED PENETRATIONS MADE THROUGH EXISTING ROOFS ARE TO BE COORDINATED WITH THE ROOFING WARRANTY CONTRACTOR. 15.2. ALL PENETRATIONS THROUGH RATED WALLS SHALL BE PATCHED TO MAINTAIN RATING.

16. THE CONTRACTOR SHALL BE RESPONSIBLE FOR REPAIRING AND REPLACING ANY DAMAGE TO EXISTING MATERIALS RESULTING FROM WORK UNDER THIS CONTRACT AND SHALL RESTORE SUCH TO IT'S ORIGINAL CONDITION WITH NEW MATERIALS TO MATCH EXISTING.

17. INSTALL THE SPECIFIED FIRE STOPPING (SLEEVES, WRAP, CONDUIT, ETC.) AT RATED CONSTRUCTION: 17.1. FIRE STOP ALL PENETRATIONS WHERE NEW DEVICES/LINES, RELOCATING EXISTING DEVICES/LINES, PENETRATING FLOORS, CEILINGS AND OTHER RATED BARRIERS. 17.2. FIRE STOP ALL NEWLY CREATED PENETRATIONS WHERE EXISTING DEVICES/LINES PENETRATE FLOORS, CEILINGS AND

18. ALL METAL STUD AND GYPSUM WALLBOARD PARTITIONS ARE DIMENSIONED TO THE OUTSIDE FACE OF WALL AND TO THE COLUMN GRD UNLESS OTHERWISE NOTED.

19. ALL GYPSUM BOARD SHALL BE TYPE 'X' FIRE CODE GYPSUM BOARD MOLD AND MOISTURE RESISTANT AT WALLS AND

OTHER RATED BARRIERS. USE FIRE APPROVED CAULKING AND FIRE STOPS (SEE SPECIFICATIONS).

20. PROVIDE WOOD BLOCKING OR 16 GA. SHEET METAL BACKING PLATES IN ALL WALLS TO RECEIVE WALL HUNG

BLOCKING IS USED, PROVIDE AS FIRE-RESISTANT. 21. ALL ITEMS AND DEVICES, SUCH AS COVER PLATES, SWITCH PLATES, CONVENIENCE OUTLETS, DOOR STOPS, AND OTHER FINISH HARDWARE, ETC. SHALL BE REMOVED AND REINSTALLED AS PART OF THE REFINISHING OF EXISTING WALLS INDICATED TO

ACCESSORIES, SUCH AS EQUIPMENT, GRAB BARS, MILLWORK, COAT HOOKS, AND DOOR STOPS, ETC. IF WOOD

22. THE CONTRACTOR SHALL WORK WITH THE CONDITIONS AS THEY EXIST AT THE SITE. ALL ABOVE CEILING CONDITIONS SHALL BE REVIEWED AND MODIFICATIONS IDENTIFIED, COORDINATED, AND INCORPORATED INTO THE SHOP DRAWING PROCESS. COORDINATE ALL ABOVE CEILING WORK TO ENSURE A COMPLETE AND OPERATIONAL

SYSTEM AT NO ADDITIONAL COST TO THE OWNER. COORDINATION SHALL INCLUDE, BUT NOT BE LIMITED TO THE

22.1. THE OWNER'S EQUIPMENT REQUIREMENTS. 22.2. THE CEILING SUPPORT SYSTEM.

22.3. THE MECHANICAL DUCTWORK SYSTEM. 22.4. THE LIGHTING FIXTURES.

FOLLOWING:

22.5. ELECTRICAL WIRING AND CONDUIT SYSTEMS.

22 . 6. THE PLUMBING AND PIPING SYSTEMS. 22. 7. THE COMMUNICATIONS SYSTEMS.

23. ALL CONTRACTORS ARE RESPONSIBLE FOR REVIEWING ENTIRE SET OF DOCUMENTS TO DETERMINE THEIR FULL SCOPE OF WORK. CONTRACTOR SHALL NOT BE ALLOWED EXTRA COSTS DUE TO FAILURE TO REVIEW ENTIRE SET OF DOCUMENTS.

24. ALL NEW STUD WALLS AND GYPSUM BOARD SHALL EXTEND TO STRUCTURE UNLESS NOTED OTHERWISE.

25. WHEN ALTERING THE BUILDING, IF STRUCTURAL INTEGRITY APPEARS TO BE IN QUESTION CONTRACTOR SHALL NOTIFY OWNER AND ARCHITECT IMMEDIATELY.

26. ALL NEW CONSTRUCTION IS INDICATED BOLD OR FULL TONE UNLESS NOTED OTHERWISE.

27. WHEN WALL PARTITIONS OF DIFFERENT FIRE RATING INTERSECT, THE HIGHEST RATED PARTITION TAKES PRECEDENT. MAINTAIN RATING BEHIND RECESSED AREAS IN WALLS.

28. ALL CORRIDOR WALLS ARE REQUIRED TO BE SMOKE TIGHT, WHETHER THEY ARE FIRE RATED OR NOT. REPAIR AND EXTEND AT LEAST THE CORRIDOR SIDE OF NON-RATED CORRIDOR WALLS TO STRUCTURE, UNLESS NOTED OTHERWISE, SEE WALL TYPES

29. COORDINATE CONSTRUCTION REQUIREMENTS WITH MECHANICAL AND ELECTRICAL DRAWINGS.

30. REVIEW AREAS OF WORK WITH COR FOR INFECTION CONTROL REQUIREMENTS. AREAS REQUIRING CLASS I/CLASS II INFECTION CONTROL WILL REQUIRE APPROVAL BY THE COR PRIOR TO BEGINNING WORK. AREAS REQUIRING CLASS III/CLASS IV INFECTION CONTROL REQUIRE PERMITS FROM THE VA. SEE DIVISION 1 SPECIFICATION "SAFETY REQUIREMENTS-INFECTION CONTROL" FOR DETAILED INFORMATION.

31. CONTRACTOR SHALL OBSERVE WORK RESTRICTIONS NOTED IN PHASING REQUIREMENTS, ON DRAWINGS AND IN THE SPECIFICATIONS FOR AREAS THAT ARE A PART OF OR ADJACENT TO ADMINISTRATIVE, DIETARY, SUPPORT, IN-PATIENT, OUT-PATIENT AND CLINICAL AREAS.

IMPORTANT CONTRACTOR NOTES:


- 1. ALL CONTRACTORS ARE RESPONSIBLE FOR REVIEWING ENTIRE SET OF DOCUMENTS TO DETERMINE THEIR FULL SCOPE OF WORK. CONTRACTOR SHALL NOT BE ALLOWED EXTRA COSTS DUE TO FAILURE TO REVIEW ENTIRE SET OF DOCUMENTS.
- . COVER AND PROTECT ALL VA EQUIPMENT AND FURNITURE SO THAT THE FUNCTION AND APPEARANCE IS NOT AFFECTED BY CONSTRUCTION, THE CONTRACTOR, THEIR EQUIPMENT, MATERIALS, OR ANY INVOLVED ACTIONS.
- 3. A 1 HR MINIMUM FIRE-RATED SEPARATION IS REQUIRED BETWEEN ALL OCCUPIED SPACE AND CONSTRUCTION AREAS. THIS PROTECTION INCLUDES ANY EXISTING PENETRATIONS AND OPENINGS.


FIRE PROOFING GENERAL NOTES:

- . MAINTAIN FIRE RATED CONSTRUCTION AT WALL PENETRATIONS, (CONSTRUCTION TO CONFORM TO MANUFACTURER'S FIRE RATED/TEST ASSEMBLIES.)
- 2. FIRE CAULK ALL SLEEVES AND PENETRATIONS AT FIRE WALLS/PARTITIONS AND FLOORS. CONFORM WITH THE TESTED/SUBMITTED FIRE RATED ASSEMBLY. USE RED FIRE CAULK AND LABEL WALL WITH U.L. DESIGN NUMBER AND ASTM. FIRE RATED WALLS SHOWN ON PLAN.
- PATCH AND REPAIR ALL EXISTING FIRE CAULKING AT EXISTING RATED WALLS WHICH IS UNCOVERED NEEDING REPAIR AND THAT WHICH IS DISTURBED DURING CONSTRUCTION. RE-LABEL EXISTING WALL IF NECESSARY.

HAZARDOUS MATERIAL:

1. IF THE CONTRACTOR ENCOUNTERS MATERIAL THAT COULD BE HAZARDOUS, THE CONTRACTOR SHALL STOP WORK AND NOTIFY THE OWNER IMMEDIATELY FOR DIRECTION.

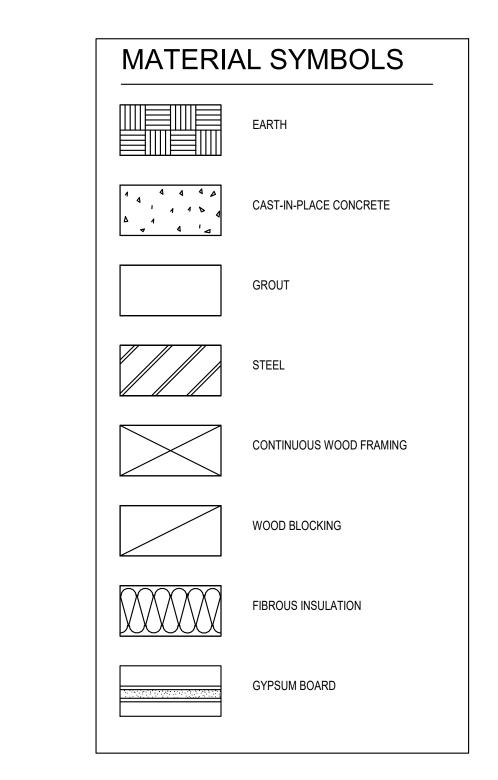

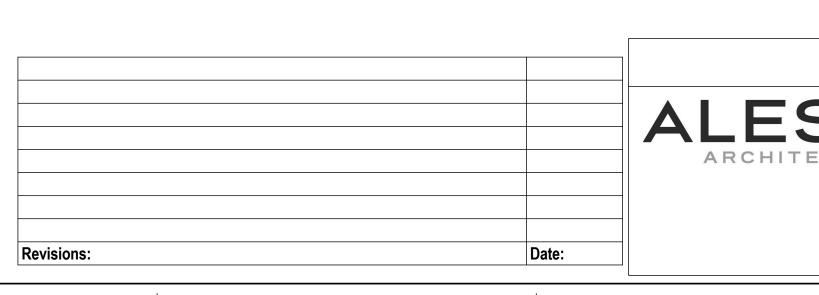


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Construction and Facilities Management

U.S. Department of Veterans

Drawing Title ARCHITECTURAL ABBREVIATIONS LEGENDS AND NOTES


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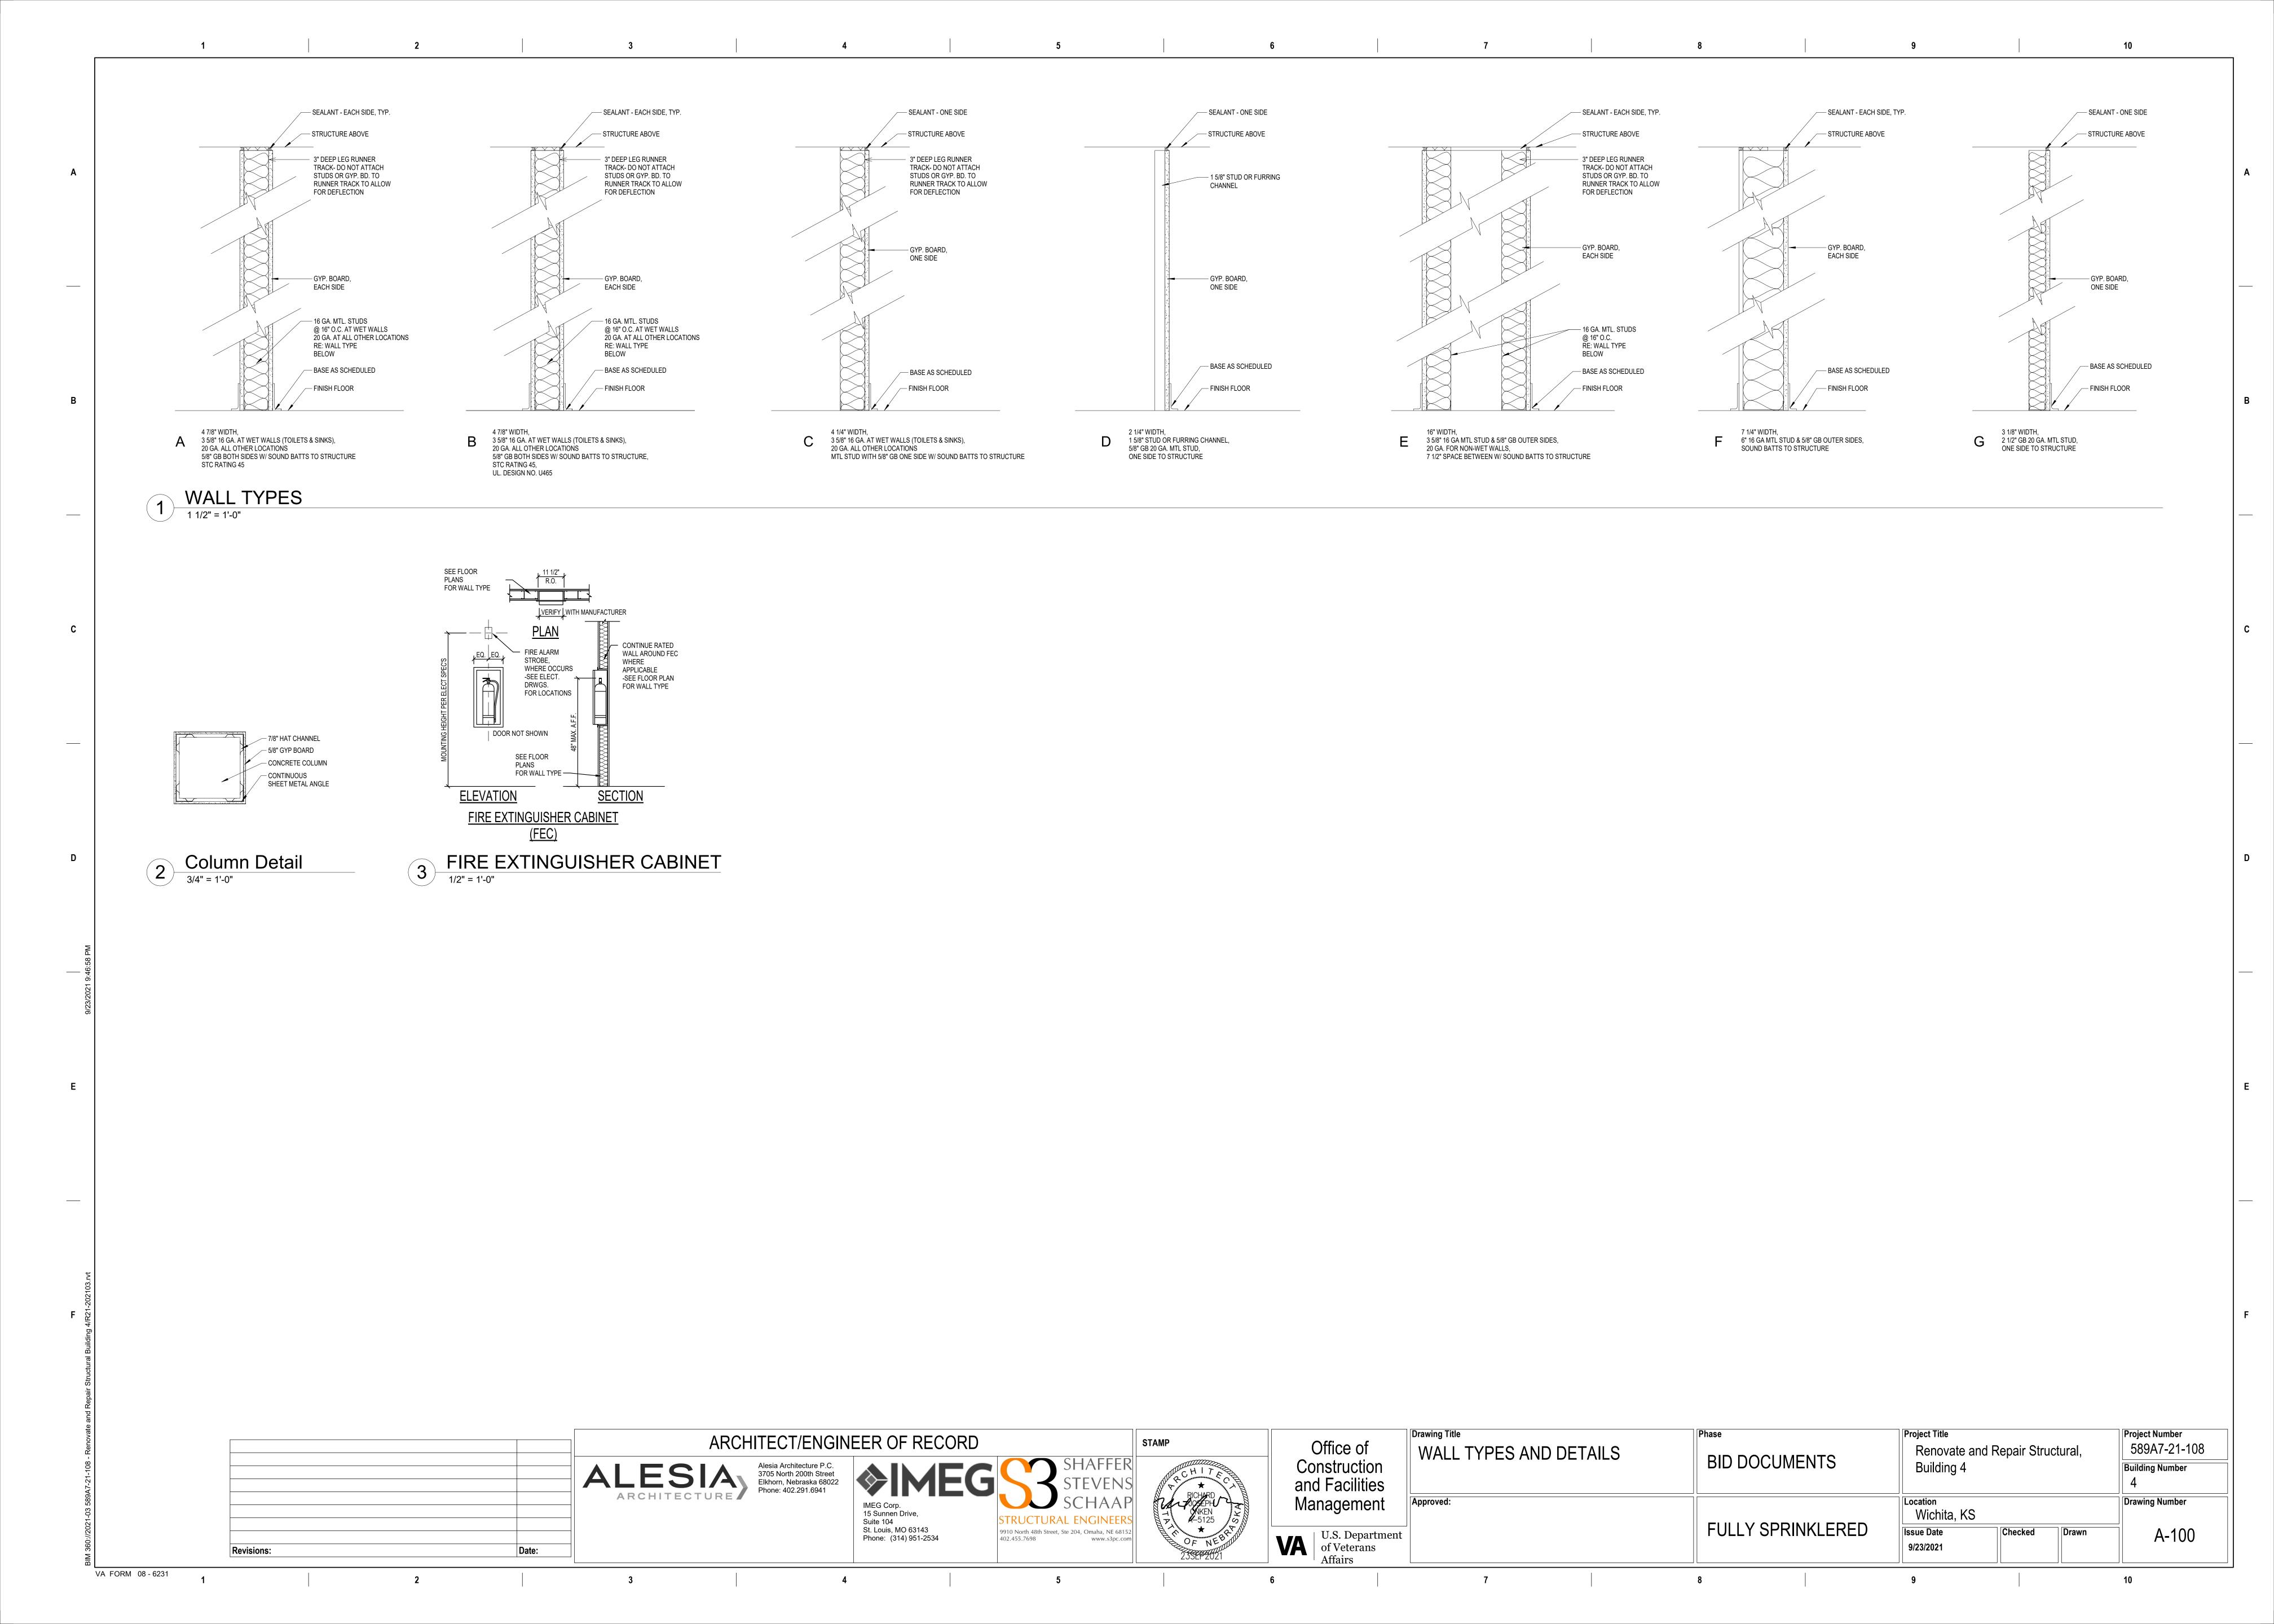
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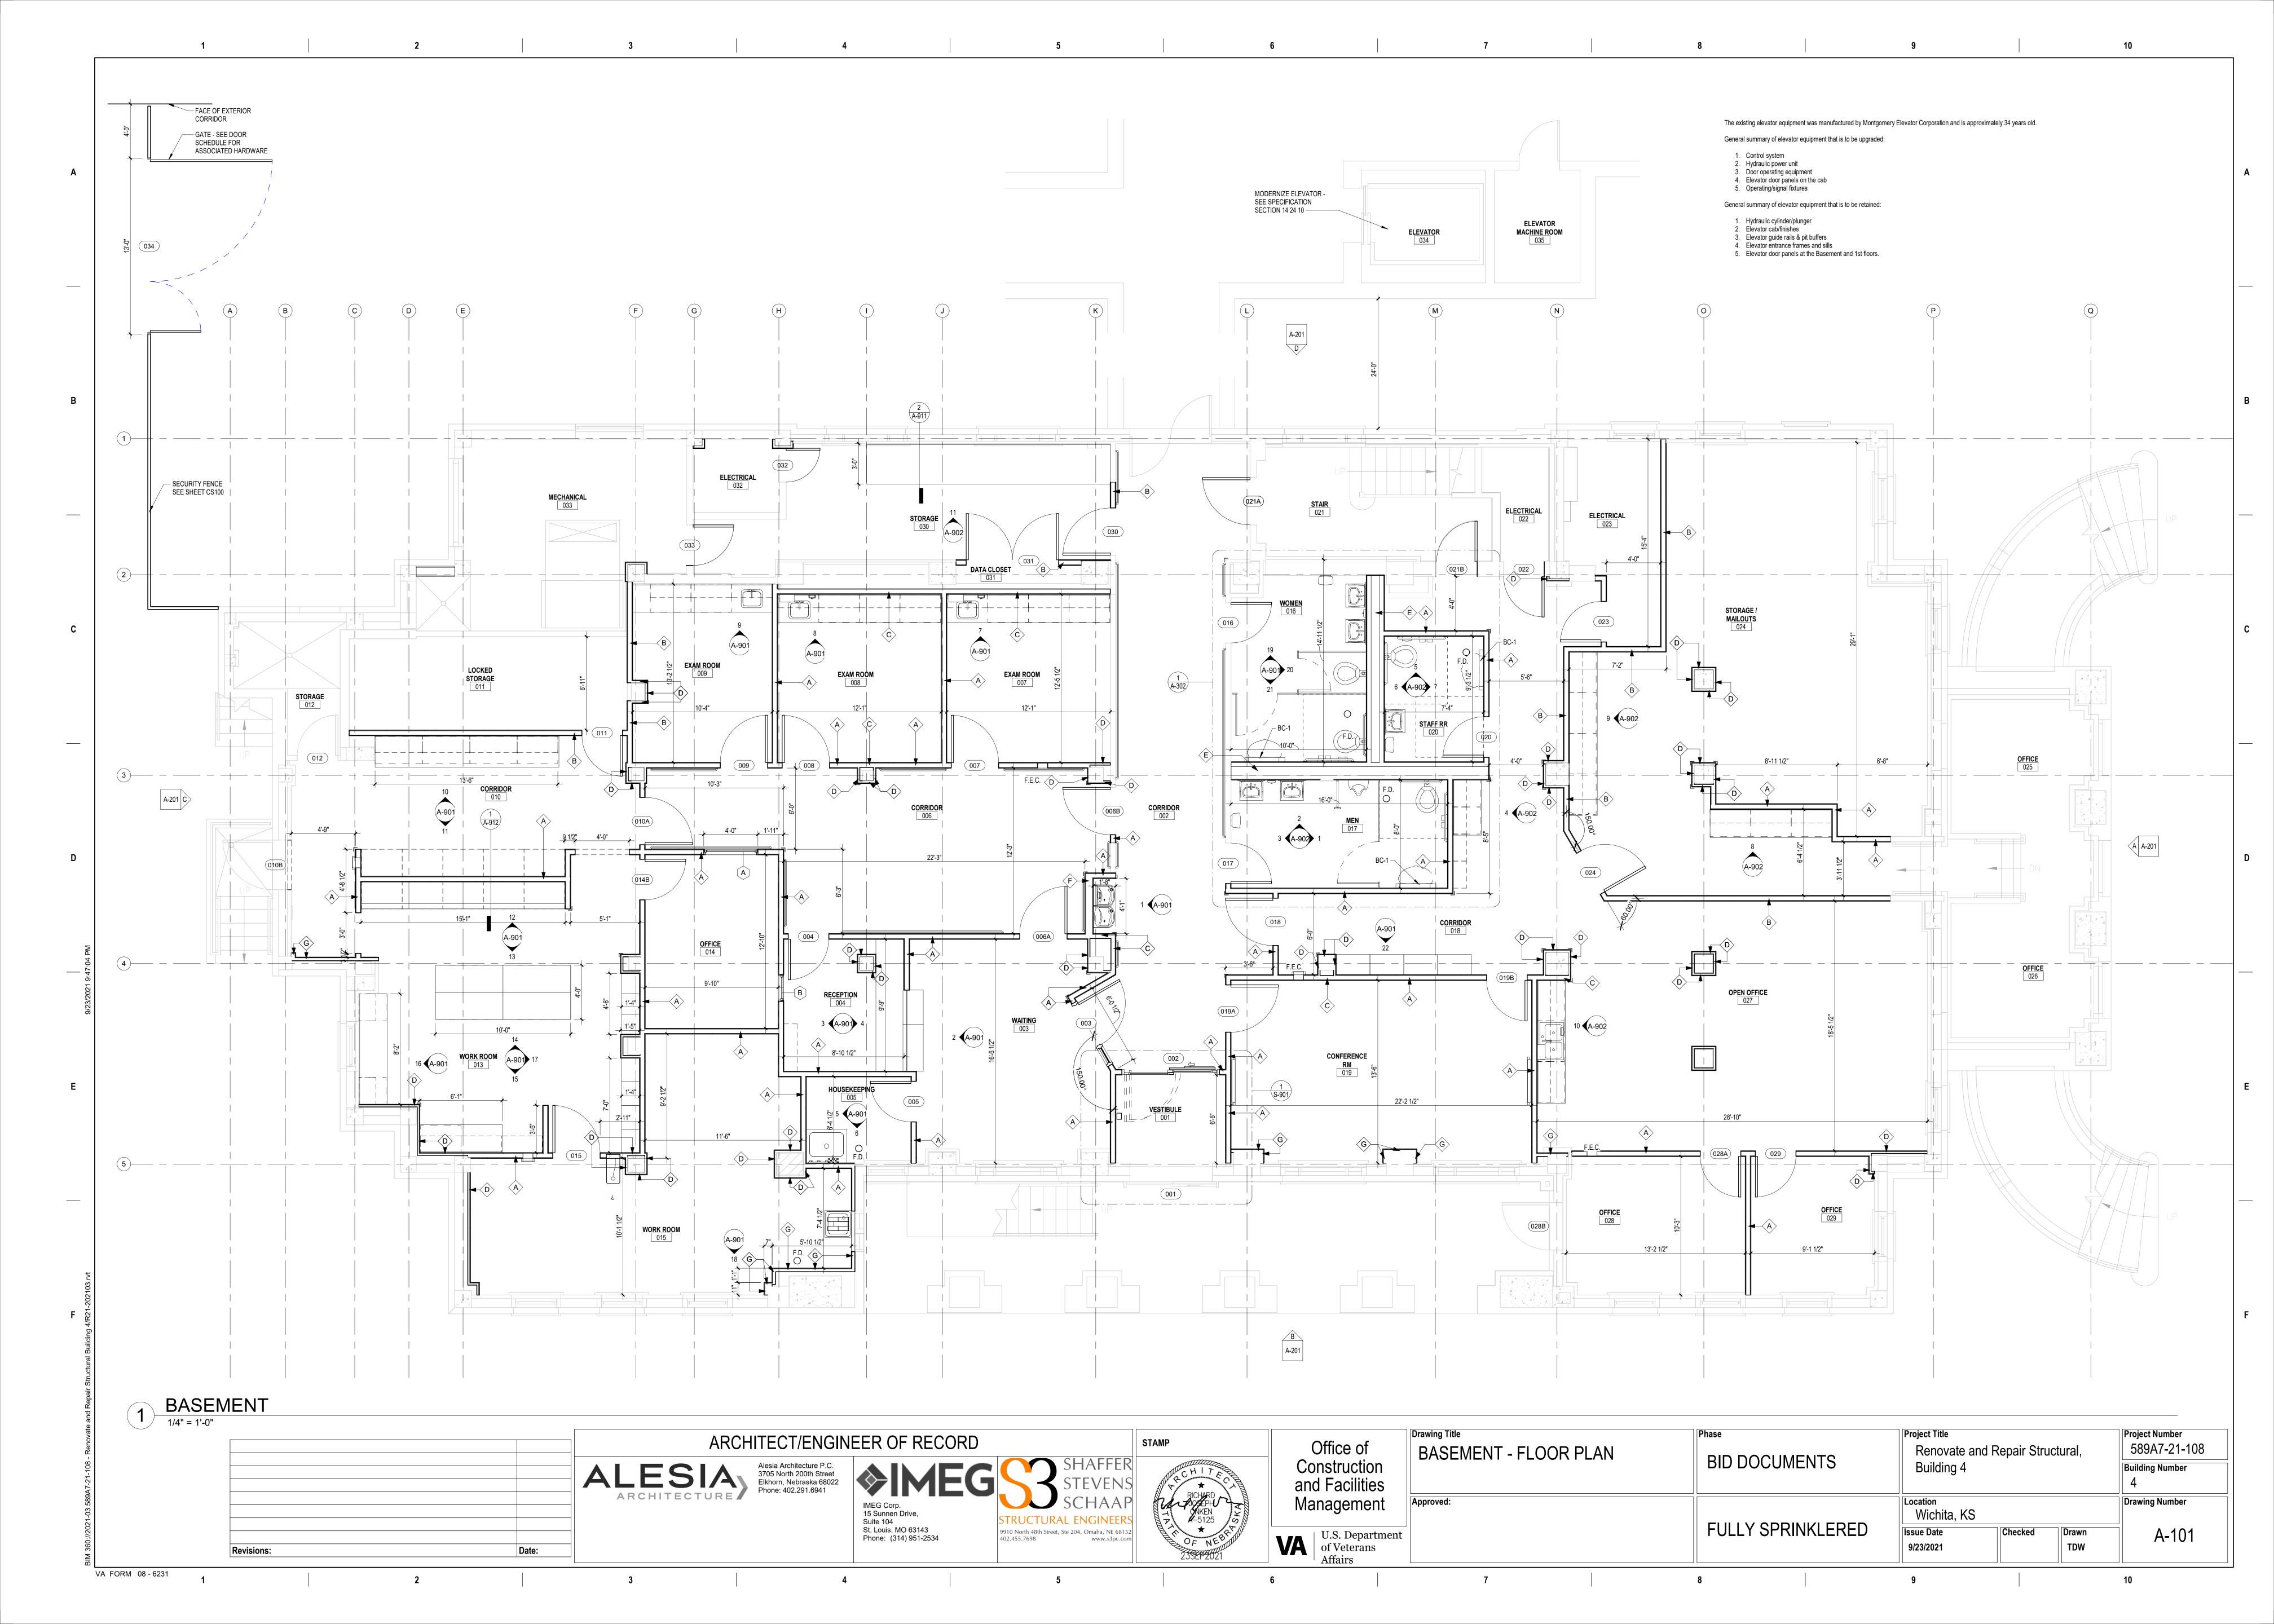
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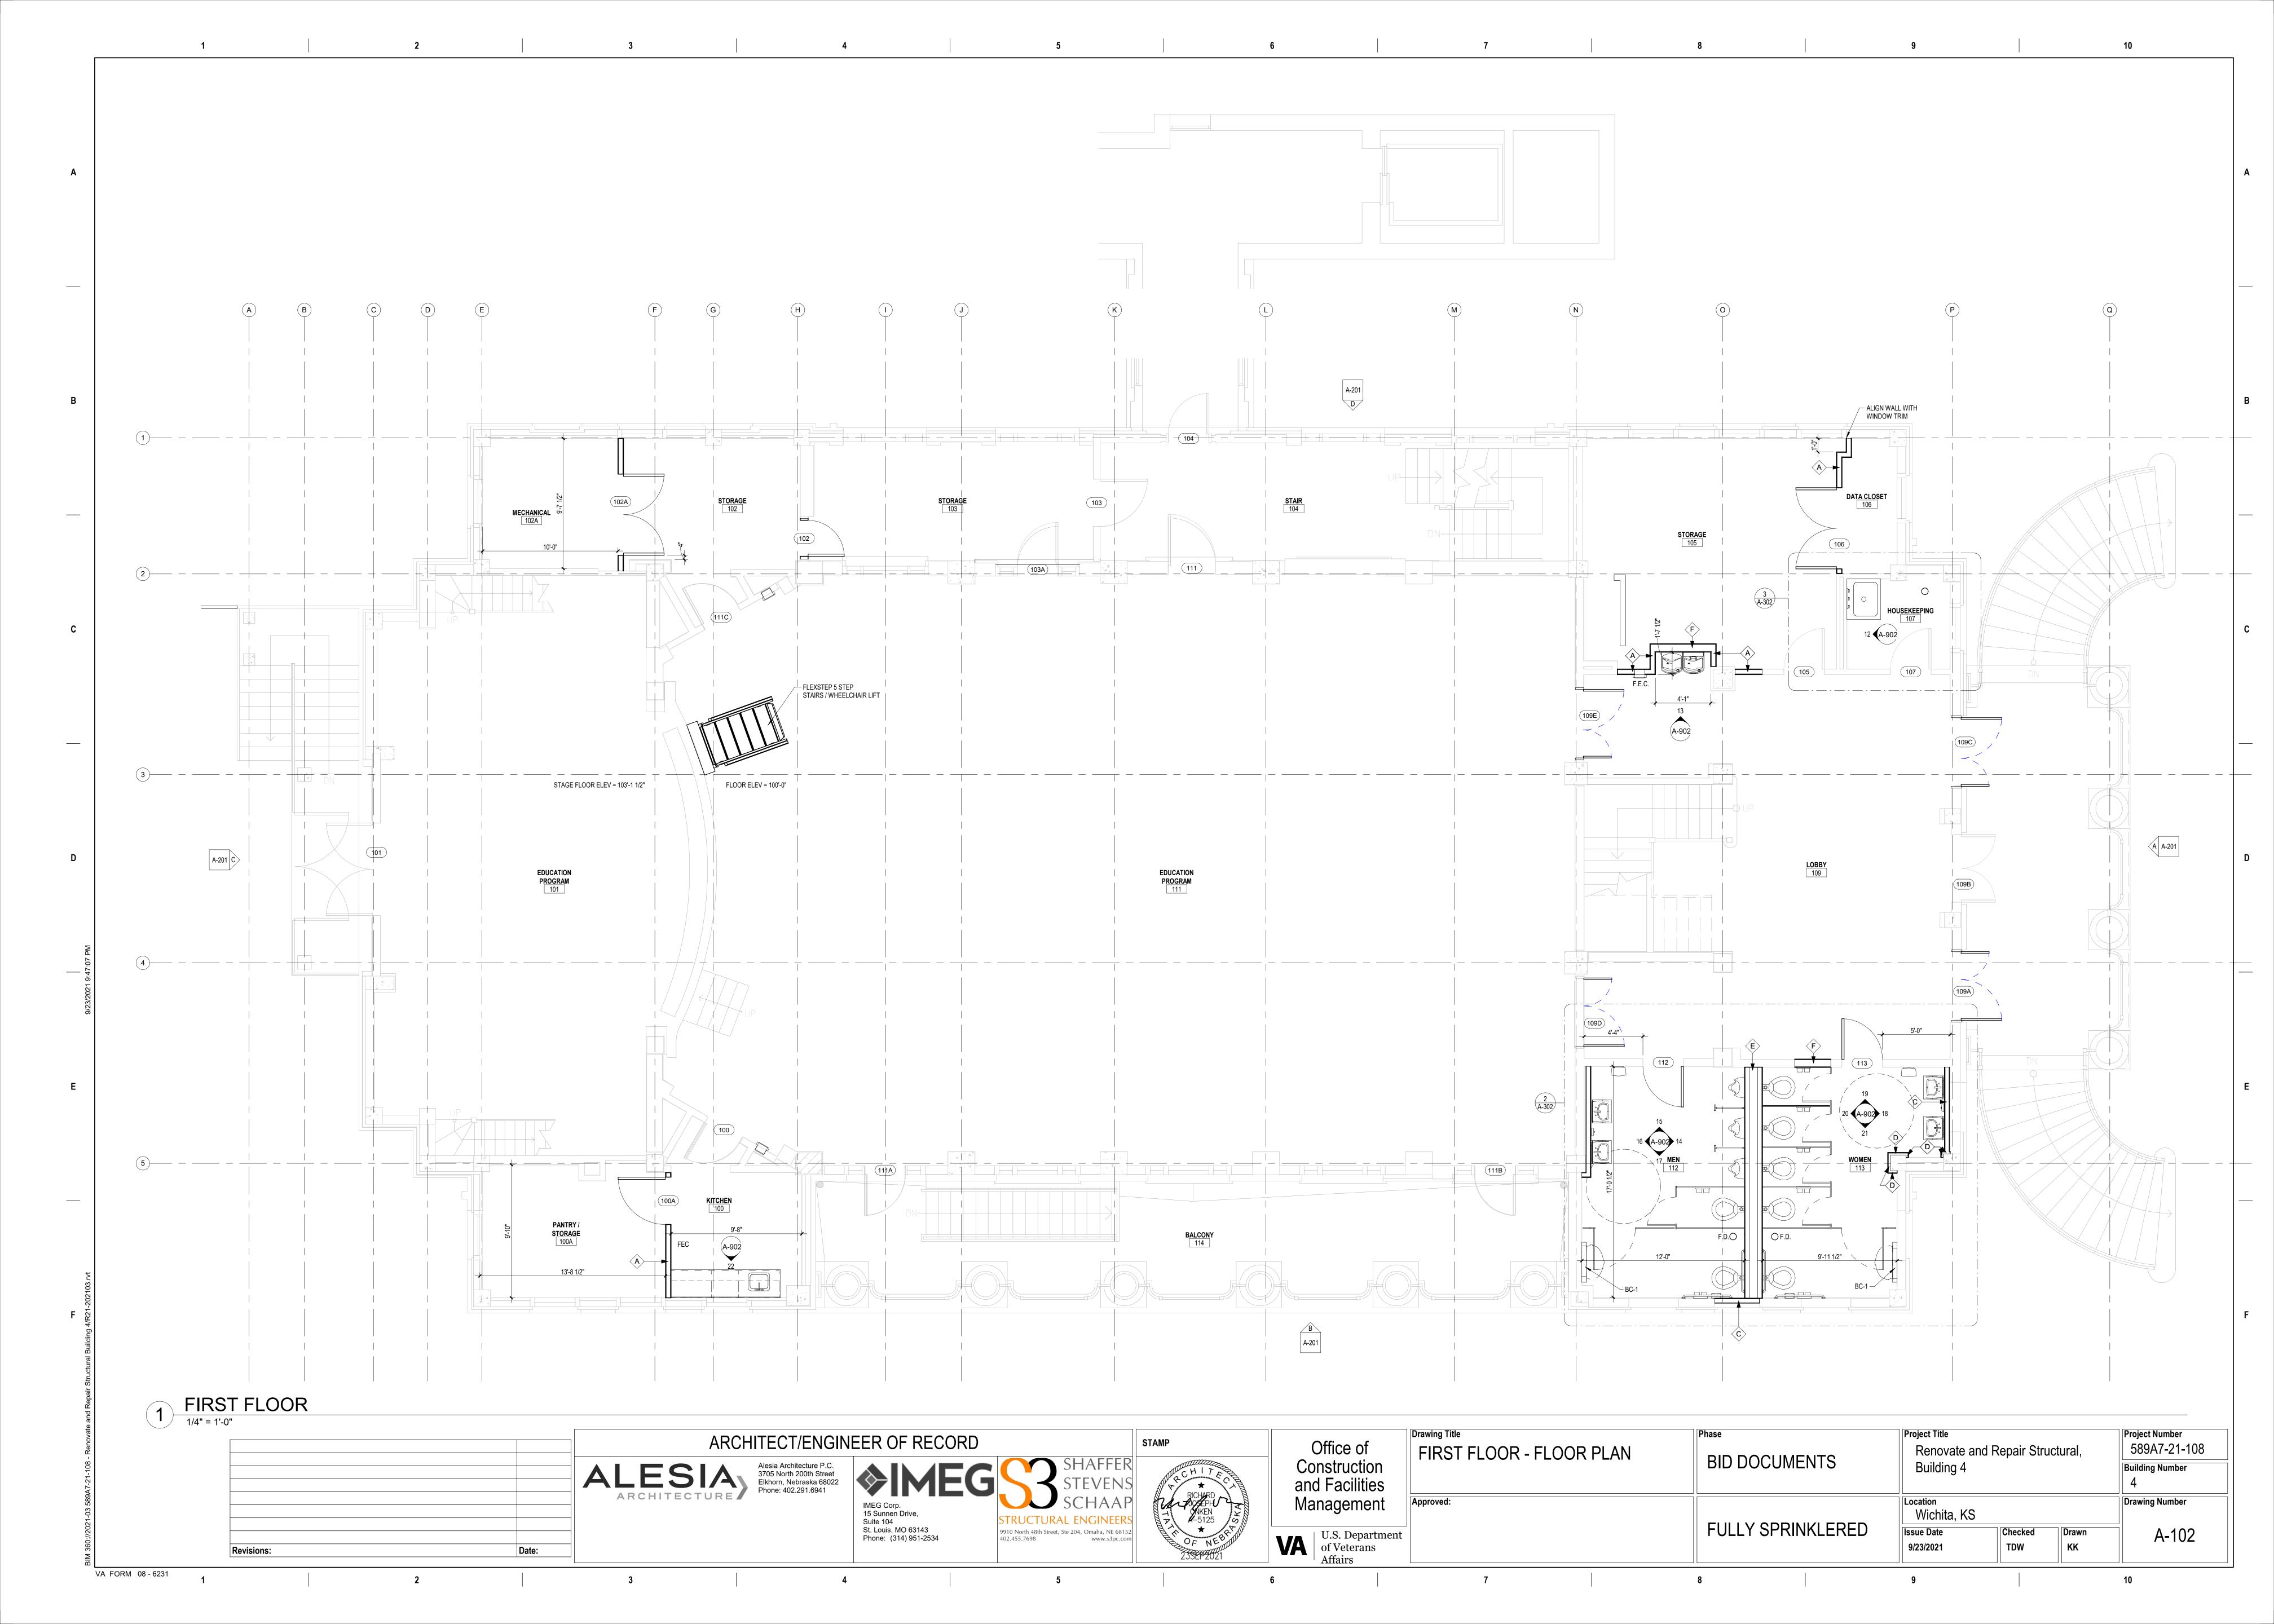
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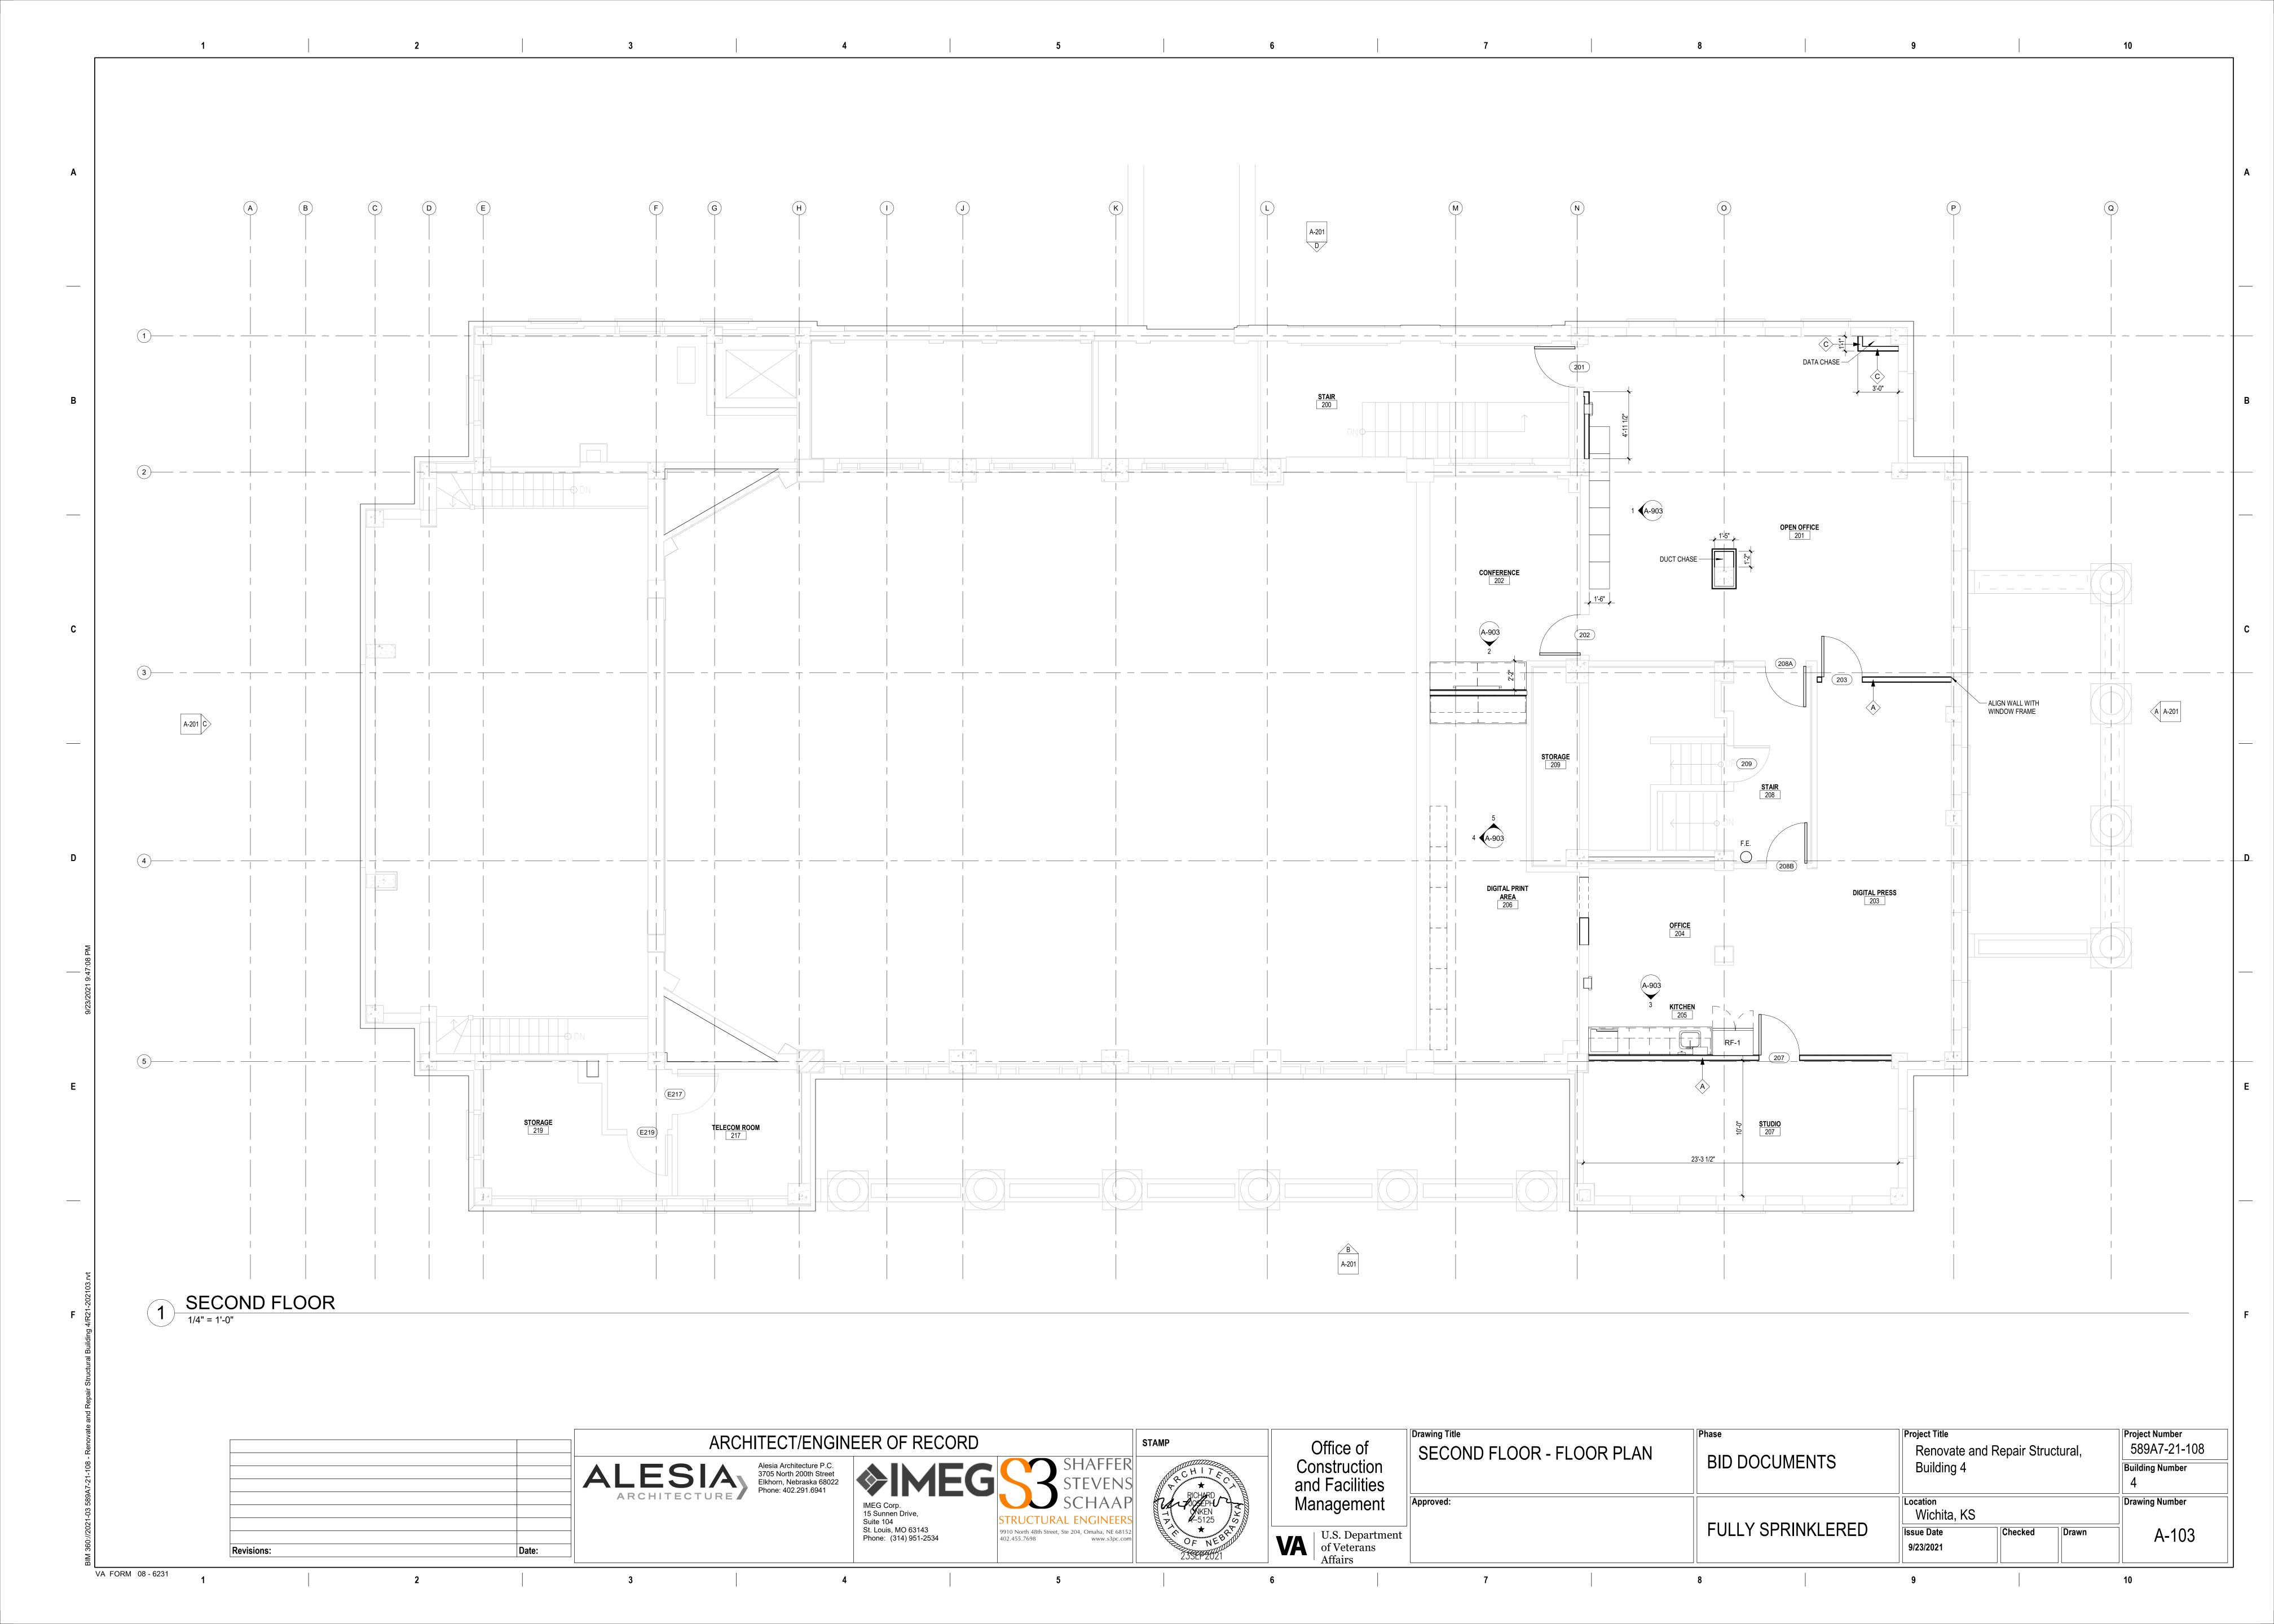
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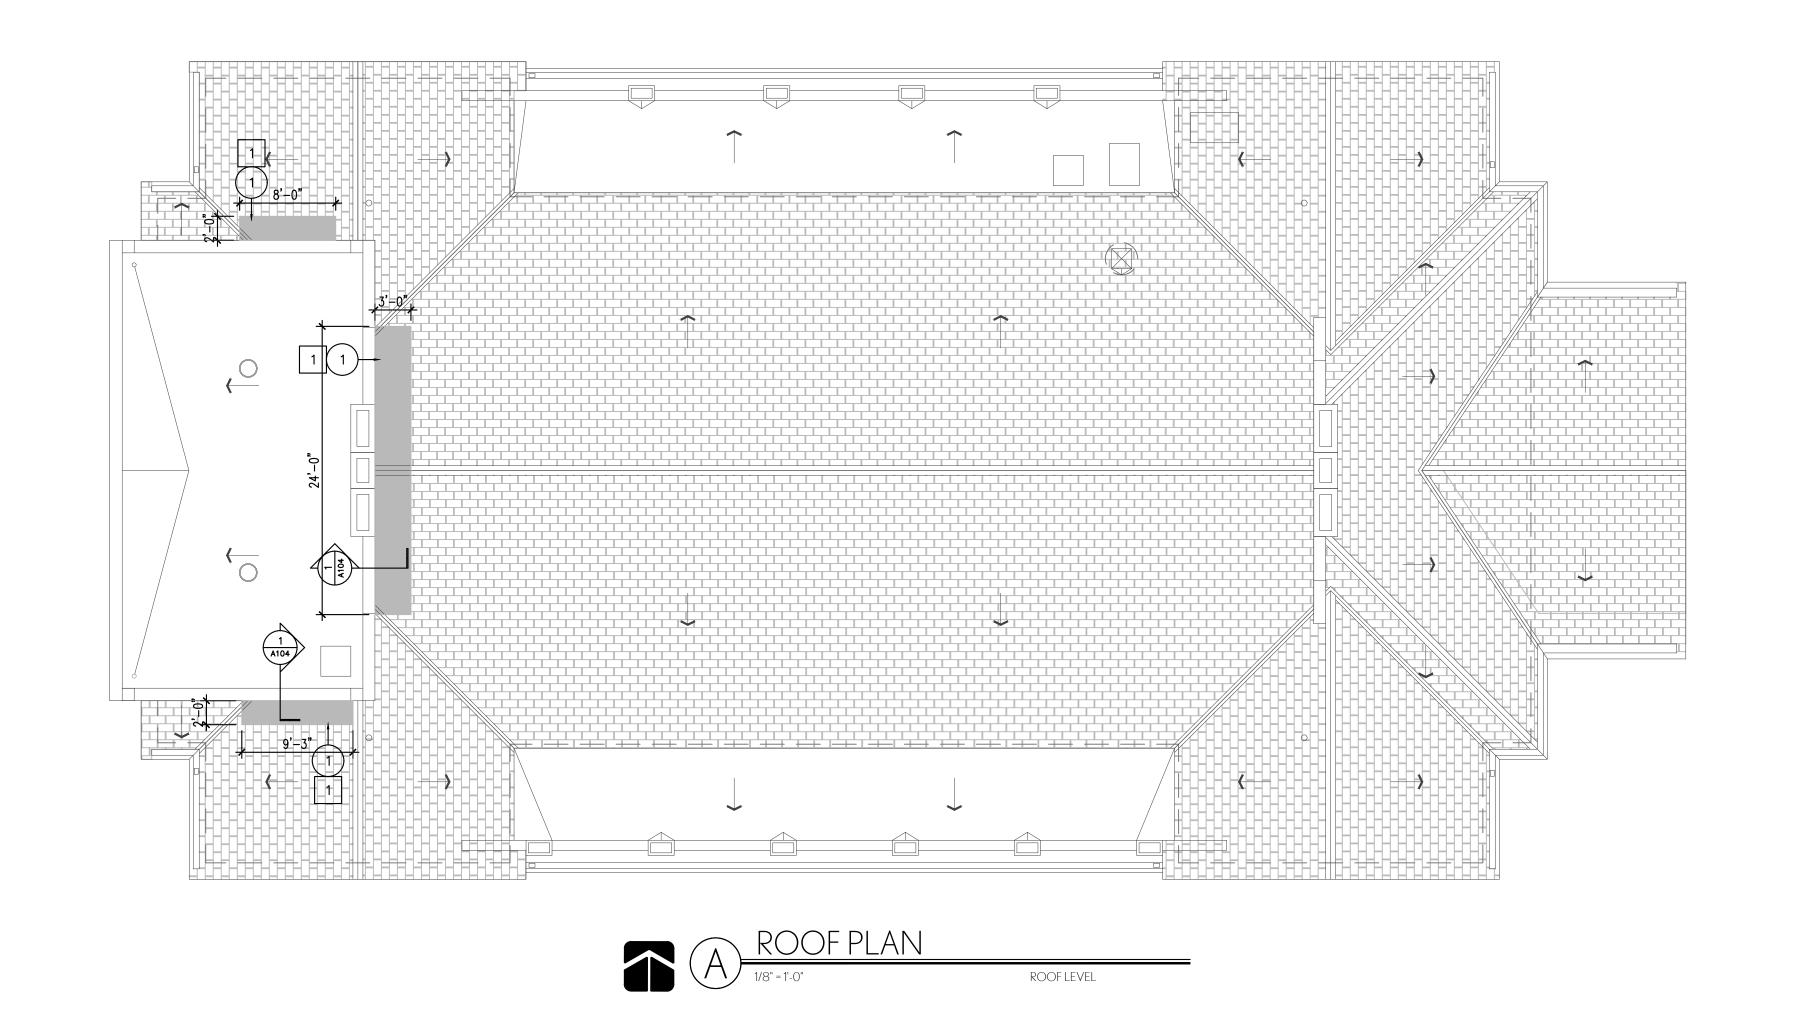


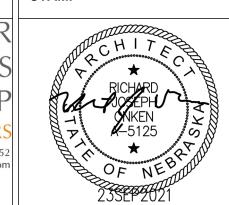







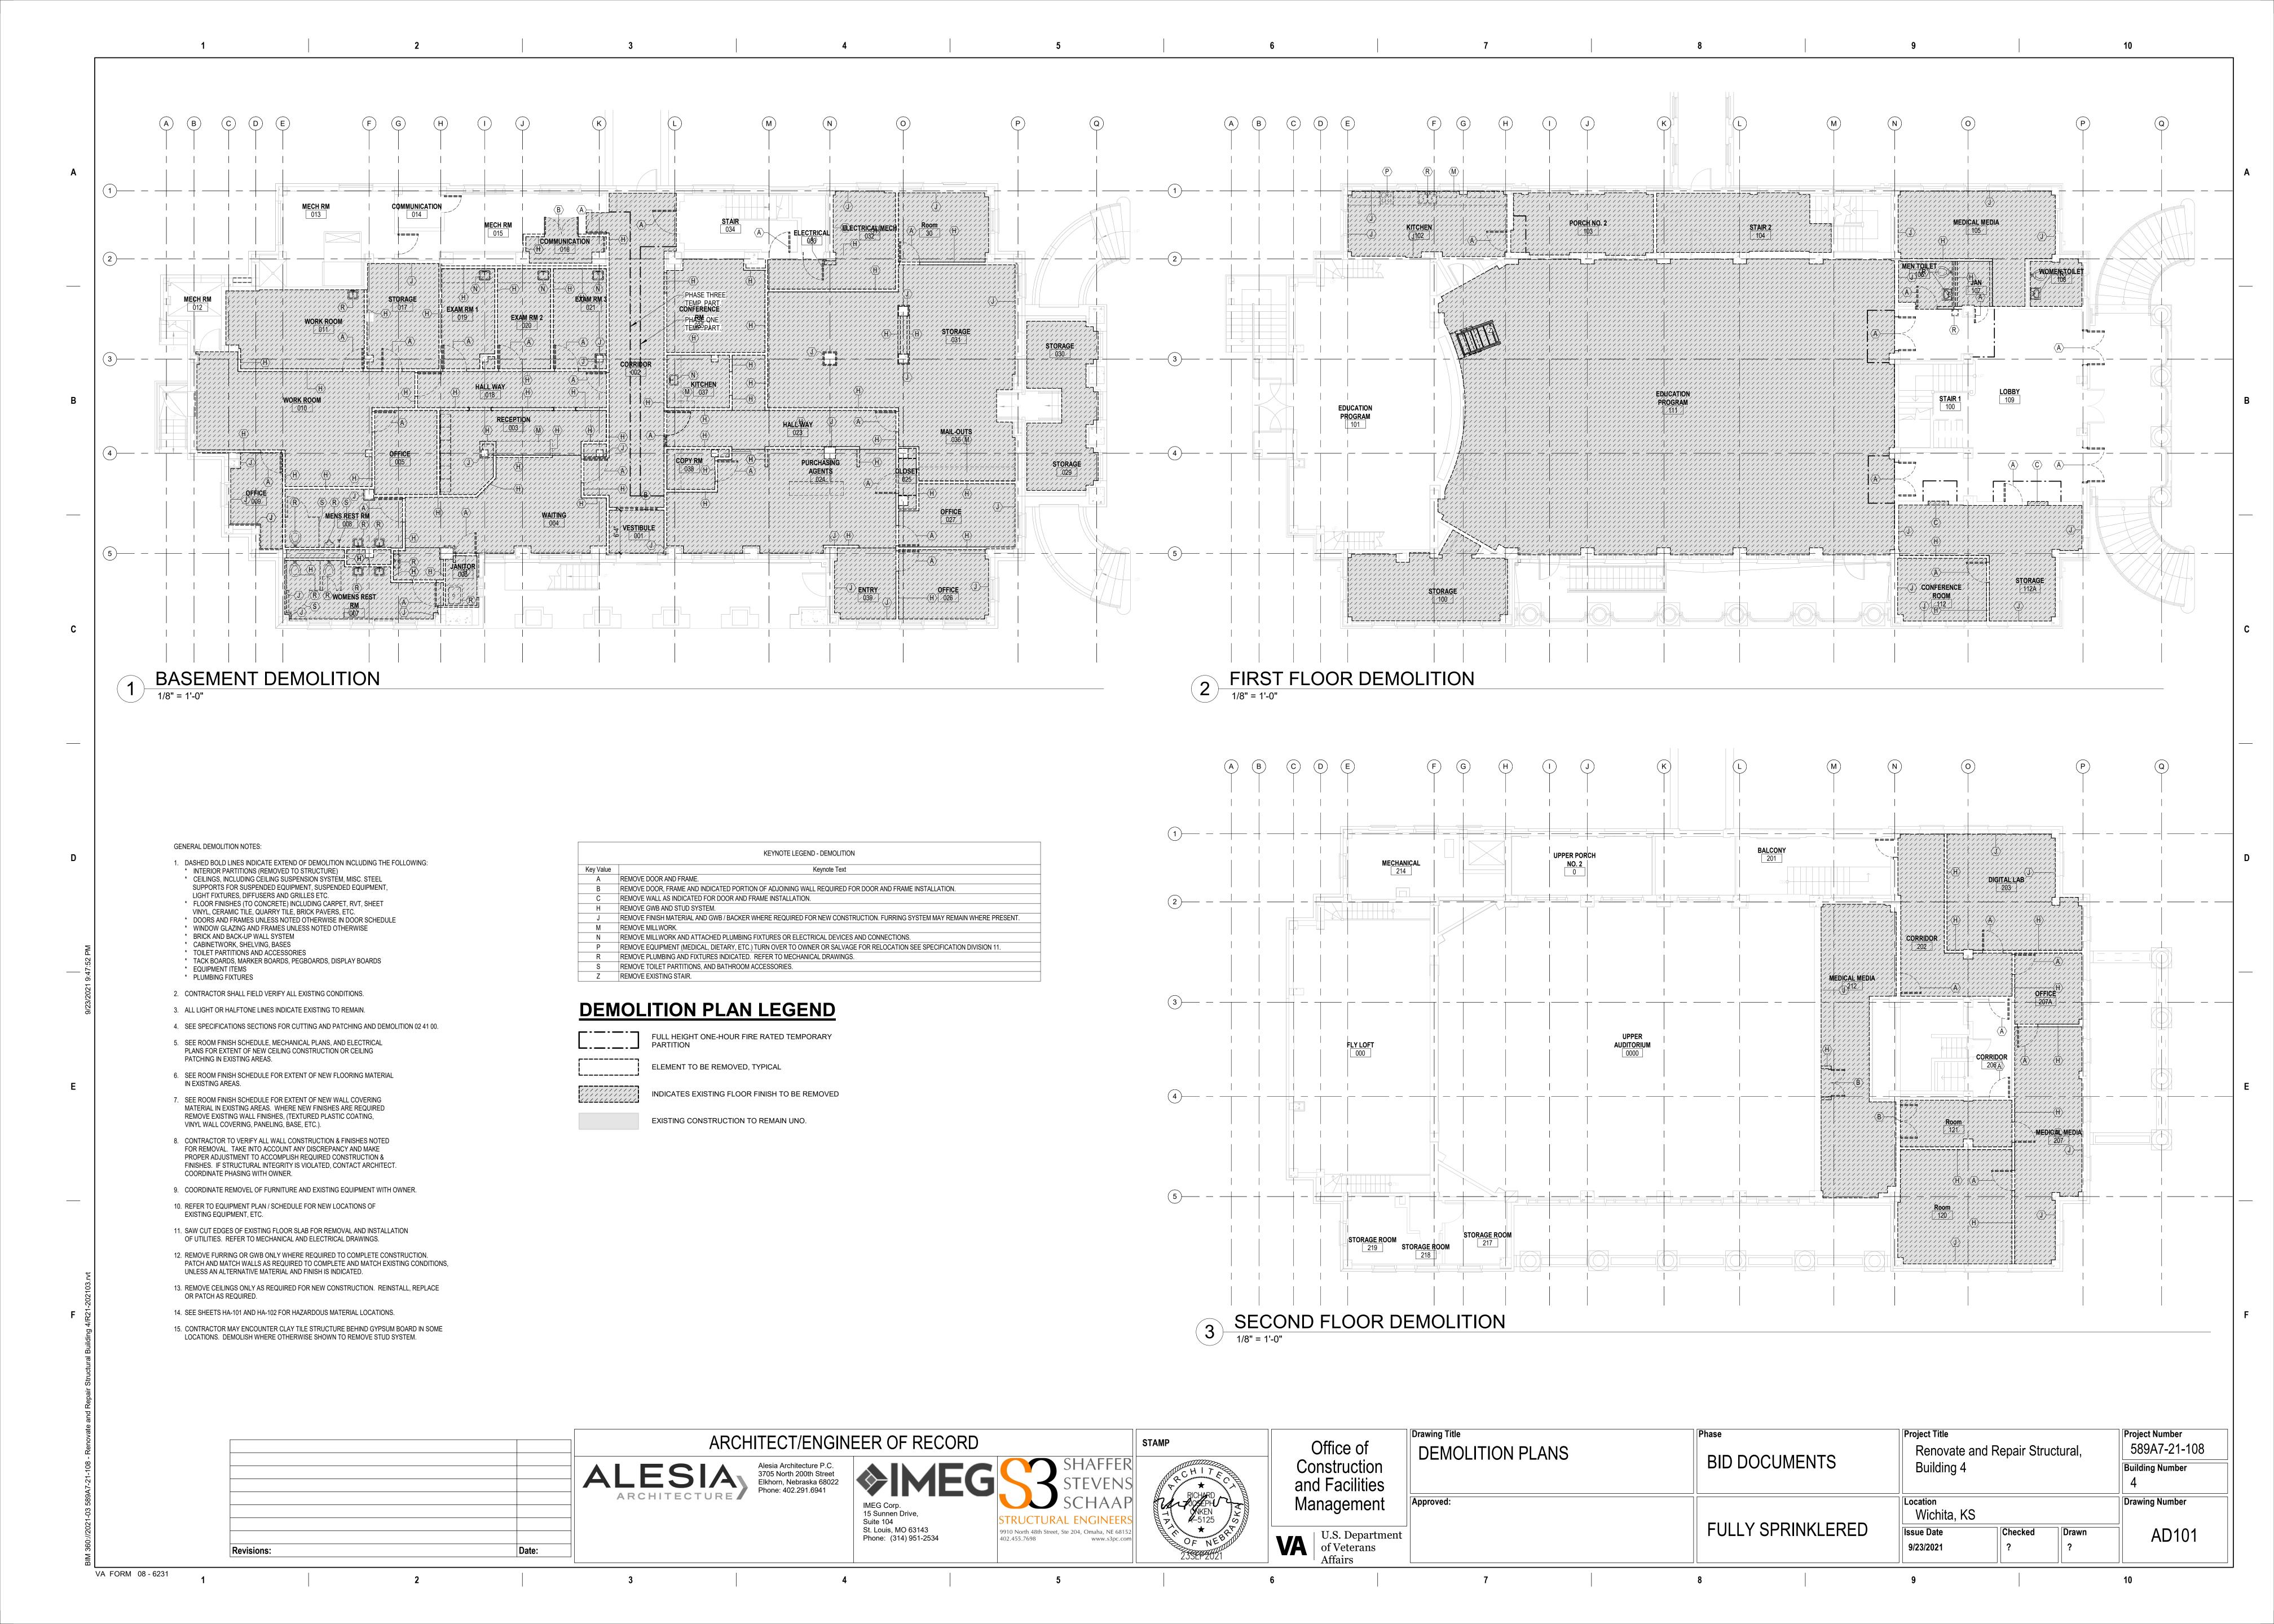

DEMOLITION NOTES

LEGEND

IN AREA SHOWN BY SHADING, REMOVE AND SALVAGE EXISTING CLAY TILE SHINGLES ON ROOF. REMOVE EXISTING ROOF UNDERLAYMENT AND ROOF DECK SHEATHING TO CLOSEST RAFTER OUTSIDE OF DAMAGED AREA AS SHOWN BY SHADING.

EXISTING INTERLOCKING CLAY TILE OVER (2) LAYERS OF 30# ASPHALTIC FELT OVER EXISTING 7/8" ROOF DECK. CONTRACTOR TO

VERIFY CONDITIONS OF EXISTING SUBSTRATE.

LOCATIONS OF ROOF WORK TO BE DONE

PLAN NOTES

INSTALL NEW 7/8" BCX PLYWOOD SHEATHING, NEW

DOUBLE LAYER 30# ASPHALTIC FELT UNDERLAYMENT,
AND NEW COPPER FLASHING AS PER DETAIL 1-4/A104
IN AREA AS SHOWN BY SHADING TO CLOSEST RAFTER
OUTSIDE OF DAMAGE AREA. CONTRACTOR TO FIELD
VERIFY RAFTER LOCATION. REINSTALL SALVAGED CLAY
TILES BACK IN PLACE IN ACCORDANCE WITH
MANUFACTURER'S INSTALLATION RECOMENDATIONS, REF.


GENERAL NOTES


- PROTECT EXISTING ROOFTOP EQUIPMENT AND MATERIALS TO REMAIN DURING CONSTRUCTION.
- PROTECT BUILDING SIDING, SIDEWALKS, LAWNS, ETC. DURING CONSTRUCTION.
 PLANS ARE DIAGRAMMATIC IN NATURE AND ONLY REPRESENT ROOF TOP EQUIPMENT RELATIVE LOCATIONS THAT WERE PRESENT AT THE TIME OF SITE REVIEW.
- LOCATIONS ARE NOT EXACT AND SHALL BE FIELD VERIFIED BY CONTRACTOR PRIOR TO DEMOLITION OR REROOFING WORK.

 4. UNDOCUMENTED MISCELLANEOUS ROOF TOP ITEMS

10

- SHALL BE FIELD VERIFIED BY CONTRACTOR AND ROOFING WORK AROUND SUCH ITEMS SHALL BE PART OF SCOPE FOR COMPLETE AND WEATHER TIGHT PROJECT.
- AFTER REMOVAL OF EXISTING ROOFING MATERIALS, CONTRACTOR SHALL VERIFY AND CORRECT CONDITIONS OF EXISTING DECK OR SUBSTRATE.
- REMOVE EXISTING AND REPLACE BOOTS, PITCH PANS, AND OTHER PIPE FLASHING PIECES AT PLUMBING AND CONDUIT PIPE PENETRATIONS.
- 7. MAINTAIN, PROTECT, AND RESET EXISTING METAL CURB FLASHING AND OTHER METAL OR ALUMINUM FLASHINGS FOR REUSE, UNLESS OTHERWISE NOTED.
- 8. FIELD VERIFY ALL DIMENSIONS.
- 9. EXISTING SHINGLE ROOF PITCHES ARE 9:12.

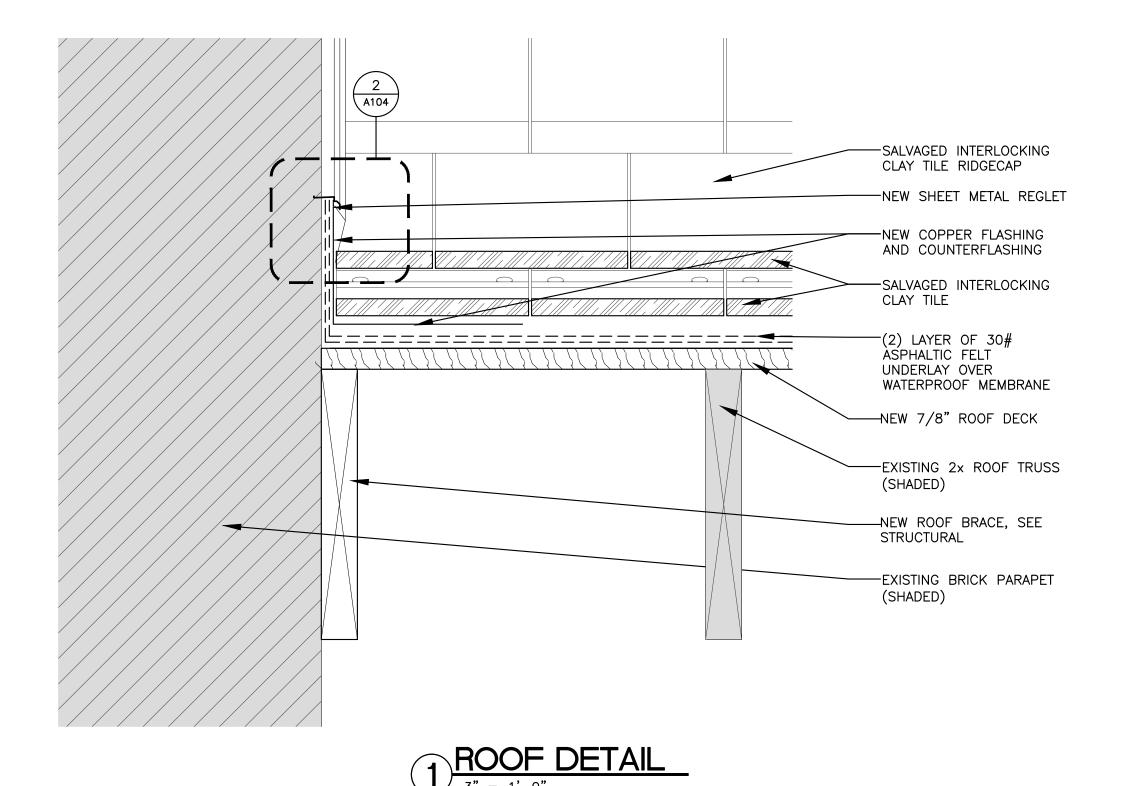

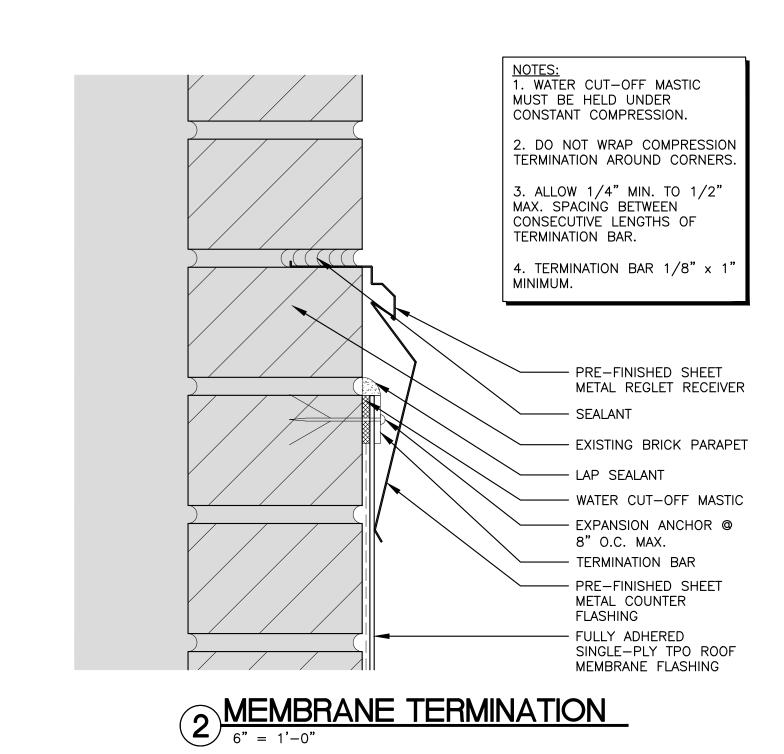


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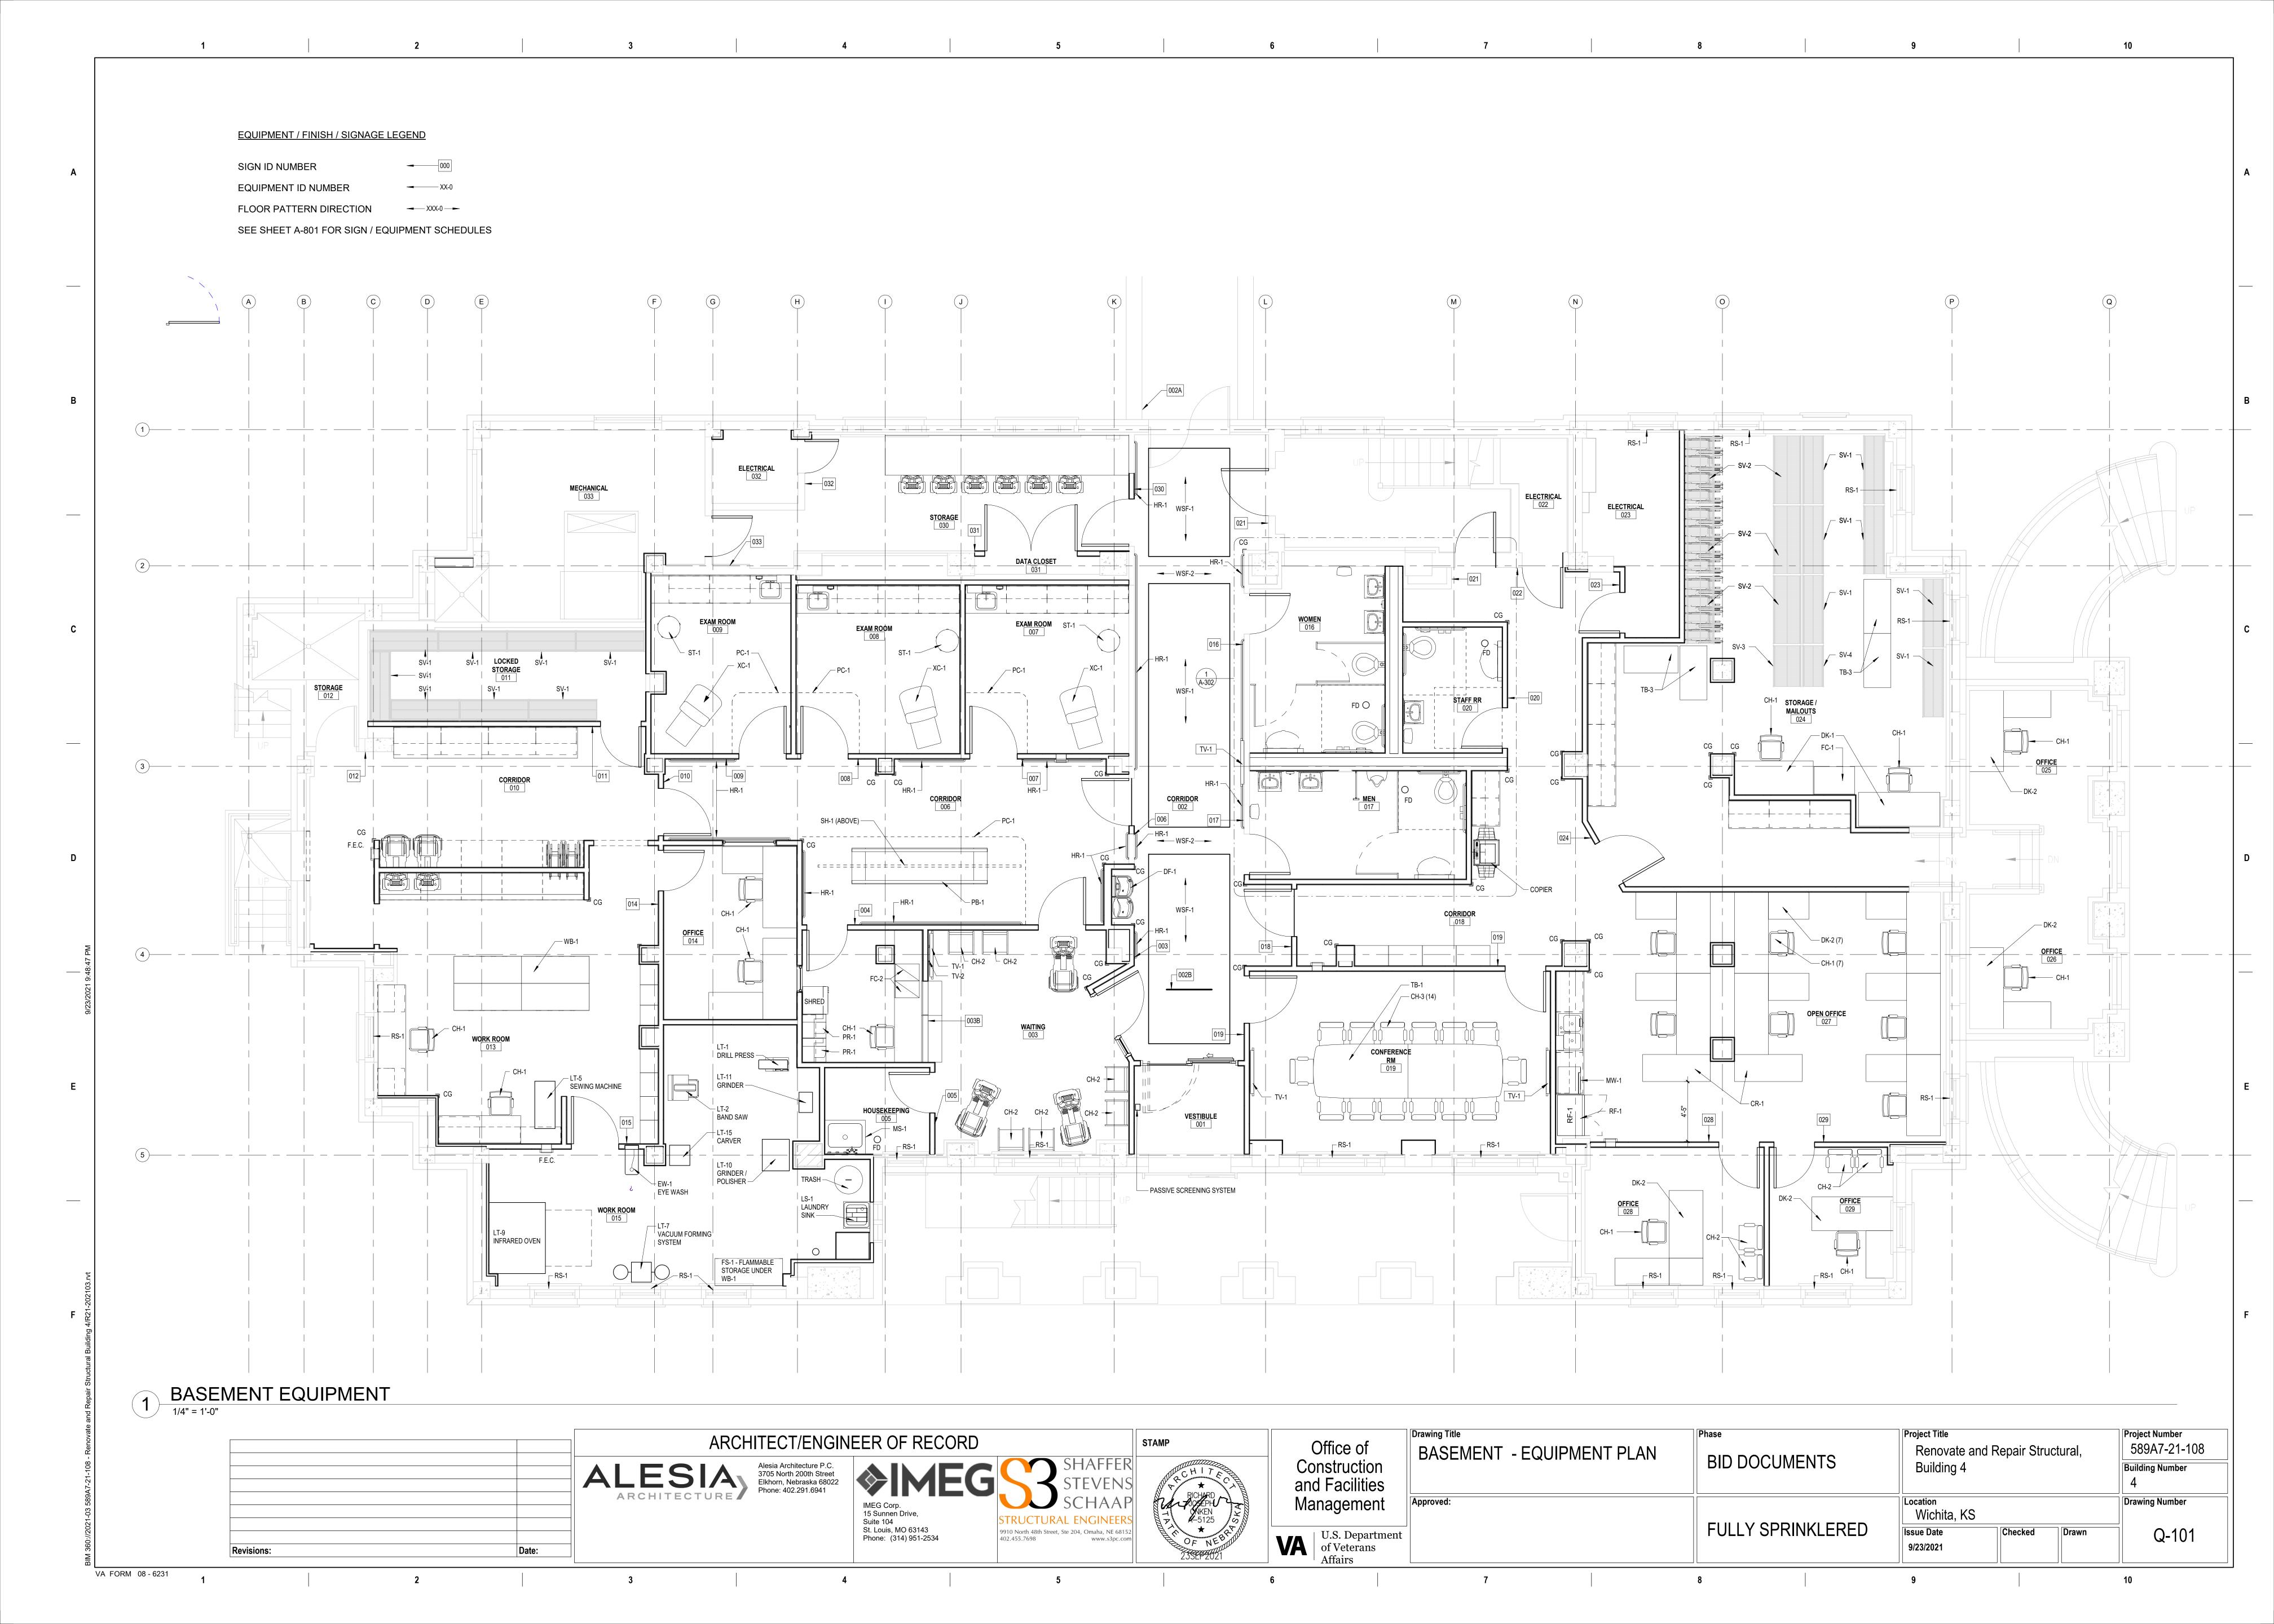
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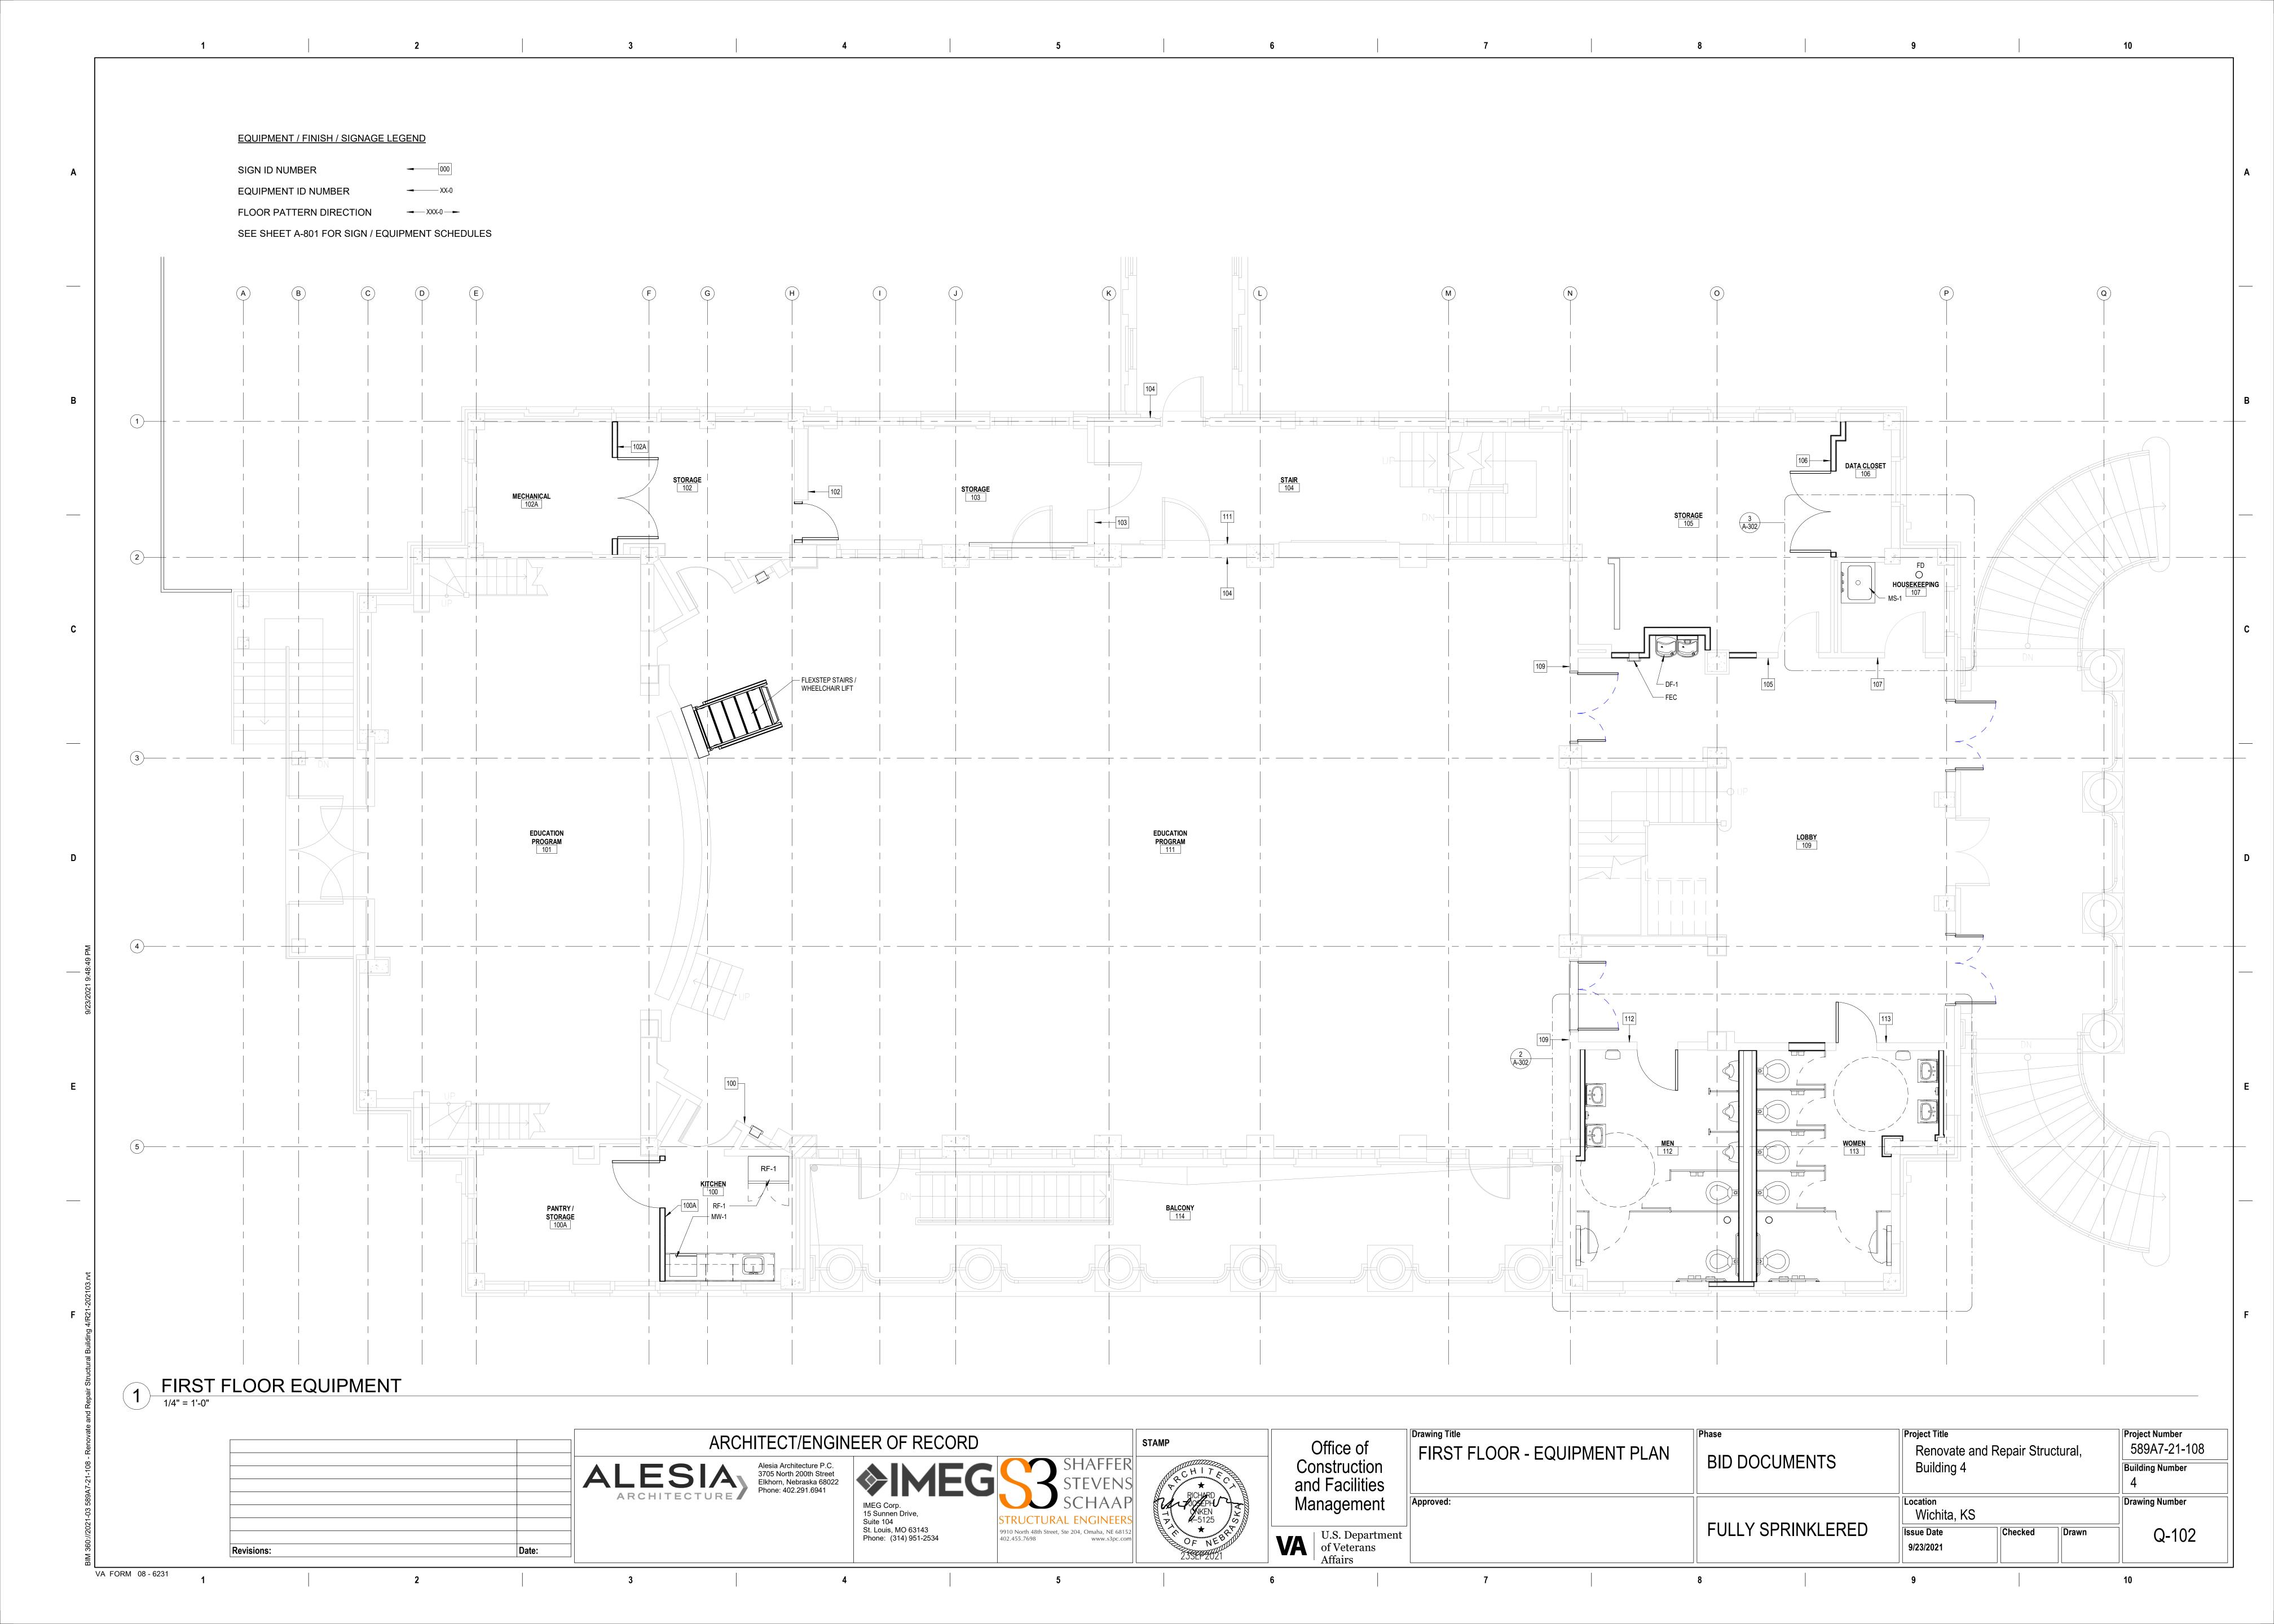
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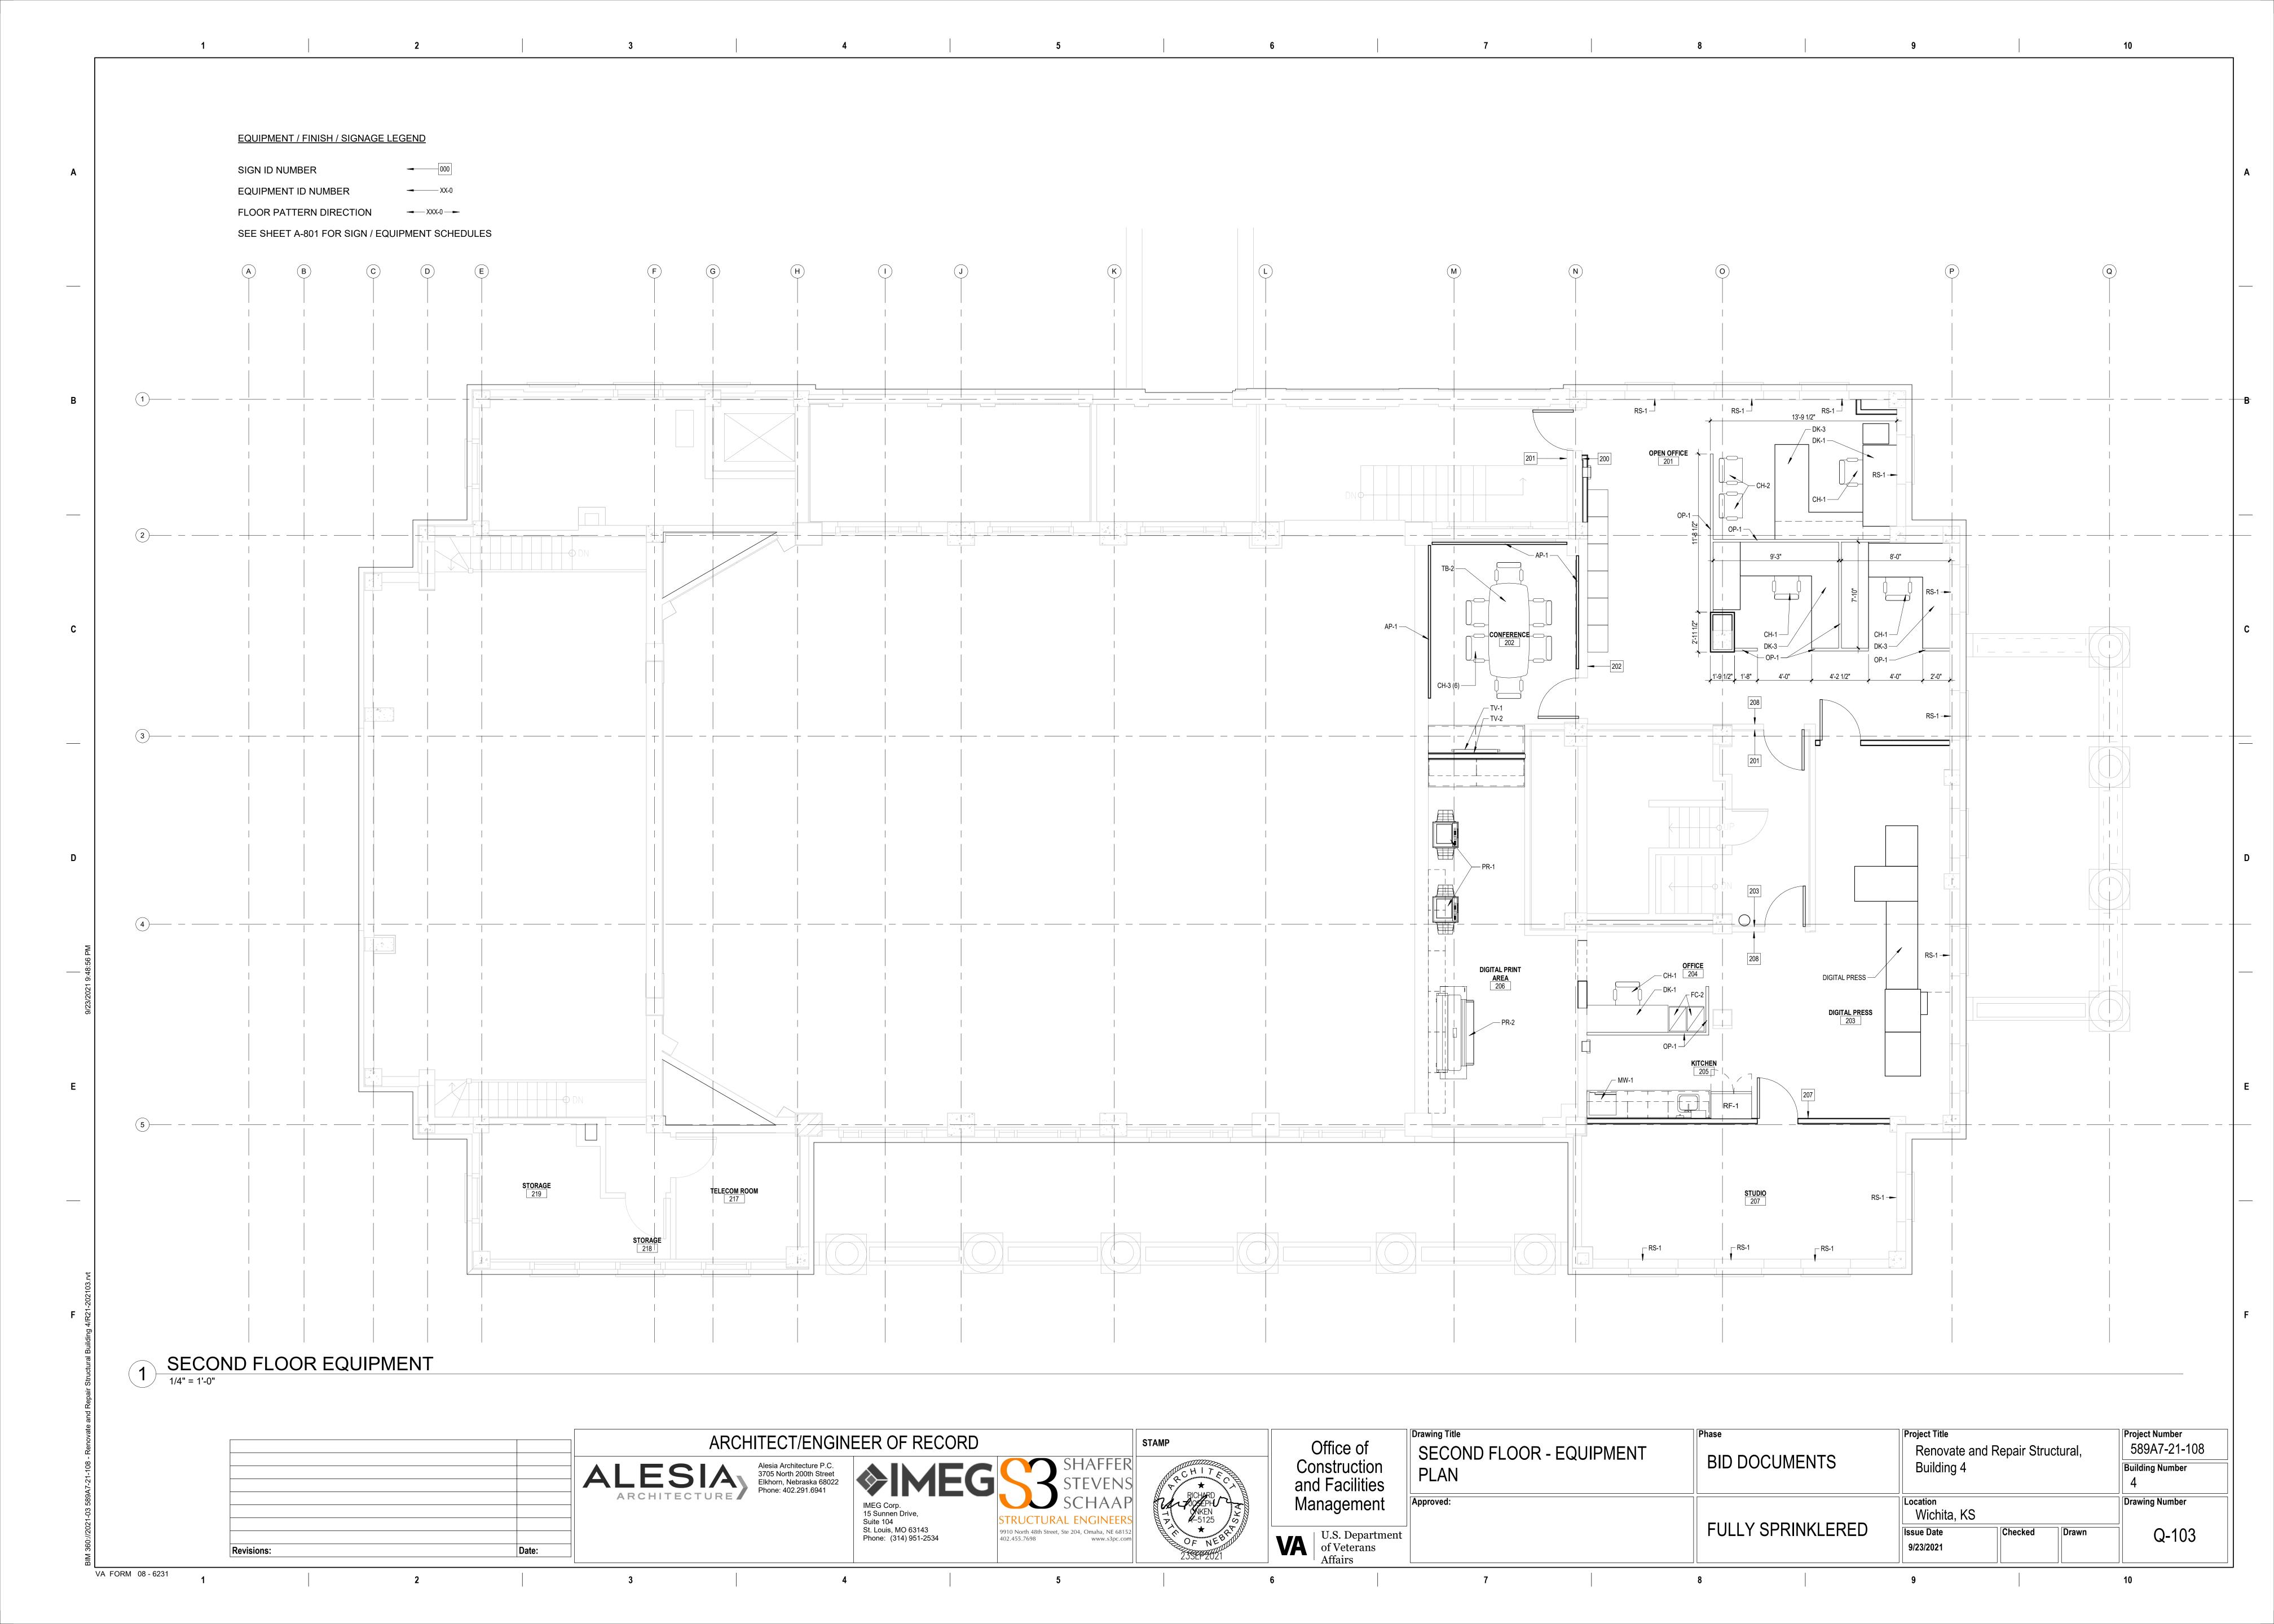



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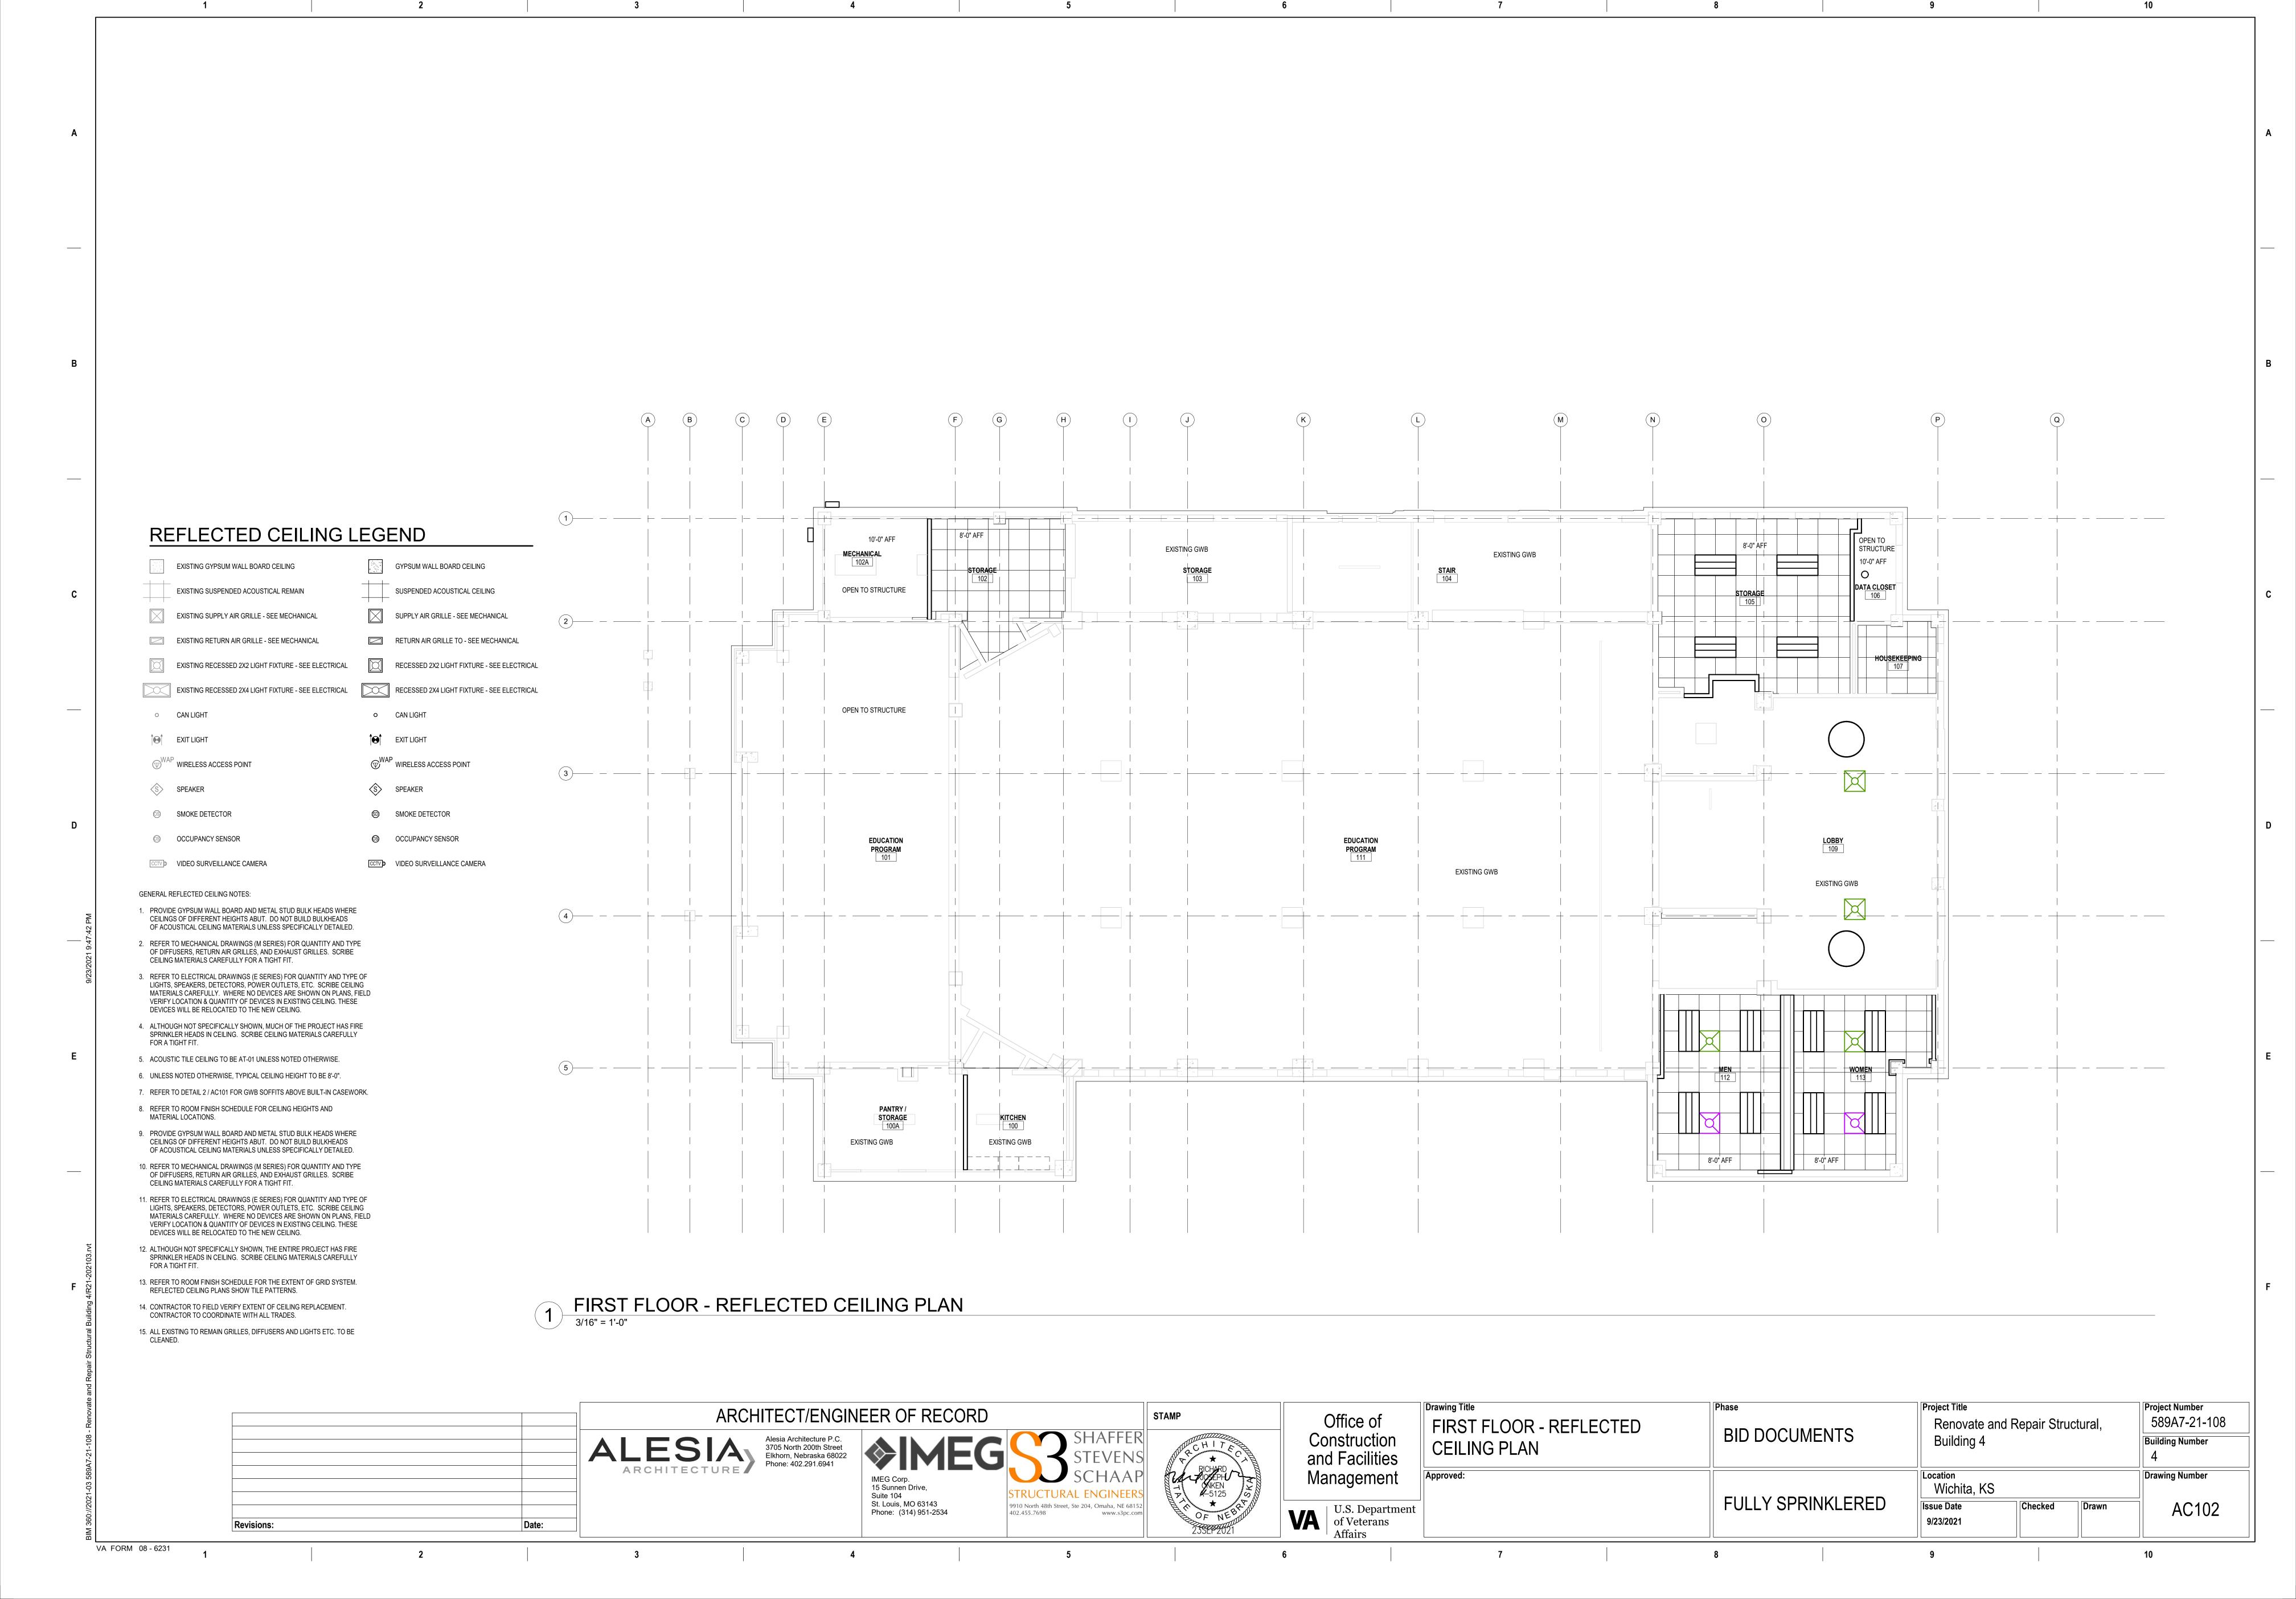
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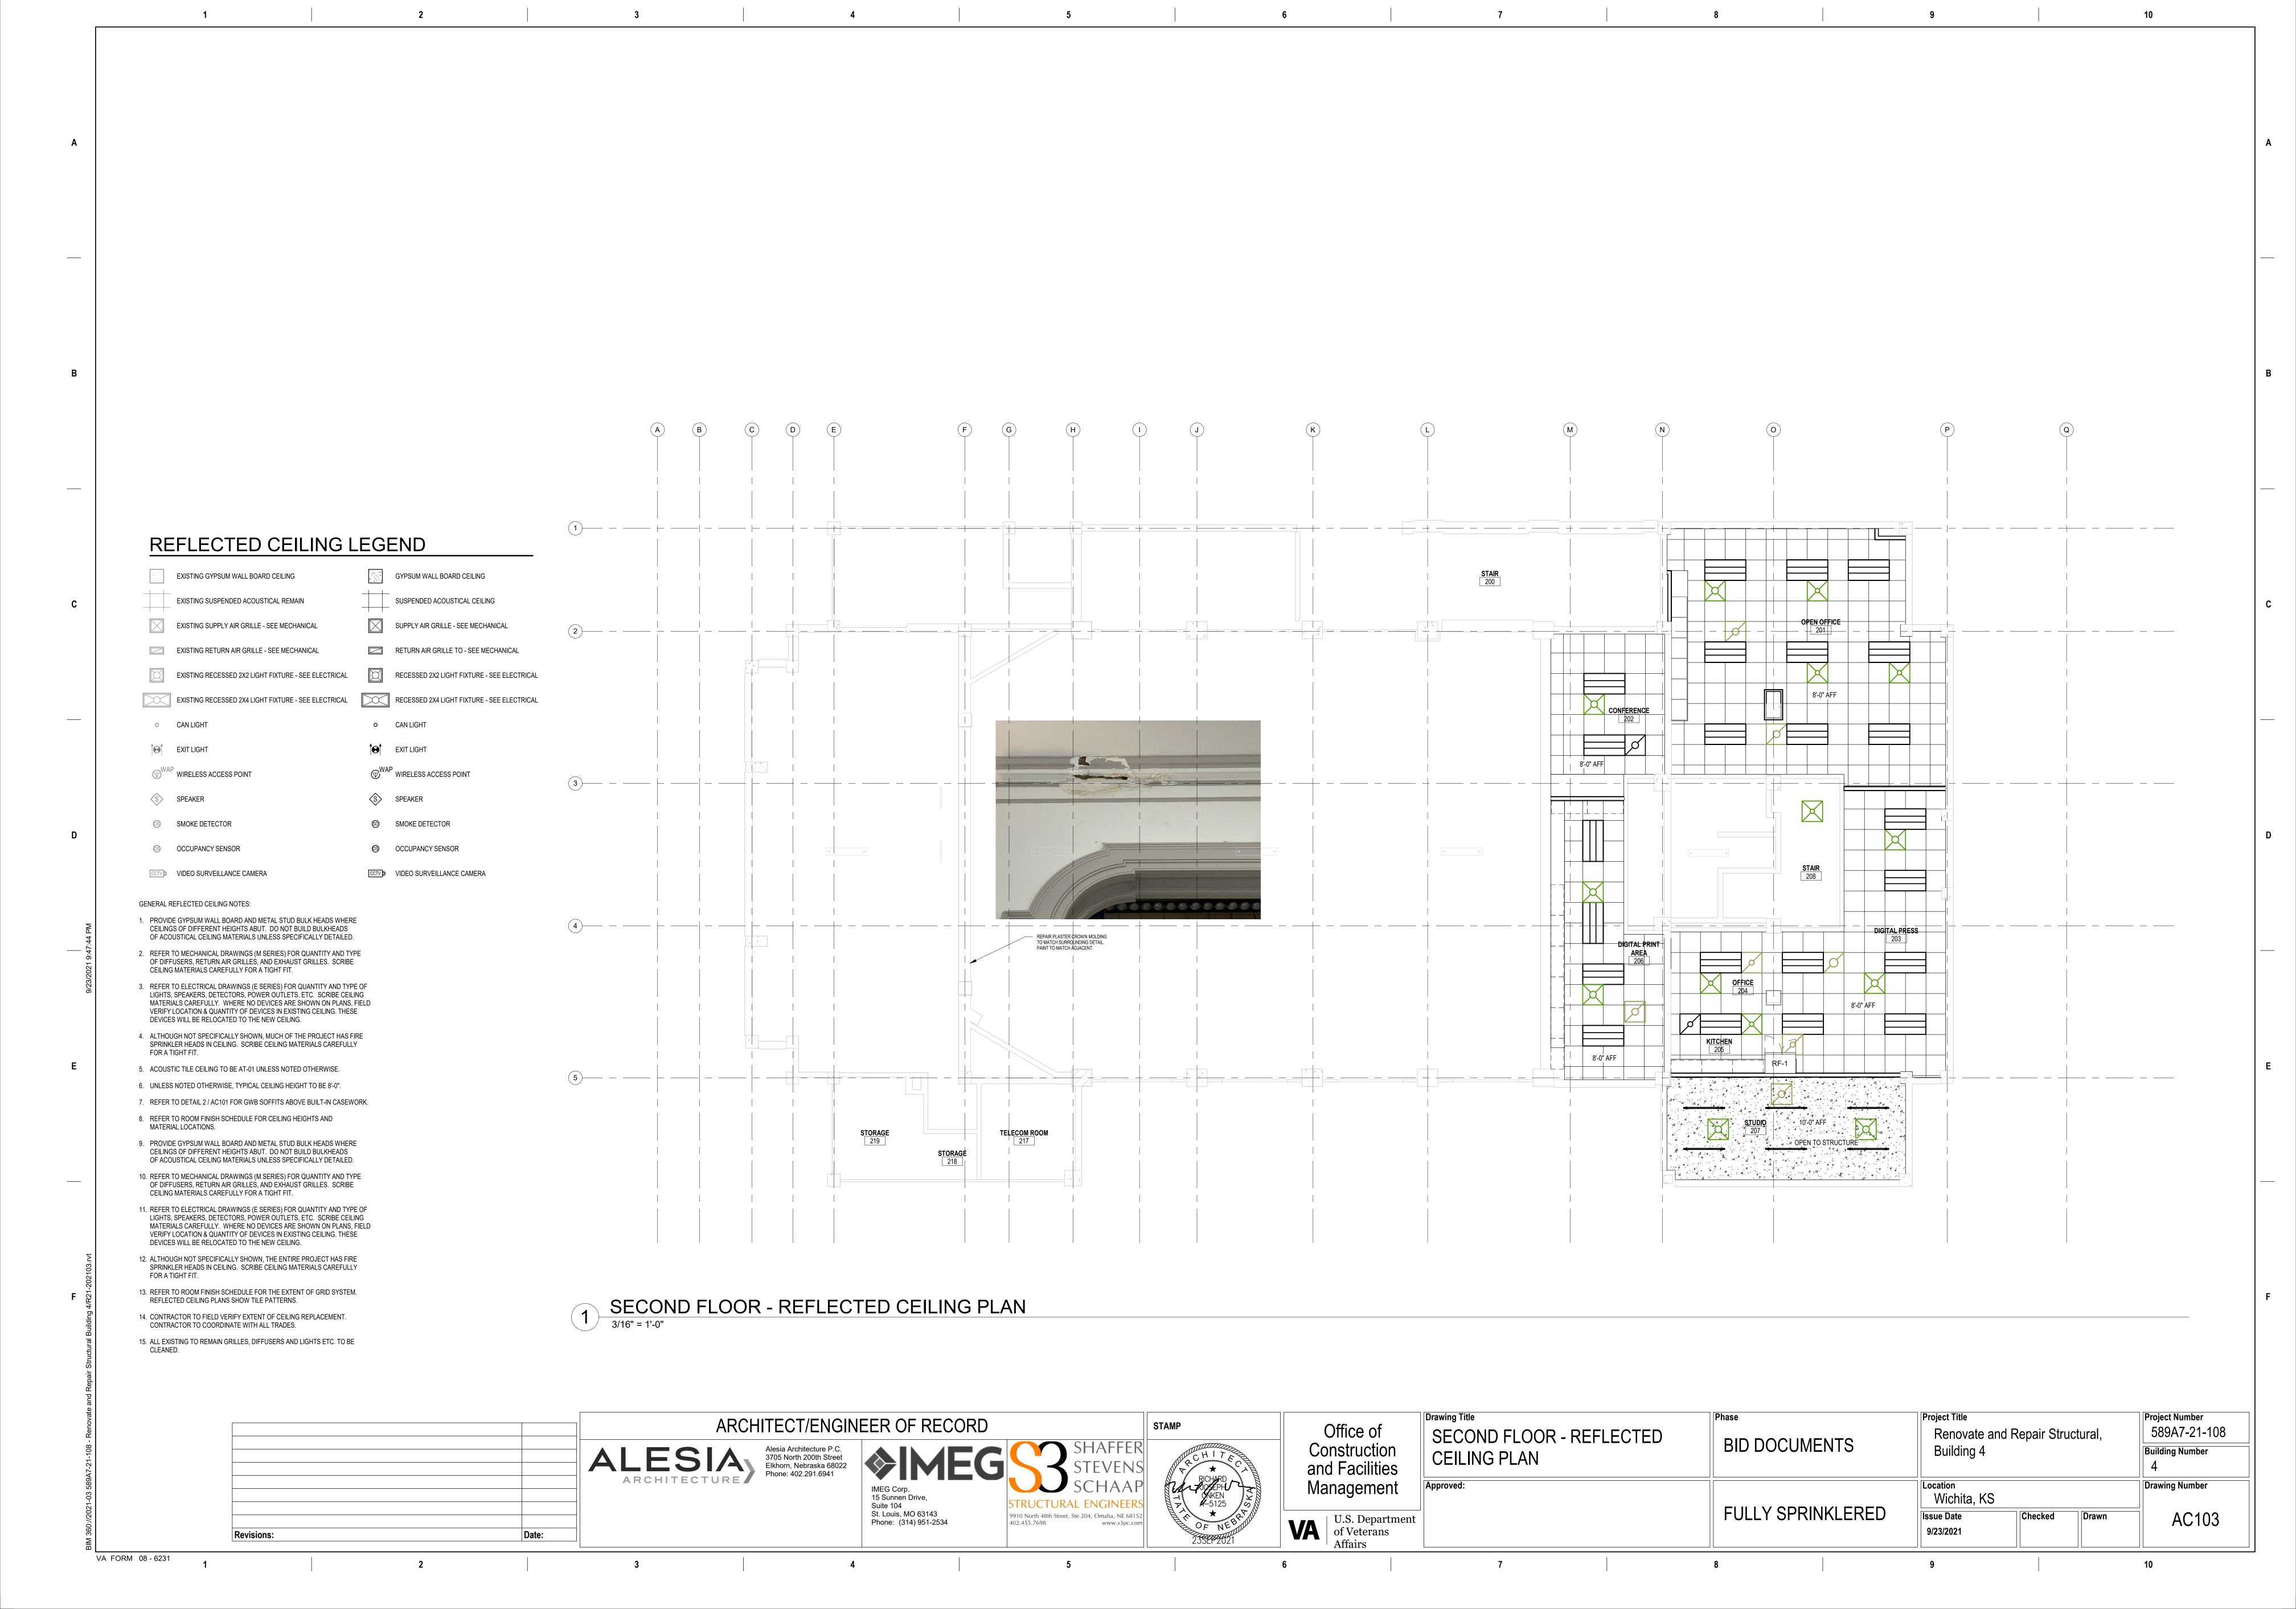








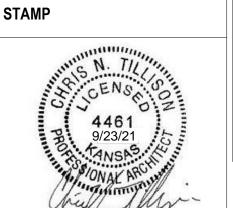





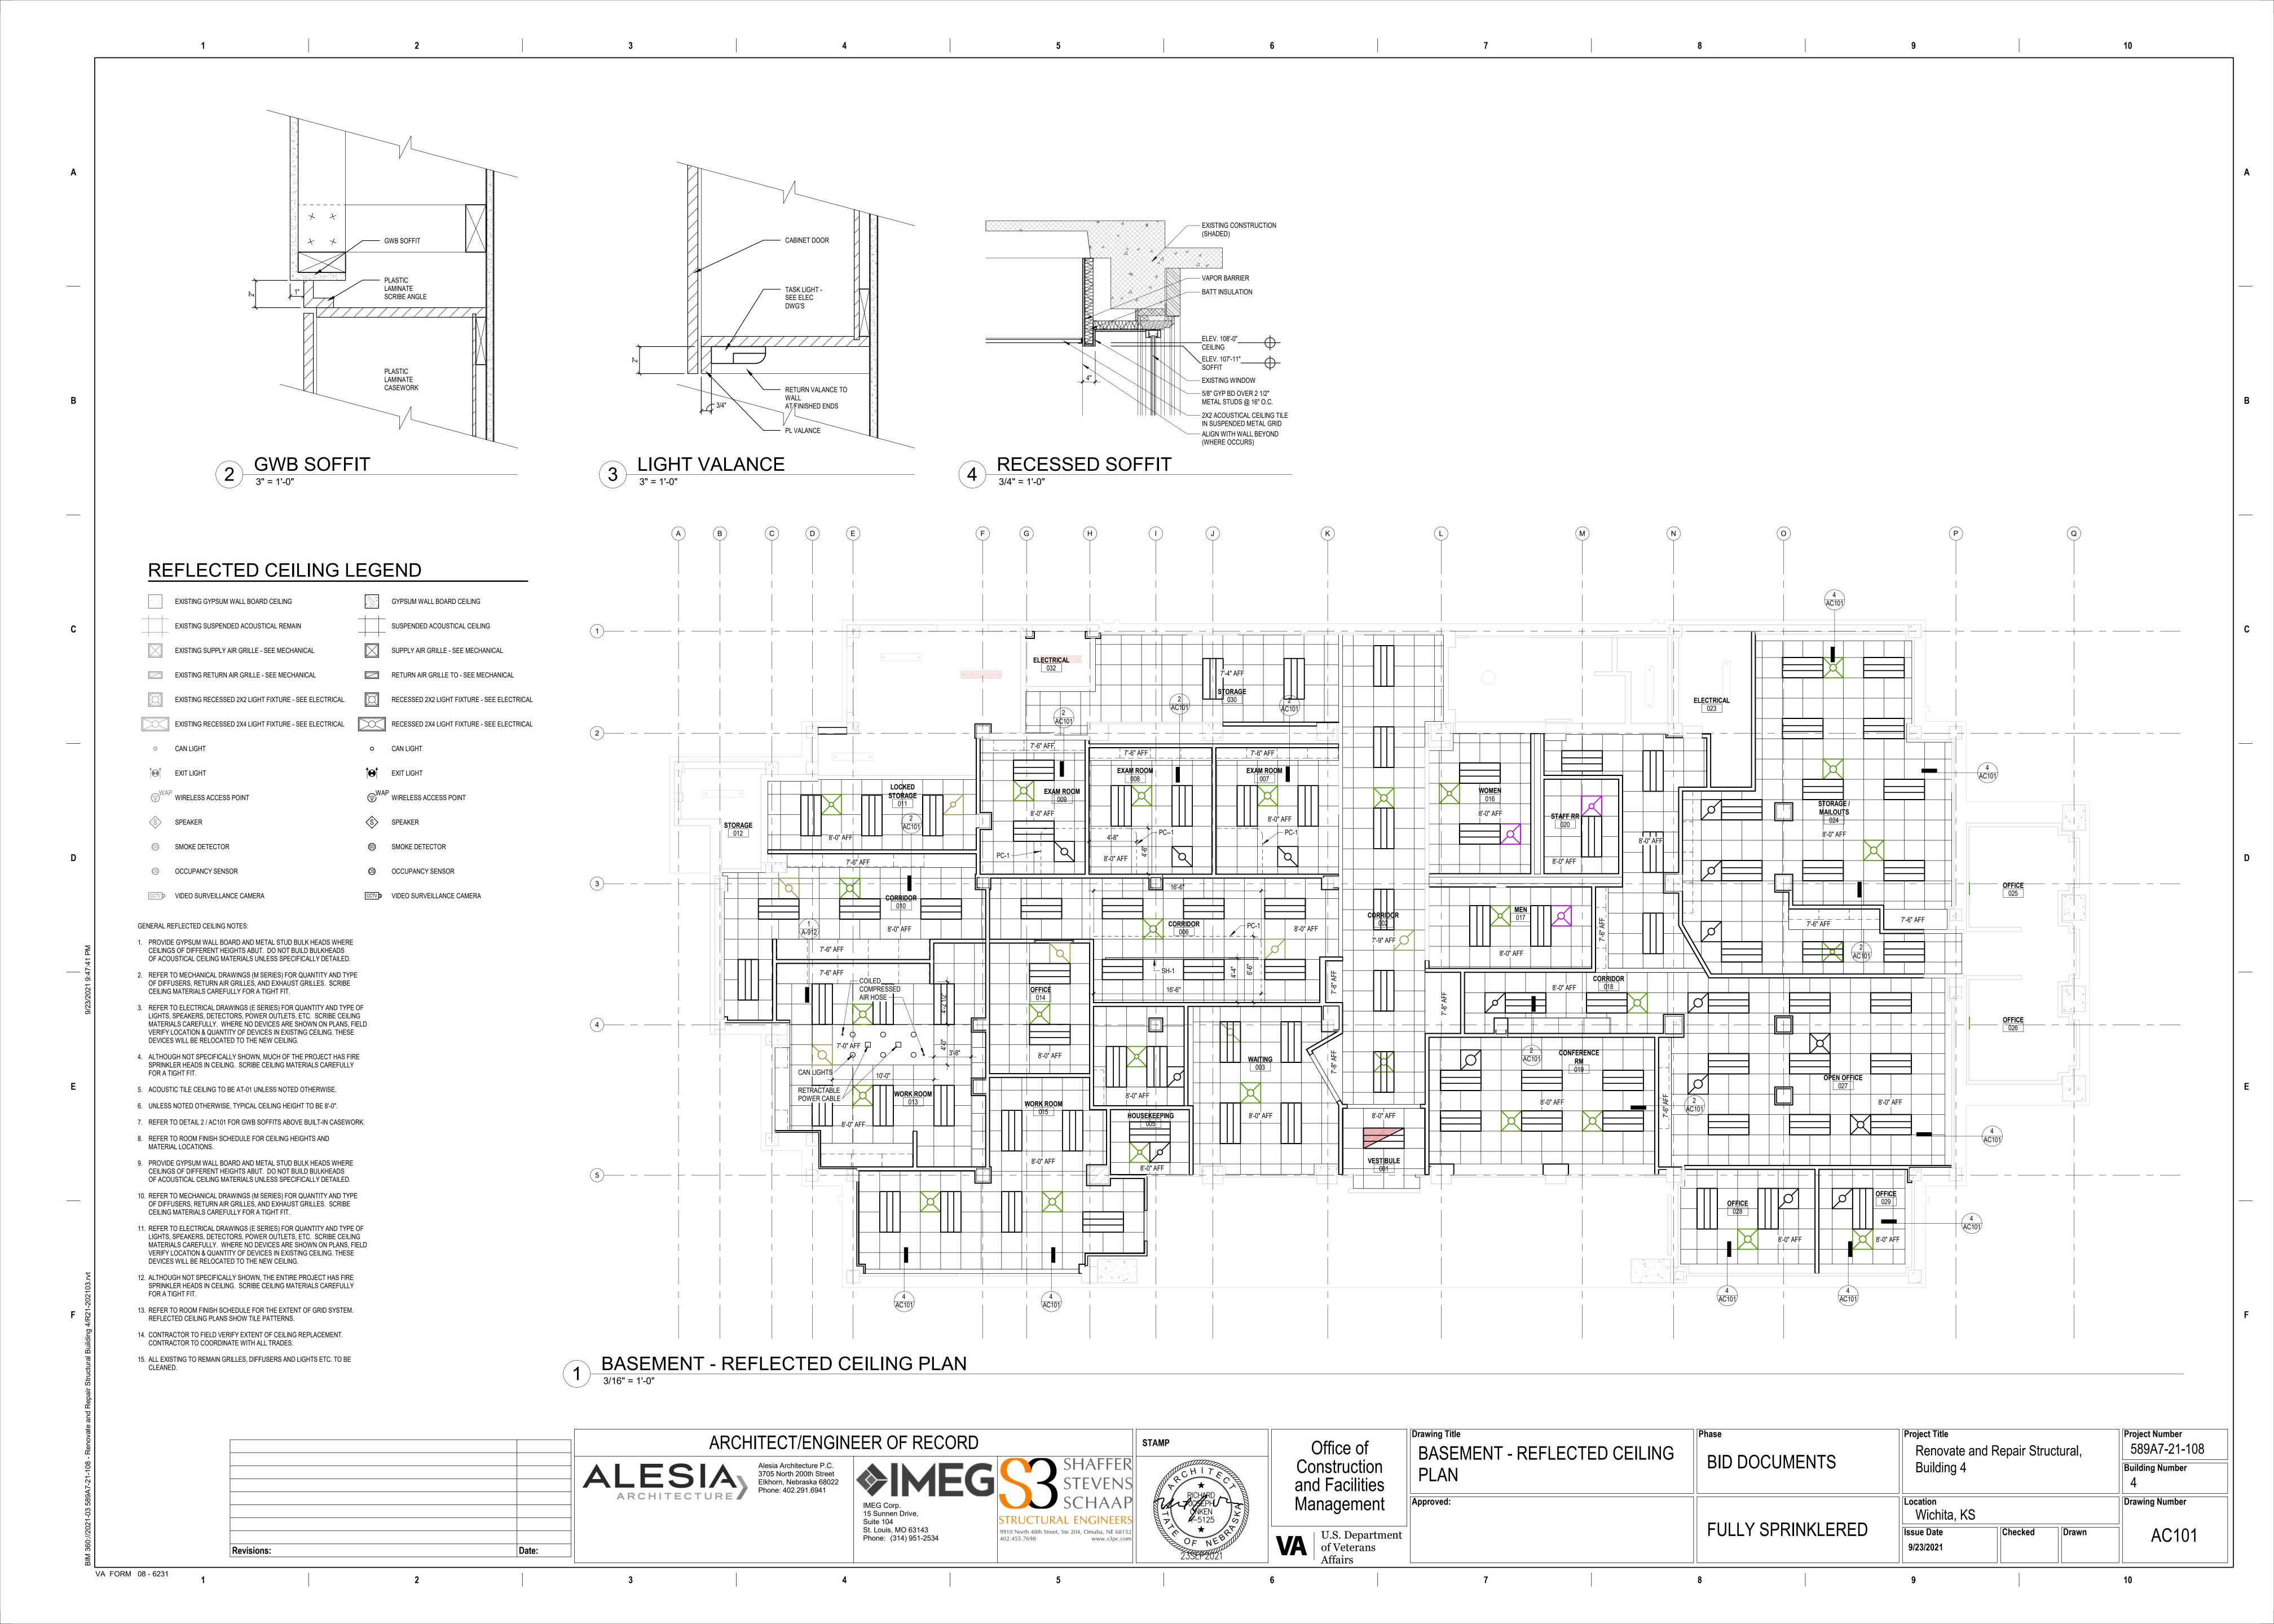


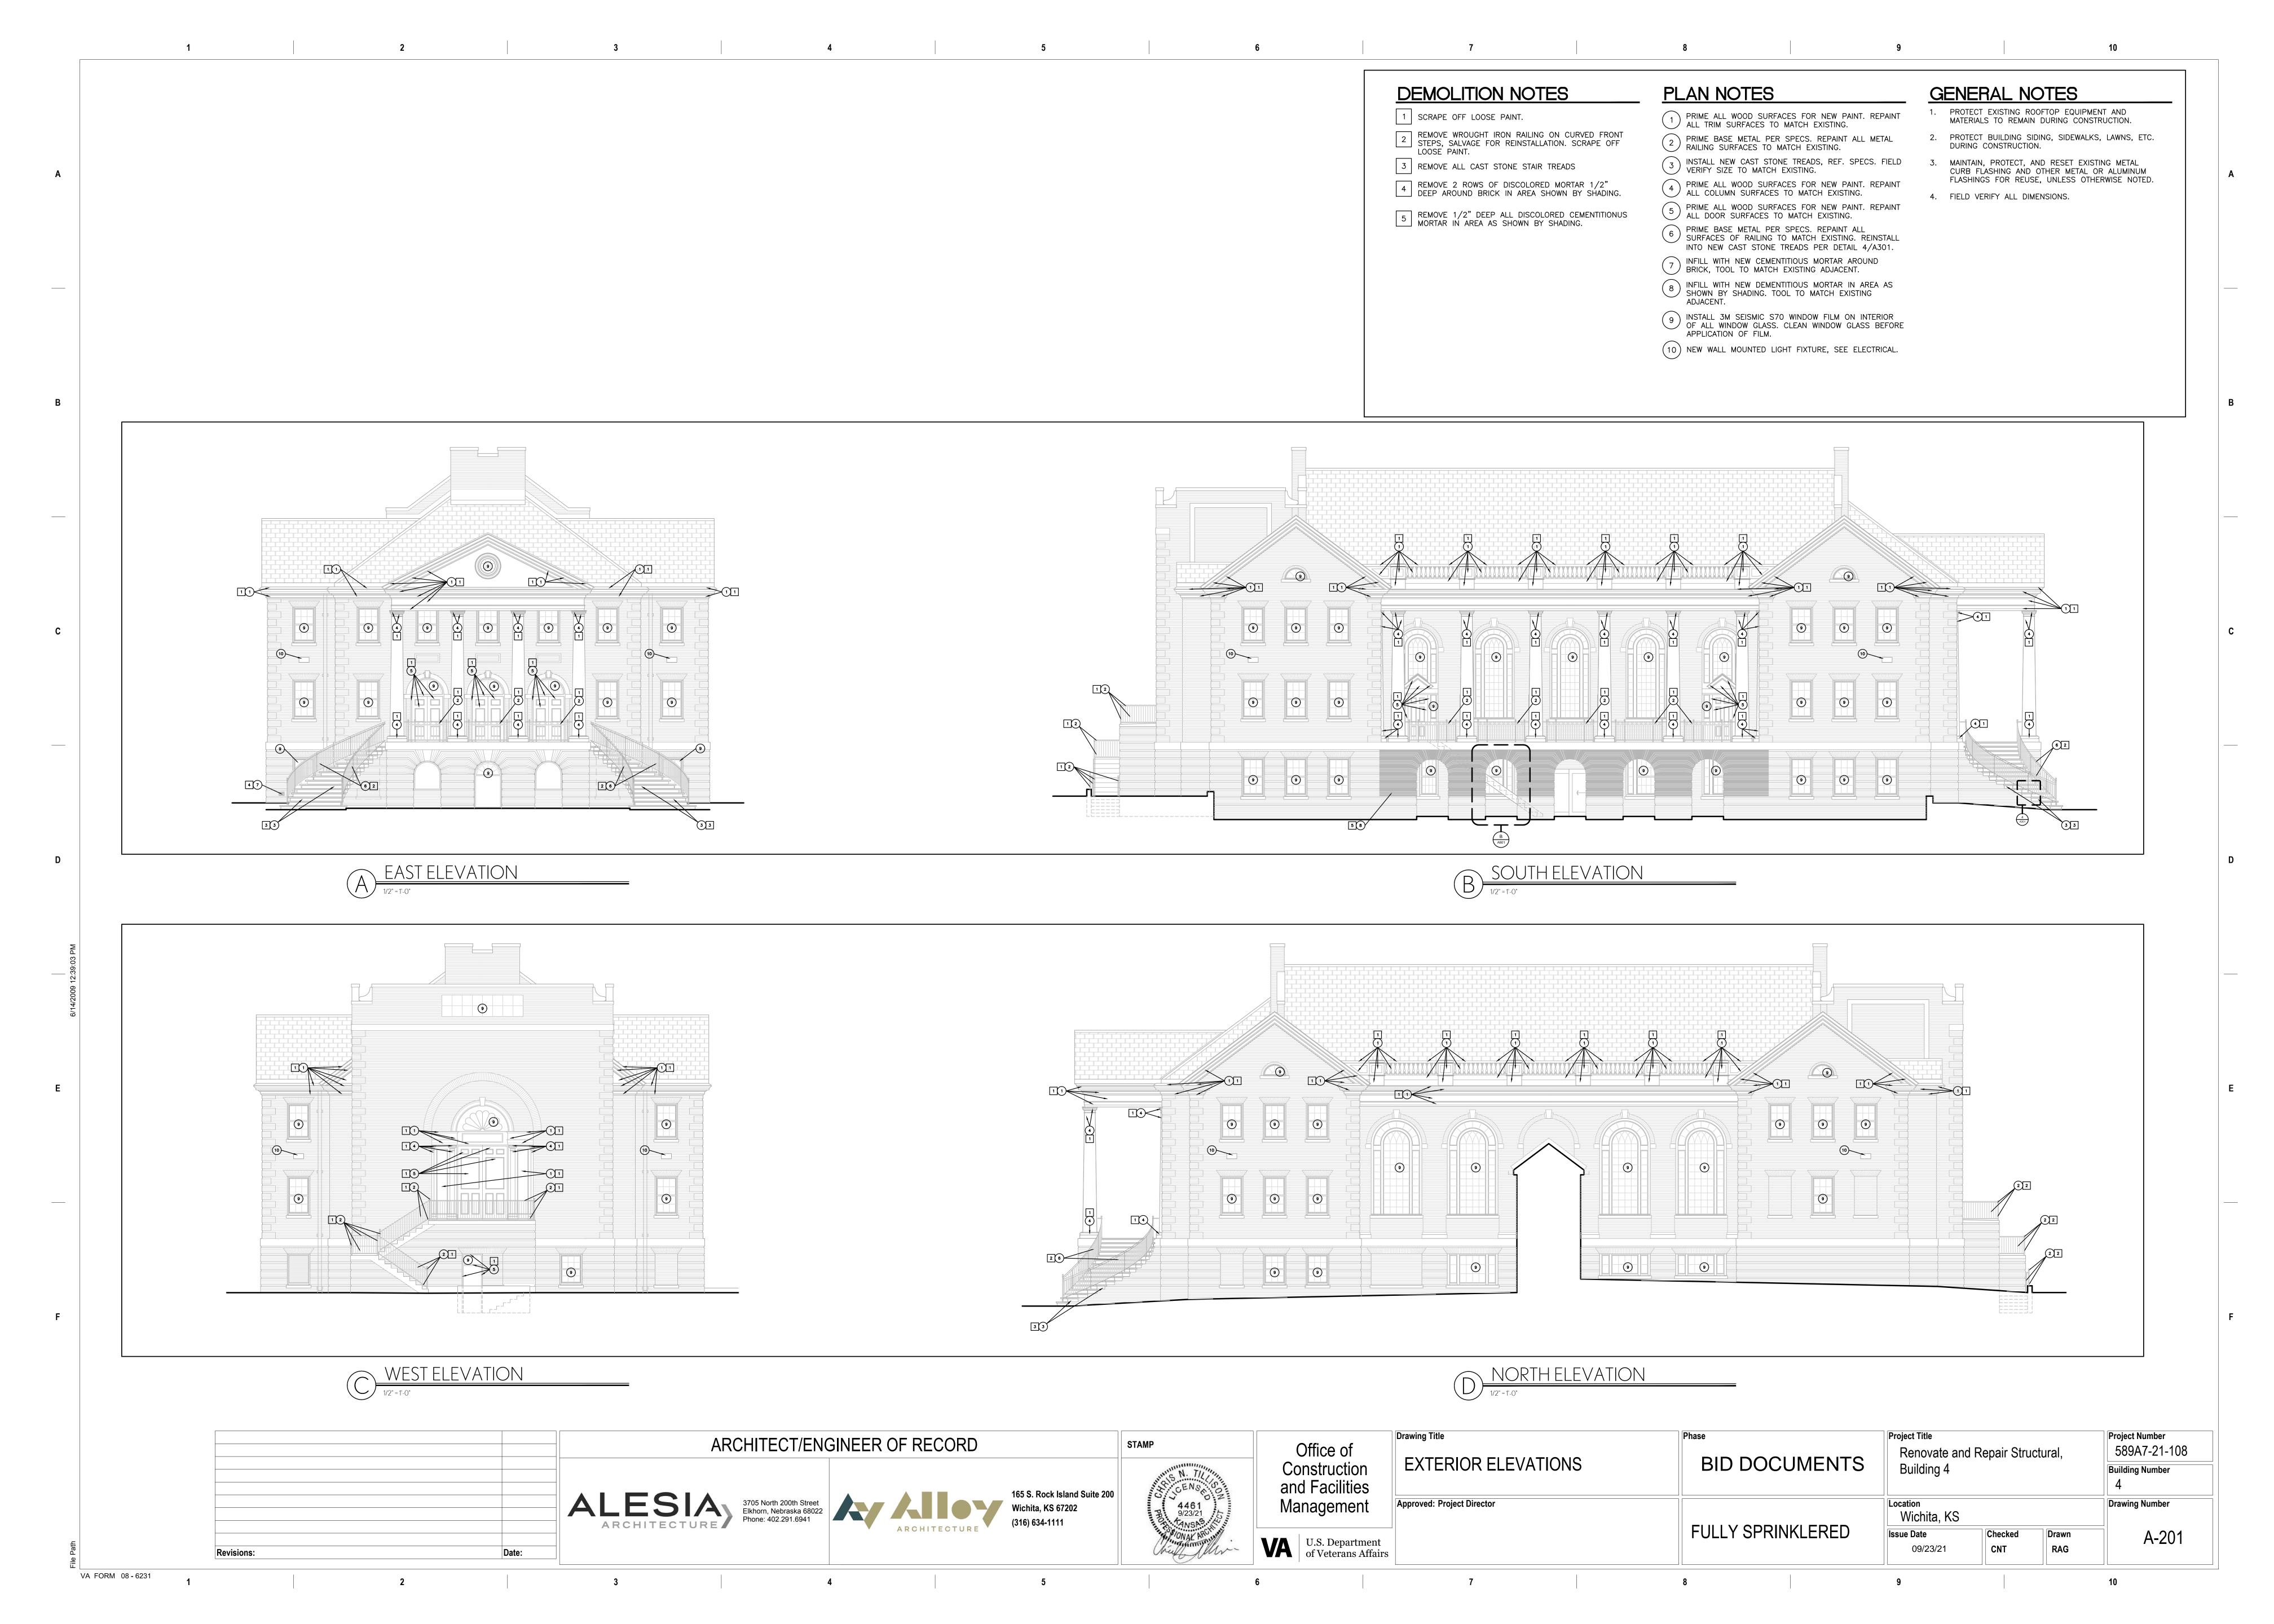


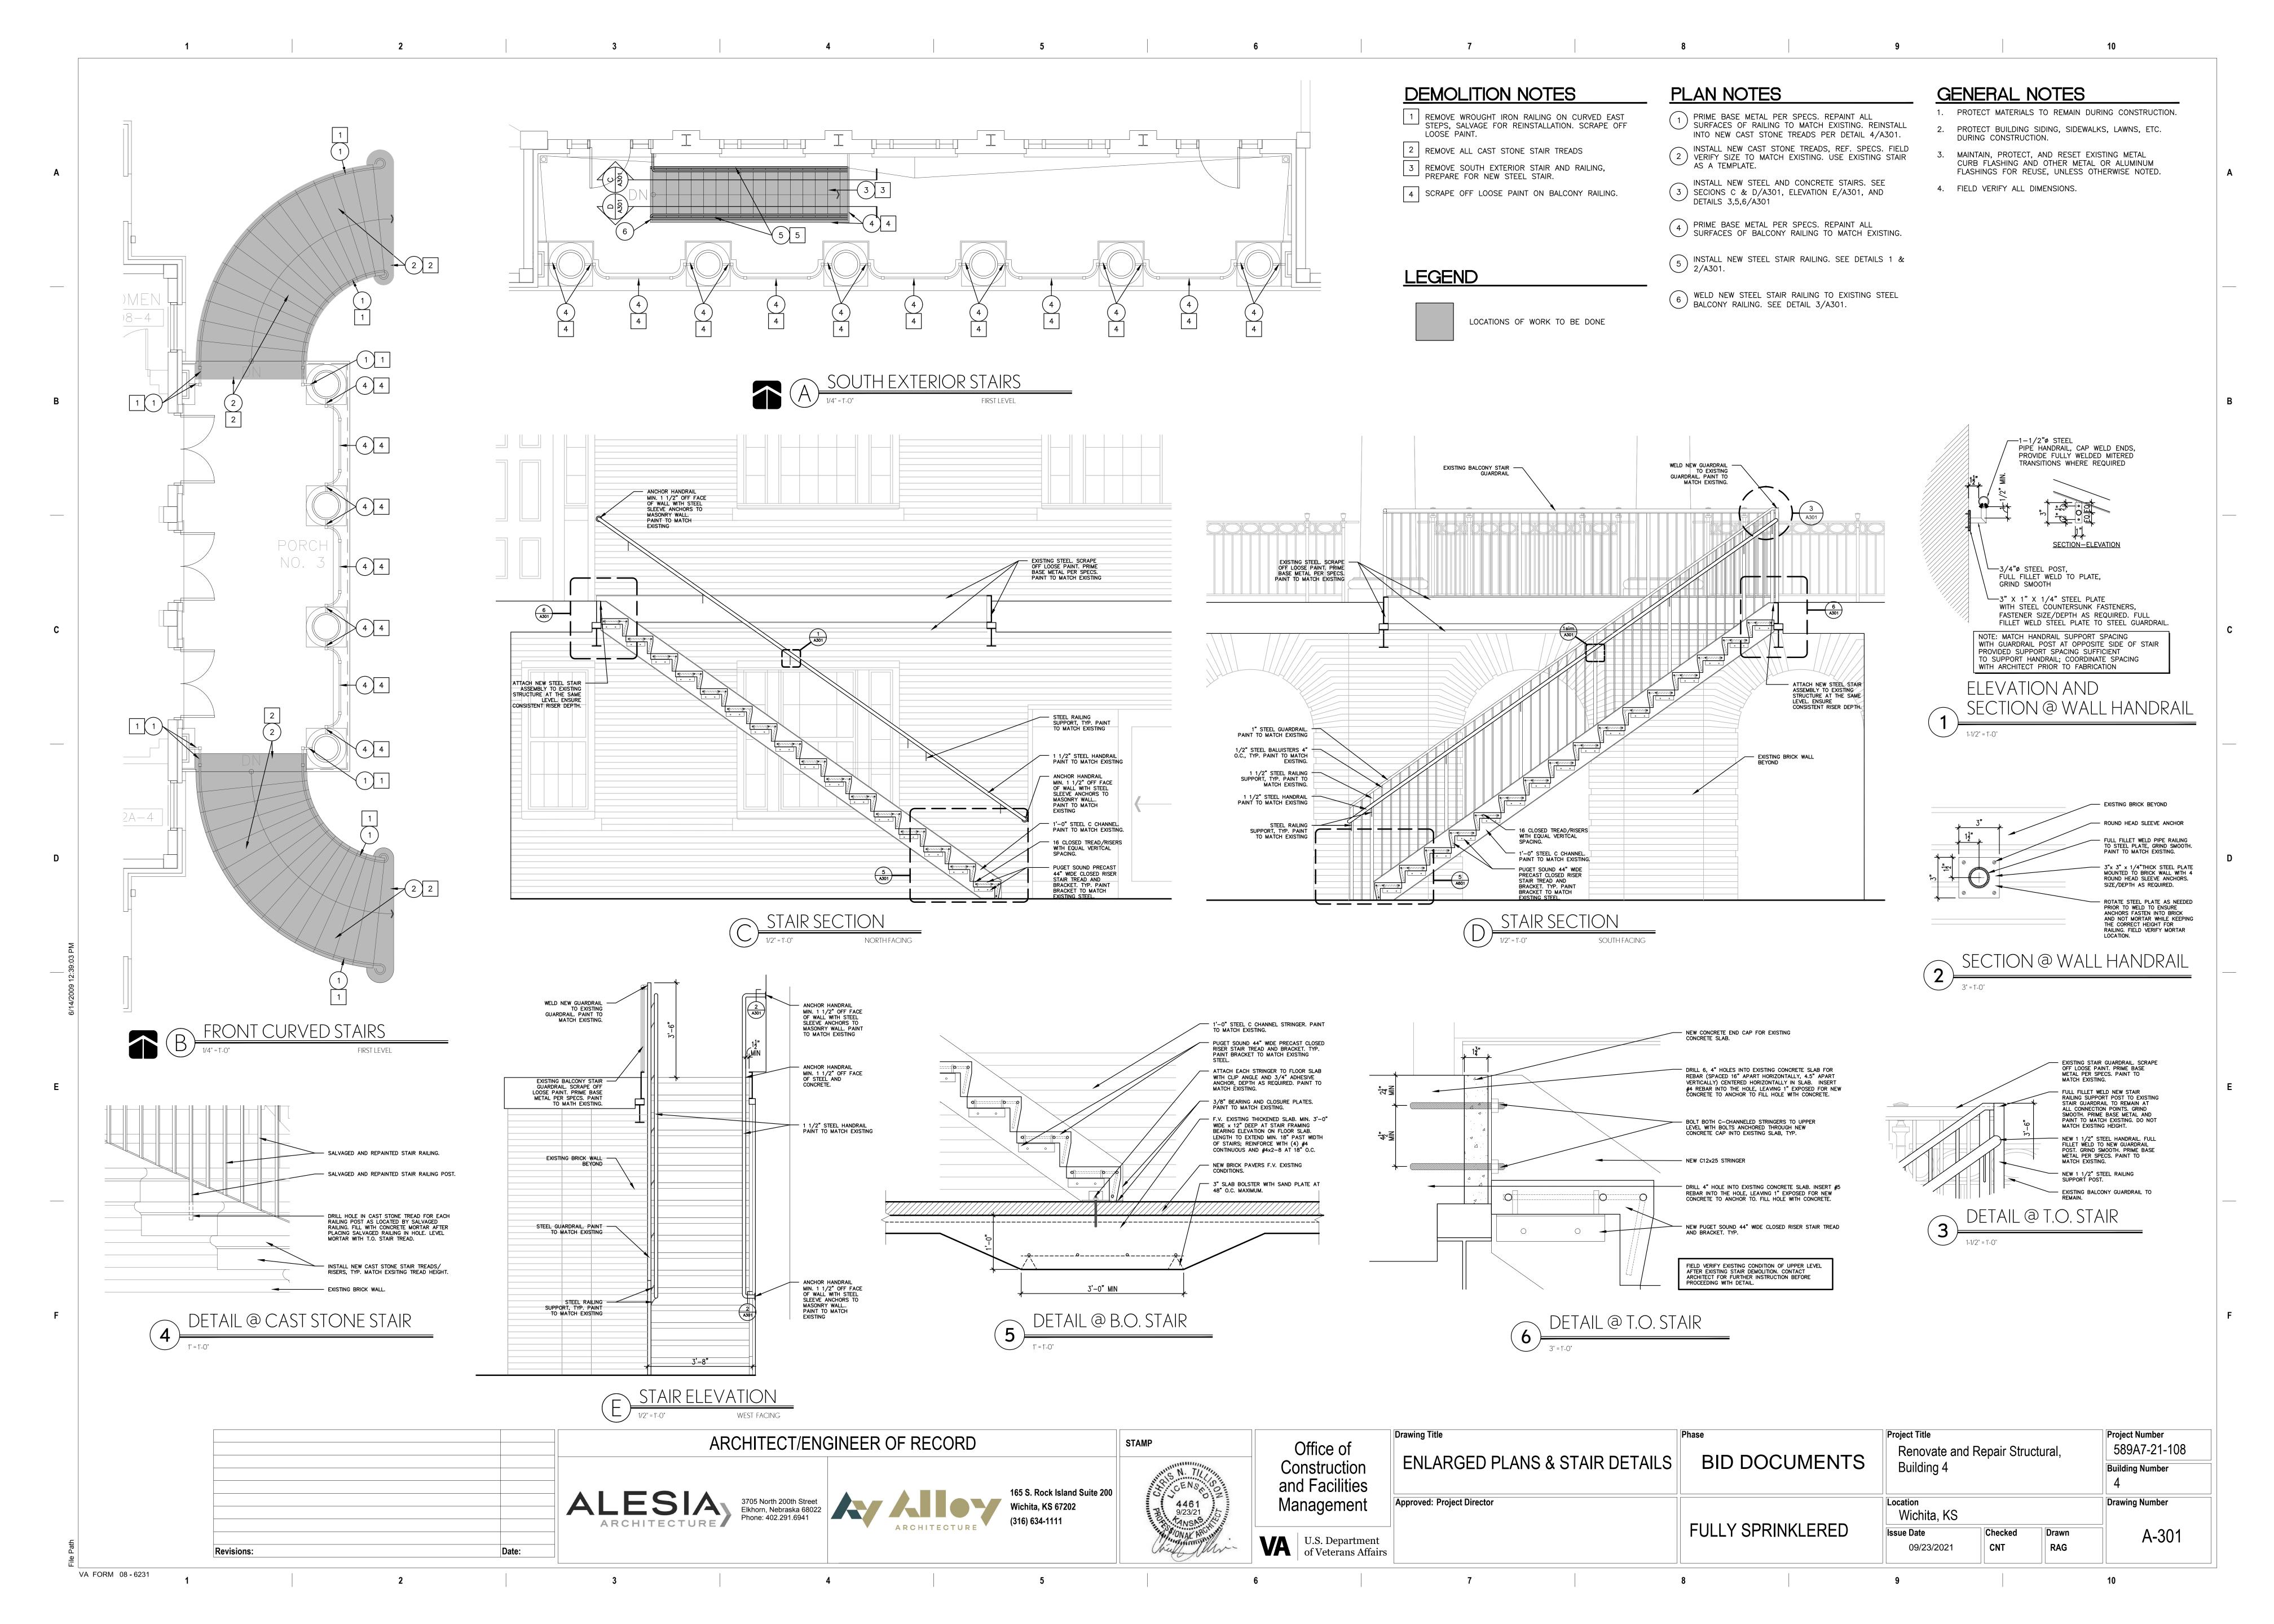

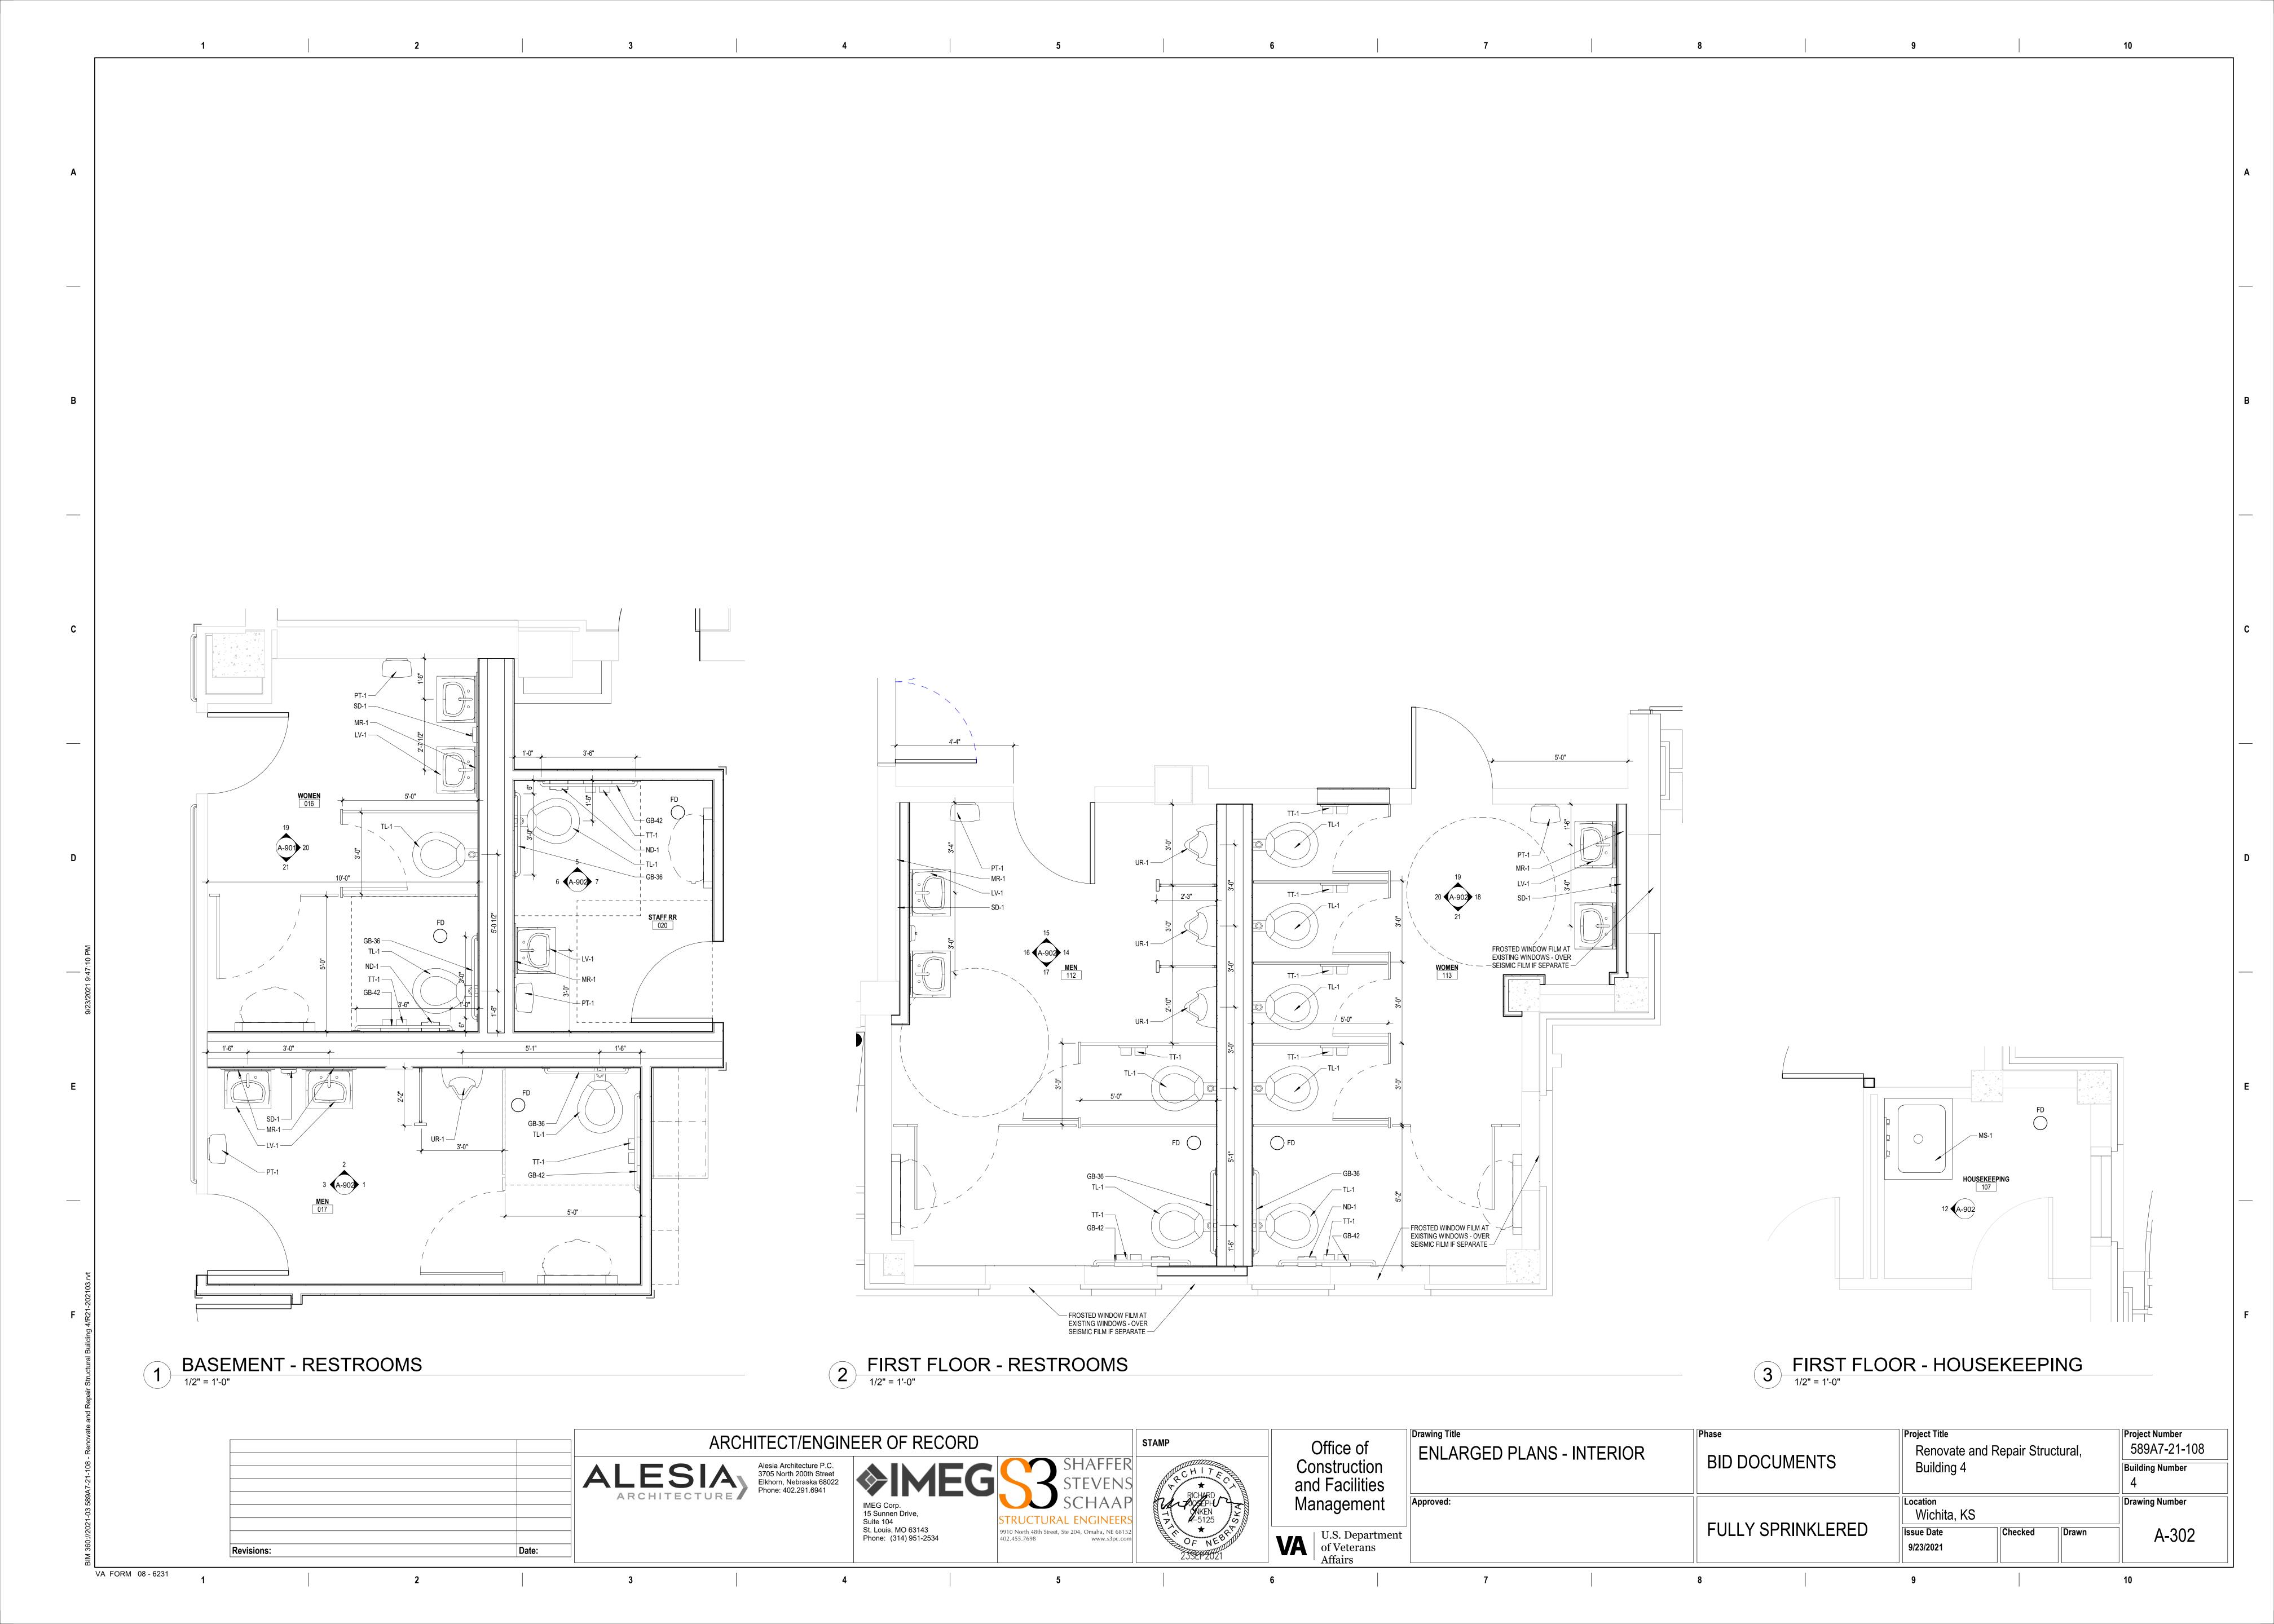

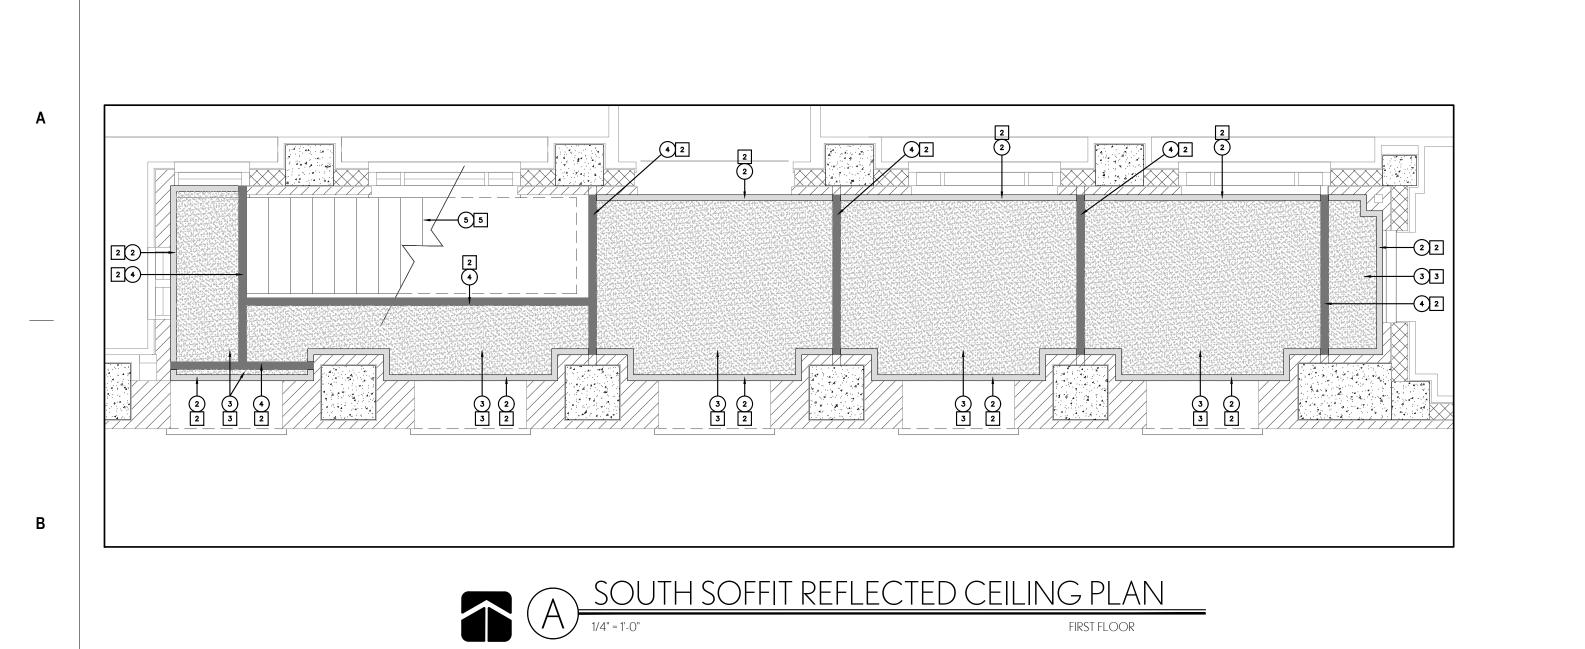

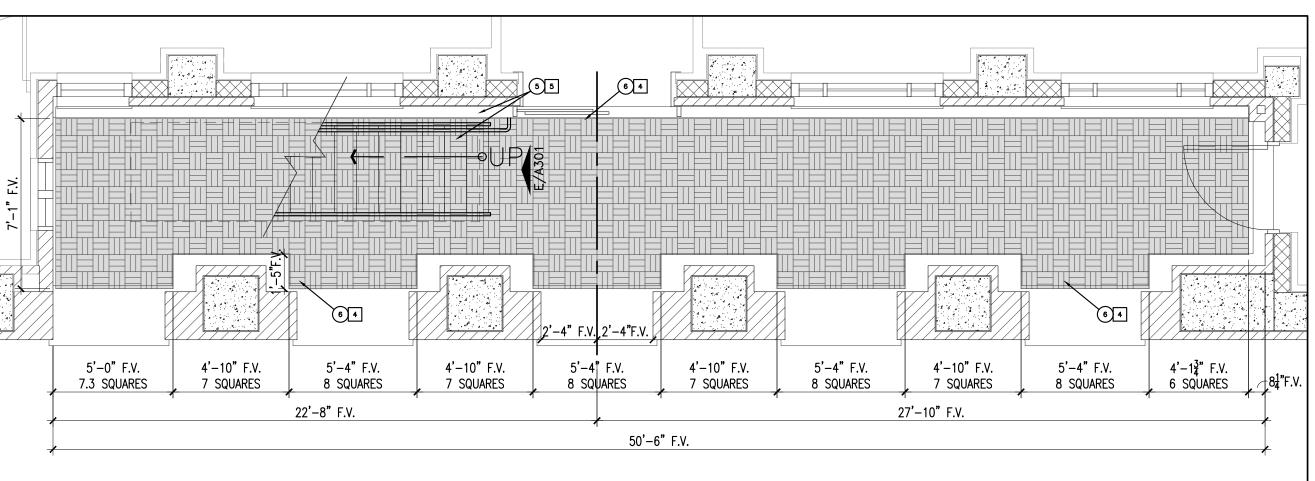

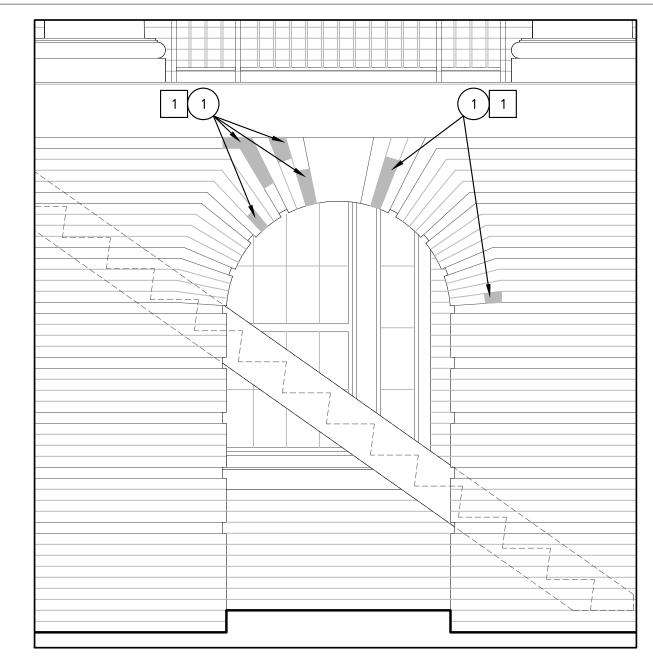

PLAN NOTES **DEMOLITION NOTES**

2 SCRAPE OFF LOOSE PAINT

3 REMOVE EXISTING PLASTER

LEGEND

4 REMOVE EXISTING BRICK PAVERS

5 REMOVE EXISTING STEEL STAIRS AND RAILING. SEE DETAIL A/A301

1/4" WOODEN LATHE.

LOCATIONS OF WORK TO BE DONE

3/4" THICK CEMENTITIOUS PLASTER ON 2"x

- 1 INSTALL NEW CUSTOM SHAPED BRICK AND MORTAR TO MATCH ADJACENT AS SHOWN IN SHADED AREA. TOOL MORTAR TO MATCH EXISTING ADJACENT. SEE PLAN NOTE 8 ON SHEET A201. 1 REMOVE DAMAGED BRICK AND SURROUNDING MORTAR IN SHADED AREA.
 - (2) REPAINT WOOD TRIM TO MATCH EXISTING.

 - (3) REAPPLY NEW PLASTER AND PAINT TO MATCH EXISTING 4. FIELD VERIFY ALL DIMENSIONS.
 - 4 PRIME BASE METAL PER SPECS. REPAINT ALL SURFACES OF METAL TO MATCH EXISTING.
 - 5 INSTALL NEW STEEL STAIRS AND RAILING. SEE DETAIL A/A301
 - 6 INSTALL NEW BRICK PAVERS IN 3x3 PARQUET PATTERN AS SHOWN.

GENERAL NOTES

- PROTECT EXISTING ROOFTOP EQUIPMENT AND MATERIALS TO REMAIN DURING CONSTRUCTION.
- PROTECT BUILDING SIDING, SIDEWALKS, LAWNS, ETC. DURING CONSTRUCTION.

10

- 3. MAINTAIN, PROTECT, AND RESET EXISTING METAL CURB FLASHING AND OTHER METAL OR ALUMINUM FLASHINGS FOR REUSE, UNLESS OTHERWISE NOTED.

SOUTH PAVERS PLAN

1/4" = 1'-0"

B ENLG. ARCHWAY EXTERIOR ELEVATION

> Drawing Title Project Title Renovate and Repair Structural, BID DOCUMENTS EXTERIOR DETAILS Building 4 Approved: Project Director Location Wichita, KS **FULLY SPRINKLERED**

U.S. Department of Veterans Affairs

Office of

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Drawing Number Checked CNT 09/23/2021


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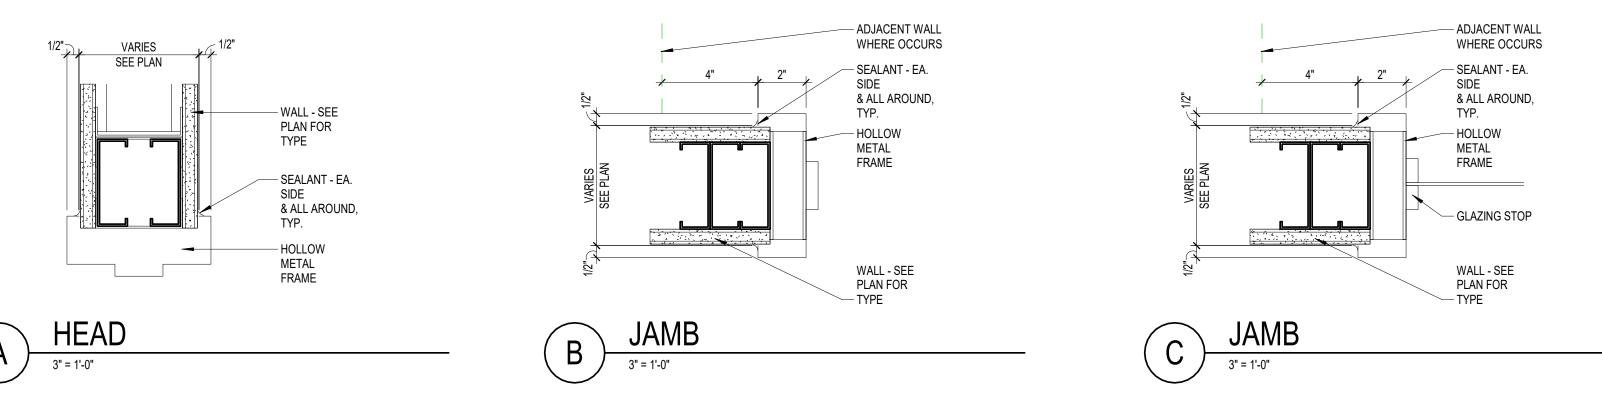
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Building Number


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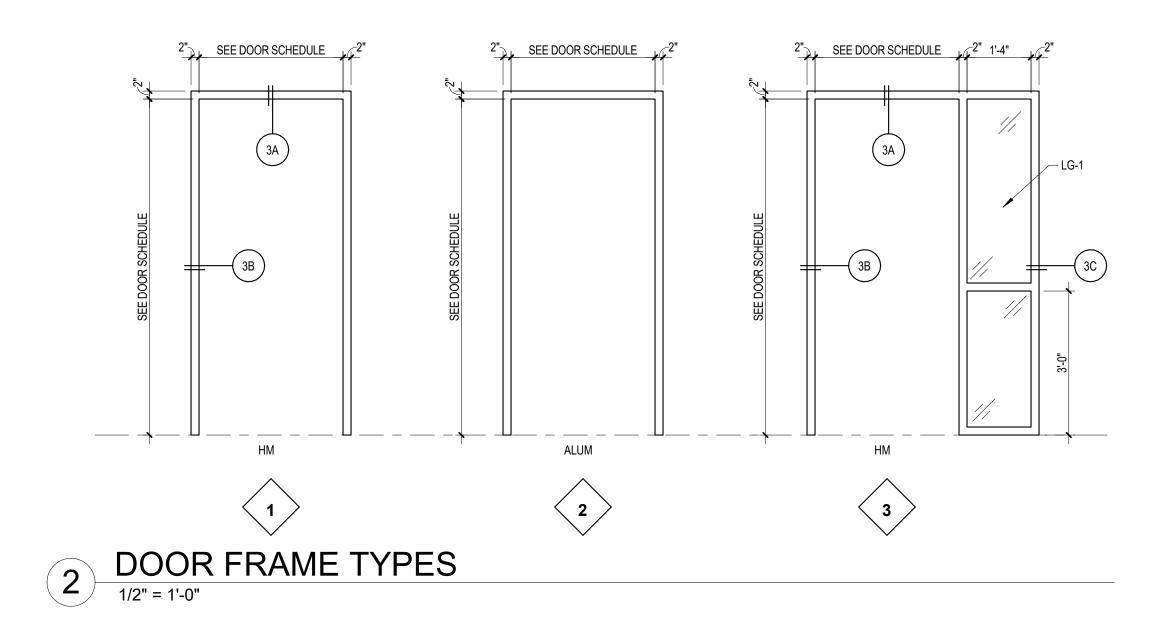


3 DOOR FRAME DETAILS
3" = 1'-0"




4 WINDOW TYPES

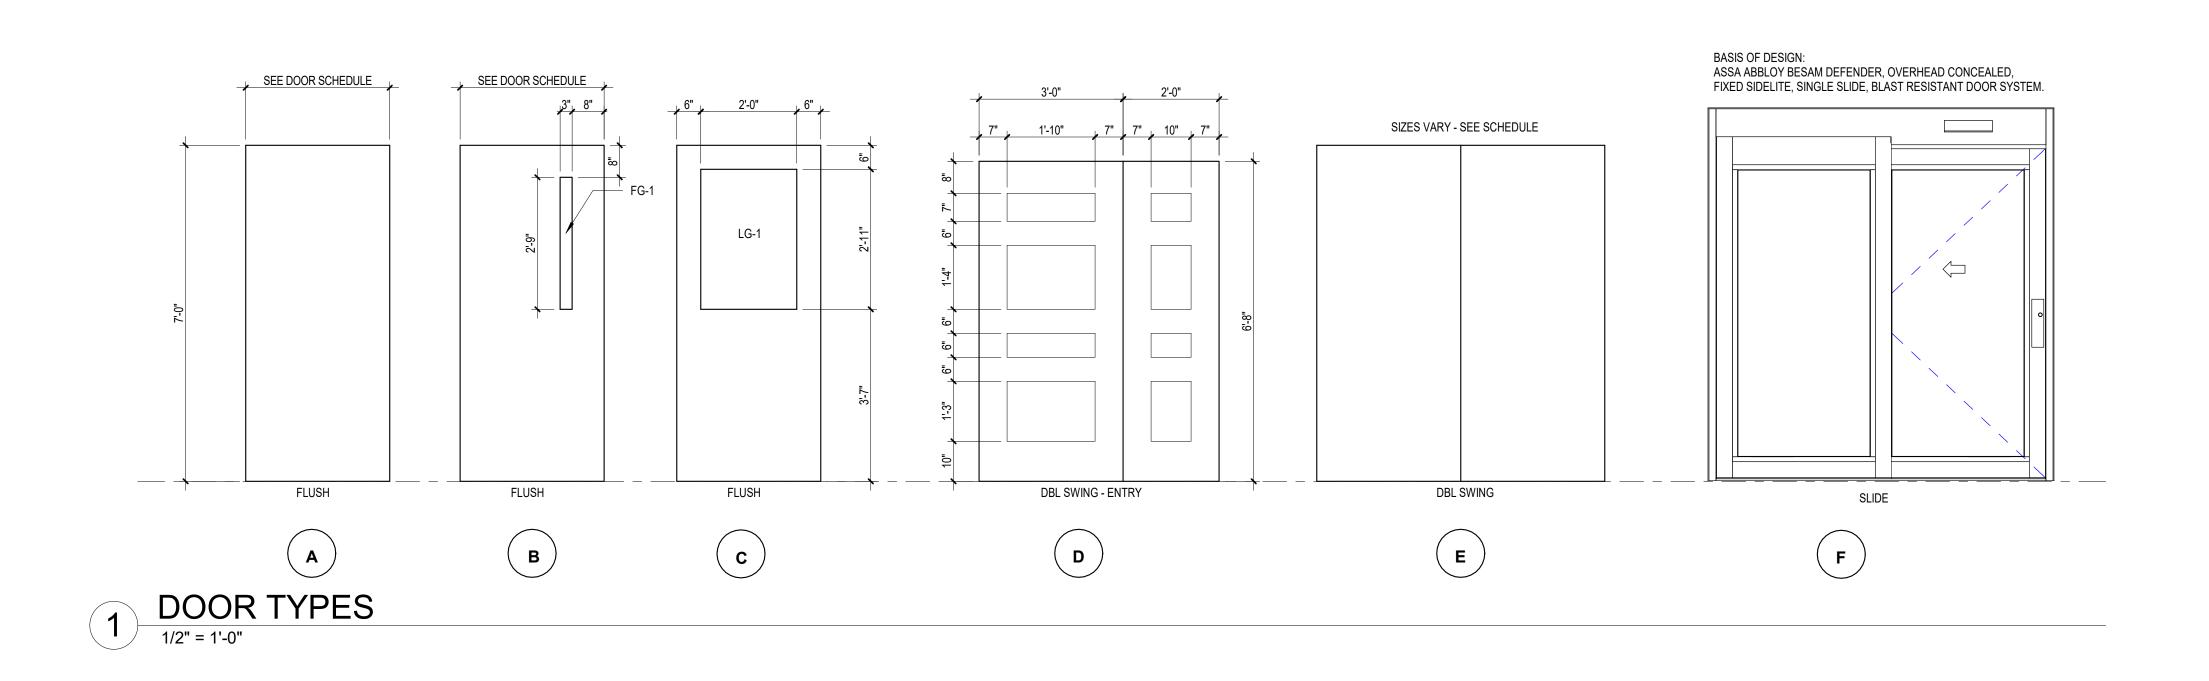1/2" = 1'-0"

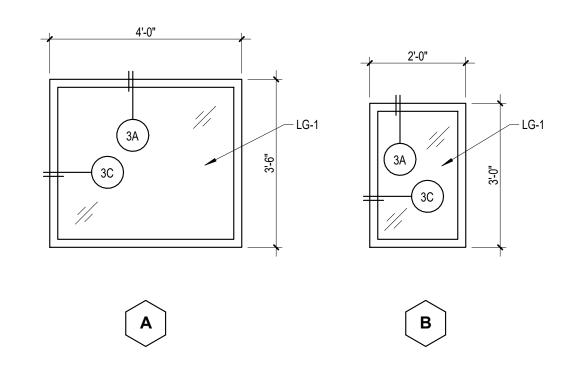

	DOOR SCHEDULE											
OOR JMBER	ROOM NAME	Width	Height	HARDWARE	DOOR MATERIAL	DOOR TYPE	DOOR FINISH	FRAME TYPE	FRAME MATERIAL	FRAME FINISH	FIRE RATING	NOTES
)1)2	VESTIBULE VESTIBULE	6'-8" 7'-2"	7'-0" 7'-9"	SH-1 BY MANUF.	AL	F			AL			EXISTING SLIDING DOOR COORD. WITH SECURITY SCREENING SYSTEM
)3	WAITING	3'-6"	7'-0"	4A-A	WD	A	ST-2	3	HM	P-4		ADO
)4	RECEPTION	3'-0"	7'-0"	3E	WD	А	ST-2	1	HM	P-4		
)5	HOUSEKEEPING	3'-0"	7'-0"	SH3-A	WD	Α	ST-2	1	HM	P-4		
06A	CORRIDOR	3'-6"	7'-0"	4A-A	НМ	В	P-4	1	HM	P-4		ADO
06B	CORRIDOR	3'-6"	7'-0"	4E-A	WD	Α	ST-2	1	HM	P-4		
07	EXAM ROOM	3'-6"	7'-0"	1Q	WD	Α	ST-2	1	HM	P-4		
08	EXAM ROOM	3'-6"	7'-0"	1Q	WD	A	ST-2	1	HM	P-4		
)9	EXAM ROOM	3'-6"	7'-0"	1Q	WD	A	ST-2	1	HM	P-4		
10A	CORRIDOR	3'-6"	7'-0"	3E	WD	A	ST-2	1	HM	P-4		
10B	CORRIDOR	3'-8"	7'-0"	E4-A	HM	A	P-4	1	HM	P-4		
11	LOCKED STORAGE	3'-0"	7'-0"	4E	WD	A	ST-2	1	HM	P-4		EVIOTING
12	STORAGE	3'-0"	7'-0"	5D	WD	Δ.	CT 2	1	1.18.4	D 4		EXISTING
14B	OFFICE WORK ROOM	3'-0"	7'-0"	3E	WD WD	A	ST-2 ST-2	1	HM HM	P-4 P-4		
15 16	WORK ROOM	3'-6" 3'-0"	7'-0" 7'-0"	5D 4B-A	WD WD	A	ST-2 ST-2	1	HM HM	P-4 P-4		ADO
	MEN	3'-0"	7 -0 7'-0"	4B-A 4B-A	WD	A	ST-2 ST-2	1	HM	P-4 P-4		ADO
18	CORRIDOR	3'-6"	7'-0"	4D-A 4A-A	WD	C	ST-2	1	HM	P-4 P-4		ADO
19A	CONFERENCE	3'-6"	7'-0"	SH3	WD	A	ST-2	1	HM	P-4		
19B	CONFERENCE	3'-0"	7'-0"	SH3	WD	A	ST-2	1	HM	P-4		
	STAFF RR	3'-0"	7'-0"	2G	WD	A	ST-2	1	HM	P-4		
21A	STAIRS	3'-6"	7'-0"	SH-4B	HM	В	P-4	1	HM	P-4	60 MIN	
21B	STAIRS	3'-0"	7'-0"	SH-4B	HM	В	P-4	1	HM	P-4	60 MIN	
22	ELECTRICAL	3'-0"	7'-0"	5F-A	НМ	Α	P-4	1	HM	P-4		
23	ELECTRICAL	3'-0"	7'-0"	5F-B	HM	Α	P-4	1	HM	P-4		
24	STORAGE / MAILOUTS	3'-6"	7'-0"	4E	WD	Α	ST-2	1	HM	P-4		
28A	OFFICE	3'-0"	7'-0"	3E	WD	А	ST-2	1	HM	P-4		
28B	OFFICE	3'-6"	7'-0"	E4-A								EXISTING
29	OFFICE	3'-0"	7'-0"	3E	WD	A	ST-2	1	HM	P-4		
30	STORAGE	3'-6"	7'-0"	SH3	WD	A	ST-2	1	HM	P-4		
31	DATA CLOSET	6'-10"	6'-8"	11-A	НМ	В	P-4	1	HM	P-4		
32	ELECTRICAL	2'-6"	7'-0"	5F-A	HM	A	P-4	1	HM	P-4		
33	MECHANICAL	3'-0"	7'-0"	5F-A	HM	A	P-4	1	HM	P-4		
34	FENCE GATE	13'-0"	8'-0"	EVIOT	Steel							EV/OTING
00	KITCHEN	3'-0"	7'-0"	EXIST	NA/D	Δ.	07.0	4	1.18.4	D 4		EXISTING
00A	PANTRY / STORAGE EDUCATION PROGRAM	3'-6" 6'-10"	7'-0" 6'-8"	SH3-A SH-1	WD	A	ST-2	1	HM	P-4		EXISTING
01 02	STORAGE	2'-8"	7'-0"	EXIST	WD		ST-2	1	HM	P-4		EXISTING
02A	MECHANICAL	6'-0"	7'-0"	11-A	HM	A E	P-4	1	HM	P-4 P-4		
)3	ANTE ROOM	3'-6"	7'-0"	EXIST	ПІИ	<u> </u>	Γ-4	I	FIIVI	Γ-4		EXISTING
)3A	ANTE ROOM	3'-0"	7'-0"	EXIST								EXISTING
)4	CORRIDOR	3'-0"	7'-0"	EXIST							90 MIN	EXISTING
05	STORAGE	3'-0"	7'-0"	SH3-A							45 MIN	EXISTING
06	DATA CLOSET	6'-0"	7'-0"	5F-A	WD	A	ST-2	1	HM	P-4		
)7	HOUSEKEEPING	3'-0"	7'-0"	5D-A				-		· · ·	45 MIN	EXISTING
9A	LOBBY	5'-4"	7'-0"	E9-A	НМ	D	P-4	1	НМ	P-4		
9B	LOBBY	5'-0"	6'-8"	E9-A	НМ	D	P-4	1	НМ	P-4		
9C	LOBBY	5'-4"	7'-0"	E9-A	HM	D	P-4	1	НМ	P-4		
9D	LOBBY	5'-4"	7'-0"	E9	WD	D	ST-2	1	НМ	P-4	45 MIN	
)9E	LOBBY	5'-4"	7'-0"	E9	WD	D	ST-2	1	HM	P-4	45 MIN	
1	EDUCATION PROGRAM	3'-6"	7'-0"	EXIST							60 MIN	EXISTING
11A	EDUCATION PROGRAM	3'-0"	7'-0"	E4-A								EXISTING
1B	EDUCATION PROGRAM	3'-0"	7'-0"	E4-A								EXISTING
1C	OFFICE	3'-0"	7'-0"	3D-A		_						EXISTING
2	MEN	3'-0"	7'-0"	4B	WD	A	ST-2	1	HM	P-4	45 MIN	
3	WOMEN	3'-0"	7'-0"	4B	WD	A	ST-2	1	HM	P-4	45 MIN	
)1	OPEN OFFICE	3'-0"	7'-0"	SH-4B	HM	В	P-4	1	HM	P-4	60 MIN	
)2	CONFERENCE	3'-0"	7'-0"	3E	WD	A	ST-2	1	HM	P-4		
3	DIGITAL PRESS	3'-0"	7'-0"	3E	WD	A	ST-2	1	HM	P-4		
)7)8 A	STUDIO	3'-0"	7'-0"	3E	WD	A	ST-2	1	HM	P-4	00 84181	
)8A	STAIRS	3'-0"	7'-0"	SH-4B	HM	В	P-4	1	HM	P-4	60 MIN	
08B	STAIRS	3'-0"	7'-0"	SH-4B	HM	В	P-4	1	HM	P-4	60 MIN	EVICTING
09	STORAGE	2'-8"	7'-0"	SH3-A							60 MIN	EXISTING

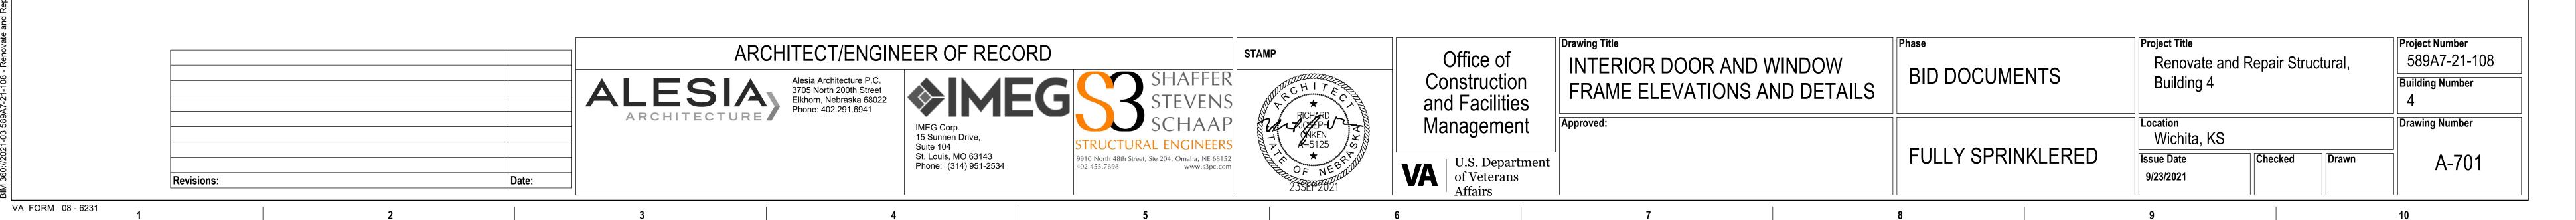

4 360-//2021-03 589A7-21-108 - Renovate and Repair Structural Building

		T			SCHEDULE	A/ALL C		6=11 /1··=	
ROOM NUMBER	ROOM NAME	FLOOR	BASE	NORTH	EAST	VALLS SOUTH	WEST	CEILING MATERIAL	REMARK
01	VESTIBULE	WSF-3	CWSF-3	PT-1	PT-1	PT-1	PT-1	AT-1	G.
002	CORRIDOR	WSF-1/WSF-2	RB-2	WP-3/PT-1	WP-3/PT-1	WP-3/PT-1	WP-3/PT-1	AT-1	A.
03	WAITING	WSF-3	RB-1	PT-1	PT-1	PT-1	PT-1	AT-1	7 (1
04	RECEPTION	CPT-1	RB-2	PT-1	PT-1	PT-1	PT-1	AT-1	
05	HOUSEKEEPING	WSF-3	CWSF-3	PT-1	PT-1	PT-1	PT-1	AT-1	G.
006	CORRIDOR	WSF-1/WSF-2	RB-2	WP-3/PT-1	WP-3/PT-1	WP-3/PT-1	WP-3/PT-1	AT-1	A.
007	EXAM ROOM	WSF-1	RB-1	PT-1	WP-4/PT-1	WP-4/PT-1	WP-4/PT-1	AT-1/GWB PT-9	F.
08	EXAM ROOM	WSF-1	RB-1	PT-1	WP-4/PT-1	WP-4/PT-1	WP-4/PT-1	AT-1/GWB PT-9	F.
009	EXAM ROOM	WSF-1	RB-1	PT-1	WP-4/PT-1	WP-4/PT-1	WP-4/PT-1	AT-1/GWB PT-9	F.
)10	CORRIDOR	WSF-1/WSF-2	RB-2	WP-3/PT-1	WP-3/PT-1	WP-3/PT-1	WP-3/PT-1	AT-1	A.
)11	LOCKED STORAGE	WSF-3	RB-2	PT-1	PT-1	PT-1	PT-1	AT-1	7 (.
)12	STORAGE	-	-					-	
)13	WORK ROOM	WSF-3	RB-2	PT-1	PT-1	PT-1	PT-1	AT-1	
)14	OFFICE	CPT-1	RB-2	PT-1	PT-1	PT-1	PT-1	AT-1	
)15	WORK ROOM	WSF-3	RB-2	PT-1	PT-1	PT-1	PT-1	AT-1	
)16	WOMEN	T-2	T-1	T-1/T-3/PT-3A	T-1/T-3/PT-3A	T-1/T-3/PT-3A	T-1/T-3/PT-3A	AT-2	C.
17	MEN	T-2	T-1	T-1/T-3/PT-3A	T-1/T-3/PT-3A	T-1/T-3/PT-3A	T-1/T-3/PT-3A	AT-2	C.
)18	CORRIDOR	WSF-3	RB-2	WP-3/PT-1	WP-3/PT-1	WP-3/PT-1	WP-3/PT-1	AT-1/GWB PT-9	A.
119	CONFERENCE RM	CPT-1	RB-2	PT-1	PT-1	PT-1	PT-1	AT-1/GWB P1-9 AT-1	۸.
)20	STAFF RR	T-2	T-1	T-1/T-3/PT-3A	T-1/T-3/PT-3A	T-1/T-3/PT-3A	T-1/T-3/PT-3A	AT-2	C.
)21	STAIR	WSF-1	RB-1	PT-1	PT-1	PT-1	PT-1	GWB PT-9	<u> </u>
	ELECTRICAL	VV3F-1	RD-1	PI-I	PI-I	P1-1	PI-I	GWD P1-9	
)22		-	- DD 0	- DT 4	- DT 4	- DT 4	- DT 4	-	
)23	ELECTRICAL STORAGE (MAILOUTS	- WCE 2	RB-2	PT-1	PT-1	PT-1	PT-1	AT 4/CM/D DT 0	
)24	STORAGE / MAILOUTS	WSF-3	RB-2	PT-1	PT-1	PT-1	PT-1	AT-1/GWB PT-9	
)25	OFFICE	CPT-1	RB-2	PT-1	PT-1	PT-1	PT-1	AT-1	
)26	OFFICE	CPT-1	RB-2	PT-1	PT-1	PT-1	PT-1	AT-1	
)27	OPEN OFFICE	CPT-1	RB-2	PT-1	PT-1	PT-1	PT-1	AT-1	
)28	OFFICE	CPT-1	RB-2	PT-1	PT-1	PT-1	PT-1	AT-1	
)29	OFFICE	CPT-1	RB-2	PT-1	PT-1	PT-1	PT-1	AT-1	
030	STORAGE	WSF-3	RB-2	PT-1	PT-1	PT-1	PT-1	AT-1	_
031	DATA CLOSET	SDF-1	RB-2	PT-1	PT-1	PT-1	PT-1	-	D.
)32	ELECTRICAL	-	-	-	-	-	-	-	
)33	MECHANICAL	-	-	-	-	-	-	-	
)34	ELEVATOR	WSF-1	-	-	-	-	-	-	
)35	ELEVATOR MACHINE ROOM	-	-	-	-	-	-	-	
100	KITCHEN	WSF-3	RB-2	PT-1	PT-1	PT-1	PT-1	GWB PT-9	
00A	PANTRY / STORAGE	WSF-3	RB-2	PT-1	PT-1	PT-1	PT-1	GWB PT-9	
01	EDUCATION PROGRAM	CPT-2	PT-12	PT-10/11/12	PT-10/11/12	PT-10/11/12	PT-10/11/12	PT-13	B.
02	STORAGE	WSF-3	RB-2	PT-1	PT-1	PT-1	PT-1	AT-1	
02A	MECHANICAL	WSF-3	RB-2	PT-1	PT-1	PT-1	PT-1		
103	STORAGE	WSF-3	RB-2	PT-1	PT-1	PT-1	PT-1	GWB PT-9	
104	STAIR	WSF-1	RB-1	PT-1	PT-1	PT-1	PT-1	GWB PT-9	
05	STORAGE	WSF-3	RB-2	PT-1	PT-1	PT-1	PT-1	AT-1	
06	DATA CLOSET	SDF-1	RB-2	PT-1	PT-1	PT-1	PT-1	-	D.
07	HOUSEKEEPING	WSF-3	CWSF-3	PT-1	PT-1	PT-1	PT-1	AT-1	E.
09	LOBBY	-	-	PT-1	PT-1	PT-1	PT-1	GWB PT-9	H.
11	EDUCATION PROGRAM	CPT-2	PT-12	PT-10/11/12	PT-10/11/12	PT-10/11/12	PT-10/11/12	GWB PT-9	B.
12	MEN	T-2	T-1	T-1/T-3/PT-3A		T-1/T-3/PT-3A	T-1/T-3/PT-3A	AT-2	C.
13	WOMEN	T-2	T-1	T-1/T-3/PT-3A	T-1/T-3/PT-3A	T-1/T-3/PT-3A	T-1/T-3/PT-3A	AT-2	C.
200	STAIR	EXIST	EXIST	PT-1	PT-1	PT-1	PT-1	PT-1	
201	OPEN OFFICE	CPT-1	RB-2	PT-1	PT-1	PT-1	PT-1	AT-1	
202	CONFERENCE	CPT-1	RB-2	PT-1	PT-1	PT-1	PT-1	AT-1	
03	DIGITAL PRESS	WSF-3	RB-2	PT-1	PT-1	PT-1	PT-1	AT-1	
04	OFFICE	WSF-3	RB-2	PT-1	PT-1	PT-1	PT-1	AT-1	
05	KITCHEN	WSF-3	RB-2	PT-1	PT-1	PT-1	PT-1	AT-1	
206	DIGITAL PRINT AREA	WSF-3	RB-2	PT-1	PT-1	PT-1	PT-1	AT-1	
207	STUDIO	CPT-1	RB-2	PT-1	PT-1	PT-1	PT-1	AT-1	
80	STAIR	EXIST	EXIST	PT-1	PT-1	PT-1	PT-1	PT-1	
209	STORAGE	-	-	-	-	-	-	-	
217	TELECOM ROOM	-	-	-	-	-	-	-	
218	STORAGE	-	-	-	-	-	-	-	

FINISH SCHEDULE REMARKS:

- A. PROTECTIVE WALL PANEL WP-3 AND REQUIRED TRIM & TOP CAP FROM TOP OF 6" BASE TO 4'-0" A.F.F., PT-1 ABOVE.
- PROTECT EXISTING FINISHES DURING INSTALLATION OF HANDICAP WHEELCHAIR LIFT IN EDUCATION ROOM 111. PATCH WALL AS REQUIRED AS DISTURBED BY INSTALLATION. WALLS, BASE AND TRIM TO BE PAINTED TO MATCH EXISTING COLORS AND AS APPROVED BY COR TO MATCH EXISTING. VERIFY CEILING TO MATCH PT-9.
- C. PROVIDE FIELD TILE IN T-1 TO 6'-6" ABOVE FINISHED FLOOR WITH ACCENT TILE T-3 AT 5' TO 5'-6" WITH ONE FULL TILE OF T-1 ABOVE. PROVIDE BEVELED BRUSHED ALUMINUM TOP CAP ON ALL EXPOSED EDGES.
- D. PROVIDE PAINTED 3/4" FIRE RETARDANT PLYWOOD OVER ALL WALLS WHERE DATA EQUIPMENT OCCURS.
- E. PROVIDE QT-1 BASE WITH CT-1 TO 4'-0" A.F.F. WITH PT-1A ABOVE. PROVIDE BRUSHED ALUMINUM TRANSITION BETWEEN QT-1 AND CT-1 AS WELL AS BEVELED TOP CAP AT TOP OF WAINSCOT CT 1
- F. PROVIDE WP-4 TO ALIGN WITH TOP OF COUNTERTOP ON EAST AND WEST WALLS.
- G. PROVIDE COVED BASE TO 6" A.F.F. WITH BRUSHED ALUMINUM TOP CAP FOR A FINISHED INSTALLATION.
- H. VERIFY PAINT TO MATCH EXISTING.

GENERAL NOTES:

VA FORM 08 - 6231


- ANY FINISHES REQUIRED BUT NOT SHOWN IN THIS SCHEDULE SHALL BE APPROVED BY THE COR.
- 2. SEE RELECTED CEILING PLAN FOR CEILING AND SOFFIT HEIGHTS.
- 3. CEILING SOFFITS TO BE PAINTED PT-9.
- 4. ALL WELDED SHEET FLOORGING TO BE HEAT WELDED. WHERE NOTED TO BE COVED, COVED BASE SHALL BE 6" A.F.F.

ID NUMBER	VA ROOM NUMBER	ROOM NAME	MOUNTING	CONTENTS	TYPE
002	002-4	CORRIDOR	A		IN-03.01
002B	002-4	CORRIDOR	В	PROSTHETICS / ORTHOTICS	IN-15.51
003	003-4	WAITING	Α	WAITING	IN-04.01
003B	003-4	WAITING	D	PROSTHETICS / ORTHOTICS RECEPTIONIST	IN-15.56
004	004-4	RECEPTION	Α		IN-04.03
005	005-4	HOUSEKEEPING	Α		IN-03.01
006	006-4	CORRIDOR	Α		IN-03.01
007	007-4	EXAM ROOM	Α	EXAM A	IN-07.02
008	008-4	EXAM ROOM	Α	EXAM B	IN-07.02
009	009-4	EXAM ROOM	Α	EXAM C	IN-07.02
010	010-4	CORRIDOR	A		IN-03.01
011	011-4	LOCKED STORAGE	A		IN-04.03
012	012-4	STORAGE	A		IN-04.03
013	013-4	WORK ROOM	A	WORK ROOM	IN-04.01
014	014-4	OFFICE	A	WORKEN COM	IN-04.03
015	015-4	WORK ROOM	A		IN-03.01
015	015-4	WOMEN	C		IN-03.01
017	010-4	MEN	C		IN-09.02
017	017-4	CORRIDOR	A		IN-03.01
019	019-4	CONFERENCE RM	A	CONFERENCE ROOM	IN-03.01
				CONFERENCE ROOM	
020	020-4	STAFF RR	C	MESSACELAVOLIED	IN-09.03
021	021-4	STAIR	A	MESSAGE LAYOUT D	IN-09.08
022	022-4	ELECTRICAL	A		IN-03.01
023	023-4	ELECTRICAL	A		IN-03.01
024	024-4	STORAGE / MAILOUTS	A		IN-04.03
028	028-4	OFFICE	A		IN-04.03
029	029-4	OFFICE	A		IN-04.03
030	030-4	STORAGE	A		IN-04.03
031	031-4	DATA CLOSET	A		IN-03.01
032	032-4	ELECTRICAL	A		IN-03.01
033	033-4	MECHANICAL	Α		IN-03.01
034	034-4	ELEVATOR	A	MESSAGE LAYOUT E	IN-09.08
035	035-4	ELEVATOR MACHINE ROOM	A		IN-03.01
100	100-4	KITCHEN	A	KITCHEN	IN-04.01
100A	100A-4	PANTRY / STORAGE	A		IN-03.01
102	102-4	STORAGE	A		IN-04.03
102A	102A-4	MECHANICAL	A		IN-03.01
103	103-4	STORAGE	A		IN-04.03
104	104-4	STAIR	Α	MESSAGE LAYOUT D	IN-09.08
105	105-4	STORAGE	Α		IN-03.01
106	106-4	DATA CLOSET	Α		IN-03.01
107	107-4	HOUSEKEEPING	Α		IN-03.01
109	109-4	LOBBY	А	LOBBY	IN-04.02
111	111-4	EDUCATION PROGRAM	А	EDUCATION PROGRAM	IN-04.02
112	112-4	MEN	С		IN-09.01
113	113-4	WOMEN	С		IN-09.02
114	114-4	BALCONY			
200	200-4	STAIR	Α	MESSAGE LAYOUT D	IN-09.08
201	201-4	OPEN OFFICE	А		IN-04.03
202	202-4	CONFERENCE	Α	CONFERENCE ROOM	IN-07.01
203	203-4	DIGITAL PRESS	A		IN-03.01
207	207-4	STUDIO	A	STUDIO	IN-04.03
208	208-4	STAIR	A	MESSAGE LAYOUT D	IN-09.08

SIGNAGE SCHEDULE

SIGNAGE NOTES

1. SEE VA SIGNAGE DESIGN GUIDE CHAPTER 9 FOR SIGN TYPES AND INSTALLATION REQUIREMENTS https://www.cfm.va.gov/til/signs/Signage09-Interior.pdf

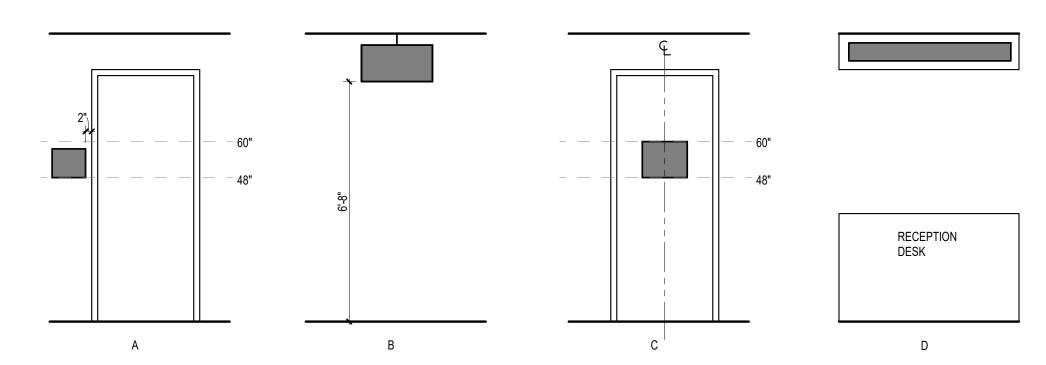



ABBREVIATIONS:

V VA PROVIDED / INSTALLED
C CONTRACTOR PROVIDED / INSTALLED

KEY	JSN	DESCRIPTION	PROVIDED	INSTALLEI
AP-1	F0040	ACOUSTICAL PANELS	С	С
BB-1 BC-1	F3010	MAGNETIC WHITEBOARD BABY CHANGING STATION	C	C V
CD-1		CREDENZA WITH HUTCH	V	V
CH-1	F0275	OFFICE CHAIR	V	V
CH-2	F0210	SIDE CHAIR W/ ARMS	V	V
CH-3		CONFERENCE CHAIR	V	V
CL-1	F3200	CLOCK	V	С
CP-1	M1801	COMPUTER W/ DUAL FLAT PANEL MONITORS	V	V
CR-1 DF-1		CRASH RAIL DRINKING FOUNTAIN	C	C
DK-1	E0123	DESK	V	V
DK-2	20120	DESK - L SHAPED	V	V
EW-1	P2000	EYE WASH STATION - WALL MOUNTED	C	C
FC-1	F0420	FILING CABINET - LATERAL - HALF HEIGHT	V	V
FC-2		FILE CABINET - LEGAL	V	V
FS-1	M2015	FLAMMABLE STORAGE CABINET	V	V
GB-18 GB-30	A5109 A5109	GRAB BAR 18" GRAB BAR 30"	C	C
GB-30 GB-36	A5109 A5109	GRAB BAR 36"	C	C
GB-42	A5109	GRAB BAR 42"	C	C
GB-48	A5109	GRAB BAR 48"	C	C
GD-1	A5107	GLOVE DISPENSER	V	С
GH-1	A5145	GARMENT HOOK	С	С
HR-1		HAND RAIL	С	С
HS-1	A5077	HAND SANITIZER DISPENSER	V	V
LS-1 LT-1	T0285	LAUNDRY SINK DRILL PRESS	C	C V
LT-2	T0285	BAND SAW	V	V
LT-3	T0700	JACK STAND - SHOE REPAIR	V	V
LT-4	T0850	SOLE CUTTER - BENCH MOUNTED	V	V
LT-5	T0860	SEWING MACHINE	V	V
LT-6	T1500	FINISHING MACHINE	V	V
LT-7	T1510	VACUUM FORMING SYSTEM	V	V
LT-8	L2205	FUME HOOD	V	V
LT-9 LT-10	L8285 T0400	INFRARED OVEN GRINDER / POLISHER	V	V
LT-10	T0400	GRINDER / POLISHER GRINDER	V	V
LT-12	T0740	SANDER - BELT	V	V
LT-13	T9400	MACHINIST'S VISE	V	V
LT-14	D8540	SANDBLASTER	V	V
LT-15	T6000	CARVER	V	V
LV-1	P3000	LAVATORY MOD HOLDER	C	C
MH-1 MR-1	A1067	MOP HOLDER MIRROR	V	V C
MS-1	P4700	MOP SINK	C	C
MW-1	K4665	MICROWAVE	V	V
ND-1	A5090	SANITARY NAPKIN DISPOSAL	С	С
OP-1		OFFICE PARTITION	V	V
PB-1	M8240	PARALLEL BARS	V	С
PC-1	N 4 0 4 F	PRIVACY CURTAIN - TRACK ONLY	C	C
PH-1 PH-2	A1015 A1012	TELEPHONE TELEPHONE	V	V
PR-1	M1825	PRINTER	V	V
PR-2	,520	PLOTTER	V	V
PT-1	A5082	PAPER TOWEL DISPENSER W/ SENSOR	V	C
PT-2	A5080	PAPER TOWEL DISPENSER - SS	С	С
RF-1	R5100	FRIDGE / FREEZER	V	V
RS-1	A = 2 = -	ROLLER SHADES	C	C
SD-1	A5075	SOAP DISPENSER	V	V
SF-1 SF-2		SINK FAUCET SERVICE SINK FAUCET	C	C
SF-2 SG-1	A5106	GLOVE DISPENSER / SHARPS / WASTE	V	V
SH-1	, 10 100	OVERHEAD HARNESS / TRACK SYSTEM	C	C
SK-1		INTEGRATED CORIAN SINK	C	C
SR-1		SHREDDER	V	V
ST-1	F0340	STOOL - SELF ADJUSTING	V	V
SV-1	M2055	SHELVING STORAGE UNIT, WIRE, 72H60W18D	V	V
TB-1		CONFERENCE TABLE - 14	V	V
TB-2 TB-3	Z1013	CONFERENCE TABLE - 6 WORK TABLE	V	V
TL-1	P9050	TOILET - WALL HUNG	C	C
TT-1	A5200	TOILET TISSUE DISPENSER	V	C
TV-1	M0512	TELEVISION HDTV 60"	V	V
TV-2	A5212	TELEVISION BRACKET - WALL MTD - TILT/ANGLE	V	V
UR-1		URINAL	С	С
WB-1	T0120	WORK BENCH	V	V
WB-2	T0106	WORK BENCH - SEWING	V	V
WC-1	E0042	WORK CENTER	V	V
WL-1 WP-1	M4705 F2010	WHEEL CHAIR WASTE PAPER BASKET	V	V
v v 🗠 – I	1 4010	WASTE PAPER BASKET WASTE RECEPTACLE - WALL MOUNT	C	C
WR-1		TVAOIL NECLITAGEL - WALLINGATING	()	, , ,

	ARCHITECT/ENGIN	S	STAMP Office of		Drawing Title FINISH SCHEDULES	Phase DID DOOLINAENITO	Project Title Renovate and Repair Structural,	Project Number 589A7-21-108	
	Alesia Architecture P.C. 3705 North 200th Street Elkhorn, Nebraska 68022 Phone: 402.291.6941	SIMEG	SHAFFER	DICHARD PICHARD	Construction and Facilities		BID DOCUMENTS	Building 4	Building Number 4
	ARCHITECTURE	15 Sunnen Drive, Suite 104 STRUCT	SCHAAP SC	NKEN T P -5125	Management	Approved:		Location Wichita, KS	Drawing Number
Revisions: Date:		St. Louis, MO 63143 Phone: (314) 951-2534 9910 No 402.455	lorth 48th Street, Ste 204, Omaha, NE 68152 5.7698 www.s3pc.com	OF NEBRUDUL	VA U.S. Department of Veterans Affairs		FULLY SPRINKLERED	Issue Date Checked Drawn 9/23/2021	A-801

