

A

B

C

D

E

F

GENERAL ABBREVIATIONS

Table of general abbreviations including symbols like &, @, CL, etc., and their corresponding full names such as Angle, Centerline, Diameter or Round, etc.

GENERAL ARCHITECTURAL NOTES

- 1. THE CONTRACTOR SHALL INSPECT THE SITE STUDY EXISTING CONDITIONS, REVIEW DRAWINGS AND SPECIFICATIONS. CONTRACTOR SHALL ADJUST FOR ACTUAL FIELD CONDITIONS AT NO ADDITIONAL EXPENSE TO THE OWNER.
2. CONTRACTOR SHALL TAKE ALL MEASUREMENTS FOR THE WORK AND BE RESPONSIBLE FOR SAME. COORDINATE THE WORK AND SHOP DRAWINGS WITH ALL OTHER TRADES AFFECTED AND MAKE ANY NECESSARY OFFSETS TO CONCEAL PIPING AND DUCTWORK AND TO CLEAR EQUIPMENT, STRUCTURAL MEMBERS AND OTHER OBSTRUCTIONS.
3. ALL UTILITIES AND SERVICES SHALL BE KEPT IN CONTINUOUS OPERATION UNLESS WRITTEN PERMISSION IS OTHERWISE GRANTED BY THE OWNER.
3.1. MINOR SHUTDOWNS OF LESS THAN 48 HOURS REQUIRE 7 TO 14 DAYS NOTICE.
3.2. MAJOR SHUTDOWNS OF MORE THAN 48 HOURS REQUIRE 14 DAYS NOTICE.
3.3. CONTRACTOR MUST CONTACT VA'S COR PRIOR TO ANY SHUTDOWNS.
4. TEMPORARY ALTERATIONS AND CONNECTIONS REQUIRED BY THIS CONTRACT SHALL BE MADE SO THAT ALL BUILDING SERVICES ARE MAINTAINED WITH MINIMUM INTERRUPTION. SCHEDULE ALL ELECTRICAL/MECHANICAL OUTAGES 14 DAYS IN ADVANCE WITH THE OWNER.
5. PROTECT ALL WORK, MATERIALS AND EQUIPMENT. CAP OR PLUG TEMPORARY OPENINGS. DELIVER ALL WORK TO THE OWNER CLEAN AND IN GOOD CONDITION.
6. WHEN DEMOLITION IS COMPLETE, NOTIFY ARCHITECT AND OWNER FOR A SCHEDULED MEETING TO REVIEW EXISTING CONDITIONS AND ANY CONCERNS REGARDING NEW WORK.
7. CUTTING AND PATCHING OF EXISTING WALLS, FLOORS OR CEILINGS REQUIRED BY NEW WORK SHALL BE INCLUDED AS WORK PROVIDED UNDER THIS CONTRACT.
8. CUTTING SHALL BE DONE WITH CARE SO AS NOT TO DAMAGE EXISTING EQUIPMENT.
9. DAMAGE CAUSED BY SUCH CUTTING SHALL BE REPLACED OR REPAIRED TO ORIGINAL CONDITION BY CONTRACTOR AT NO COST TO THE OWNER, UNLESS UNFORESEEN EXISTING CONDITIONS ARE DISCOVERED AND OWNER IS NOTIFIED.
10. ALL OCCUPIED WORK AREAS, BUILDING CORRIDORS AND EXTERIOR AREAS SHALL BE KEPT CLEAR OF DEBRIS.
11. ALL MATERIALS AND EQUIPMENT SHALL BE NEW, OF THE BEST QUALITY AND FREE FROM DEFECTS.
12. MANUFACTURER AND MODEL NUMBERS SPECIFIED ESTABLISH THE TYPE AND QUALITY REQUIRED, UNLESS OTHERWISE NOTED.
13. ALL WORK SHALL COMPLY WITH APPLICABLE REGULATIONS, CODES AND ORDINANCES.
14. THE CONTRACTOR SHALL PERFORM ALL TESTS AS SPECIFIED OR AS NECESSARY TO DEMONSTRATE A COMPLETE AND SATISFACTORY INSTALLATION.
15. ALL EXPOSED PENETRATIONS MADE THROUGH EXISTING ROOFS, FLOORS, AND WALLS SHALL BE PATCHED WITH LIKE MATERIALS TO MATCH THE SURROUNDING AREAS, AND FILLED AS CLOSE AS POSSIBLE TO THE NEW PIPING OR DUCTWORK.
15.1. ALL EXPOSED PENETRATIONS MADE THROUGH EXISTING ROOFS ARE TO BE COORDINATED WITH THE ROOFING WARRANTY CONTRACTOR.
15.2. ALL PENETRATIONS THROUGH RATED WALLS SHALL BE PATCHED TO MAINTAIN RATING.
16. THE CONTRACTOR SHALL BE RESPONSIBLE FOR REPAIRING AND REPLACING ANY DAMAGE TO EXISTING MATERIALS RESULTING FROM WORK UNDER THIS CONTRACT AND SHALL RESTORE SUCH TO ITS ORIGINAL CONDITION WITH NEW MATERIALS TO MATCH EXISTING.
17. INSTALL THE SPECIFIED FIRE STOPPING (SLEEVES, WRAP, CONDUIT, ETC.) AT RATED CONSTRUCTION:
17.1. FIRE STOP ALL PENETRATIONS WHERE NEW DEVICES/LINES, RELOCATING EXISTING DEVICES/LINES, PENETRATING FLOORS, CEILINGS AND OTHER RATED BARRIERS.
17.2. FIRE STOP ALL NEWLY CREATED PENETRATIONS WHERE EXISTING DEVICES/LINES PENETRATE FLOORS, CEILINGS AND OTHER RATED BARRIERS. USE FIRE APPROVED CAULKING AND FIRE STOPS (SEE SPECIFICATIONS).
18. ALL METAL STUD AND GYPSUM WALLBOARD PARTITIONS ARE DIMENSIONED TO THE OUTSIDE FACE OF WALL AND TO THE COLUMN GRID UNLESS OTHERWISE NOTED.
19. ALL GYPSUM BOARD SHALL BE TYPE 'X' FIRE CODE GYPSUM BOARD MOLD AND MOISTURE RESISTANT AT WALLS AND CEILINGS.
20. PROVIDE WOOD BLOCKING OR 1/8 GA. SHEET METAL BACKING PLATES IN ALL WALLS TO RECEIVE WALL HUNG ACCESSORIES, SUCH AS EQUIPMENT, GRAB BARS, MILLWORK, COAT HOOKS, AND DOOR STOPS, ETC. IF WOOD BLOCKING IS USED, PROVIDE AS FIRE-RESISTANT.
21. ALL ITEMS AND DEVICES, SUCH AS COVER PLATES, SWITCH PLATES, CONVENIENCE OUTLETS, DOOR STOPS, AND OTHER FINISH HARDWARE, ETC. SHALL BE REMOVED AND REINSTALLED AS PART OF THE REFINISHING OF EXISTING WALLS INDICATED TO REMAIN.
22. THE CONTRACTOR SHALL WORK WITH THE CONDITIONS AS THEY EXIST AT THE SITE. ALL ABOVE CEILING CONDITIONS SHALL BE REVIEWED AND MODIFICATIONS IDENTIFIED, COORDINATED, AND INCORPORATED INTO THE SHOP DRAWINGS PROCESS. COORDINATE ALL ABOVE CEILING WORK TO ENSURE A COMPLETE AND OPERATIONAL SYSTEM AT NO ADDITIONAL COST TO THE OWNER. COORDINATION SHALL INCLUDE, BUT NOT BE LIMITED TO THE FOLLOWING:
22.1. THE OWNER'S EQUIPMENT REQUIREMENTS.
22.2. THE CEILING SUPPORT SYSTEM.
22.3. THE MECHANICAL DUCTWORK SYSTEM.
22.4. THE LIGHTING FIXTURES.
22.5. ELECTRICAL WIRING AND CONDUIT SYSTEMS.
22.6. THE PLUMBING AND PIPING SYSTEMS.
22.7. THE COMMUNICATIONS SYSTEMS.
23. ALL CONTRACTORS ARE RESPONSIBLE FOR REVIEWING ENTIRE SET OF DOCUMENTS TO DETERMINE THEIR FULL SCOPE OF WORK. CONTRACTOR SHALL NOT BE ALLOWED EXTRA COSTS DUE TO FAILURE TO REVIEW ENTIRE SET OF DOCUMENTS.
24. ALL NEW STUD WALLS AND GYPSUM BOARD SHALL EXTEND TO STRUCTURE UNLESS NOTED OTHERWISE.
25. WHEN ALTERING THE BUILDING, IF STRUCTURAL INTEGRITY APPEARS TO BE IN QUESTION CONTRACTOR SHALL NOTIFY OWNER AND ARCHITECT IMMEDIATELY.
26. ALL NEW CONSTRUCTION IS INDICATED BOLD OR FULL TONE UNLESS NOTED OTHERWISE.
27. WHEN WALL PARTITIONS OF DIFFERENT FIRE RATING INTERSECT, THE HIGHEST RATED PARTITION TAKES PRECEDENT, MAINTAIN RATING BEHIND RECESSED AREAS IN WALLS.
28. ALL CORRIDOR WALLS ARE REQUIRED TO BE SMOKE TIGHT, WHETHER THEY ARE FIRE RATED OR NOT. REPAIR AND EXTEND AT LEAST THE CORRIDOR SIDE OF NON-RATED CORRIDOR WALLS TO STRUCTURE, UNLESS NOTED OTHERWISE. SEE WALL TYPES LISTED IN DRAWINGS.
29. COORDINATE CONSTRUCTION REQUIREMENTS WITH MECHANICAL AND ELECTRICAL DRAWINGS.
30. REVIEW AREAS OF WORK WITH COR FOR INFECTION CONTROL REQUIREMENTS. AREAS REQUIRING CLASS I/CLASS II INFECTION CONTROL WILL REQUIRE APPROVAL BY THE COR PRIOR TO BEGINNING WORK. AREAS REQUIRING CLASS III/CLASS IV INFECTION CONTROL REQUIRE PERMITS FROM THE VA. SEE DIVISION 1 SPECIFICATION 'SAFETY REQUIREMENTS-INFECTION CONTROL' FOR DETAILED INFORMATION.
31. CONTRACTOR SHALL OBSERVE WORK RESTRICTIONS NOTED IN PHASING REQUIREMENTS, ON DRAWINGS AND IN THE SPECIFICATIONS FOR AREAS THAT ARE A PART OF OR ADJACENT TO ADMINISTRATIVE, DIETARY, SUPPORT, IN-PATIENT, OUT-PATIENT AND CLINICAL AREAS.

IMPORTANT CONTRACTOR NOTES:

- 1. ALL CONTRACTORS ARE RESPONSIBLE FOR REVIEWING ENTIRE SET OF DOCUMENTS TO DETERMINE THEIR FULL SCOPE OF WORK. CONTRACTOR SHALL NOT BE ALLOWED EXTRA COSTS DUE TO FAILURE TO REVIEW ENTIRE SET OF DOCUMENTS.
2. COVER AND PROTECT ALL VA EQUIPMENT AND FURNITURE SO THAT THE FUNCTION AND APPEARANCE IS NOT AFFECTED BY CONSTRUCTION, THE CONTRACTOR, THEIR EQUIPMENT, MATERIALS, OR ANY INVOLVED ACTIONS.
3. A 1 HR MINIMUM FIRE-RATED SEPARATION IS REQUIRED BETWEEN ALL OCCUPIED SPACE AND CONSTRUCTION AREAS. THIS PROTECTION INCLUDES ANY EXISTING PENETRATIONS AND OPENINGS.

FIRE PROOFING GENERAL NOTES:

- 1. MAINTAIN FIRE RATED CONSTRUCTION AT WALL PENETRATIONS, (CONSTRUCTION TO CONFORM TO MANUFACTURER'S FIRE RATED/TEST ASSEMBLIES.)
2. FIRE CAULK ALL SLEEVES AND PENETRATIONS AT FIRE WALLS/PARTITIONS AND FLOORS. CONFORM WITH THE TESTED/SUBMITTED FIRE RATED ASSEMBLY. USE RED FIRE CAULK AND LABEL WALL WITH U.L. DESIGN NUMBER AND ASTM. FIRE RATED WALLS SHOWN ON PLAN.
3. PATCH AND REPAIR ALL EXISTING FIRE CAULKING AT EXISTING RATED WALLS WHICH IS UNCOVERED NEEDING REPAIR AND THAT WHICH IS DISTURBED DURING CONSTRUCTION. RE-LABEL EXISTING WALL IF NECESSARY.

HAZARDOUS MATERIAL:

- 1. IF THE CONTRACTOR ENCOUNTERS MATERIAL THAT COULD BE HAZARDOUS, THE CONTRACTOR SHALL STOP WORK AND NOTIFY THE OWNER IMMEDIATELY FOR DIRECTION.


MATERIAL SYMBOLS

Table of material symbols including Earth, Cast-in-place concrete, Grout, Steel, Continuous wood framing, Wood blocking, Fibrous insulation, and Gypsum board.

9/23/2021 9:47:55 PM
9/23/2021 10:38:42:21-108 - Renewate and Repair Structural Building 4/821-102-103.rvt
VA FORM 08 - 6231

Revisions table with columns for Revisions and Date.

ARCHITECT/ENGINEER OF RECORD
ALEZIA ARCHITECTURE
IMEG CORP.
SHAFFER STEVENS SCHAAP STRUCTURAL ENGINEERS

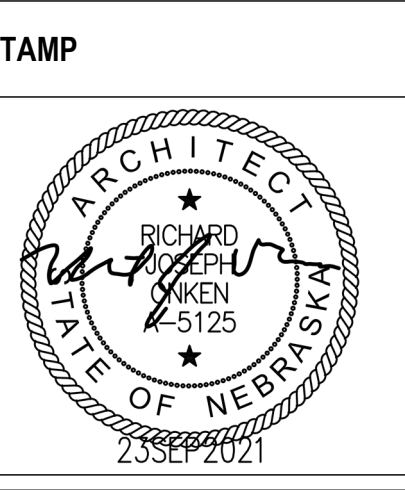


Office of Construction and Facilities Management
U.S. Department of Veterans Affairs

Drawing Title: ARCHITECTURAL ABBREVIATIONS, LEGENDS AND NOTES
Approved:

Phase: BID DOCUMENTS
FULLY SPRINKLERED

Project Title: Renovate and Repair Structural, Building 4
Location: Wichita, KS
Issue Date: 9/23/2021
Checked:
Drawn:

Project Number: 589A7-21-108
Building Number: 4
Drawing Number: AG001

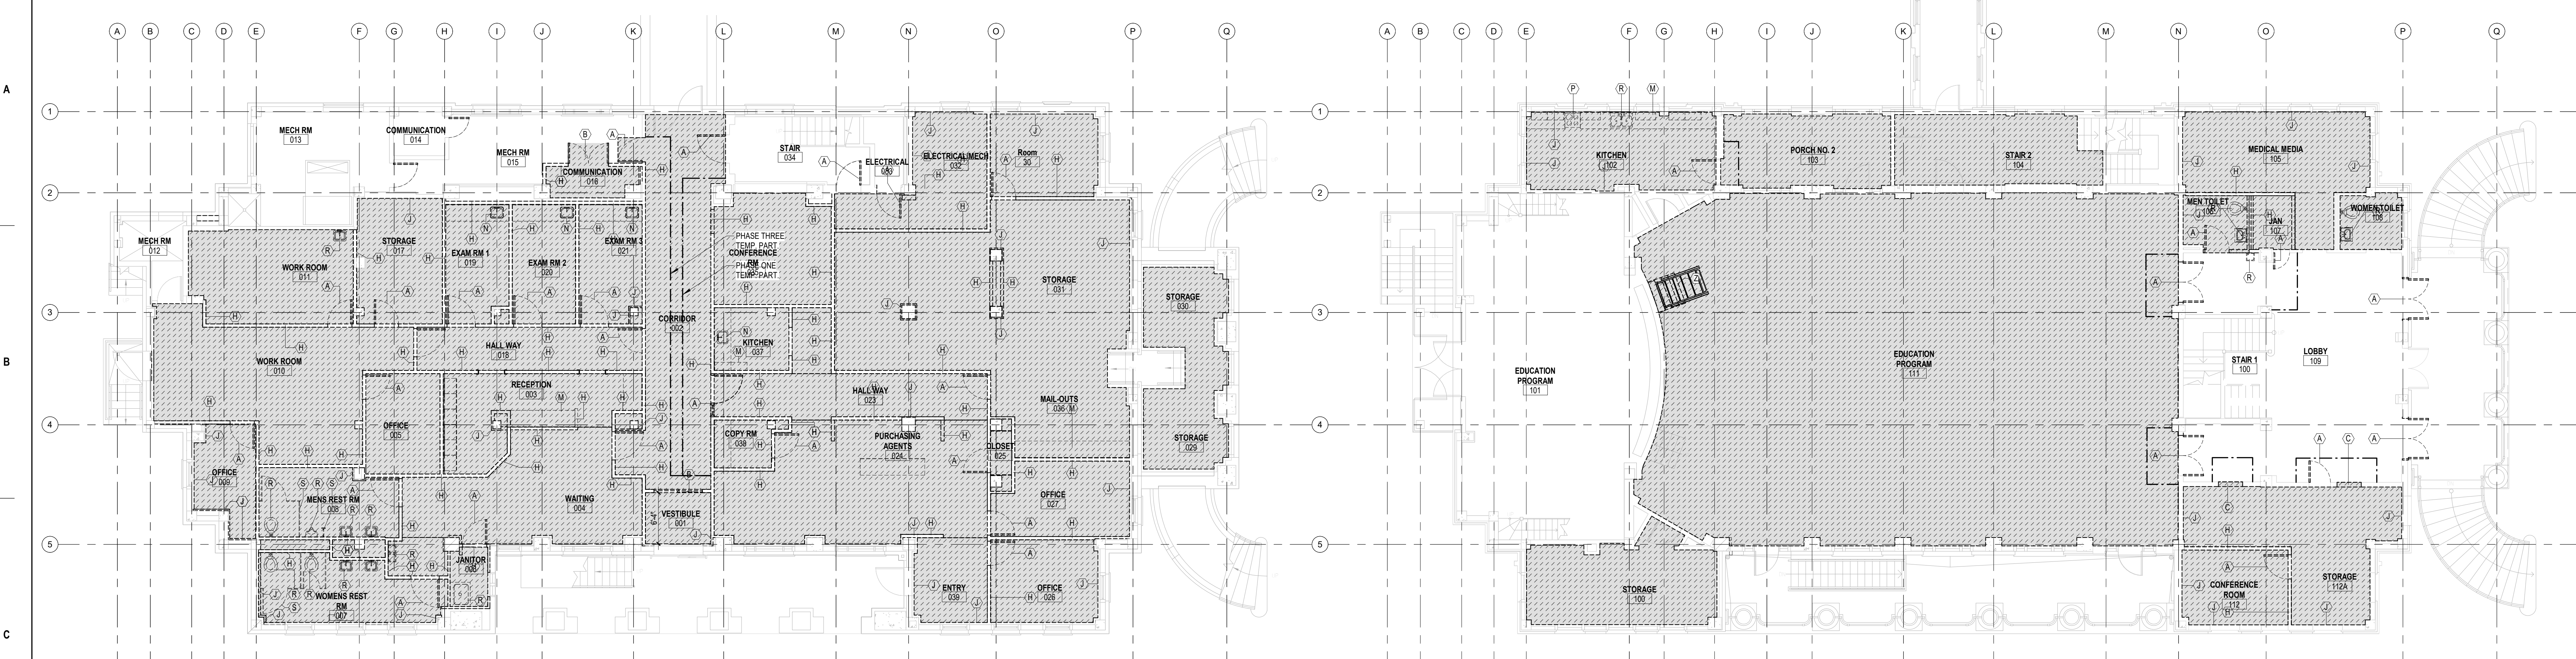

1 BASEMENT DEMOLITION
1/8" = 1'-0"

2 FIRST FLOOR DEMOLITION
1/8" = 1'-0"

- GENERAL DEMOLITION NOTES:
- DASHED BOLD LINES INDICATE EXTENT OF DEMOLITION INCLUDING THE FOLLOWING:
 - INTERIOR PARTITIONS (REMOVED TO STRUCTURE)
 - CEILINGS, INCLUDING CEILING SUSPENSION SYSTEM, MISC. STEEL SUPPORTS FOR SUSPENDED EQUIPMENT, SUSPENDED EQUIPMENT, LIGHT FIXTURES, DIFFUSERS AND GRILLES, ETC.
 - FLOOR FINISHES (TO CONCRETE) INCLUDING CARPET, RVT, SHEET VINYL, CERAMIC TILE, QUARRY TILE, BRICK PAVERS, ETC.
 - DOORS AND FRAMES UNLESS NOTED OTHERWISE. FLOOR SCHEDULE WINDOW GLAZING AND FRAMES UNLESS NOTED OTHERWISE.
 - BRICK AND BACK-UP WALL SYSTEM
 - CABINETWORK, SHELVING, BASES
 - TOILET PARTITIONS AND ACCESSORIES
 - TACK BOARDS, MARKER BOARDS, PEGBOARDS, DISPLAY BOARDS
 - EQUIPMENT TRAYS
 - PLUMBING FIXTURES
 - CONTRACTOR SHALL FIELD VERIFY ALL EXISTING CONDITIONS.
 - ALL LIGHT OR HALFTONE LINES INDICATE EXISTING TO REMAIN.
 - SEE SPECIFICATIONS SECTIONS FOR CUTTING AND PATCHING AND DEMOLITION 02 41 00.
 - SEE ROOM FINISH SCHEDULE, MECHANICAL PLANS, AND ELECTRICAL PLANS FOR EXTENT OF NEW CEILING CONSTRUCTION OR CEILING PATCHING IN EXISTING AREAS.
 - SEE ROOM FINISH SCHEDULE FOR EXTENT OF NEW FLOORING MATERIAL IN EXISTING AREAS.
 - SEE ROOM FINISH SCHEDULE FOR EXTENT OF NEW WALL COVERING MATERIAL IN EXISTING AREAS. WHERE NEW FINISHES ARE REQUIRED REMOVE EXISTING WALL FINISHES, (TEXTURED PLASTIC COATING, VINYL WALL COVERING, PANELING, BASE, ETC.).
 - CONTRACTOR TO VERIFY ALL WALL CONSTRUCTION & FINISHES NOTED FOR REMOVAL. TAKE INTO ACCOUNT ANY DISCREPANCY AND MAKE PROPER ADJUSTMENT TO ACCOMPLISH REQUIRED CONSTRUCTION & FINISHES. IF STRUCTURAL INTEGRITY IS VIOLATED, CONTACT ARCHITECT. COORDINATE PHASING WITH OWNER.
 - COORDINATE REMOVAL OF FURNITURE AND EXISTING EQUIPMENT WITH OWNER.
 - REFER TO EQUIPMENT PLAN / SCHEDULE FOR NEW LOCATIONS OF EXISTING EQUIPMENT, ETC.
 - SAW CUT EDGES OF EXISTING FLOOR SLAB FOR REMOVAL AND INSTALLATION OF UTILITIES. REFER TO MECHANICAL AND ELECTRICAL DRAWINGS.
 - REMOVE FURRING OR GWB ONLY WHERE REQUIRED TO COMPLETE CONSTRUCTION. PATCH AND MATCH WALLS AS REQUIRED TO COMPLETE AND MATCH EXISTING CONDITIONS, UNLESS AN ALTERNATIVE MATERIAL AND FINISH IS INDICATED.
 - REMOVE CEILINGS ONLY AS REQUIRED FOR NEW CONSTRUCTION. REINSTALL, REPLACE OR PATCH AS REQUIRED.
 - SEE SHEETS HA-101 AND HA-102 FOR HAZARDOUS MATERIAL LOCATIONS.
 - CONTRACTOR MAY ENCOUNTER CLAY TILE STRUCTURE BEHIND GYPSUM BOARD IN SOME LOCATIONS. DEMOLISH WHERE OTHERWISE SHOWN TO REMOVE STUD SYSTEM.

Key Value	Keynote Text
A	REMOVE DOOR AND FRAME.
B	REMOVE DOOR, FRAME AND INDICATED PORTION OF ADJOINING WALL REQUIRED FOR DOOR AND FRAME INSTALLATION.
C	REMOVE WALL AS INDICATED FOR DOOR AND FRAME INSTALLATION.
H	REMOVE GWB AND STUD SYSTEM.
J	REMOVE FINISH MATERIAL AND GWB / BACKER WHERE REQUIRED FOR NEW CONSTRUCTION. FURRING SYSTEM MAY REMAIN WHERE PRESENT.
M	REMOVE MILLWORK.
N	REMOVE MILLWORK AND ATTACHED PLUMBING FIXTURES OR ELECTRICAL DEVICES AND CONNECTIONS.
P	REMOVE EQUIPMENT (MEDICAL, DIETARY, ETC.) TURN OVER TO OWNER OR SALVAGE FOR RELOCATION SEE SPECIFICATION DIVISION 11.
R	REMOVE PLUMBING AND FIXTURES INDICATED. REFER TO MECHANICAL DRAWINGS.
S	REMOVE TOILET PARTITIONS, AND BATHROOM ACCESSORIES.
Z	REMOVE EXISTING STAIR.

DEMOLITION PLAN LEGEND

- FULL HEIGHT ONE-HOUR FIRE RATED TEMPORARY PARTITION
- ELEMENT TO BE REMOVED, TYPICAL
- INDICATES EXISTING FLOOR FINISH TO BE REMOVED
- EXISTING CONSTRUCTION TO REMAIN UNO.




3 SECOND FLOOR DEMOLITION
1/8" = 1'-0"


Revisions:	Date:

<p>ARCHITECT/ENGINEER OF RECORD</p> <p>ALESIA ARCHITECTURE Alesia Architecture P.C. 3705 North 200th Street Elkhorn, Nebraska 68022 Phone: 402.291.6941</p>		<p>IMEG S3 SHAFER STEVENS SCHAAP STRUCTURAL ENGINEERS IMEG Corp. 15 Sunbeam Drive, Suite 104 St. Louis, MO 63143 Phone: (314) 951-2534</p>		<p>STAMP</p>	<p>Office of Construction and Facilities Management</p> <p>VA U.S. Department of Veterans Affairs</p>	<p>Drawing Title</p> <p>DEMOLITION PLANS</p> <p>Approved:</p>	<p>Phase</p> <p>BID DOCUMENTS</p> <p>FULLY SPRINKLERED</p>	<p>Project Title</p> <p>Renovate and Repair Structural, Building 4</p> <p>Location</p> <p>Wichita, KS</p> <p>Issue Date</p> <p>9/23/2021</p>	<p>Project Number</p> <p>589A7-21-108</p> <p>Building Number</p> <p>4</p> <p>Drawing Number</p> <p>AD101</p>
--	--	---	--	--------------	---	--	---	--	--


A
B

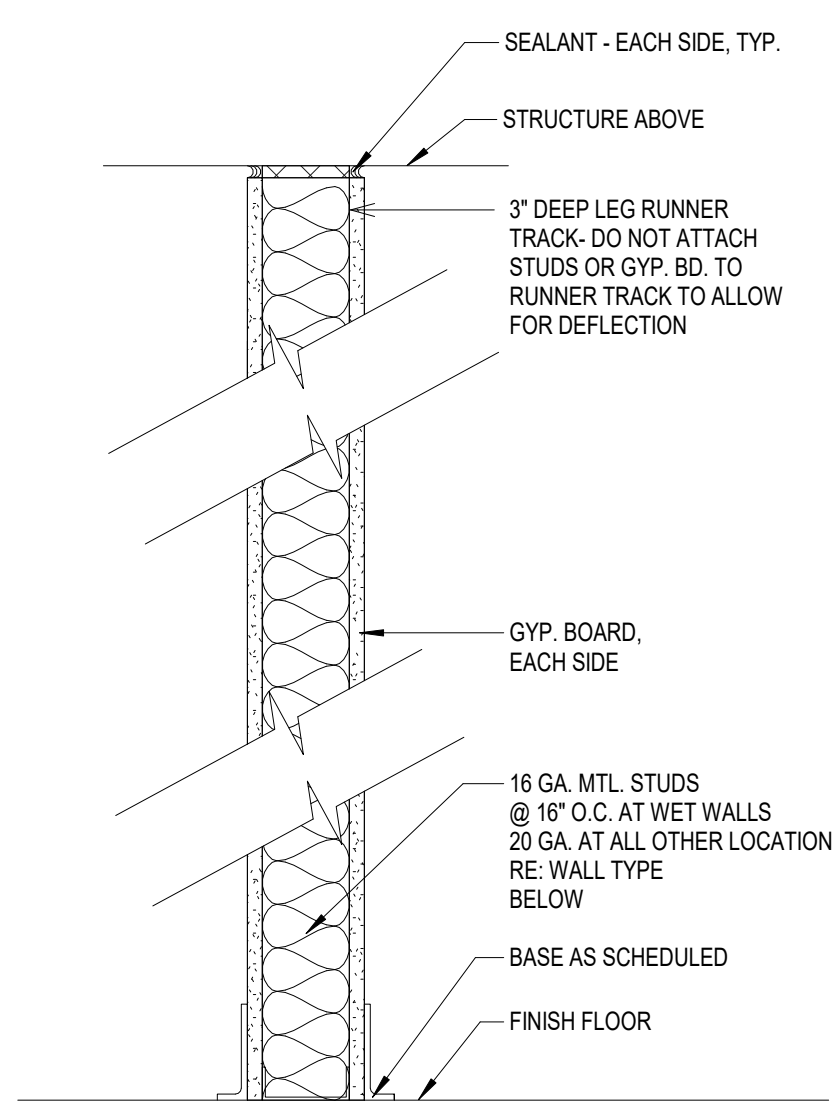


A 4 7/8" WIDTH.
3 5/8" 16 GA. AT WET WALLS (TOILETS & SINKS).
20 GA. ALL OTHER LOCATIONS
5/8" GB BOTH SIDES W/ SOUND BATTS TO STRUCTURE.
STC RATING 45

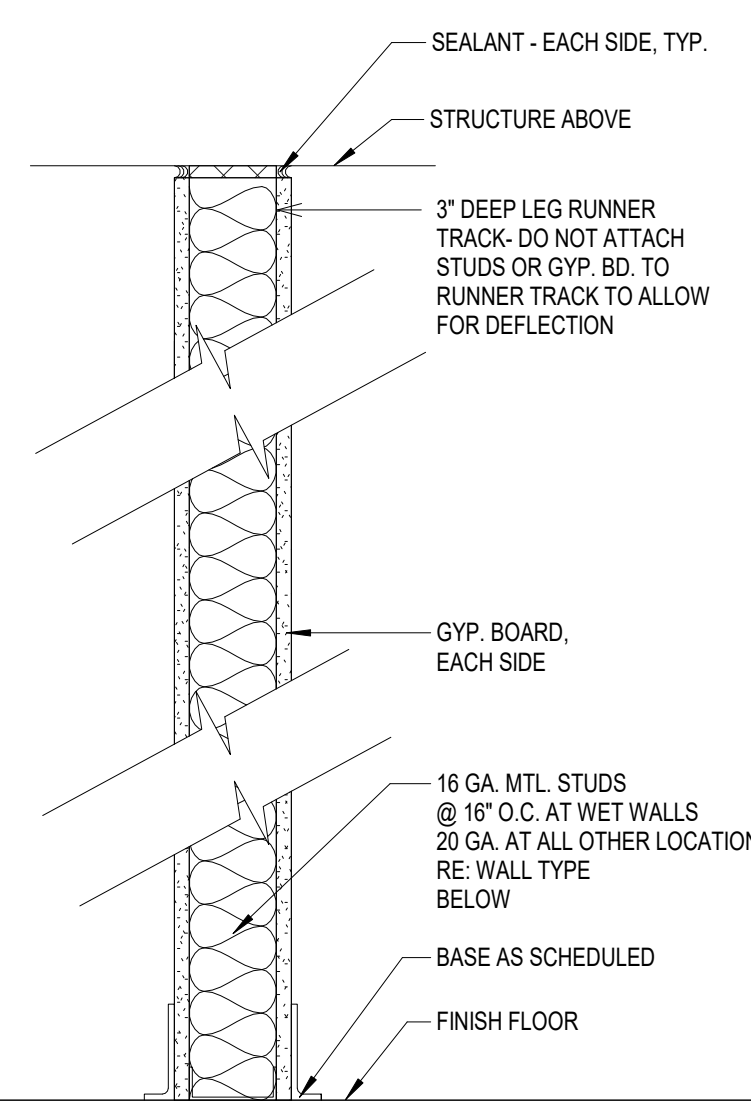


B 4 7/8" WIDTH.
3 5/8" 16 GA. AT WET WALLS (TOILETS & SINKS).
20 GA. ALL OTHER LOCATIONS
5/8" GB BOTH SIDES W/ SOUND BATTS TO STRUCTURE.
STC RATING 45.
UL DESIGN NO. U465

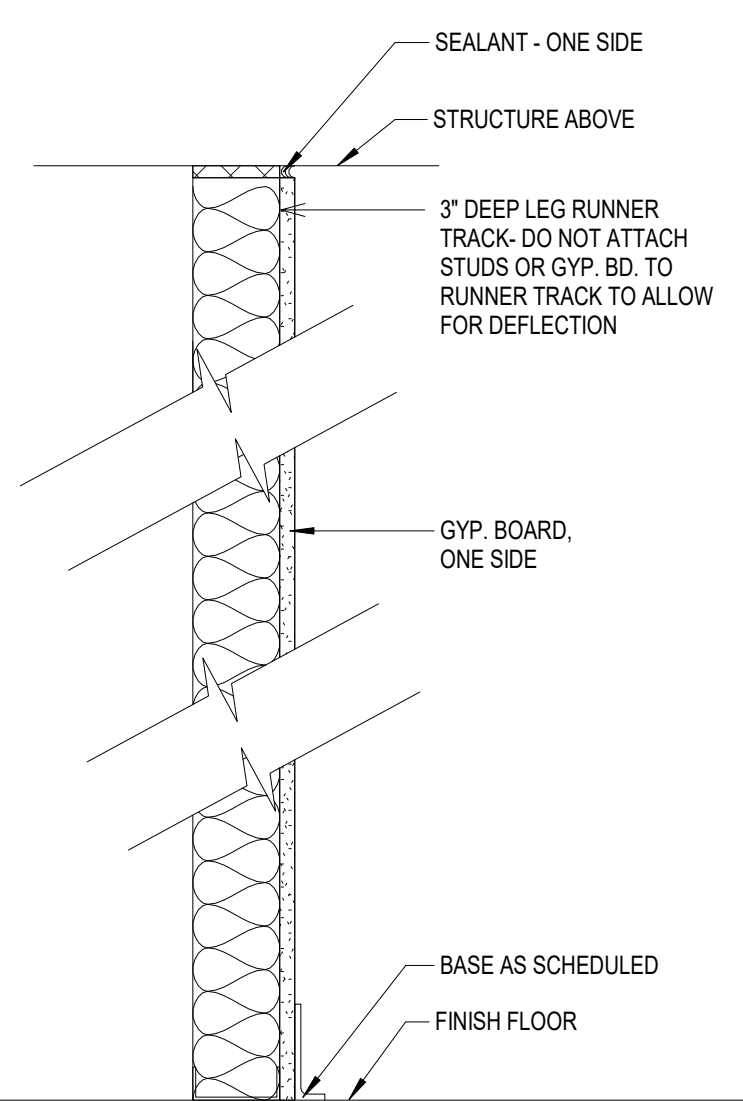


C 4 1/4" WIDTH.
3 5/8" 16 GA. AT WET WALLS (TOILETS & SINKS).
20 GA. ALL OTHER LOCATIONS
MTL STUD WITH 5/8" GB ONE SIDE W/ SOUND BATTS TO STRUCTURE

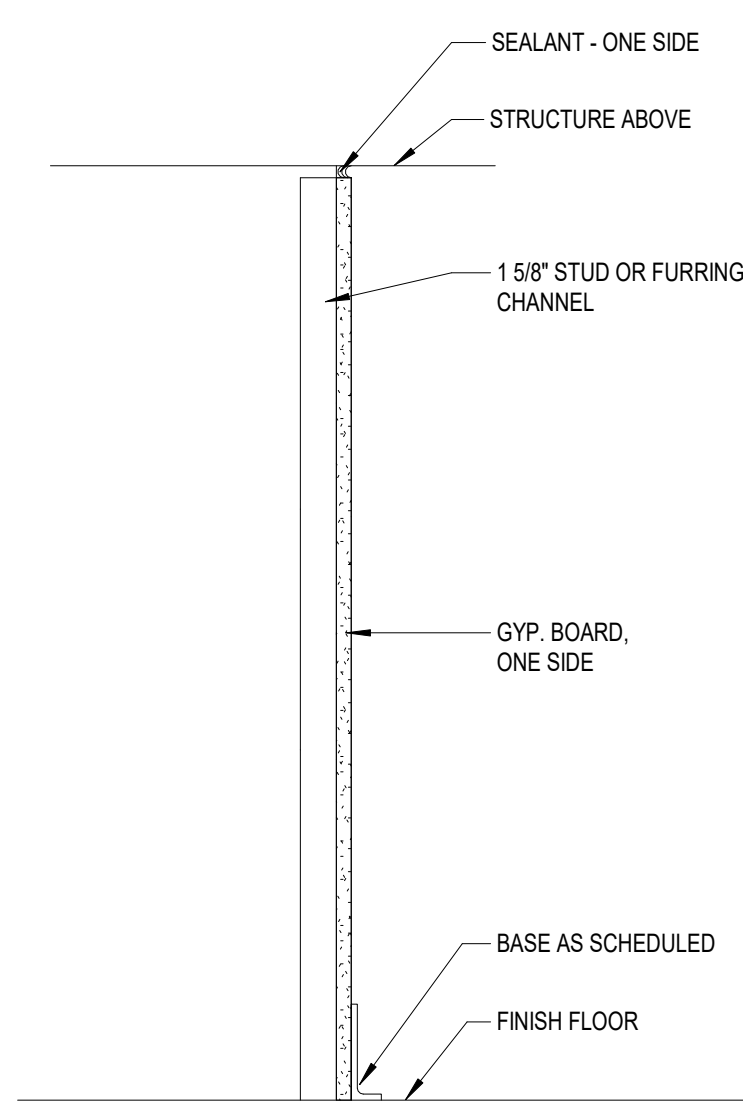


D 2 1/4" WIDTH.
1 5/8" STUD OR FURRING CHANNEL.
15/8" 20 GA. MTL STUD.
ONE SIDE TO STRUCTURE

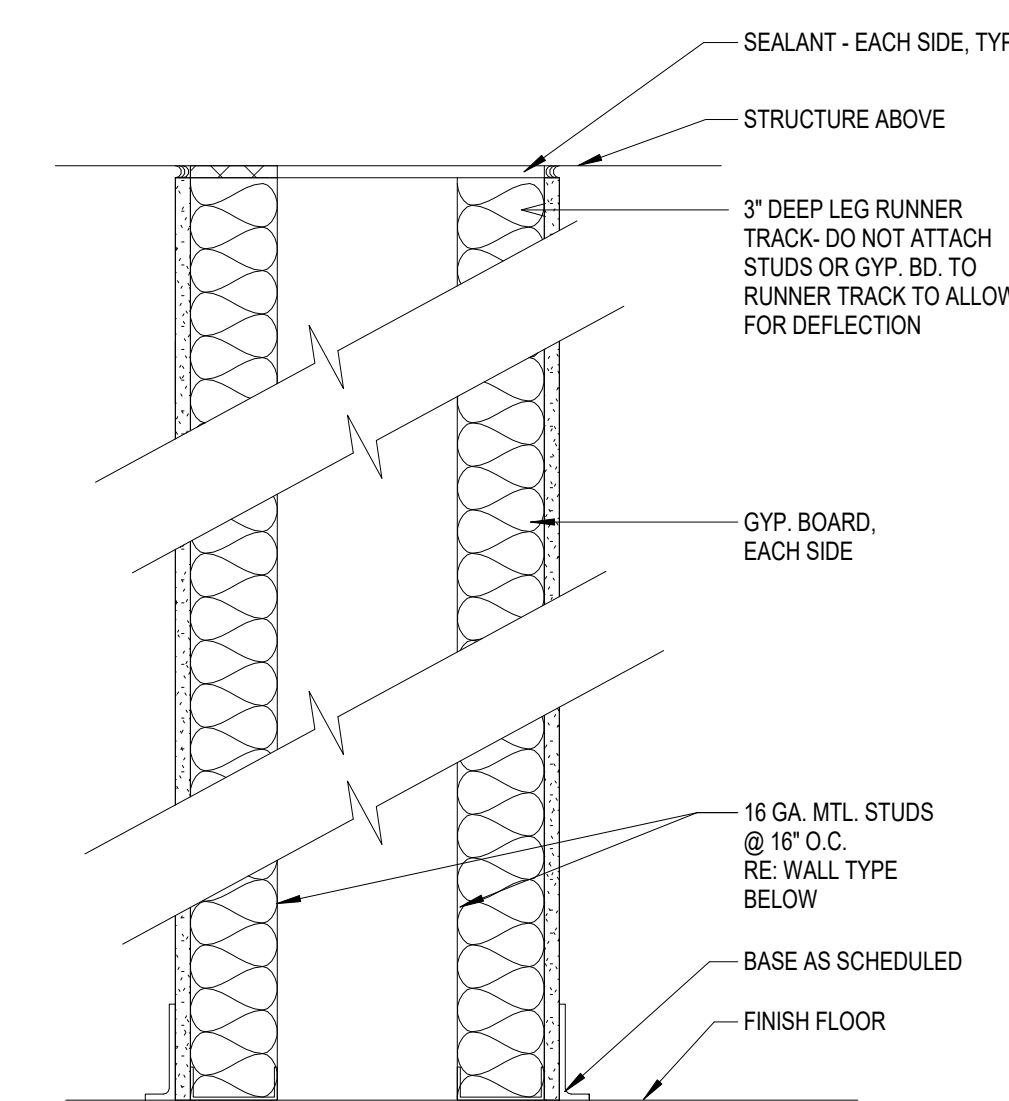

E 16" WIDTH.
3 5/8" 16 GA. MTL STUD & 5/8" GB OUTER SIDES.
20 GA. FOR NON-WET WALLS.
7 1/2" SPACE BETWEEN W/ SOUND BATTS TO STRUCTURE

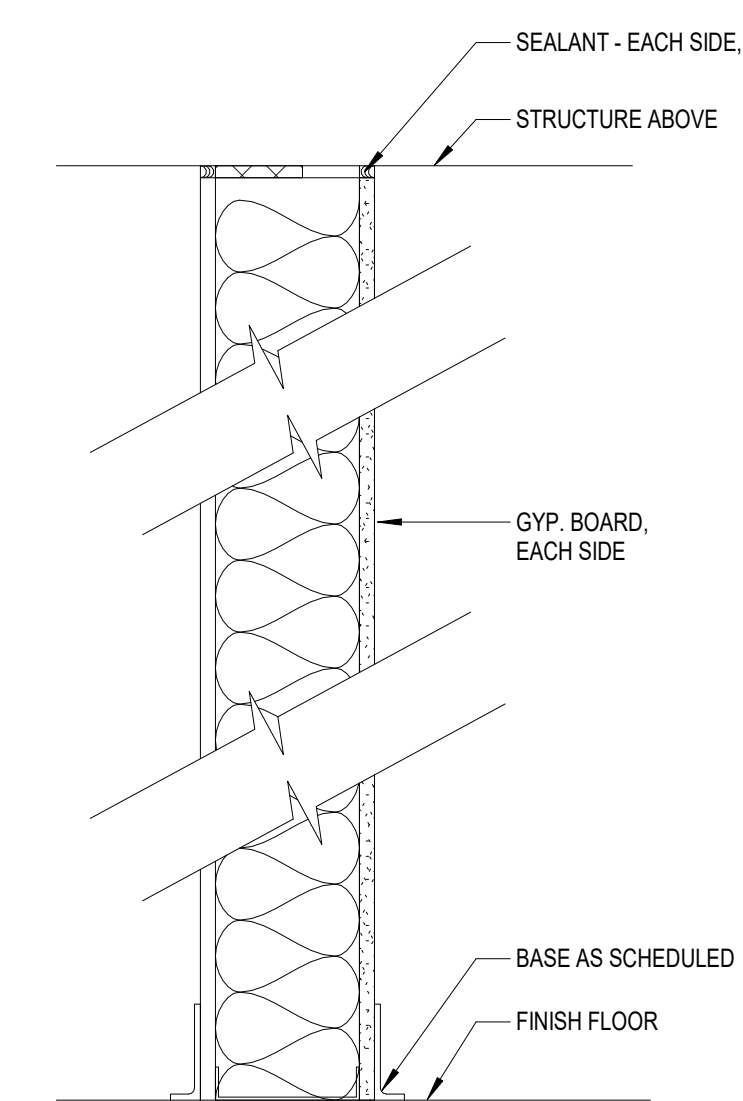


F 7 1/4" WIDTH.
6" 16 GA. MTL STUD & 5/8" GB OUTER SIDES.
SOUND BATTS TO STRUCTURE

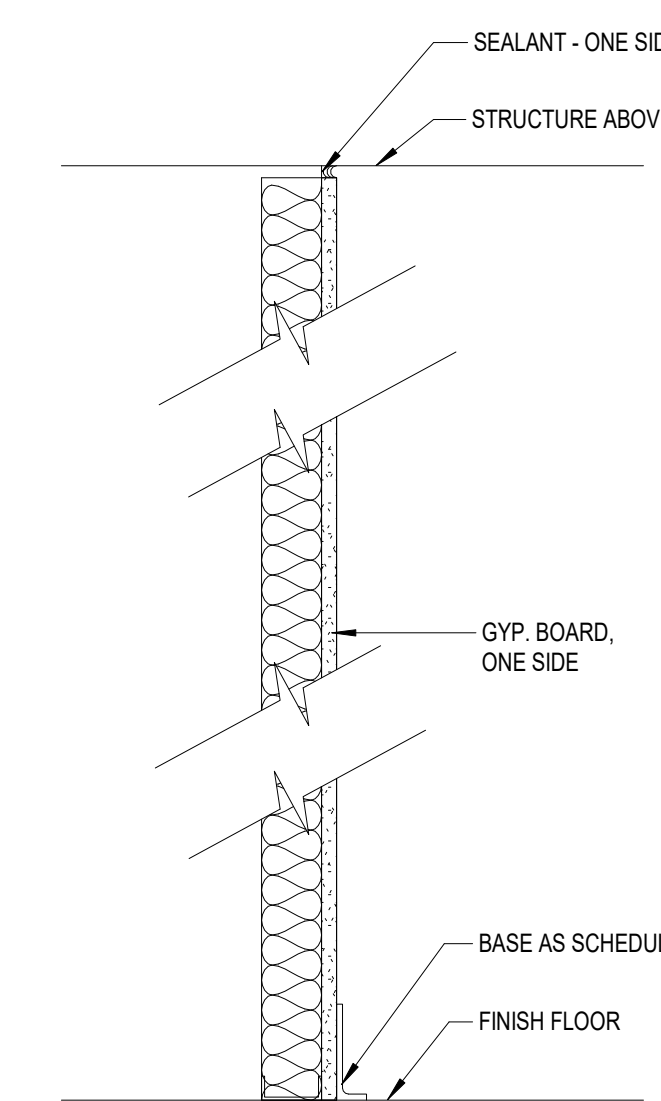


G 3 1/8" WIDTH.
2 1/2" GB 20 GA. MTL STUD.
ONE SIDE TO STRUCTURE

A
B

1 WALL TYPES
1 1/2" = 1'-0"

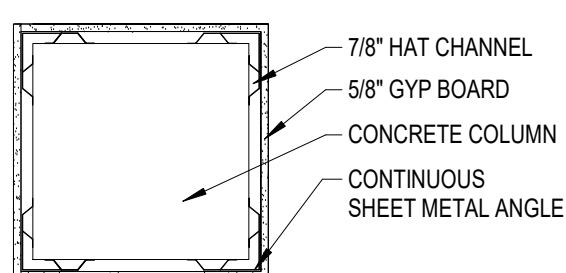

2 Column Detail
3/4" = 1'-0"

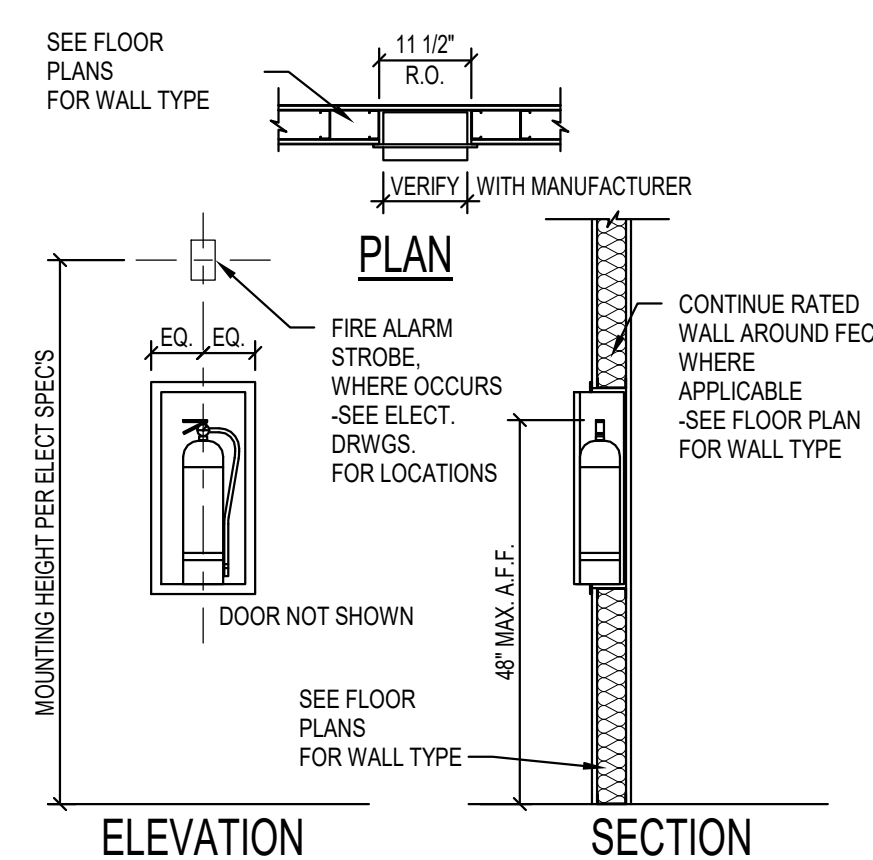

3 FIRE EXTINGUISHER CABINET
1/2" = 1'-0"

BIM 360://2021-03-30/9A7-21-108 - Renovate and Repair Structural Building 4/9/21-102-103.rvt
 9/23/2021 9:46:58 PM
 F
 T

Revisions:	Date:

ARCHITECT/ENGINEER OF RECORD

ALESIA ARCHITECTURE
 Alesia Architecture P.C.
 3705 North 200th Street
 Elkhorn, Nebraska 68022
 Phone: 402.291.6941

IMEG Corp.
 15 Saurien Drive,
 Suite 104
 St. Louis, MO 63143
 Phone: (314) 951-2534

SHAFER STEVENS SCHAAP STRUCTURAL ENGINEERS
 9910 North 48th Street, Ste 204, Omaha, NE 68152
 402.455.7698 www.s3ep.com

STAMP

Office of Construction and Facilities Management

VA U.S. Department of Veterans Affairs

Drawing Title
WALL TYPES AND DETAILS

Approved:

Phase
BID DOCUMENTS

FULLY SPRINKLERED

Project Title
Renovate and Repair Structural, Building 4

Location
Wichita, KS

Issue Date
9/23/2021

Checked


Drawn

Project Number
589A7-21-108

Building Number
4

Drawing Number
A-100

9/23/2021 9:47:04 PM
 BM 360/2021-03 589A7-21-108 - Renewal and Repair Structural Building 4R21-102-103.rvt
 9/23/2021

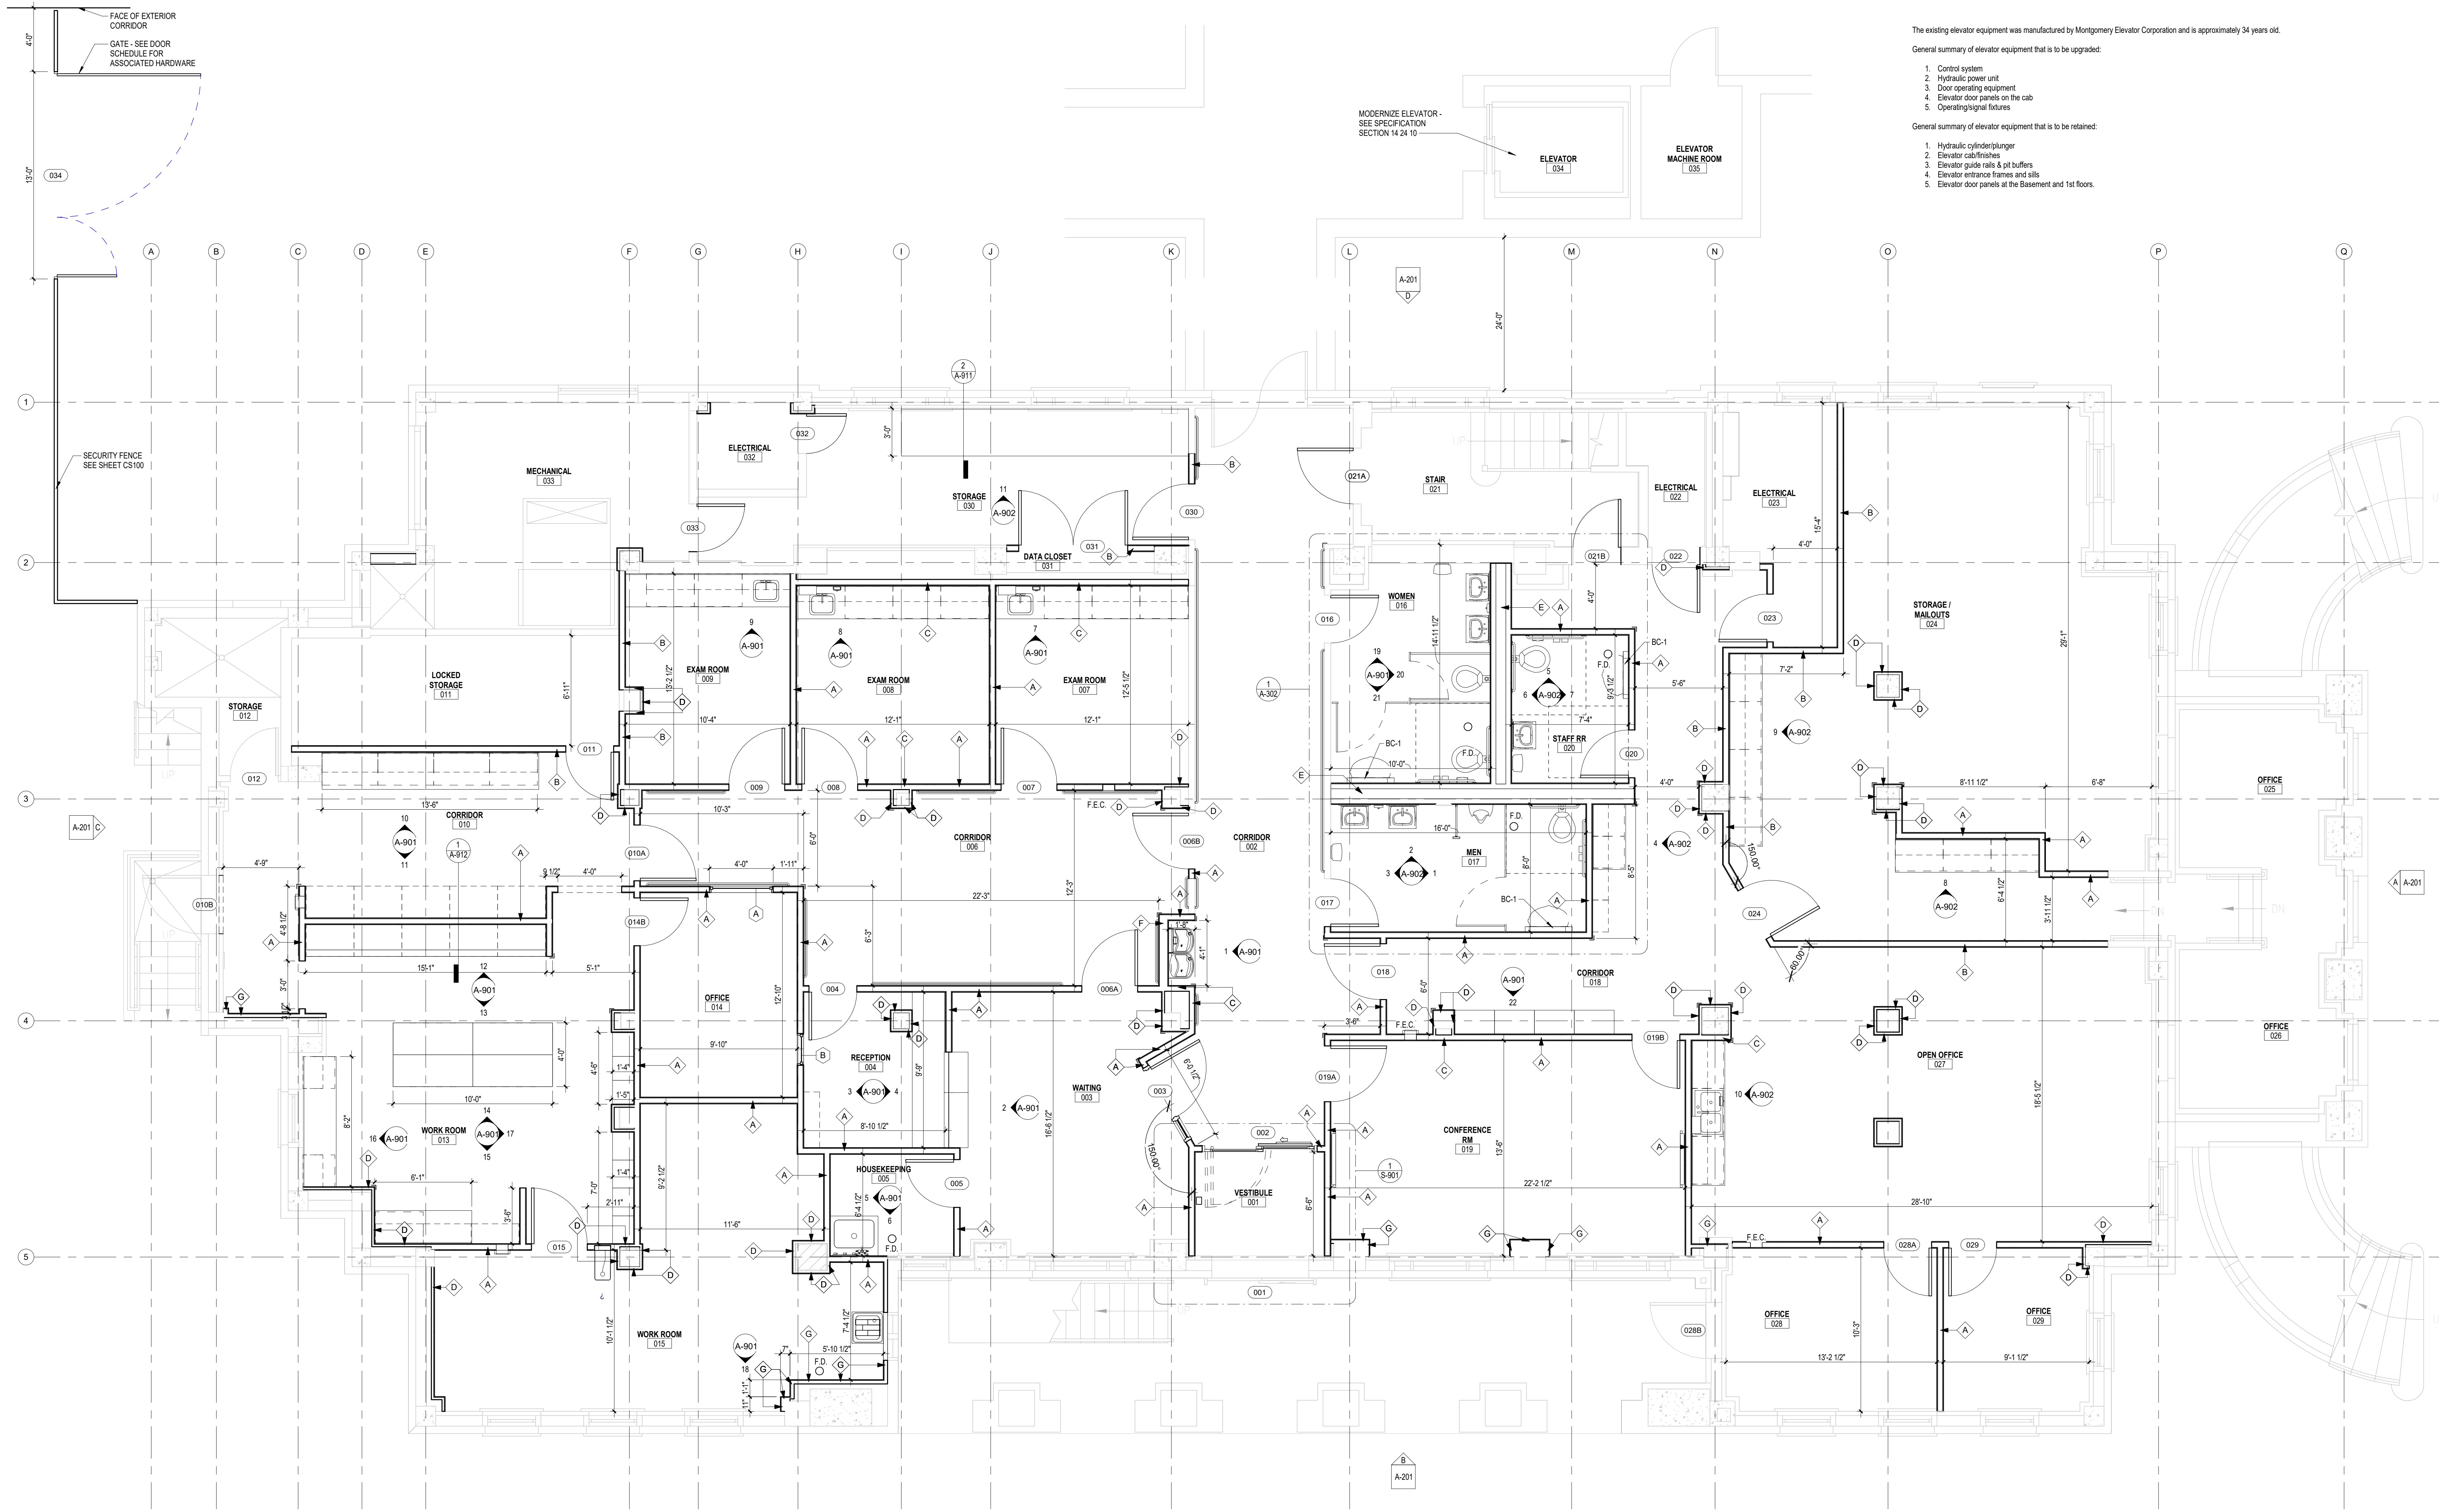

- The existing elevator equipment was manufactured by Montgomery Elevator Corporation and is approximately 34 years old.
- General summary of elevator equipment that is to be upgraded:
1. Control system
 2. Hydraulic power unit
 3. Door opening equipment
 4. Elevator door panels on the cab
 5. Operating signal fixtures
- General summary of elevator equipment that is to be retained:
1. Hydraulic cylinder/plunger
 2. Elevator cab/finishes
 3. Elevator guide rails & pit buffers
 4. Elevator entrance frames and sills
 5. Elevator door panels at the Basement and 1st floors.

1 BASEMENT
1/4" = 1'-0"


Revisions:	Date:

ARCHITECT/ENGINEER OF RECORD

ALESIA ARCHITECTURE
 Alesia Architecture P.C.
 3705 North 200th Street
 Elkhorn, Nebraska 68022
 Phone: 402.291.6941

IMEG S3
 IMEG Corp.
 15 Sunbeam Drive,
 Suite 104
 St. Louis, MO 63143
 Phone: (314) 951-2534

SHAFFER STEVENS SCHAAP STRUCTURAL ENGINEERS
 9919 North 48th Street, Ste 204, Omaha, NE 68152
 402.455.7698 www.s3cp.com

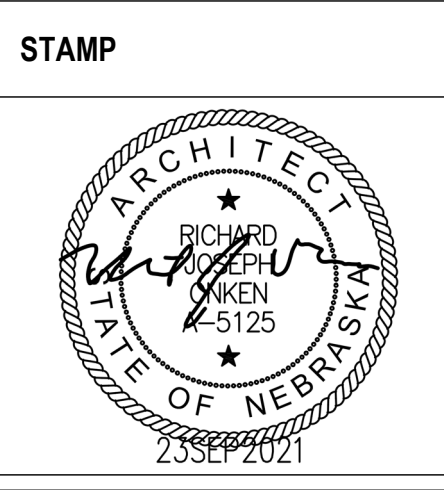

Office of Construction and Facilities Management

VA U.S. Department of Veterans Affairs


Drawing Title
BASEMENT - FLOOR PLAN

Approved: _____

Phase
BID DOCUMENTS

FULLY SPRINKLERED

Project Title Renovate and Repair Structural, Building 4	Project Number 589A7-21-108
Location Wichita, KS	Building Number 4
Issue Date 9/23/2021	Checked
Drawn TDW	Drawing Number A-101

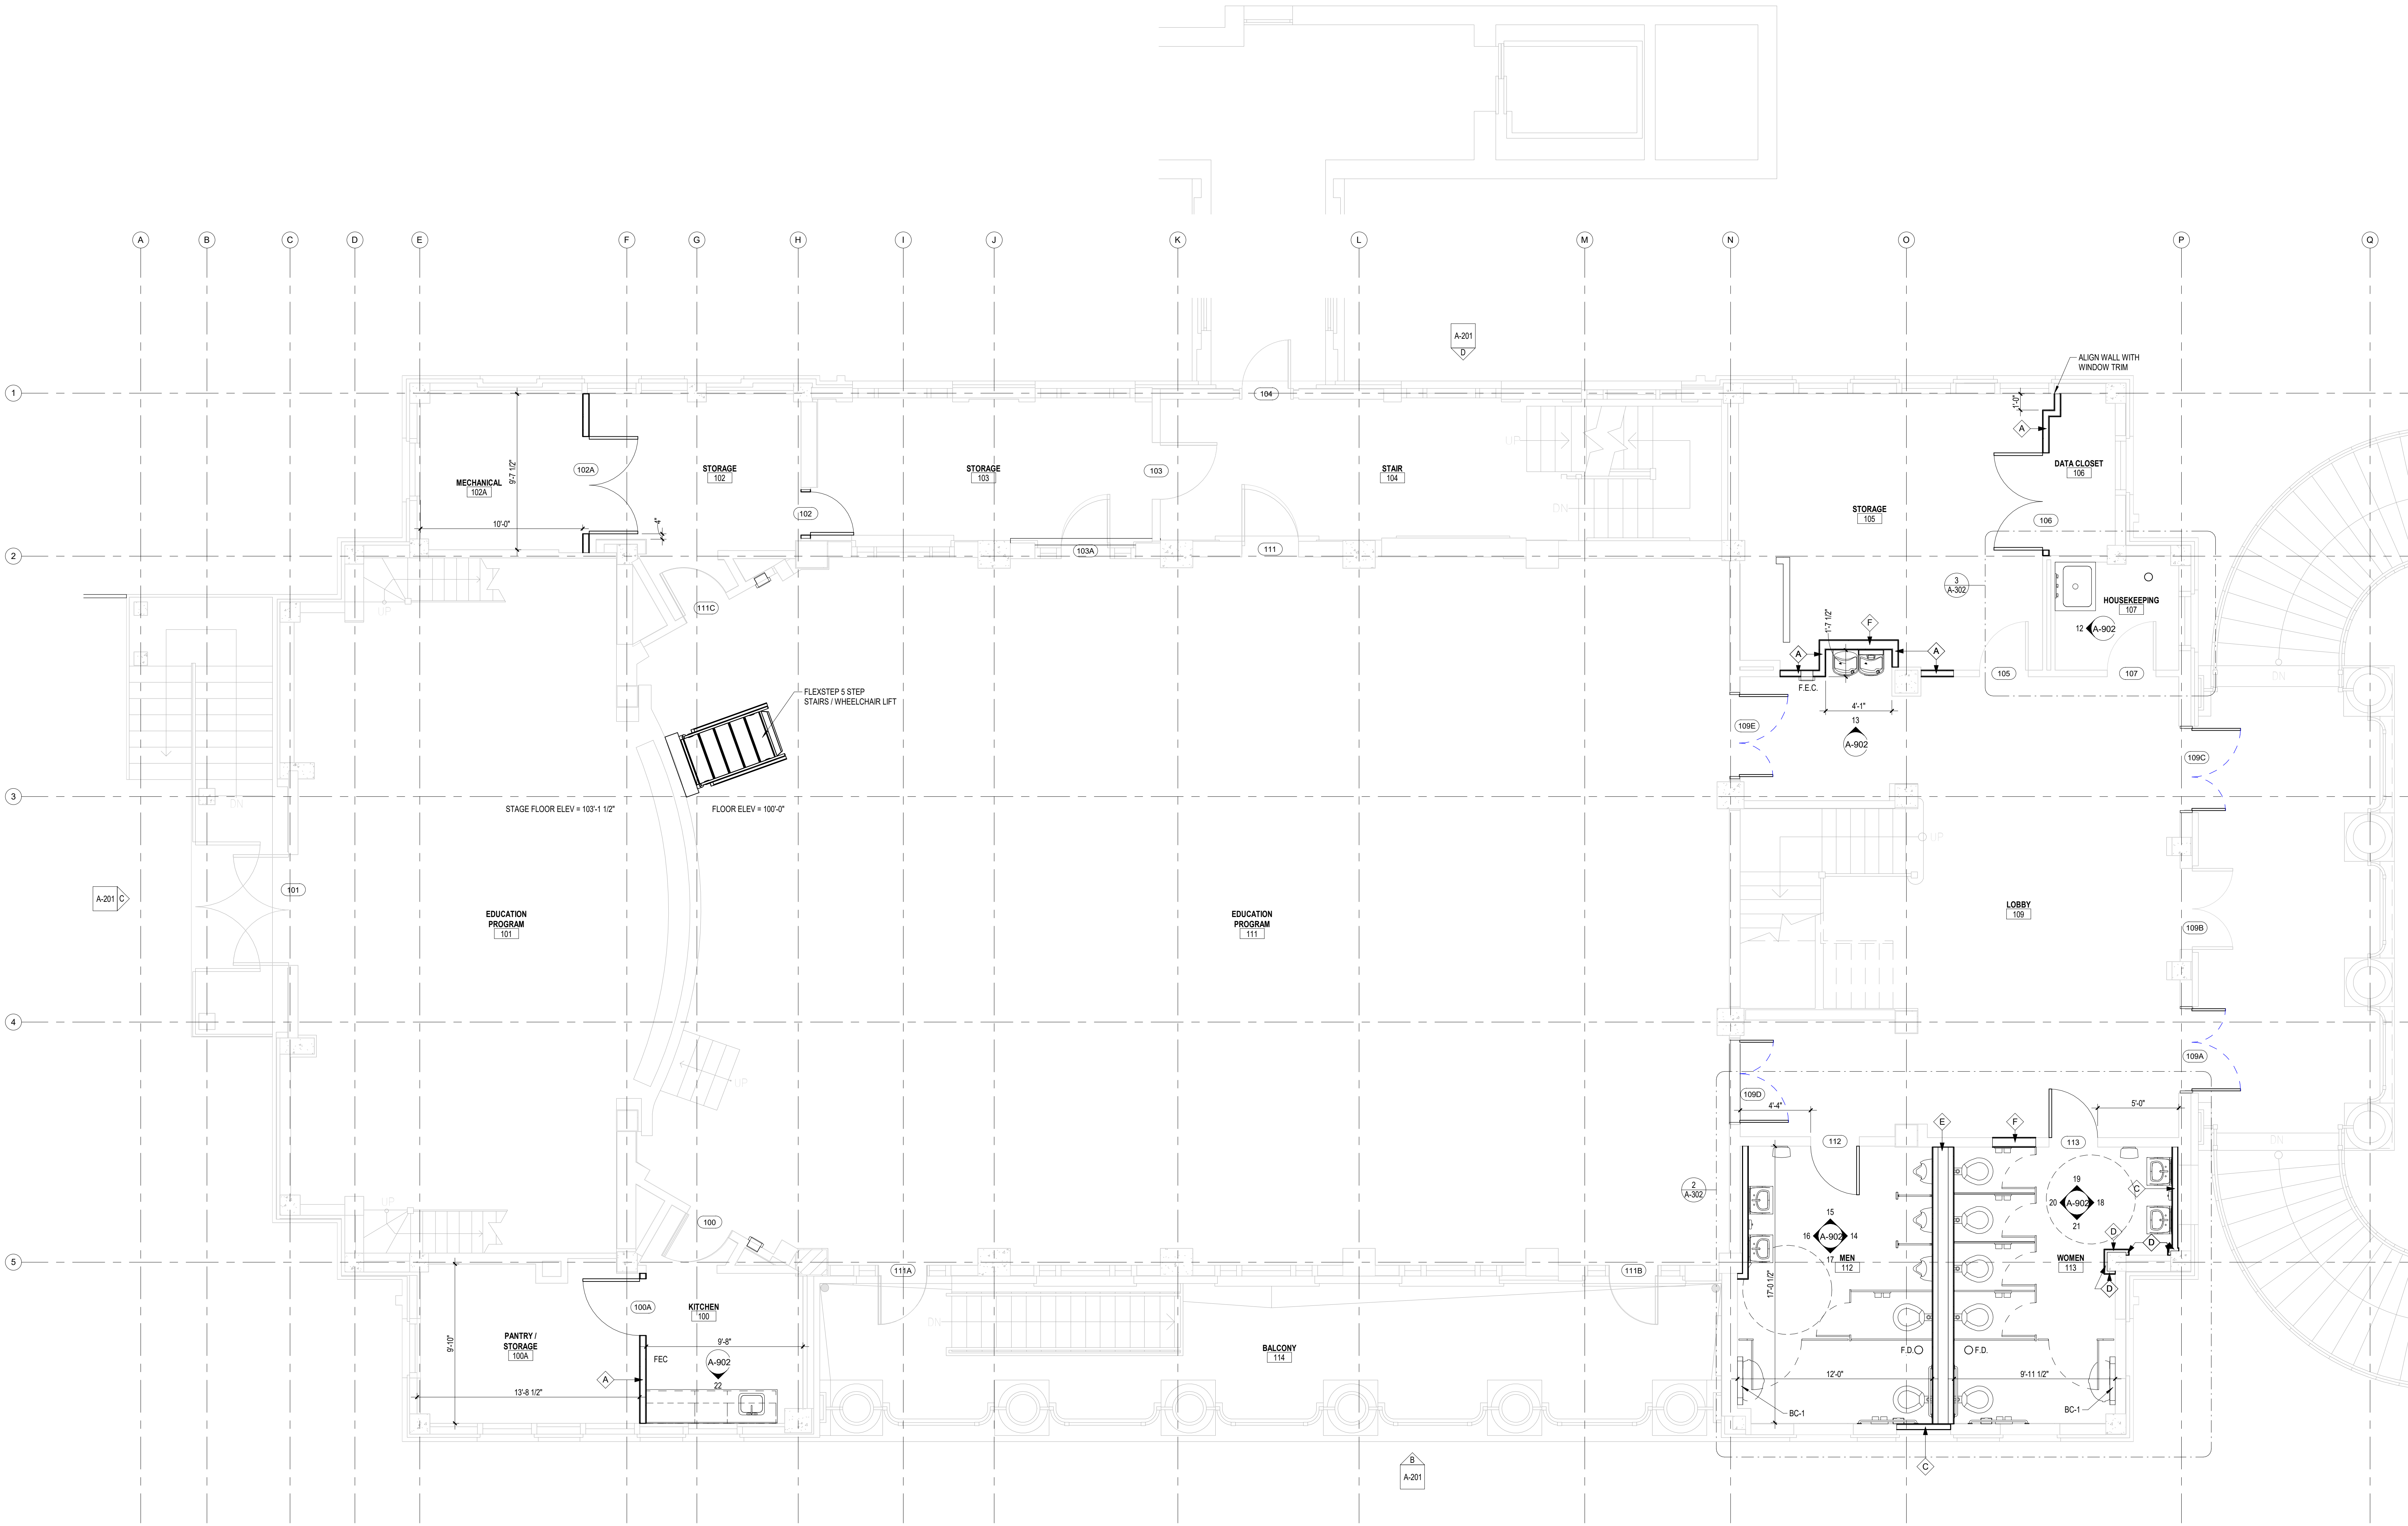

1 FIRST FLOOR
1/4" = 1'-0"


Revisions:	Date:

ARCHITECT/ENGINEER OF RECORD

ALESIA ARCHITECTURE
Alesia Architecture P.C.
3705 North 200th Street
Elkhorn, Nebraska 68022
Phone: 402.291.6941

IMEG Corp.
15 Sutterlin Drive,
Suite 104
St. Louis, MO 63143
Phone: (314) 951-2534

SHAFFER STEVENS SCHAAP STRUCTURAL ENGINEERS
9910 North 48th Street, Ste 204, Omaha, NE 68152
402.455.7698
www.s3pc.com

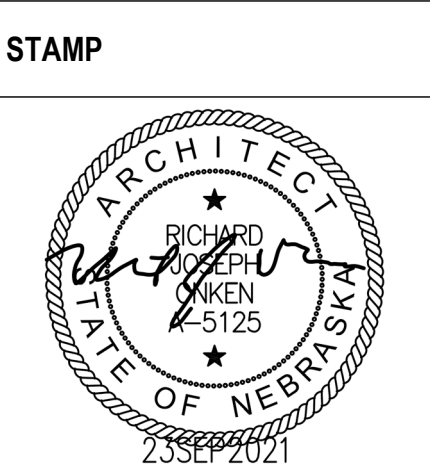

Office of Construction and Facilities Management

VA U.S. Department of Veterans Affairs

Drawing Title
FIRST FLOOR - FLOOR PLAN

Approved: _____

Phase
BID DOCUMENTS

FULLY SPRINKLERED

Project Title
Renovate and Repair Structural, Building 4

Location
Wichita, KS

Issue Date
9/23/2021


Checked
TDW

Drawn
KK

Project Number
589A7-21-108

Building Number
4

Drawing Number
A-102

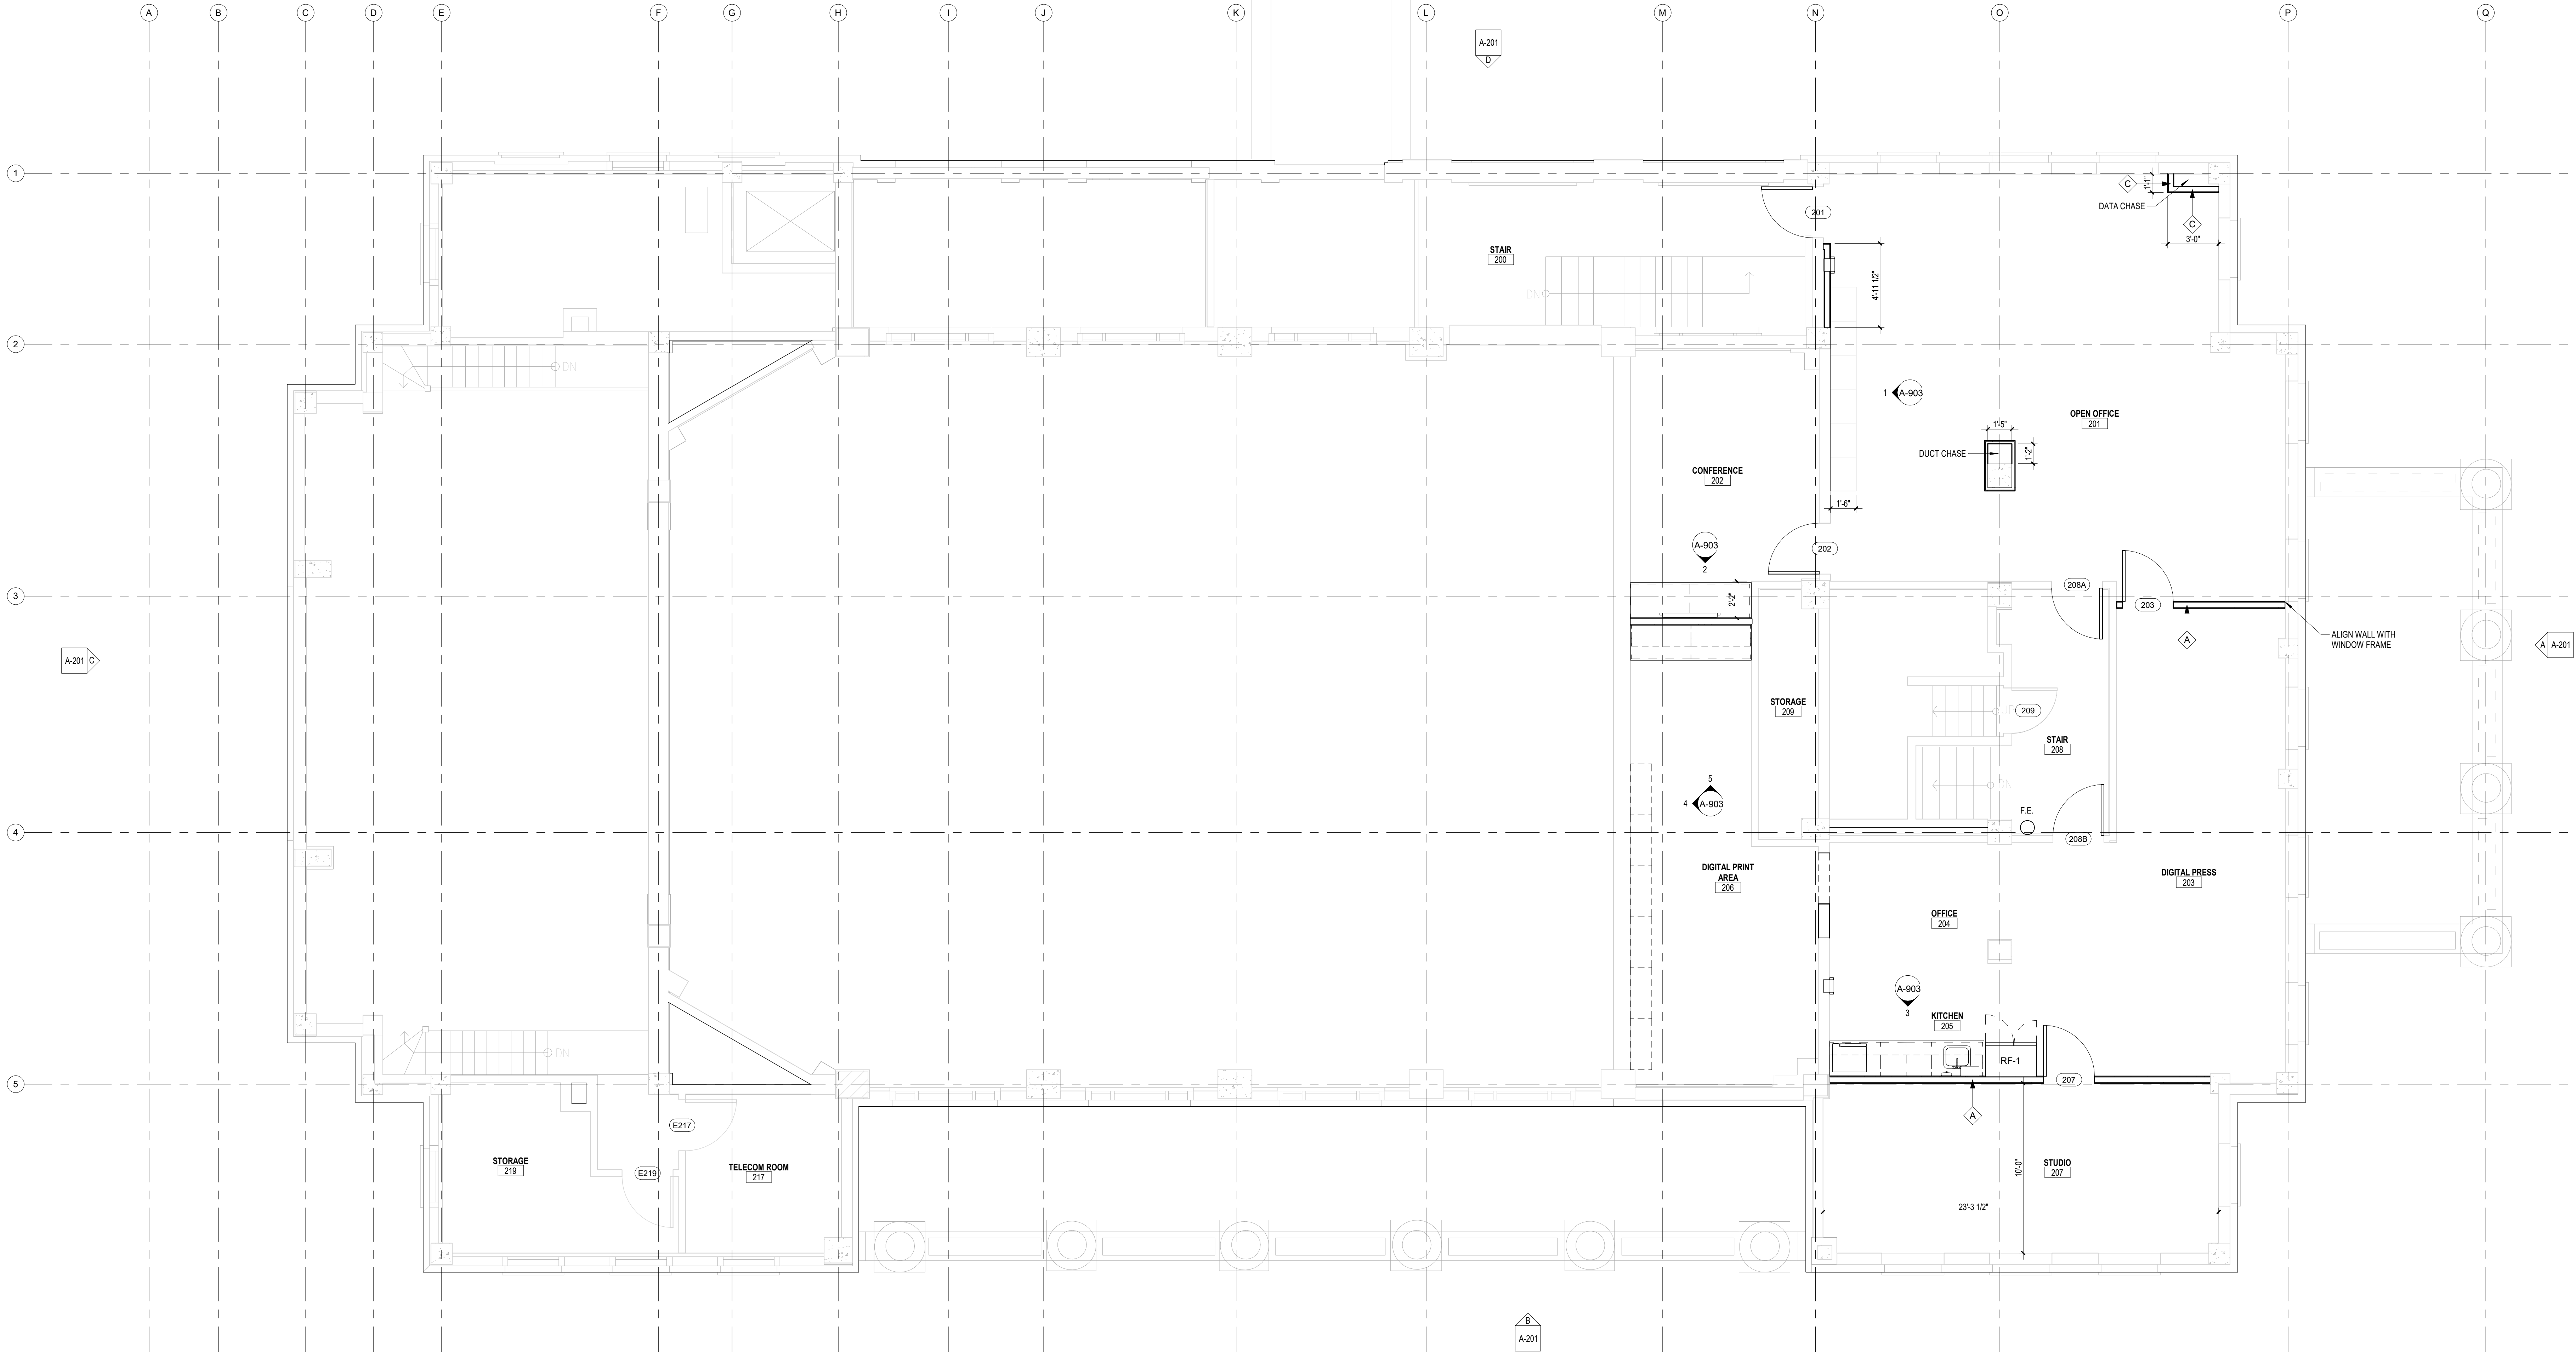

1 SECOND FLOOR
1/4" = 1'-0"

Revisions:	Date:

ARCHITECT/ENGINEER OF RECORD

ALESIA ARCHITECTURE
Alesia Architecture P.C.
3705 North 200th Street
Elkhorn, Nebraska 68022
Phone: 402.291.6941

IMEG Corp.
15 Sureson Drive,
Suite 104
St. Louis, MO 63143
Phone: (314) 951-2534

SHAFER STEVENS SCHAAP STRUCTURAL ENGINEERS
9910 North 48th Street, Ste 204, Omaha, NE 68152
402.455.7698 www.s3pc.com

STAMP

Richard Schaffer
7/28/2021

Office of Construction and Facilities Management

VA U.S. Department of Veterans Affairs

Drawing Title
SECOND FLOOR - FLOOR PLAN

Approved: _____

Phase
BID DOCUMENTS

FULLY SPRINKLERED

Project Title
Renovate and Repair Structural, Building 4

Location
Wichita, KS


Issue Date
9/23/2021

Checked _____
Drawn _____

Project Number
589A7-21-108

Building Number
4

Drawing Number
A-103

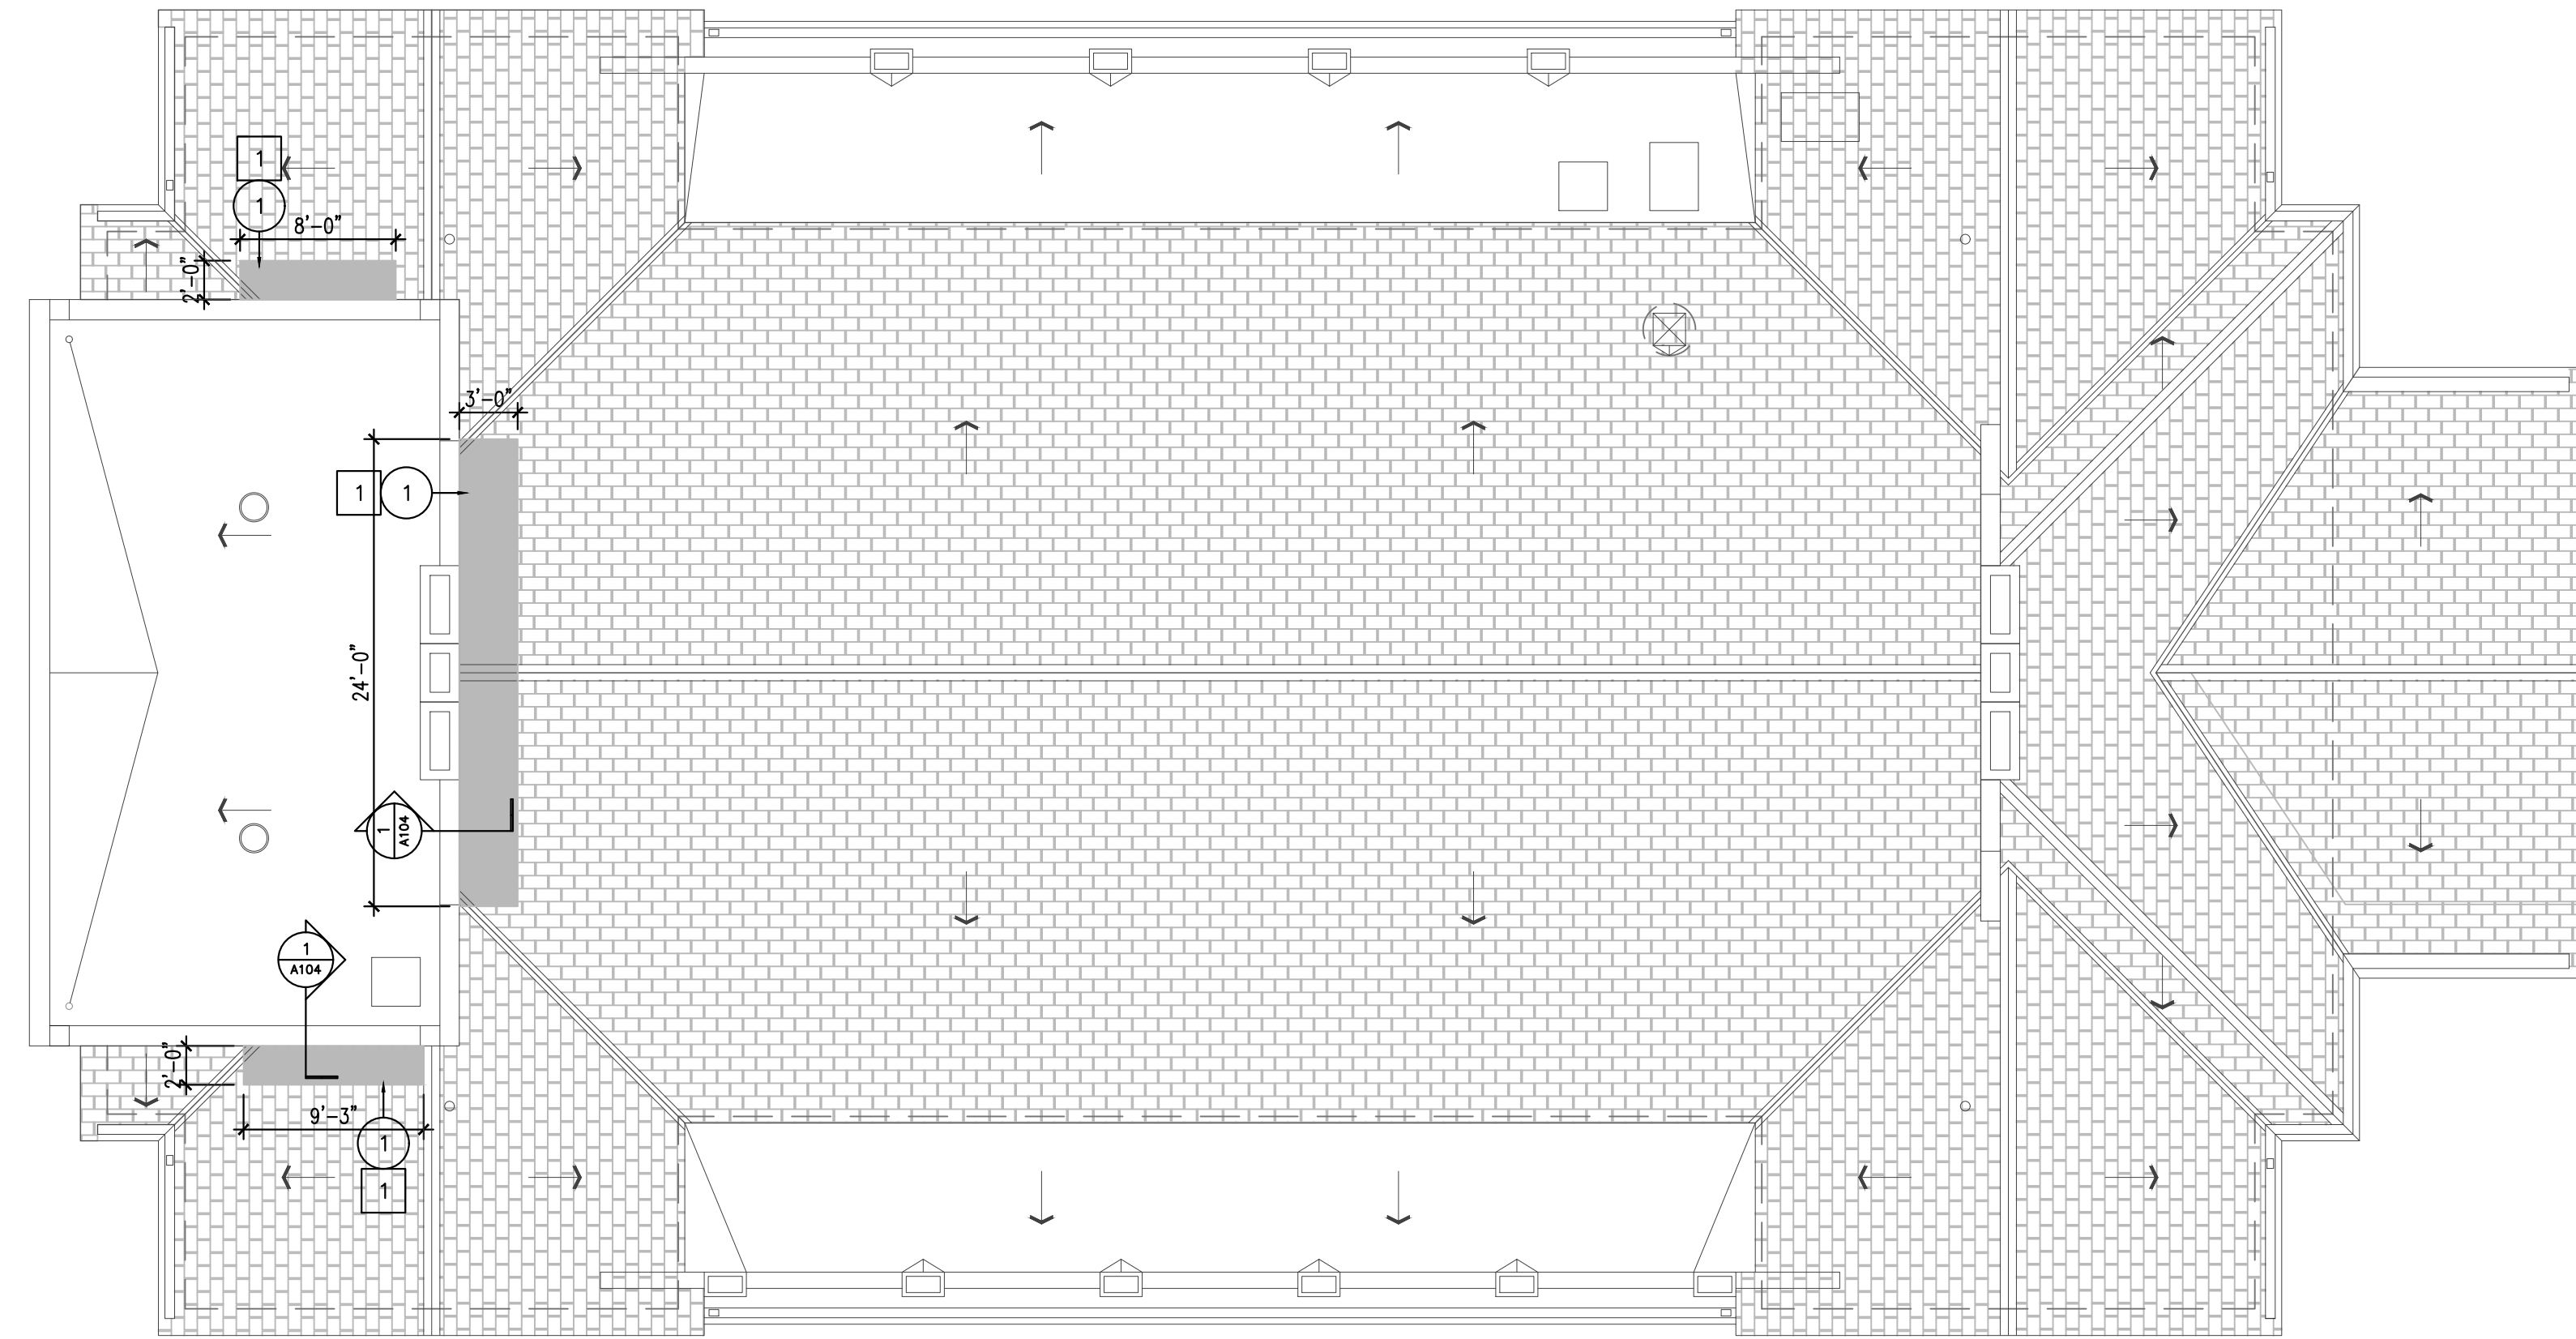

A ROOF PLAN
1/8" = 1'-0"
ROOF LEVEL

DEMOLITION NOTES

1. IN AREA SHOWN BY SHADING, REMOVE AND SALVAGE EXISTING CLAY TILE SHINGLES ON ROOF. REMOVE EXISTING ROOF UNDERLAYMENT AND ROOF DECK SHEATHING TO CLOSEST RAFTER OUTSIDE OF DAMAGED AREA AS SHOWN BY SHADING.

PLAN NOTES


1. INSTALL NEW 7/8" BCX PLYWOOD SHEATHING, NEW DOUBLE LAYER 30# ASPHALTIC FELT UNDERLAYMENT, AND NEW COPPER FLASHING AS PER DETAIL 1-4/A104 IN AREA AS SHOWN BY SHADING TO CLOSEST RAFTER OUTSIDE OF DAMAGE AREA. CONTRACTOR TO FIELD VERIFY RAFTER LOCATION. REINSTALL SALVAGED CLAY TILES BACK IN PLACE IN ACCORDANCE WITH MANUFACTURER'S INSTALLATION RECOMMENDATIONS, REF. SPECS.

GENERAL NOTES


1. PROTECT EXISTING ROOFTOP EQUIPMENT AND MATERIALS TO REMAIN DURING CONSTRUCTION.
2. PROTECT BUILDING SIDING, SIDEWALKS, LAWNS, ETC. DURING CONSTRUCTION.
3. PLANS ARE DIAGRAMMATIC IN NATURE AND ONLY REPRESENT ROOF TOP EQUIPMENT RELATIVE LOCATIONS THAT WERE PRESENT AT THE TIME OF SITE REVIEW. LOCATIONS ARE NOT EXACT AND SHALL BE FIELD VERIFIED BY CONTRACTOR PRIOR TO DEMOLITION OR REROOFING WORK.
4. UNDOCUMENTED MISCELLANEOUS ROOF TOP ITEMS SHALL BE FIELD VERIFIED BY CONTRACTOR AND ROOFING WORK AROUND SUCH ITEMS SHALL BE PART OF SCOPE FOR COMPLETE AND WEATHER TIGHT PROJECT.
5. AFTER REMOVAL OF EXISTING ROOFING MATERIALS, CONTRACTOR SHALL VERIFY AND CORRECT CONDITIONS OF EXISTING DECK OR SUBSTRATE.
6. REMOVE EXISTING AND REPLACE BOOTS, PITCH PANS, AND OTHER PIPE FLASHING PIECES AT PLUMBING AND CONDUIT PIPE PENETRATIONS.
7. MAINTAIN, PROTECT, AND RESET EXISTING METAL CURB FLASHING AND OTHER METAL OR ALUMINUM FLASHINGS FOR REUSE, UNLESS OTHERWISE NOTED.
8. FIELD VERIFY ALL DIMENSIONS.
9. EXISTING SHINGLE ROOF PITCHES ARE 9:12.

LEGEND

-
-

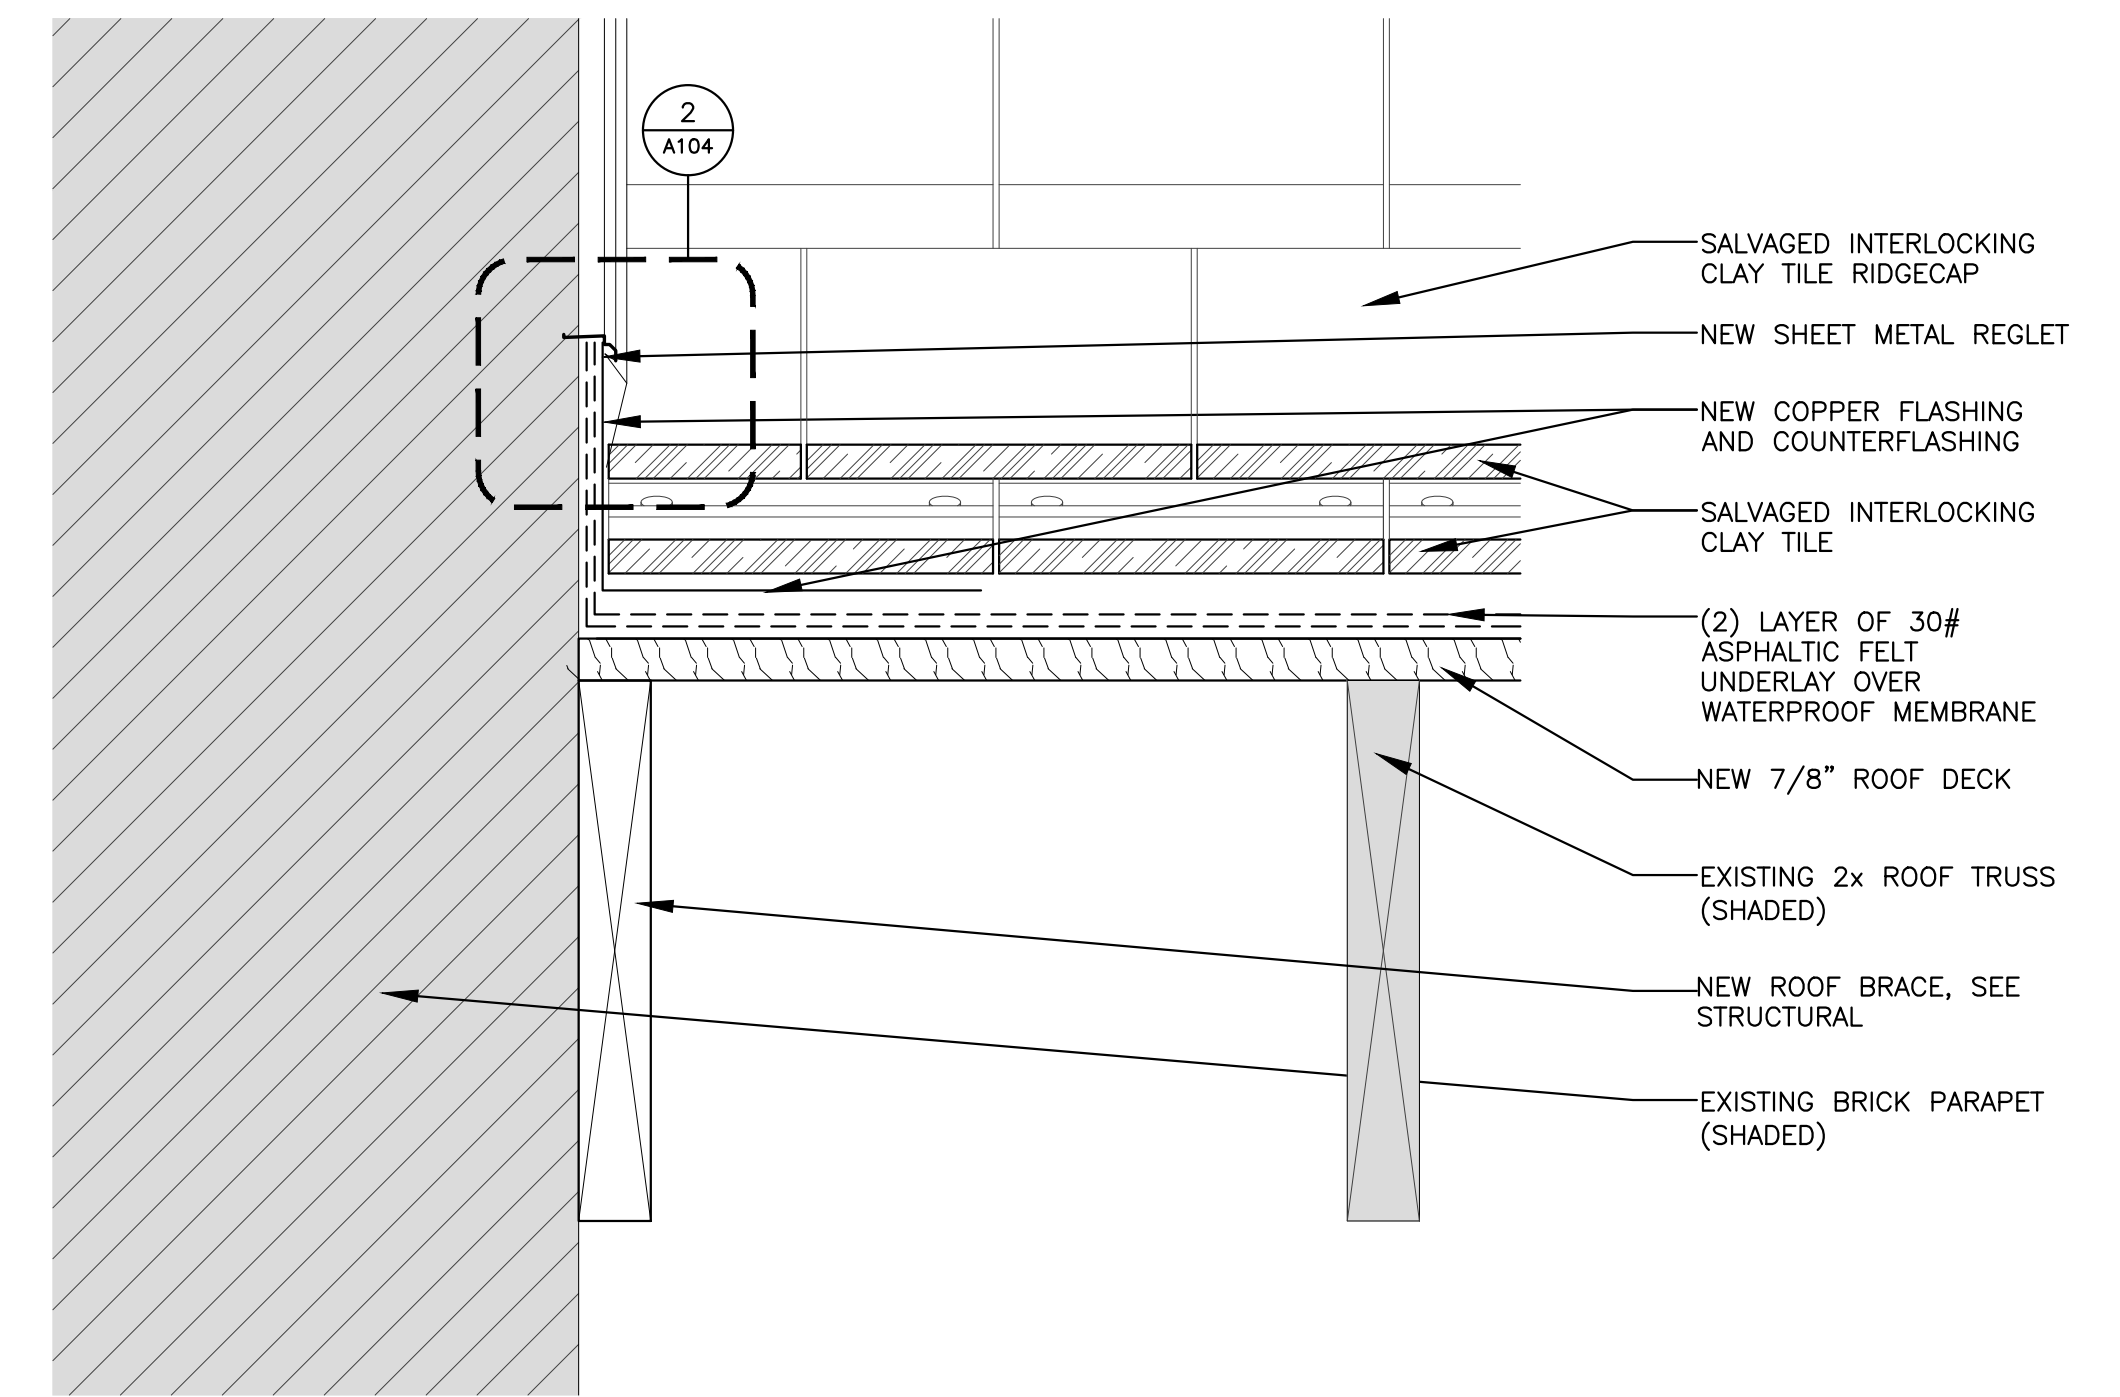

1 ROOF DETAIL
3" = 1'-0"

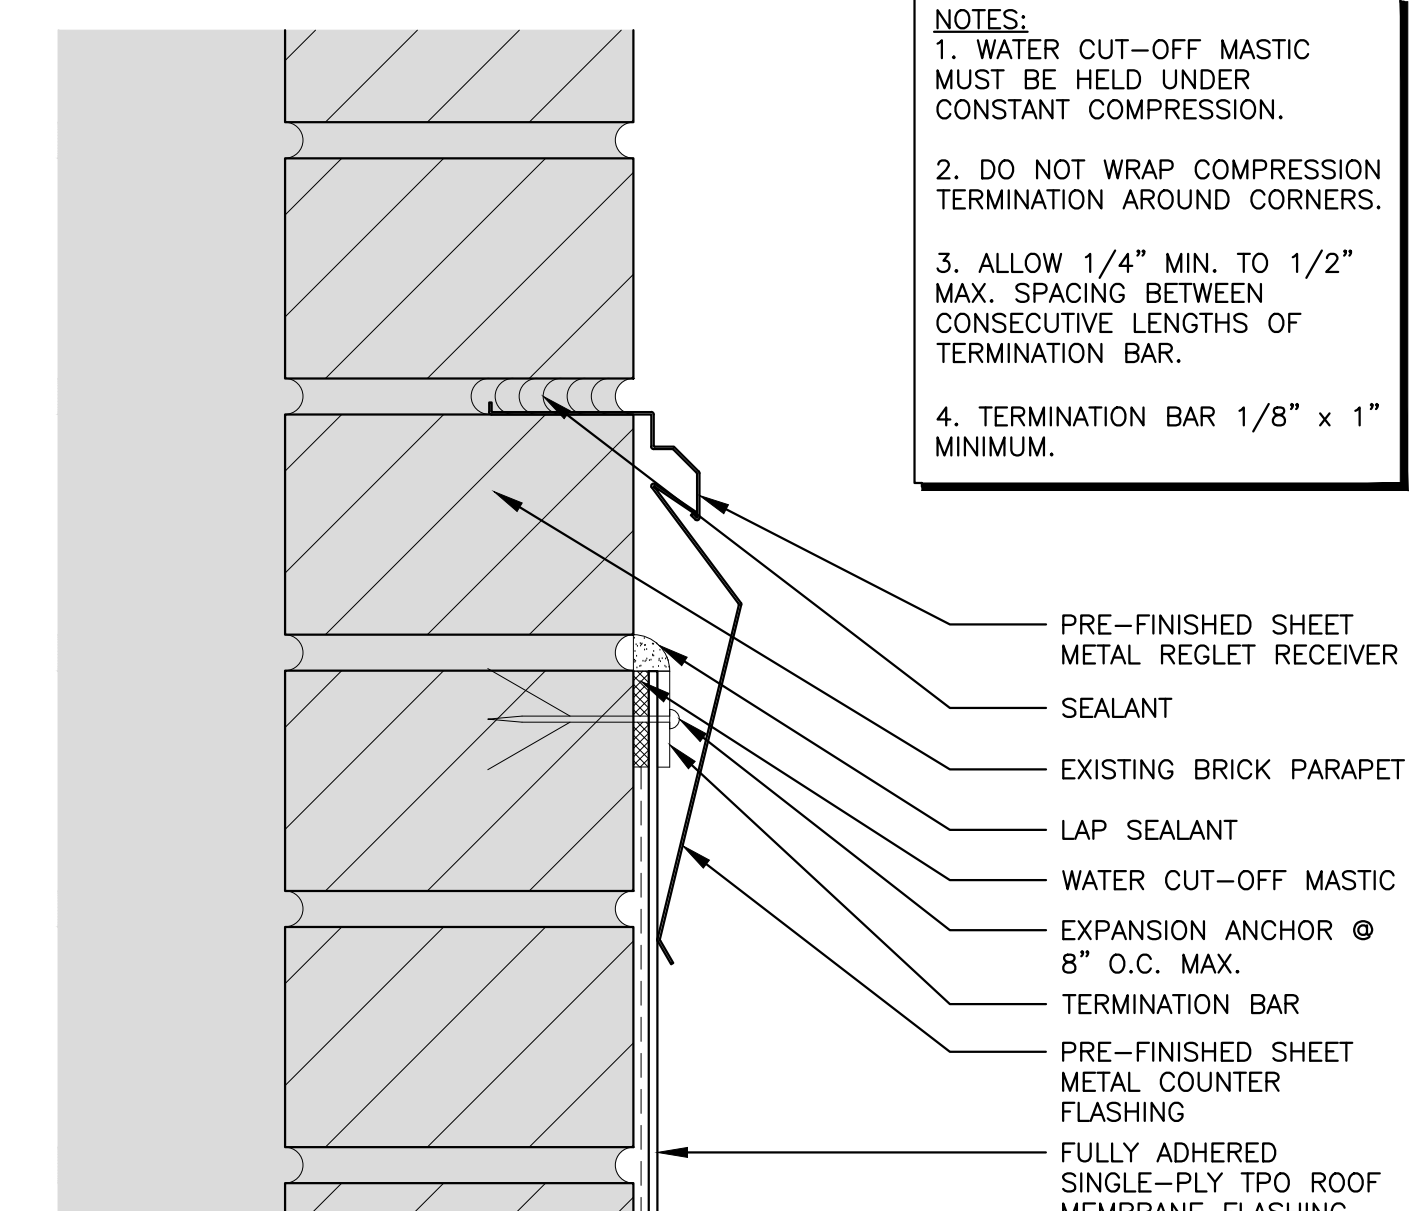

- NOTES:**
1. WATER CUT-OFF MASTIC MUST BE HELD UNDER CONSTANT COMPRESSION.
 2. DO NOT WRAP COMPRESSION TERMINATION AROUND CORNERS.
 3. ALLOW 1/4" MIN. TO 1/2" MAX. SPACING BETWEEN CONSECUTIVE LENGTHS OF TERMINATION BAR.
 4. TERMINATION BAR 1/8" x 1" MINIMUM.

2 MEMBRANE TERMINATION
6" = 1'-0"

6/14/2009 12:38:03 PM

E


F

Revisions:	Date:

ARCHITECT/ENGINEER OF RECORD

3705 North 200th Street
Elkhorn, Nebraska 68022
Phone: 402.291.6941

165 S. Rock Island Suite 200
Wichita, KS 67202
(316) 634-1111

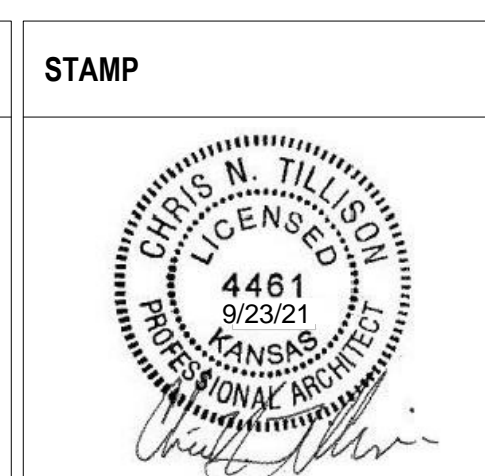

Office of Construction and Facilities Management
VA U.S. Department of Veterans Affairs

Drawing Title	Phase
ROOF PLAN	BID DOCUMENTS
Approved: Project Director	FULLY SPRINKLERED

Project Title	Location
Renovate and Repair Structural, Building 4	Wichita, KS
Issue Date	Checked
9/23/21	CNT
Drawn	RAG

Project Number	589A7-21-108
Building Number	4
Drawing Number	A-104


EQUIPMENT / FINISH / SIGNAGE LEGEND

SIGN ID NUMBER ← 000

EQUIPMENT ID NUMBER ← XXX-0

FLOOR PATTERN DIRECTION ← XXX-0 →

SEE SHEET A-801 FOR SIGN / EQUIPMENT SCHEDULES

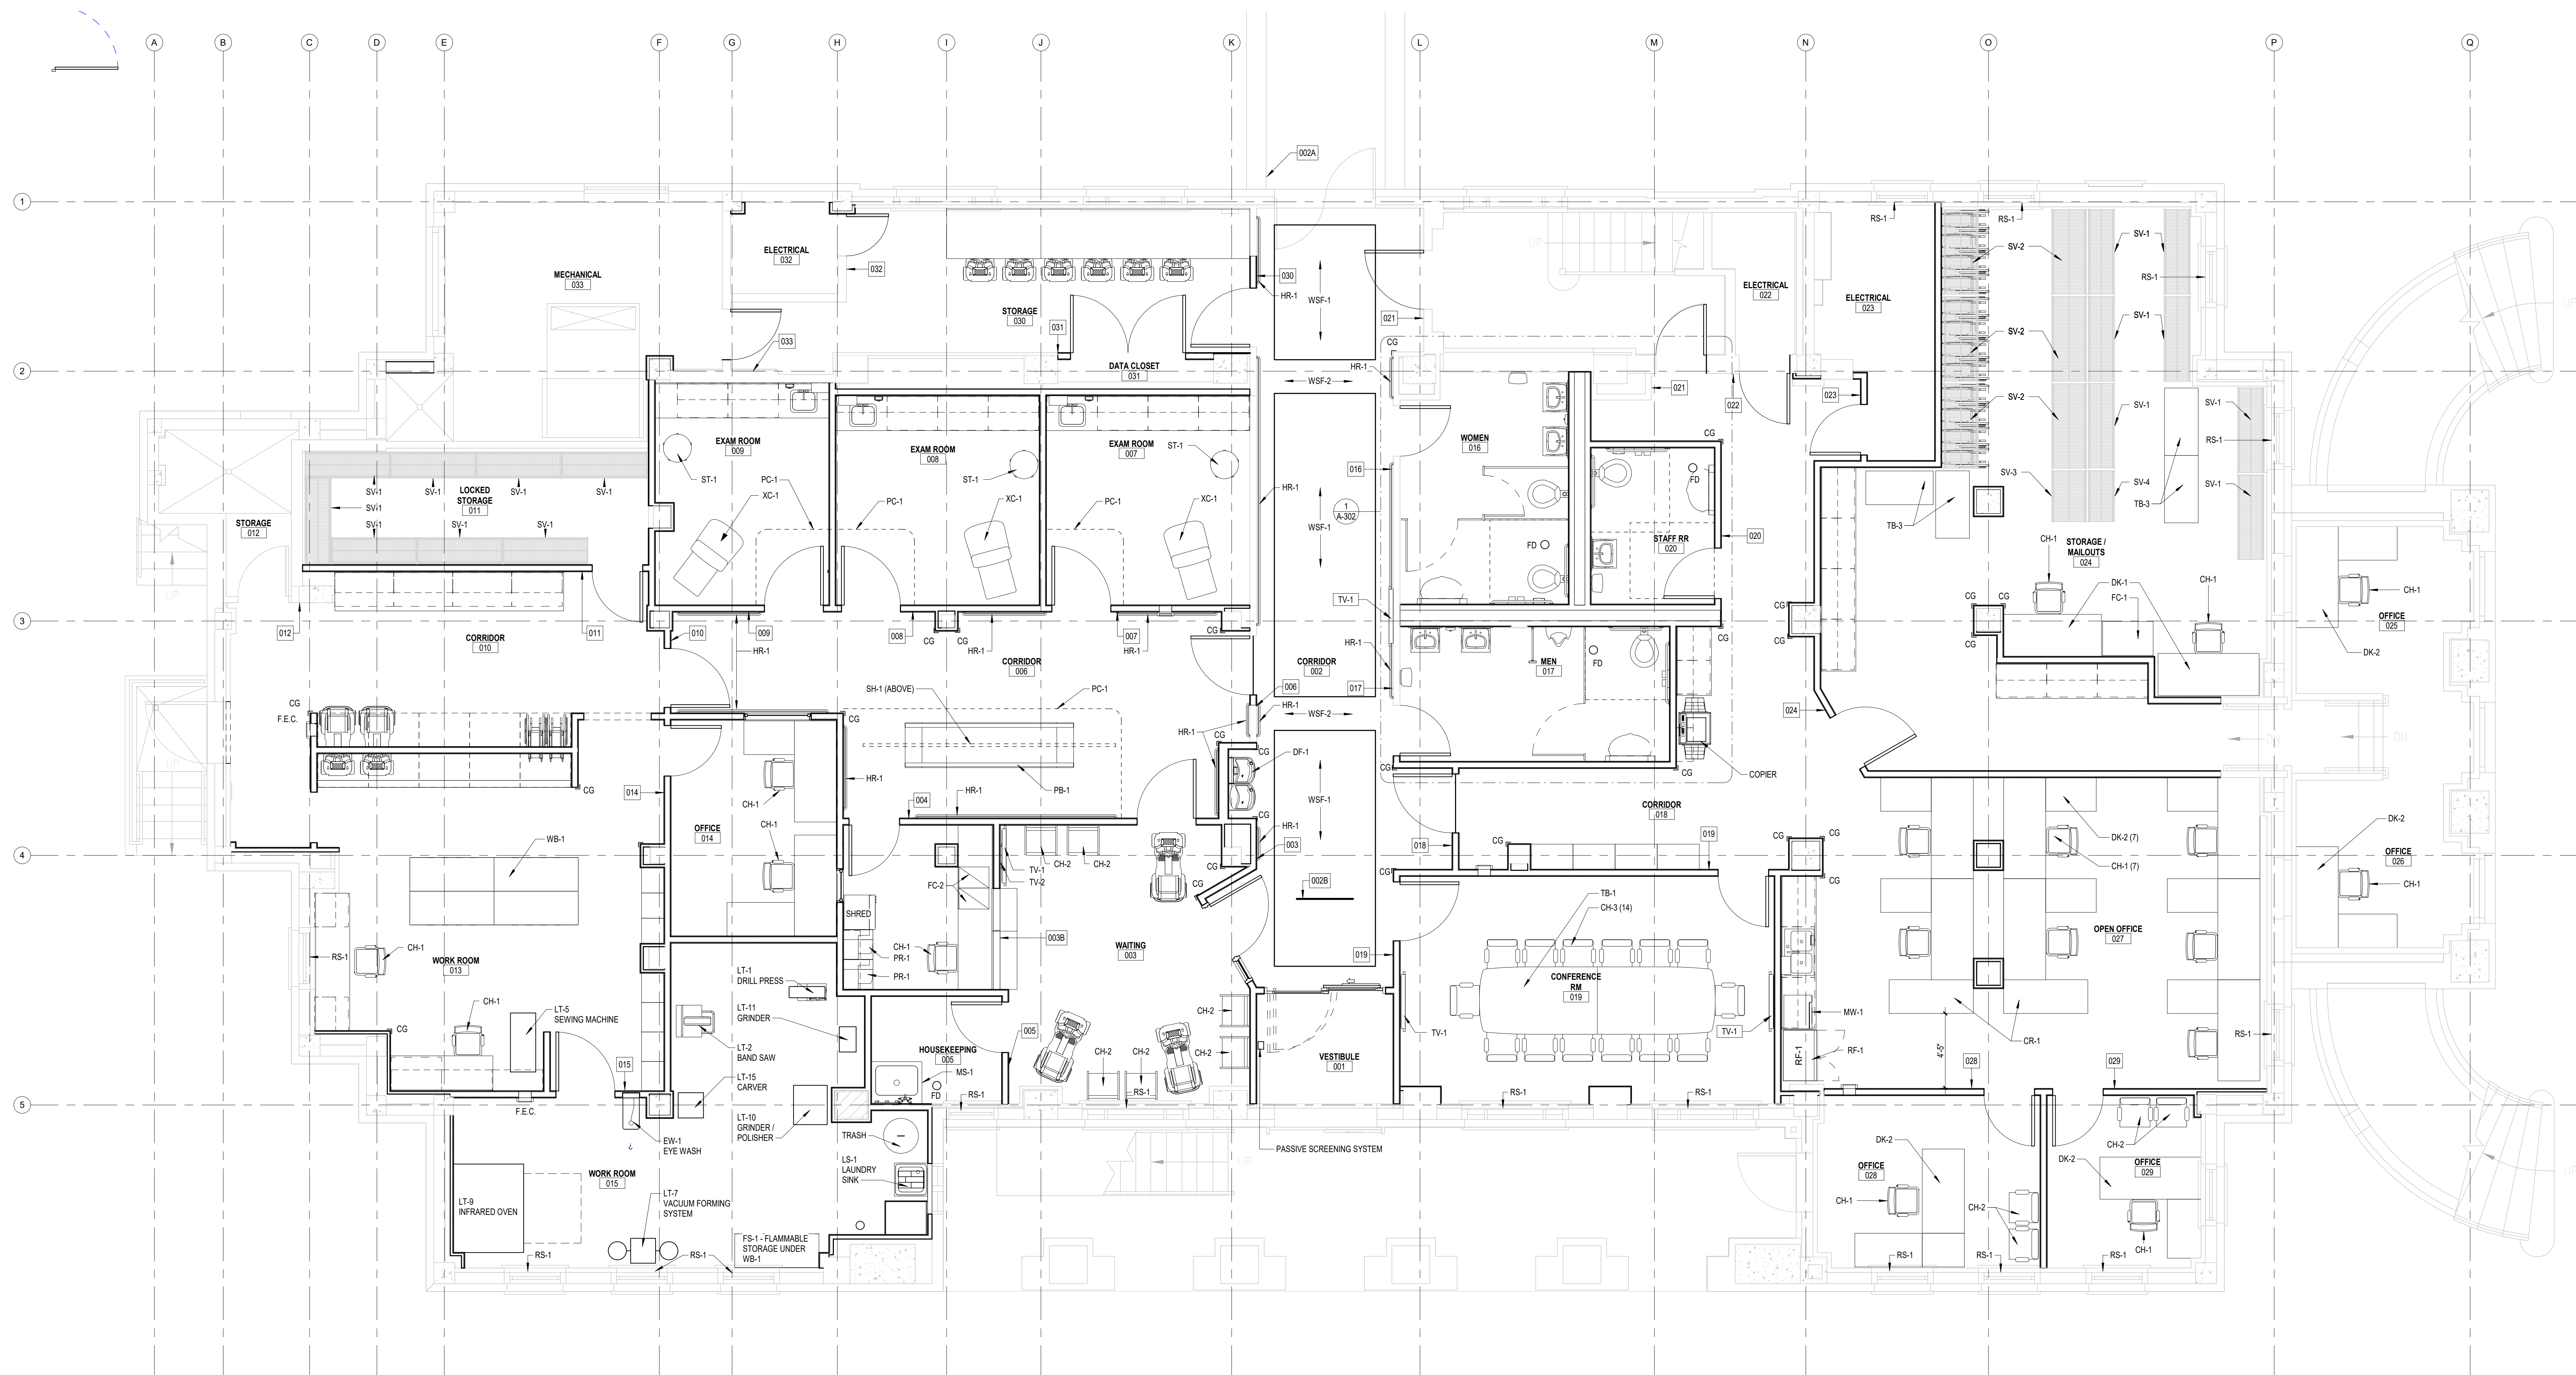

1 BASEMENT EQUIPMENT
1/4" = 1'-0"


9/23/2021 9:46:47 PM
9/23/2021 10:58:42:1-108 - Renovate and Repair Structural Building 4/21-102/103.rvt

Revisions:	Date:

ARCHITECT/ENGINEER OF RECORD

ALESIA ARCHITECTURE
Alesia Architecture P.C.
3705 North 200th Street
Elkhorn, Nebraska 68022
Phone: 402.291.6941

IMEG S3
SHAFER STEVENS SCHAAP
STRUCTURAL ENGINEERS
IMEG Corp.
15 Sutterlin Drive,
Suite 104
St. Louis, MO 63143
Phone: (314) 951-2534

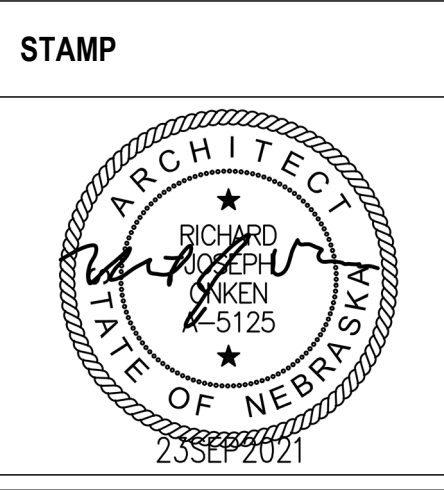

Office of
Construction
and Facilities
Management

VA U.S. Department
of Veterans
Affairs

Drawing Title
BASEMENT - EQUIPMENT PLAN

Approved:

Phase
BID DOCUMENTS

FULLY SPRINKLERED

Project Title
Renovate and Repair Structural,
Building 4

Location
Wichita, KS

Issue Date
9/23/2021

Checked

Drawn

Project Number
589A7-21-108

Building Number
4

Drawing Number
Q-101


EQUIPMENT / FINISH / SIGNAGE LEGEND

SIGN ID NUMBER — 000

EQUIPMENT ID NUMBER — XX-0

FLOOR PATTERN DIRECTION — XXX-0 —

SEE SHEET A-801 FOR SIGN / EQUIPMENT SCHEDULES

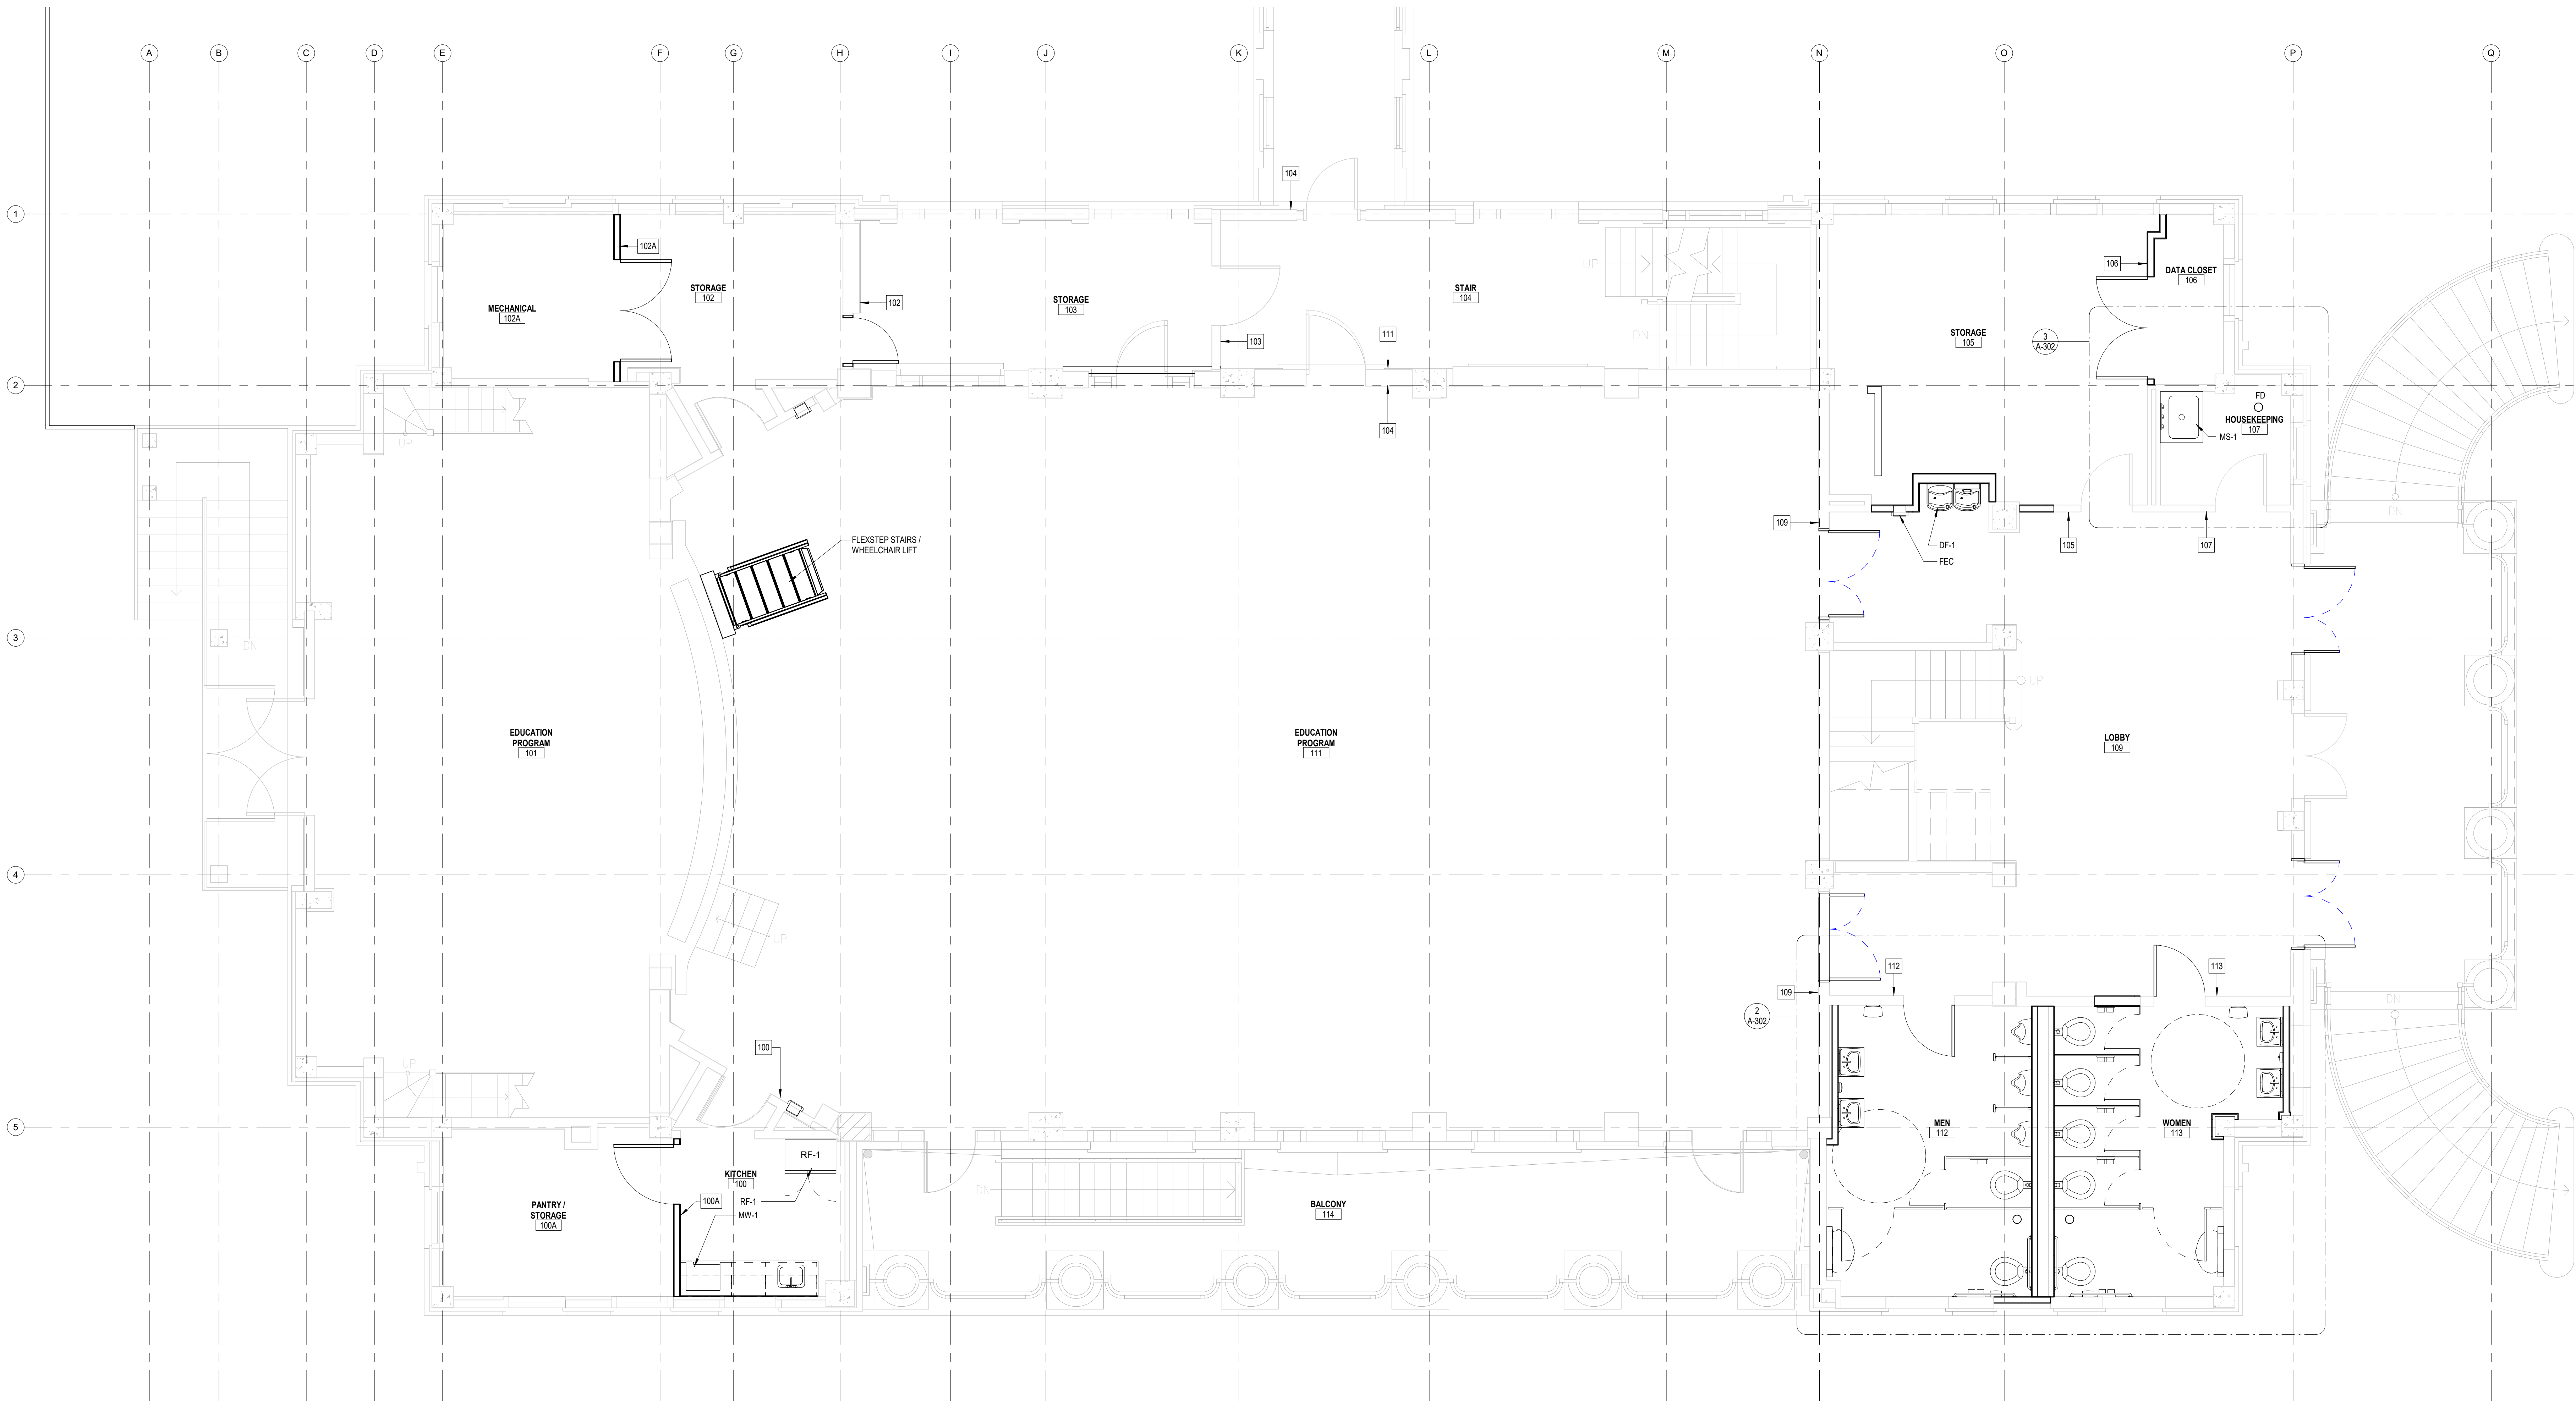

1 FIRST FLOOR EQUIPMENT
1/4" = 1'-0"

9/23/2021 9:48:49 PM
 BIM 360://2021-03-589A7-21-108 - Renovate and Repair Structural Building 4/R21-102/103.rvt


Revisions:	Date:

ARCHITECT/ENGINEER OF RECORD

ALESIA ARCHITECTURE
 Alesia Architecture P.C.
 3705 North 200th Street
 Elkhorn, Nebraska 68022
 Phone: 402.291.6941

IMEG Corp.
 15 Sunbeam Drive,
 Suite 104
 St. Louis, MO 63143
 Phone: (314) 951-2534

SHAFFER STEVENS SCHAAP STRUCTURAL ENGINEERS
 9910 North 48th Street, Ste 204, Omaha, NE 68152
 402.455.7698 www.s3pc.com

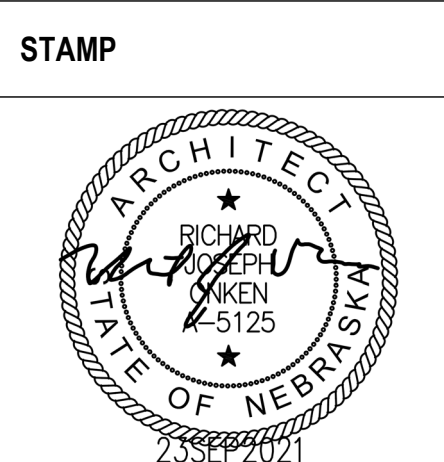

Office of Construction and Facilities Management

VA U.S. Department of Veterans Affairs

Drawing Title	FIRST FLOOR - EQUIPMENT PLAN
Approved:	

Phase	BID DOCUMENTS
	FULLY SPRINKLERED

Project Title	Renovate and Repair Structural, Building 4	
Location	Wichita, KS	
Issue Date	Checked	Drawn
9/23/2021		

Project Number	589A7-21-108
Building Number	4
Drawing Number	Q-102


EQUIPMENT / FINISH / SIGNAGE LEGEND

SIGN ID NUMBER ← 000

EQUIPMENT ID NUMBER ← XX-0

FLOOR PATTERN DIRECTION ← XXX-0

SEE SHEET A-801 FOR SIGN / EQUIPMENT SCHEDULES

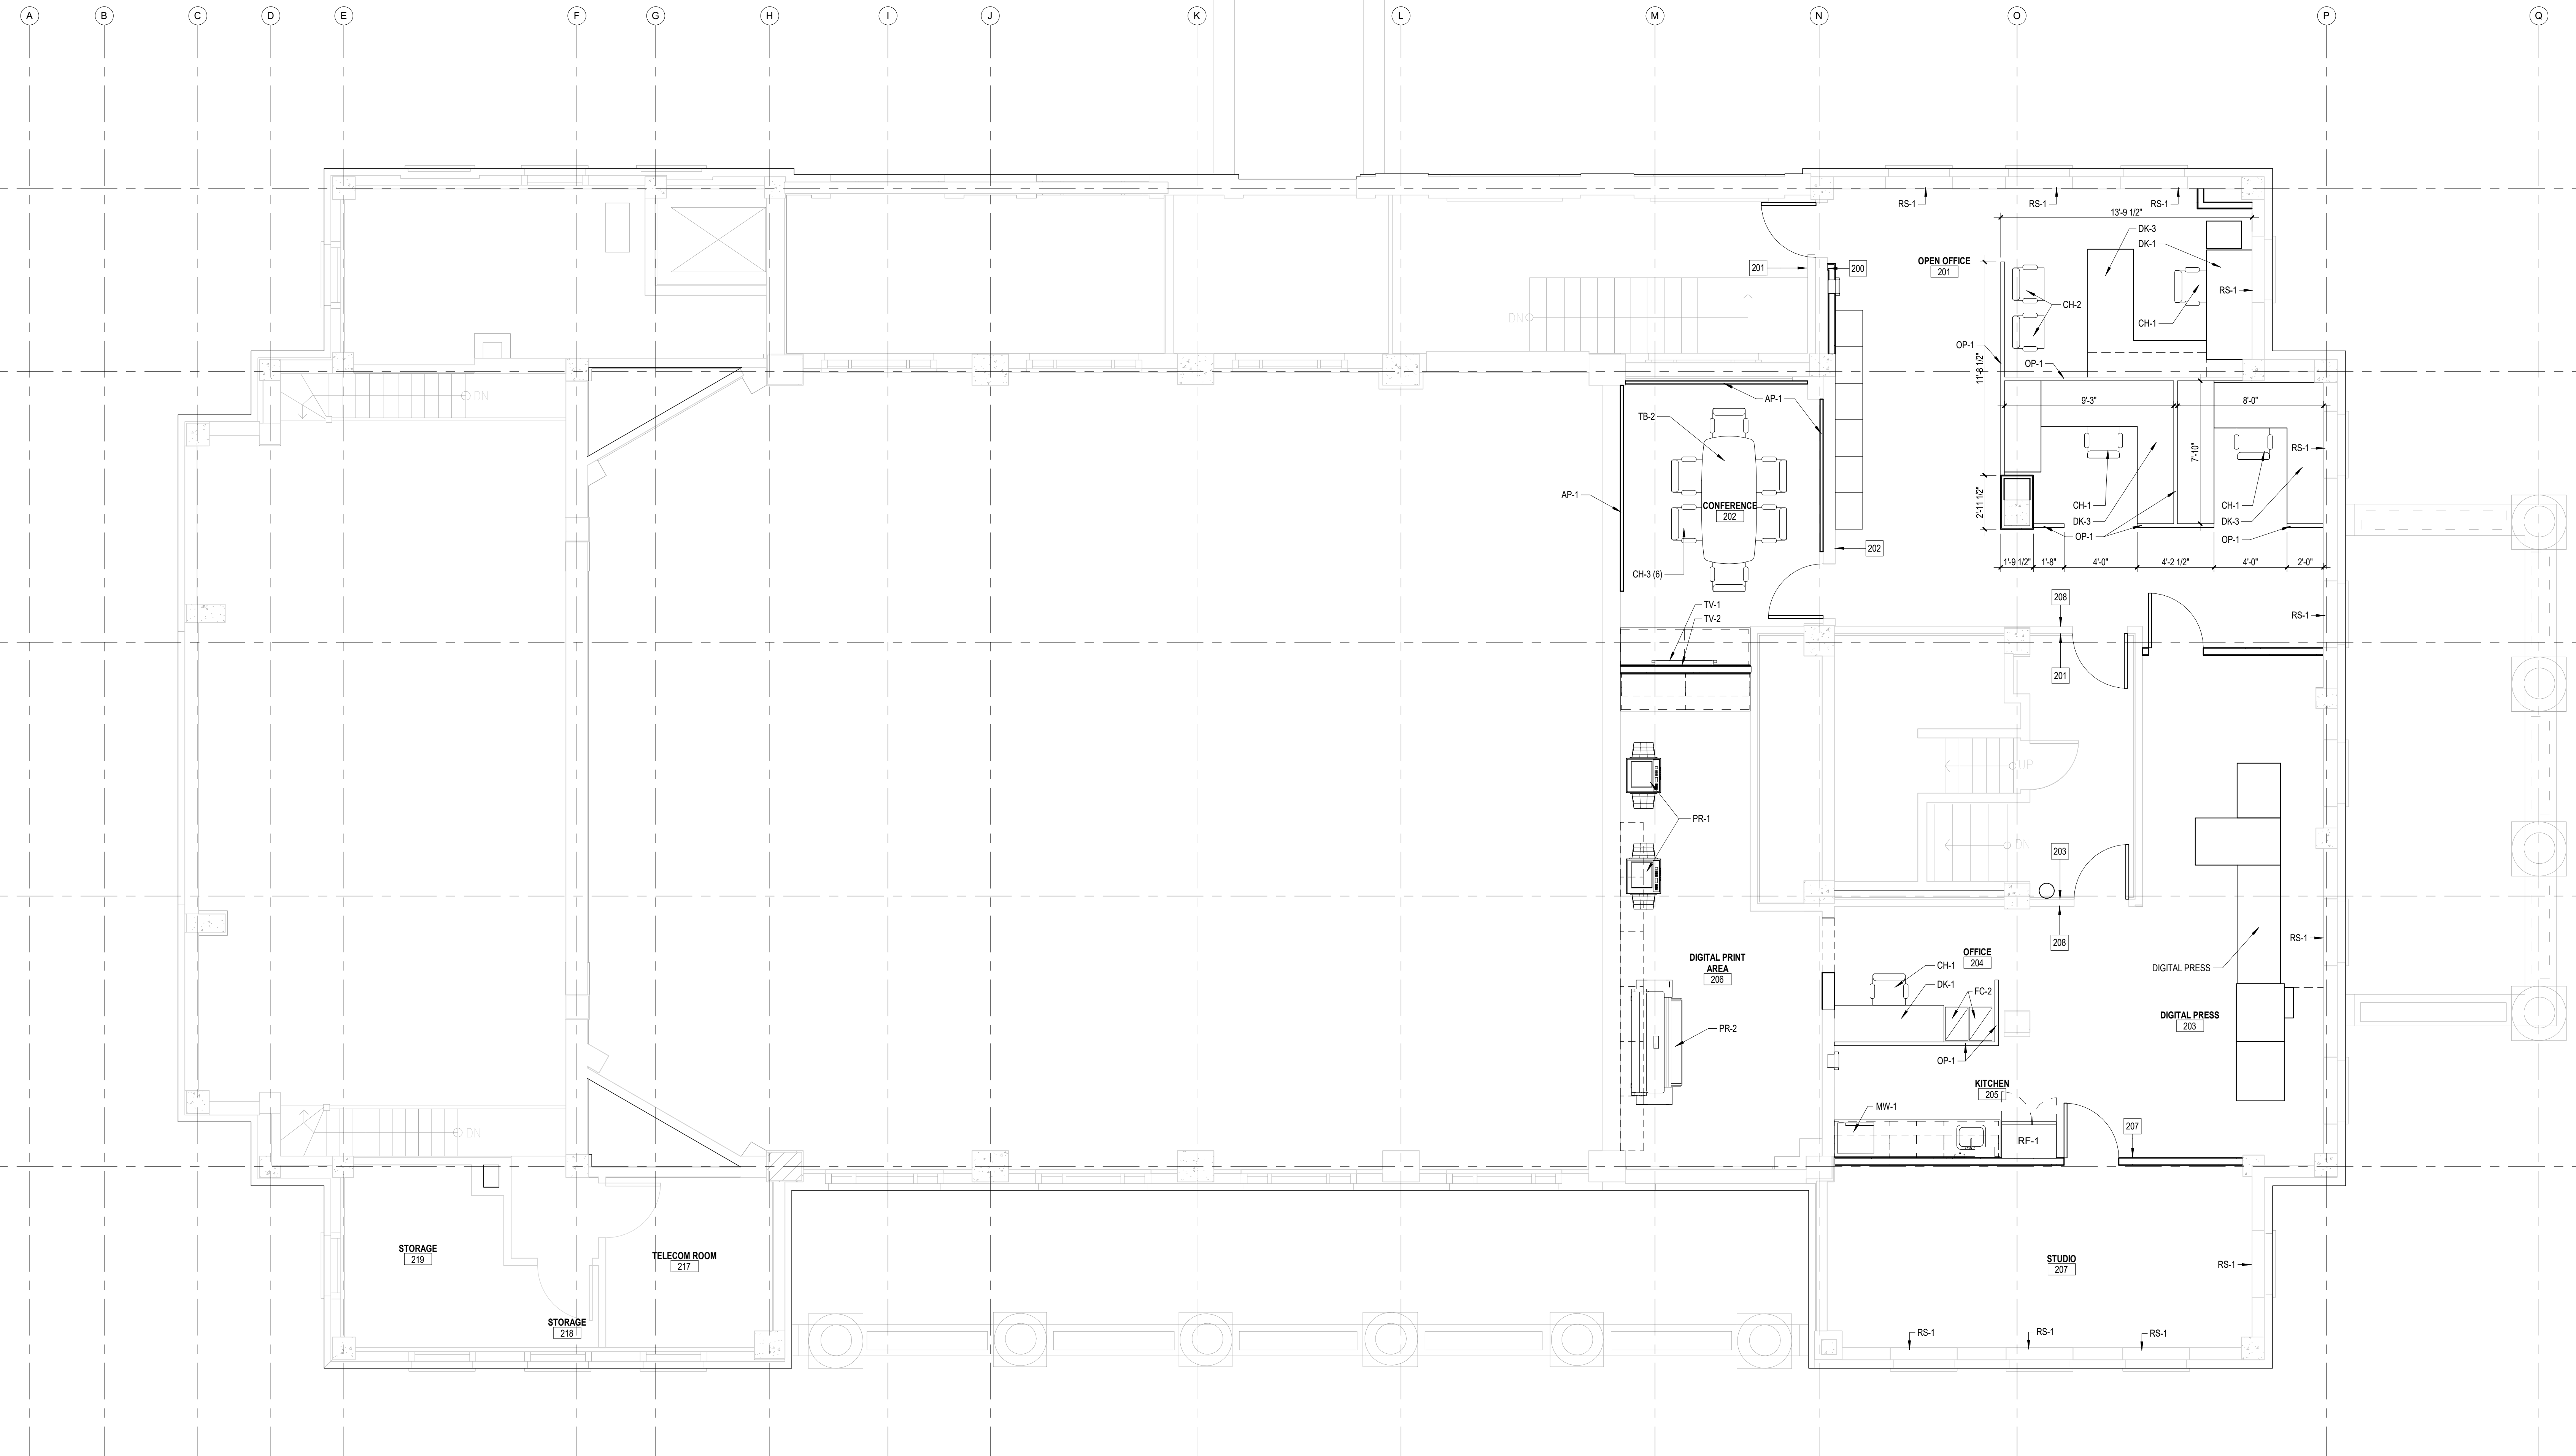

1 SECOND FLOOR EQUIPMENT
1/4" = 1'-0"

9/23/2021 9:46:58 PM
 BIM 360://21-103 589A7-21-103 - Renovate and Repair Structural Building 4/R21-103/103.rvt


Revisions:	Date:

ARCHITECT/ENGINEER OF RECORD

ALESIA ARCHITECTURE
 Alesia Architecture P.C.
 3705 North 200th Street
 Elkhorn, Nebraska 68022
 Phone: 402.291.6941

IMEG Corp.
 15 Sureson Drive,
 Suite 104
 St. Louis, MO 63143
 Phone: (314) 951-2534

SHAFER STEVENS SCHAAP STRUCTURAL ENGINEERS
 9910 North 48th Street, Ste 204, Omaha, NE 68152
 402.455.7698 www.s3pc.com

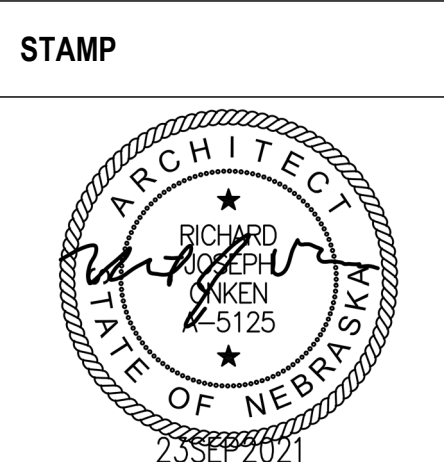

Office of Construction and Facilities Management
 VA U.S. Department of Veterans Affairs

Drawing Title
SECOND FLOOR - EQUIPMENT PLAN

Approved:

Phase
BID DOCUMENTS

FULLY SPRINKLERED

Project Title
Renovate and Repair Structural, Building 4

Location
Wichita, KS

Issue Date
9/23/2021

Checked


Drawn

Project Number
589A7-21-108


Building Number
4

Drawing Number
Q-103


A B C D E F

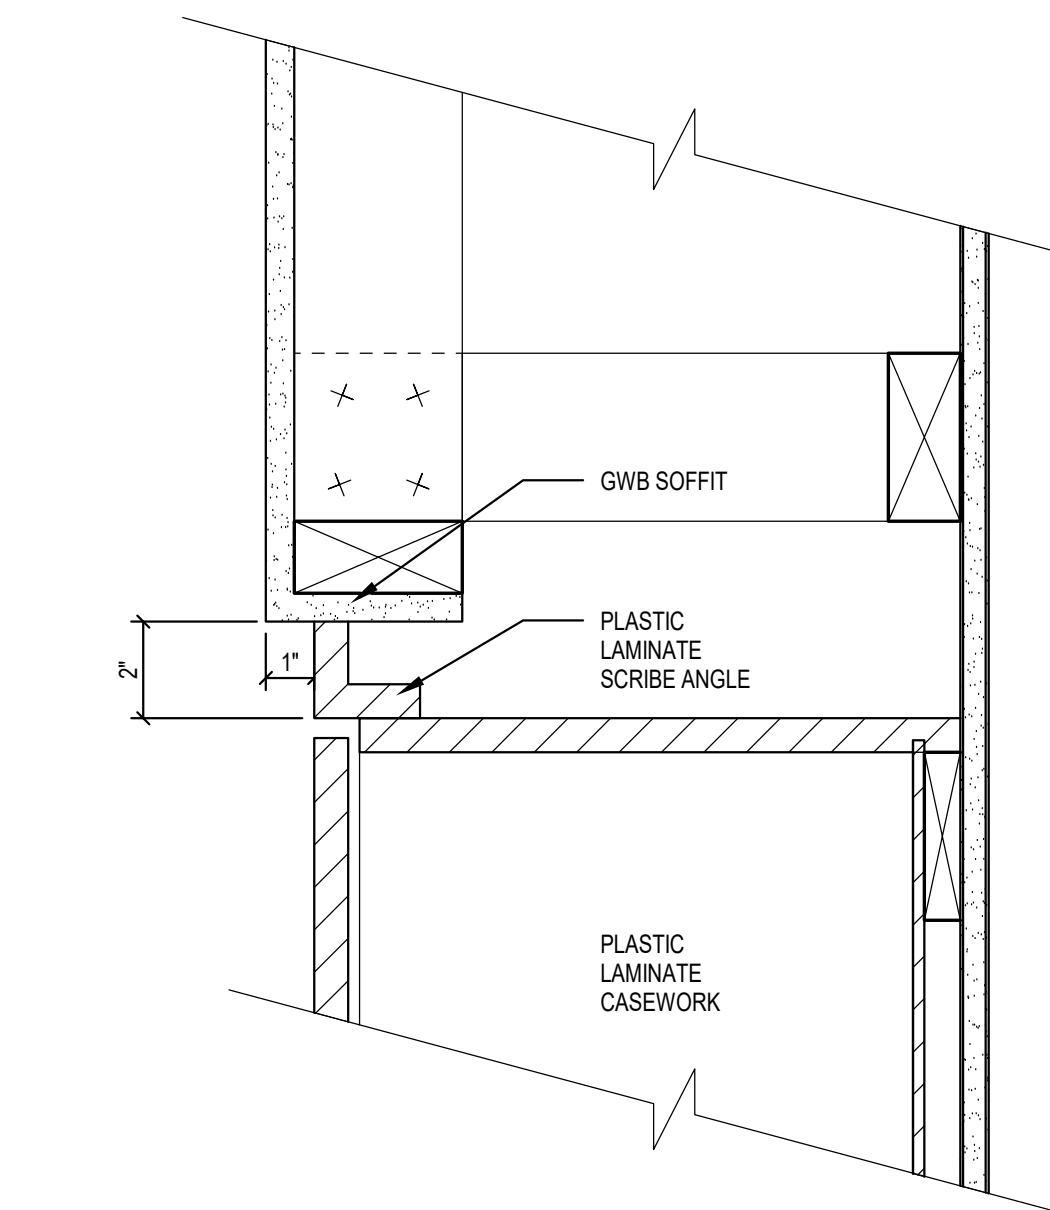

2 GWS SOFFIT
3" = 1'-0"

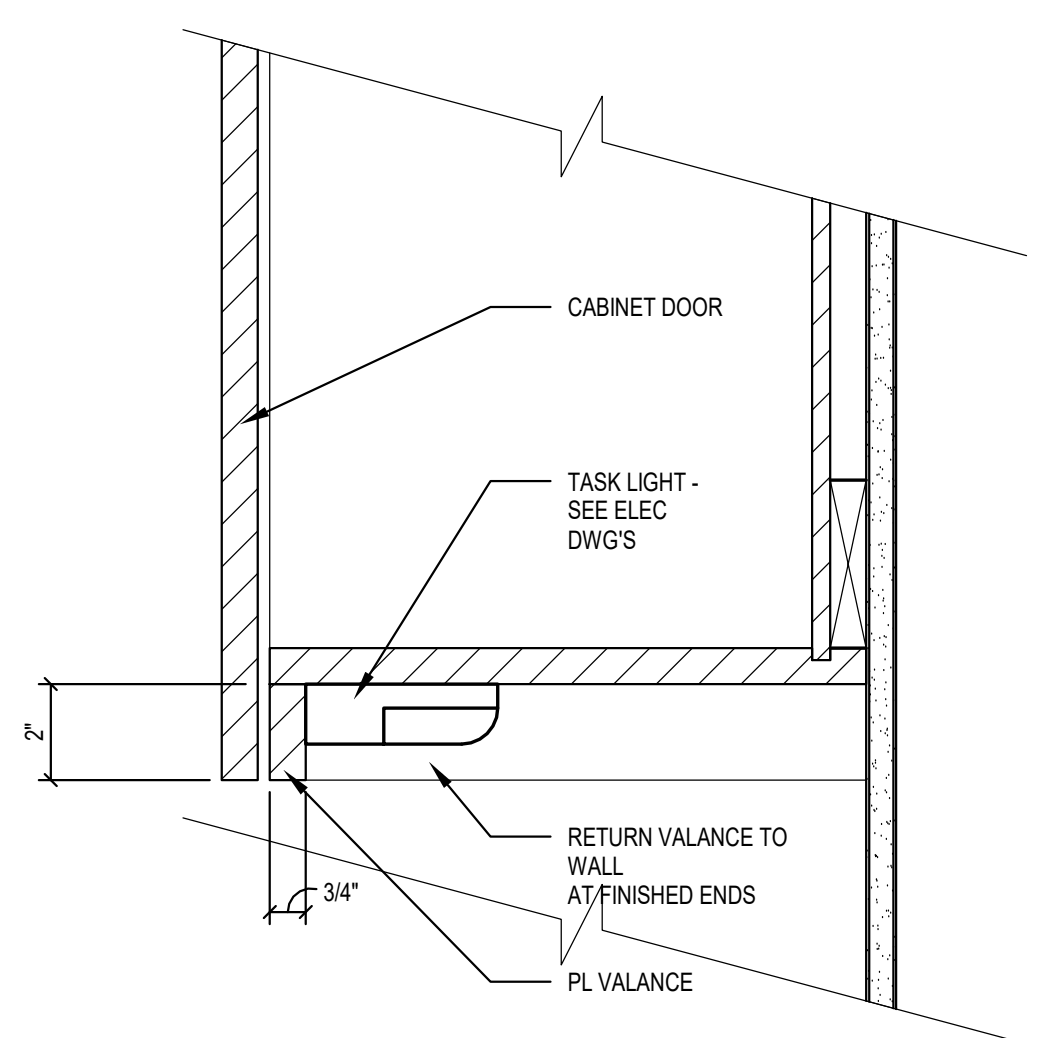

3 LIGHT VALANCE
3" = 1'-0"

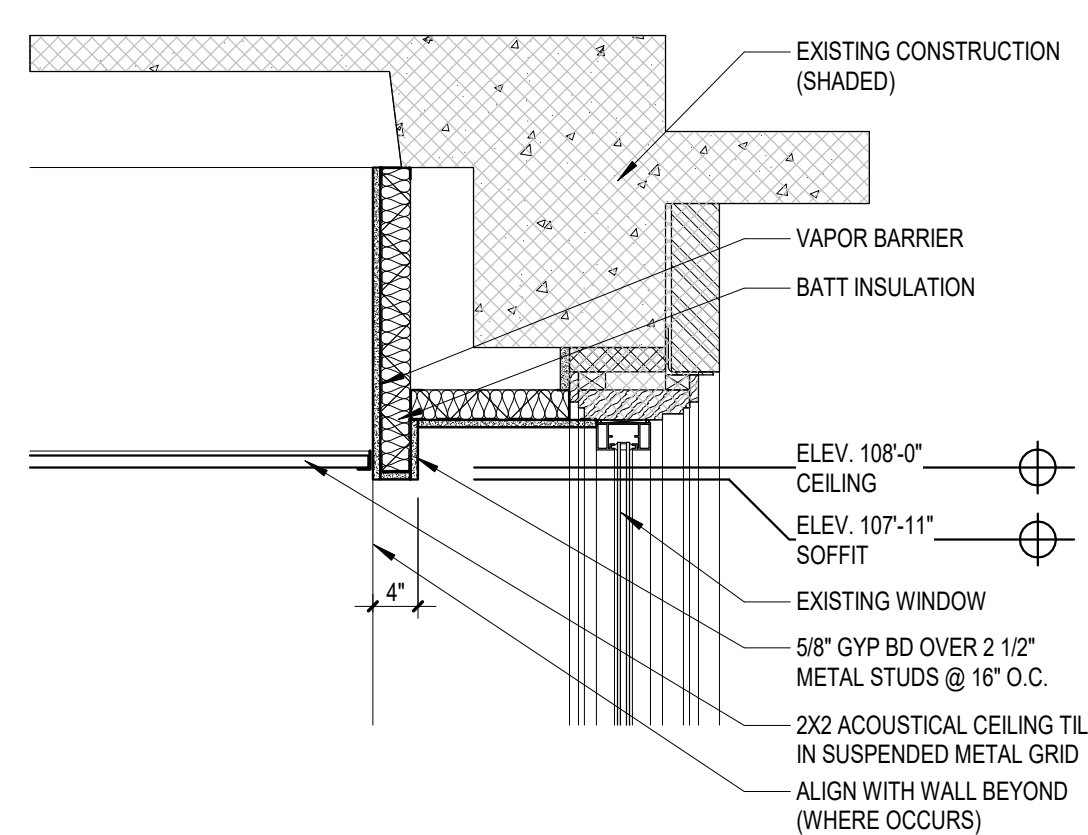

4 RECESSED SOFFIT
3/4" = 1'-0"

REFLECTED CEILING LEGEND

- | | | | |
|--|--|--|---|
| | EXISTING GYPSUM WALL BOARD CEILING | | GYPSUM WALL BOARD CEILING |
| | EXISTING SUSPENDED ACOUSTICAL REMAIN | | SUSPENDED ACOUSTICAL CEILING |
| | EXISTING SUPPLY AIR GRILLE - SEE MECHANICAL | | SUPPLY AIR GRILLE - SEE MECHANICAL |
| | EXISTING RETURN AIR GRILLE - SEE MECHANICAL | | RETURN AIR GRILLE TO - SEE MECHANICAL |
| | EXISTING RECESSED 2X2 LIGHT FIXTURE - SEE ELECTRICAL | | RECESSED 2X2 LIGHT FIXTURE - SEE ELECTRICAL |
| | EXISTING RECESSED 2X4 LIGHT FIXTURE - SEE ELECTRICAL | | RECESSED 2X4 LIGHT FIXTURE - SEE ELECTRICAL |
| | CAN LIGHT | | CAN LIGHT |
| | EXIT LIGHT | | EXIT LIGHT |
| | WIRELESS ACCESS POINT | | WIRELESS ACCESS POINT |
| | SPEAKER | | SPEAKER |
| | SMOKE DETECTOR | | SMOKE DETECTOR |
| | OCCUPANCY SENSOR | | OCCUPANCY SENSOR |
| | VIDEO SURVEILLANCE CAMERA | | VIDEO SURVEILLANCE CAMERA |

GENERAL REFLECTED CEILING NOTES:

- PROVIDE GYPSUM WALL BOARD AND METAL STUD BULK HEADS WHERE CEILINGS OF DIFFERENT HEIGHTS ABUT. DO NOT BUILD BULKHEADS OF ACOUSTICAL CEILING MATERIALS UNLESS SPECIFICALLY DETAILED.
- REFER TO MECHANICAL DRAWINGS (IN SERIES) FOR QUANTITY AND TYPE OF DIFFUSERS, RETURN AIR GRILLES, AND EXHAUST GRILLES. SCRIBE CEILING MATERIALS CAREFULLY FOR A TIGHT FIT.
- REFER TO ELECTRICAL DRAWINGS (E SERIES) FOR QUANTITY AND TYPE OF LIGHTS, SPEAKERS, DETECTORS, POWER OUTLETS, ETC. SCRIBE CEILING MATERIALS CAREFULLY. WHERE NO DEVICES ARE SHOWN ON PLANS, FIELD VERIFY LOCATION & QUANTITY OF DEVICES IN EXISTING CEILING. THESE DEVICES WILL BE RELOCATED TO THE NEW CEILING.
- ALTHOUGH NOT SPECIFICALLY SHOWN, MUCH OF THE PROJECT HAS FIRE SPRINKLER HEADS IN CEILING. SCRIBE CEILING MATERIALS CAREFULLY FOR A TIGHT FIT.
- ACOUSTIC TILE CEILING TO BE AT-01 UNLESS NOTED OTHERWISE.
- UNLESS NOTED OTHERWISE, TYPICAL CEILING HEIGHT TO BE 8'-0".
- REFER TO DETAIL 2 / AC101 FOR GWS SOFFITS ABOVE BUILT-IN CASEWORK.
- REFER TO ROOM FINISH SCHEDULE FOR CEILING HEIGHTS AND MATERIAL LOCATIONS.
- PROVIDE GYPSUM WALL BOARD AND METAL STUD BULK HEADS WHERE CEILINGS OF DIFFERENT HEIGHTS ABUT. DO NOT BUILD BULKHEADS OF ACOUSTICAL CEILING MATERIALS UNLESS SPECIFICALLY DETAILED.
- REFER TO MECHANICAL DRAWINGS (IN SERIES) FOR QUANTITY AND TYPE OF DIFFUSERS, RETURN AIR GRILLES, AND EXHAUST GRILLES. SCRIBE CEILING MATERIALS CAREFULLY FOR A TIGHT FIT.
- REFER TO ELECTRICAL DRAWINGS (E SERIES) FOR QUANTITY AND TYPE OF LIGHTS, SPEAKERS, DETECTORS, POWER OUTLETS, ETC. SCRIBE CEILING MATERIALS CAREFULLY. WHERE NO DEVICES ARE SHOWN ON PLANS, FIELD VERIFY LOCATION & QUANTITY OF DEVICES IN EXISTING CEILING. THESE DEVICES WILL BE RELOCATED TO THE NEW CEILING.
- ALTHOUGH NOT SPECIFICALLY SHOWN, THE ENTIRE PROJECT HAS FIRE SPRINKLER HEADS IN CEILING. SCRIBE CEILING MATERIALS CAREFULLY FOR A TIGHT FIT.
- REFER TO ROOM FINISH SCHEDULE FOR THE EXTENT OF GRID SYSTEM. REFLECTED CEILING PLANS SHOW TILE PATTERNS.
- CONTRACTOR TO FIELD VERIFY EXTENT OF CEILING REPLACEMENT. CONTRACTOR TO COORDINATE WITH ALL TRADES.
- ALL EXISTING TO REMAIN GRILLES, DIFFUSERS AND LIGHTS ETC. TO BE CLEANED.



1 BASEMENT - REFLECTED CEILING PLAN
3/16" = 1'-0"

9/23/2021 9:47:41 PM
B:\360\2021-10\589A7-21-108 - Renovate and Repair Structural Building\4921-102\103.rvt


Revisions:	Date:

ARCHITECT/ENGINEER OF RECORD

ALESIA ARCHITECTURE
Alesia Architecture P.C.
3705 North 200th Street
Elkhorn, Nebraska 68022
Phone: 402.291.6941

IMEG STRUCTURAL ENGINEERS
IMEG Corp.
15 Sunbeam Drive,
Suite 104
St. Louis, MO 63143
Phone: (314) 951-2534

SHAFFER STEVENS SCHAAP STRUCTURAL ENGINEERS
9910 North 48th Street, Ste 204, Omaha, NE 68152
402.455.7698
www.s3ep.com

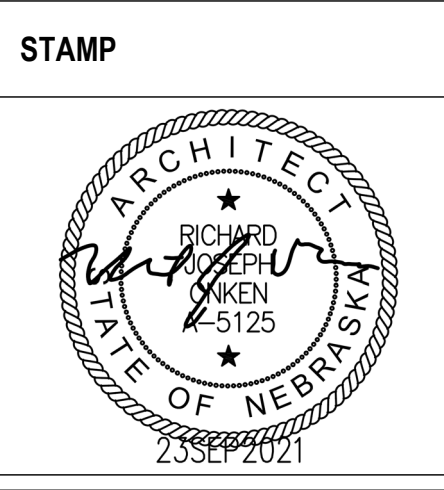

Office of Construction and Facilities Management
U.S. Department of Veterans Affairs

Drawing Title
BASEMENT - REFLECTED CEILING PLAN

Approved:

Phase
BID DOCUMENTS

FULLY SPRINKLERED

Project Title
Renovate and Repair Structural, Building 4

Location
Wichita, KS

Issue Date
9/23/2021

Checked

Drawn

Project Number
589A7-21-108

Building Number
4

Drawing Number
AC101

A

B

C

D

E


F

REFLECTED CEILING LEGEND

	EXISTING GYPSUM WALL BOARD CEILING		GYPSUM WALL BOARD CEILING
	EXISTING SUSPENDED ACOUSTICAL REMAIN		SUSPENDED ACOUSTICAL CEILING
	EXISTING SUPPLY AIR GRILLE - SEE MECHANICAL		SUPPLY AIR GRILLE - SEE MECHANICAL
	EXISTING RETURN AIR GRILLE - SEE MECHANICAL		RETURN AIR GRILLE TO - SEE MECHANICAL
	EXISTING RECESSED 2X2 LIGHT FIXTURE - SEE ELECTRICAL		RECESSED 2X2 LIGHT FIXTURE - SEE ELECTRICAL
	EXISTING RECESSED 2X4 LIGHT FIXTURE - SEE ELECTRICAL		RECESSED 2X4 LIGHT FIXTURE - SEE ELECTRICAL
	CAN LIGHT		CAN LIGHT
	EXIT LIGHT		EXIT LIGHT
	WIRELESS ACCESS POINT		WIRELESS ACCESS POINT
	SPEAKER		SPEAKER
	SMOKE DETECTOR		SMOKE DETECTOR
	OCCUPANCY SENSOR		OCCUPANCY SENSOR
	VIDEO SURVEILLANCE CAMERA		VIDEO SURVEILLANCE CAMERA

GENERAL REFLECTED CEILING NOTES:

- PROVIDE GYPSUM WALL BOARD AND METAL STUD BULK HEADS WHERE CEILING HEIGHTS DIFFER. DO NOT BUILD BULKHEADS OF ACOUSTICAL CEILING MATERIALS UNLESS SPECIFICALLY DETAILED.
- REFER TO MECHANICAL DRAWINGS (IN SERIES) FOR QUANTITY AND TYPE OF DIFFUSERS, RETURN AIR GRILLES, AND EXHAUST GRILLES. SCRIBE CEILING MATERIALS CAREFULLY FOR A TIGHT FIT.
- REFER TO ELECTRICAL DRAWINGS (E SERIES) FOR QUANTITY AND TYPE OF LIGHTS, SPEAKERS, DETECTORS, POWER OUTLETS, ETC. SCRIBE CEILING MATERIALS CAREFULLY. WHERE NO DEVICES ARE SHOWN ON PLANS, FIELD VERIFY LOCATION & QUANTITY OF DEVICES IN EXISTING CEILING. THESE DEVICES WILL BE RELOCATED TO THE NEW CEILING.
- ALTHOUGH NOT SPECIFICALLY SHOWN, MUCH OF THE PROJECT HAS FIRE SPRINKLER HEADS IN CEILING. SCRIBE CEILING MATERIALS CAREFULLY FOR A TIGHT FIT.
- ACOUSTIC TILE CEILING TO BE AT-01 UNLESS NOTED OTHERWISE.
- UNLESS NOTED OTHERWISE, TYPICAL CEILING HEIGHT TO BE 8'-0".
- REFER TO DETAIL 2 / AC101 FOR GWB SOFFITS ABOVE BUILT-IN CASEWORK.
- REFER TO ROOM FINISH SCHEDULE FOR CEILING HEIGHTS AND MATERIAL LOCATIONS.
- PROVIDE GYPSUM WALL BOARD AND METAL STUD BULK HEADS WHERE CEILING HEIGHTS DIFFER. DO NOT BUILD BULKHEADS OF ACOUSTICAL CEILING MATERIALS UNLESS SPECIFICALLY DETAILED.
- REFER TO MECHANICAL DRAWINGS (IN SERIES) FOR QUANTITY AND TYPE OF DIFFUSERS, RETURN AIR GRILLES, AND EXHAUST GRILLES. SCRIBE CEILING MATERIALS CAREFULLY FOR A TIGHT FIT.
- REFER TO ELECTRICAL DRAWINGS (E SERIES) FOR QUANTITY AND TYPE OF LIGHTS, SPEAKERS, DETECTORS, POWER OUTLETS, ETC. SCRIBE CEILING MATERIALS CAREFULLY. WHERE NO DEVICES ARE SHOWN ON PLANS, FIELD VERIFY LOCATION & QUANTITY OF DEVICES IN EXISTING CEILING. THESE DEVICES WILL BE RELOCATED TO THE NEW CEILING.
- ALTHOUGH NOT SPECIFICALLY SHOWN, THE ENTIRE PROJECT HAS FIRE SPRINKLER HEADS IN CEILING. SCRIBE CEILING MATERIALS CAREFULLY FOR A TIGHT FIT.
- REFER TO ROOM FINISH SCHEDULE FOR THE EXTENT OF GRID SYSTEM. REFLECTED CEILING PLANS SHOW TILE PATTERNS.
- CONTRACTOR TO FIELD VERIFY EXTENT OF CEILING REPLACEMENT. CONTRACTOR TO COORDINATE WITH ALL TRADES.
- ALL EXISTING TO REMAIN GRILLES, DIFFUSERS AND LIGHTS ETC. TO BE CLEANED.

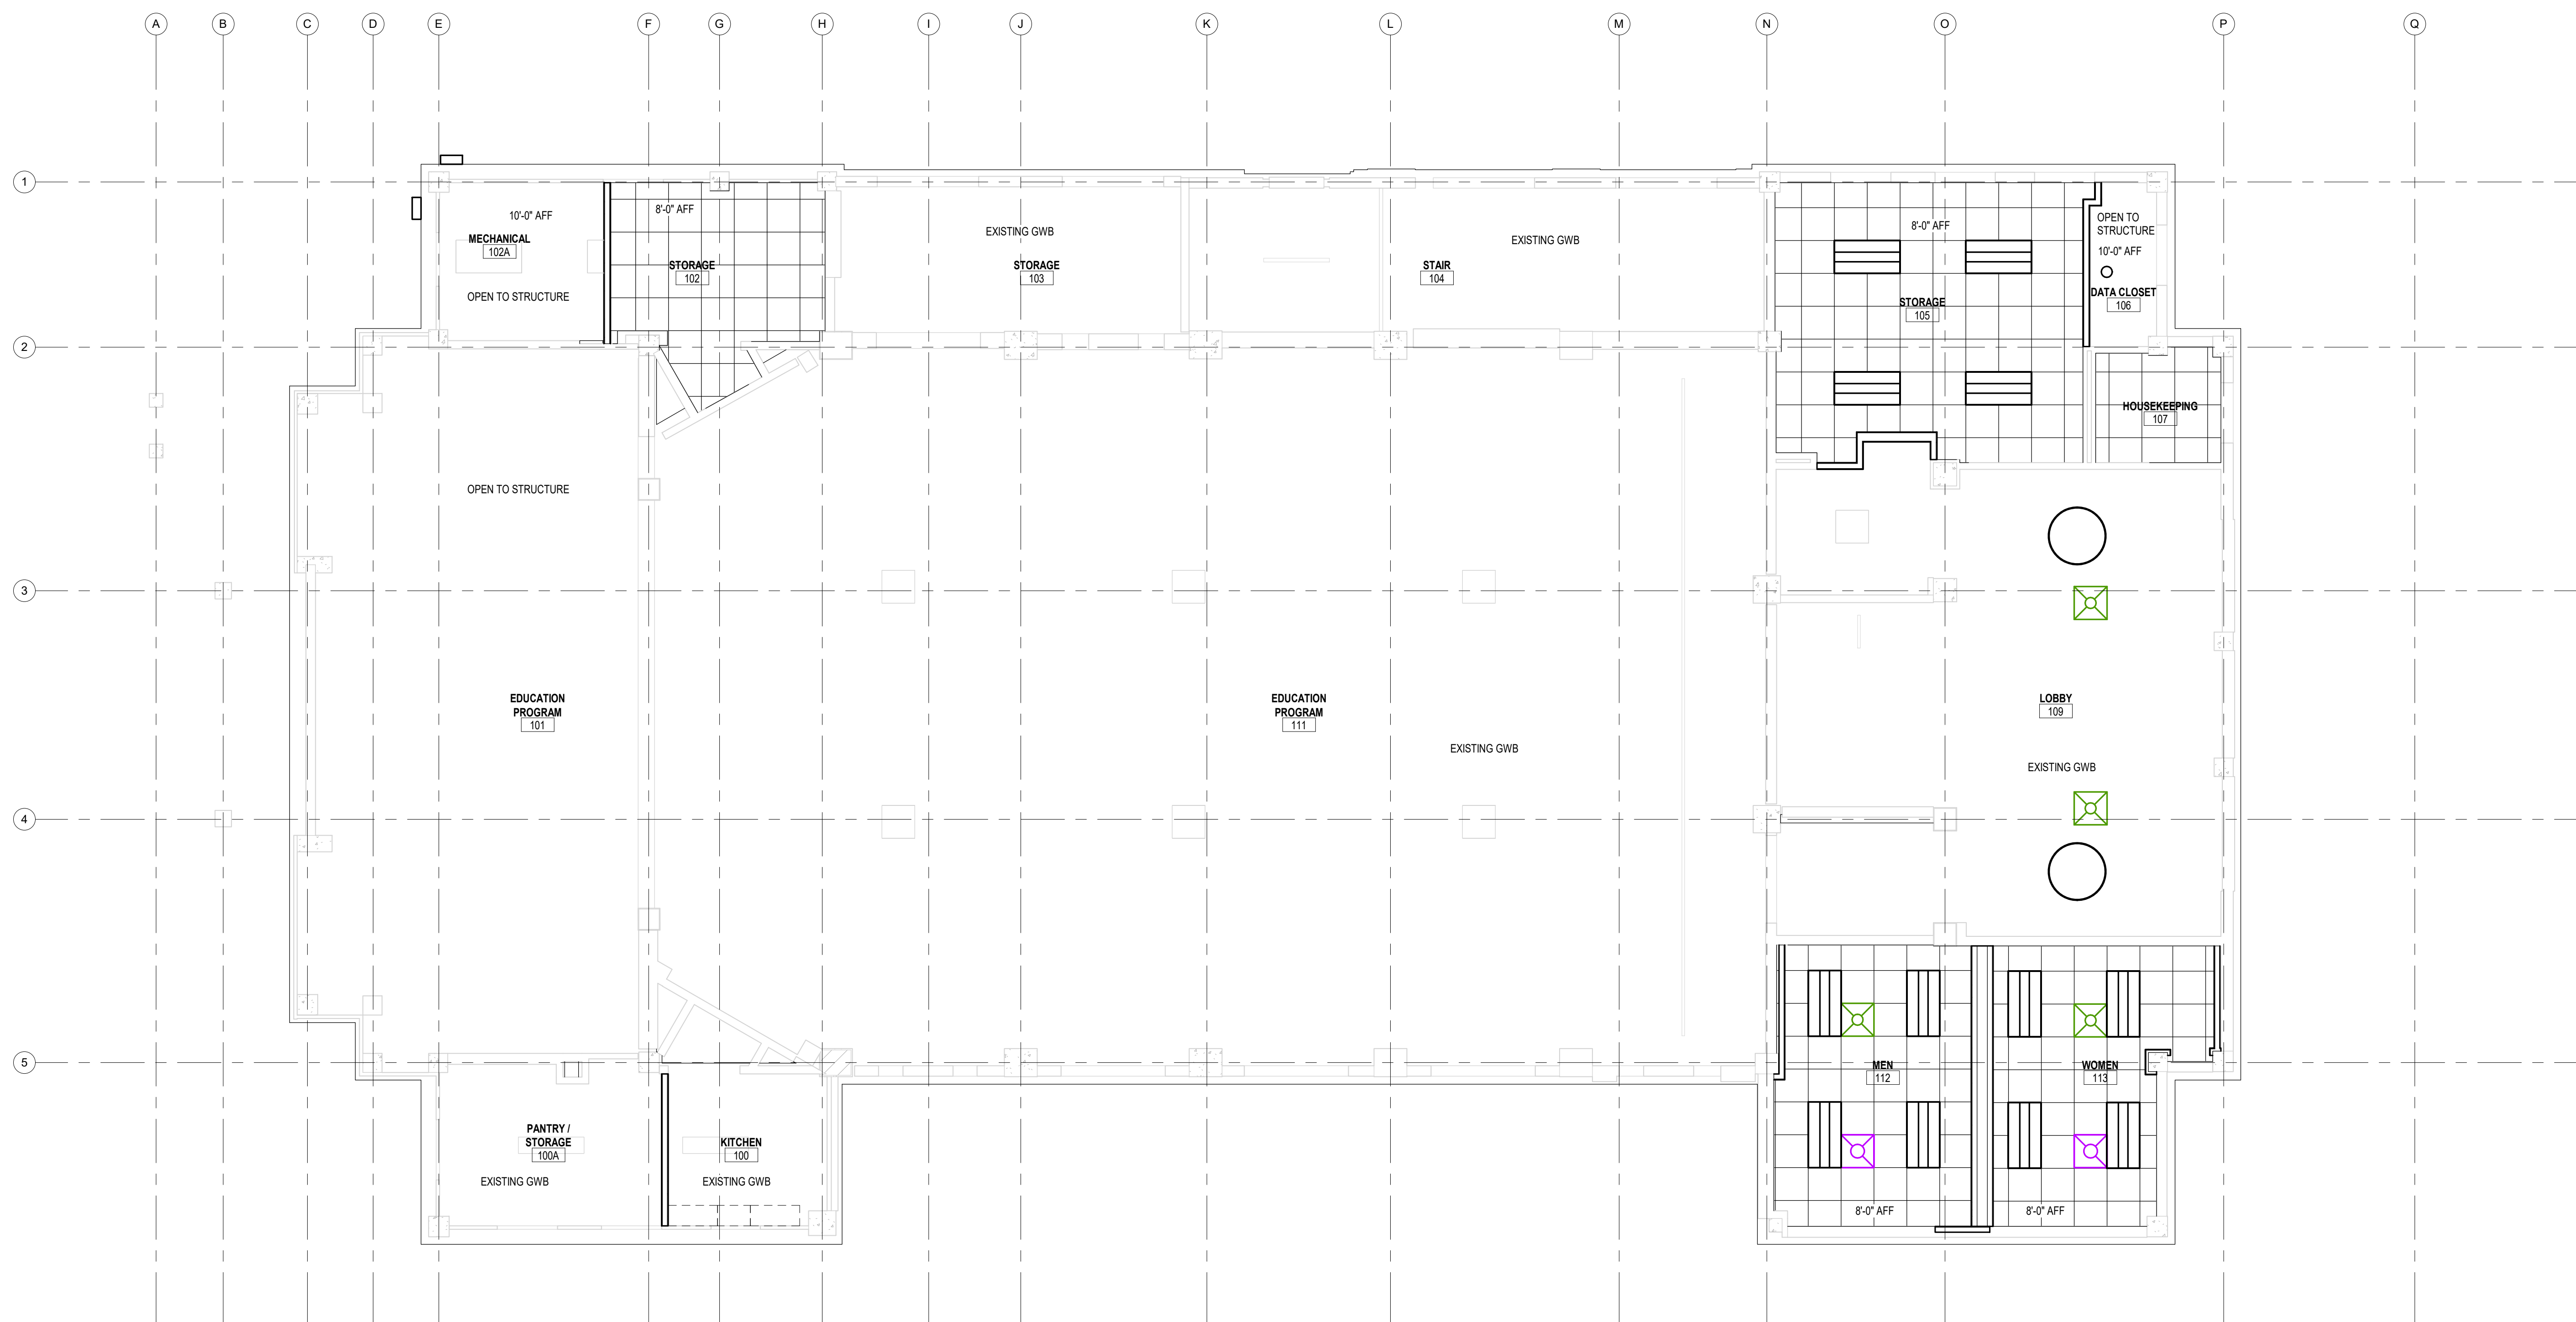

1 FIRST FLOOR - REFLECTED CEILING PLAN
3/16" = 1'-0"

9/23/2021 8:47:42 PM

BM_36012021-03_589A7-21-108 - Renovate and Repair Structural Building 4/021-102103.rvt


Revisions:	Date:




Alesia Architecture P.C.
3705 North 200th Street
Elkhorn, Nebraska 68022
Phone: 402.291.6941



IMEG Corp.
15 Sunnyside Drive,
Suite 104
St. Louis, MO 63143
Phone: (314) 951-2534

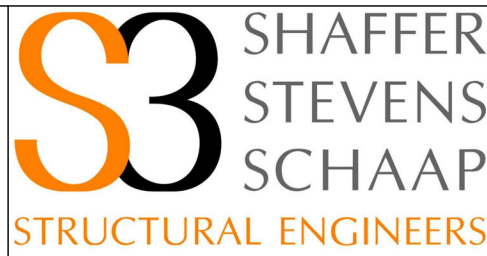

9910 North 48th Street, Ste 204, Omaha, NE 68152
402.455.7698 www.s3ep.com

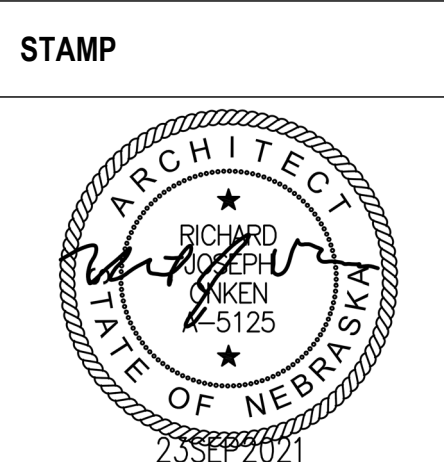

Drawing Title	FIRST FLOOR - REFLECTED CEILING PLAN
Approved:	

Phase	BID DOCUMENTS
	FULLY SPRINKLERED

Project Title	Renovate and Repair Structural, Building 4
Location	Wichita, KS
Issue Date	9/23/2021
Checked	
Drawn	

Project Number	589A7-21-108
Building Number	4
Drawing Number	AC102

A

B

C

D

E


F

REFLECTED CEILING LEGEND

	EXISTING GYPSUM WALL BOARD CEILING		GYPSUM WALL BOARD CEILING
	EXISTING SUSPENDED ACOUSTICAL REMAIN		SUSPENDED ACOUSTICAL CEILING
	EXISTING SUPPLY AIR GRILLE - SEE MECHANICAL		SUPPLY AIR GRILLE - SEE MECHANICAL
	EXISTING RETURN AIR GRILLE - SEE MECHANICAL		RETURN AIR GRILLE TO - SEE MECHANICAL
	EXISTING RECESSED 2X2 LIGHT FIXTURE - SEE ELECTRICAL		RECESSED 2X2 LIGHT FIXTURE - SEE ELECTRICAL
	EXISTING RECESSED 2X4 LIGHT FIXTURE - SEE ELECTRICAL		RECESSED 2X4 LIGHT FIXTURE - SEE ELECTRICAL
	CAN LIGHT		CAN LIGHT
	EXIT LIGHT		EXIT LIGHT
	WIRELESS ACCESS POINT		WIRELESS ACCESS POINT
	SPEAKER		SPEAKER
	SMOKE DETECTOR		SMOKE DETECTOR
	OCCUPANCY SENSOR		OCCUPANCY SENSOR
	VIDEO SURVEILLANCE CAMERA		VIDEO SURVEILLANCE CAMERA

GENERAL REFLECTED CEILING NOTES:

- PROVIDE GYPSUM WALL BOARD AND METAL STUD BULK HEADS WHERE CEILING HEIGHTS DIFFER. DO NOT BUILD BULKHEADS OF ACOUSTICAL CEILING MATERIALS UNLESS SPECIFICALLY DETAILED.
- REFER TO MECHANICAL DRAWINGS (IN SERIES) FOR QUANTITY AND TYPE OF DIFFUSERS, RETURN AIR GRILLES, AND EXHAUST GRILLES. SCRIBE CEILING MATERIALS CAREFULLY FOR A TIGHT FIT.
- REFER TO ELECTRICAL DRAWINGS (E SERIES) FOR QUANTITY AND TYPE OF LIGHTS, SPEAKERS, DETECTORS, POWER OUTLETS, ETC. SCRIBE CEILING MATERIALS CAREFULLY. WHERE NO DEVICES ARE SHOWN ON PLANS, FIELD VERIFY LOCATION & QUANTITY OF DEVICES IN EXISTING CEILING. THESE DEVICES WILL BE RELOCATED TO THE NEW CEILING.
- ALTHOUGH NOT SPECIFICALLY SHOWN, MUCH OF THE PROJECT HAS FIRE SPRINKLER HEADS IN CEILING. SCRIBE CEILING MATERIALS CAREFULLY FOR A TIGHT FIT.
- ACOUSTIC TILE CEILING TO BE AT-01 UNLESS NOTED OTHERWISE.
- UNLESS NOTED OTHERWISE, TYPICAL CEILING HEIGHT TO BE 8'-0".
- REFER TO DETAIL 2 / AC101 FOR GIBB SOFFITS ABOVE BUILT-IN CASEWORK.
- REFER TO ROOM FINISH SCHEDULE FOR CEILING HEIGHTS AND MATERIAL LOCATIONS.
- PROVIDE GYPSUM WALL BOARD AND METAL STUD BULK HEADS WHERE CEILING HEIGHTS DIFFER. DO NOT BUILD BULKHEADS OF ACOUSTICAL CEILING MATERIALS UNLESS SPECIFICALLY DETAILED.
- REFER TO MECHANICAL DRAWINGS (IN SERIES) FOR QUANTITY AND TYPE OF DIFFUSERS, RETURN AIR GRILLES, AND EXHAUST GRILLES. SCRIBE CEILING MATERIALS CAREFULLY FOR A TIGHT FIT.
- REFER TO ELECTRICAL DRAWINGS (E SERIES) FOR QUANTITY AND TYPE OF LIGHTS, SPEAKERS, DETECTORS, POWER OUTLETS, ETC. SCRIBE CEILING MATERIALS CAREFULLY. WHERE NO DEVICES ARE SHOWN ON PLANS, FIELD VERIFY LOCATION & QUANTITY OF DEVICES IN EXISTING CEILING. THESE DEVICES WILL BE RELOCATED TO THE NEW CEILING.
- ALTHOUGH NOT SPECIFICALLY SHOWN, THE ENTIRE PROJECT HAS FIRE SPRINKLER HEADS IN CEILING. SCRIBE CEILING MATERIALS CAREFULLY FOR A TIGHT FIT.
- REFER TO ROOM FINISH SCHEDULE FOR THE EXTENT OF GRID SYSTEM. REFLECTED CEILING PLANS SHOW TILE PATTERNS.
- CONTRACTOR TO FIELD VERIFY EXTENT OF CEILING REPLACEMENT. CONTRACTOR TO COORDINATE WITH ALL TRADES.
- ALL EXISTING TO REMAIN GRILLES, DIFFUSERS AND LIGHTS ETC. TO BE CLEANED.

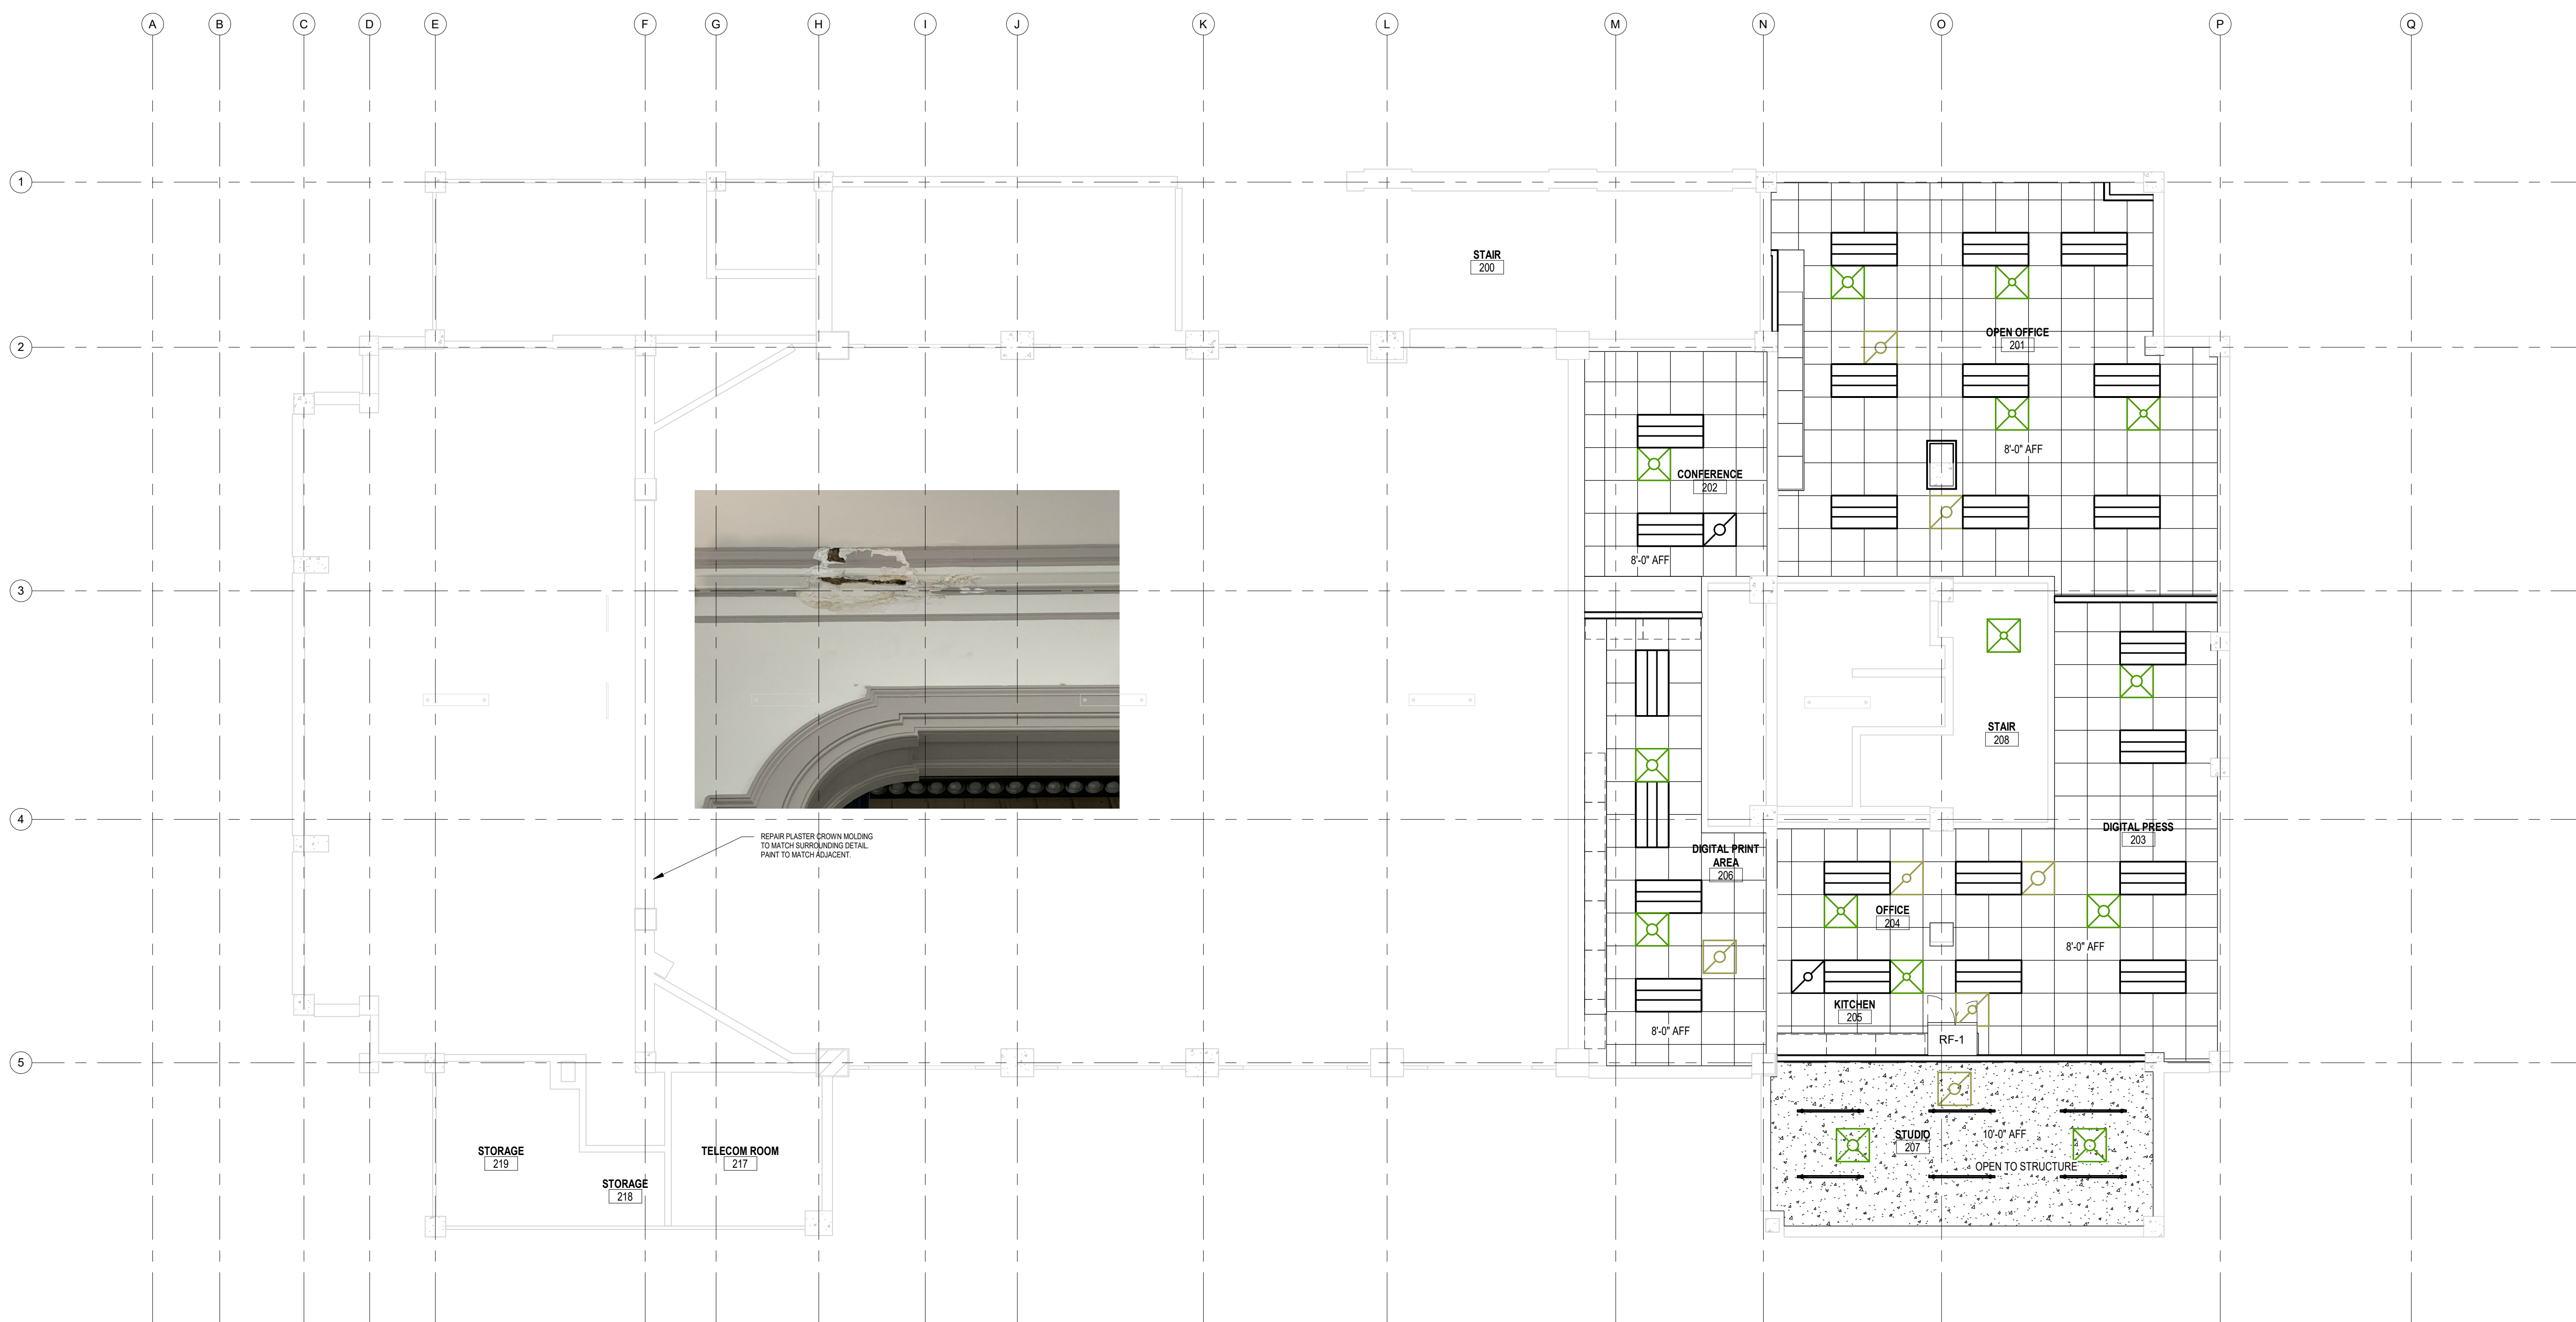

1 SECOND FLOOR - REFLECTED CEILING PLAN
3/16" = 1'-0"

9/23/2021 9:47:44 PM

B:\360\2021-10-30\589A7-21-108 - Renovate and Repair Structural Building 4\21-102\103.rvt


Revisions:	Date:

ARCHITECT/ENGINEER OF RECORD

ALESIA ARCHITECTURE
Alesia Architecture P.C.
3705 North 200th Street
Elkhorn, Nebraska 68022
Phone: 402.291.6941

IMEG CORP.
15 Sunnyside Drive,
Suite 104
St. Louis, MO 63143
Phone: (314) 951-2534

SHAFER STEVENS SCHAAP STRUCTURAL ENGINEERS
9910 North 48th Street, Ste 204, Omaha, NE 68152
402.455.7698 www.s3ep.com

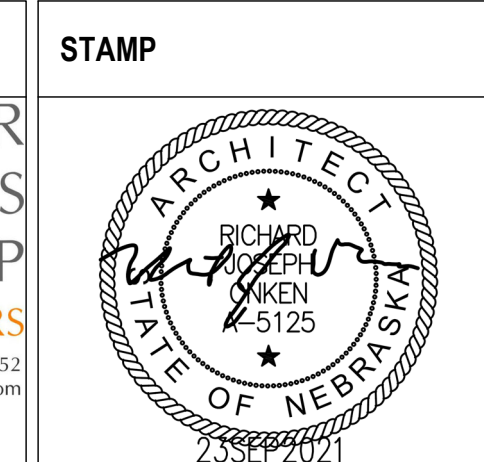

Office of Construction and Facilities Management

VA U.S. Department of Veterans Affairs

Drawing Title
SECOND FLOOR - REFLECTED CEILING PLAN

Approved: _____

Phase
BID DOCUMENTS

FULLY SPRINKLERED

Project Title
Renovate and Repair Structural, Building 4

Location
Wichita, KS

Issue Date
9/23/2021


Checked _____ Drawn _____

Project Number
589A7-21-108


Building Number
4

Drawing Number
AC103


- | DEMOLITION NOTES | PLAN NOTES | GENERAL NOTES |
|---|---|---|
| 1. SCRAPE OFF LOOSE PAINT. | 1. PRIME ALL WOOD SURFACES FOR NEW PAINT. REPAINT ALL TRIM SURFACES TO MATCH EXISTING. | 1. PROTECT EXISTING ROOFTOP EQUIPMENT AND MATERIALS TO REMAIN DURING CONSTRUCTION. |
| 2. REMOVE WROUGHT IRON RAILING ON CURVED FRONT STEPS, SALVAGE FOR REINSTALLATION. SCRAPE OFF LOOSE PAINT. | 2. PRIME BASE METAL PER SPECS, REPAINT ALL METAL RAILING SURFACES TO MATCH EXISTING. | 2. PROTECT BUILDING SIDING, SIDEWALKS, LAWNS, ETC. DURING CONSTRUCTION. |
| 3. REMOVE ALL CAST STONE STAIR TREADS | 3. INSTALL NEW CAST STONE TREADS, REF. SPECS. FIELD VERIFY SIZE TO MATCH EXISTING. | 3. MAINTAIN, PROTECT, AND RESET EXISTING METAL CURB FLASHING AND OTHER METAL OR ALUMINUM FLASHINGS FOR REUSE, UNLESS OTHERWISE NOTED. |
| 4. REMOVE 2 ROWS OF DISCOLORED MORTAR 1/2" DEEP AROUND BRICK IN AREA SHOWN BY SHADING. | 4. PRIME ALL WOOD SURFACES FOR NEW PAINT. REPAINT ALL COLUMN SURFACES TO MATCH EXISTING. | 4. FIELD VERIFY ALL DIMENSIONS. |
| 5. REMOVE 1/2" DEEP ALL DISCOLORED CEMENTITIOUS MORTAR IN AREA AS SHOWN BY SHADING. | 5. PRIME ALL WOOD SURFACES FOR NEW PAINT. REPAINT ALL DOOR SURFACES TO MATCH EXISTING. | |
| | 6. PRIME BASE METAL PER SPECS, REPAINT ALL SURFACES OF RAILING TO MATCH EXISTING. REINSTALL INTO NEW CAST STONE TREADS PER DETAIL 4/A301. | |
| | 7. INFILL WITH NEW CEMENTITIOUS MORTAR AROUND BRICK, TOOL TO MATCH EXISTING ADJACENT. | |
| | 8. INFILL WITH NEW CEMENTITIOUS MORTAR IN AREA AS SHOWN BY SHADING. TOOL TO MATCH EXISTING ADJACENT. | |
| | 9. INSTALL 3M SEISMIC S70 WINDOW FILM ON INTERIOR OF ALL WINDOW GLASS. CLEAN WINDOW GLASS BEFORE APPLICATION OF FILM. | |
| | 10. NEW WALL MOUNTED LIGHT FIXTURE, SEE ELECTRICAL. | |

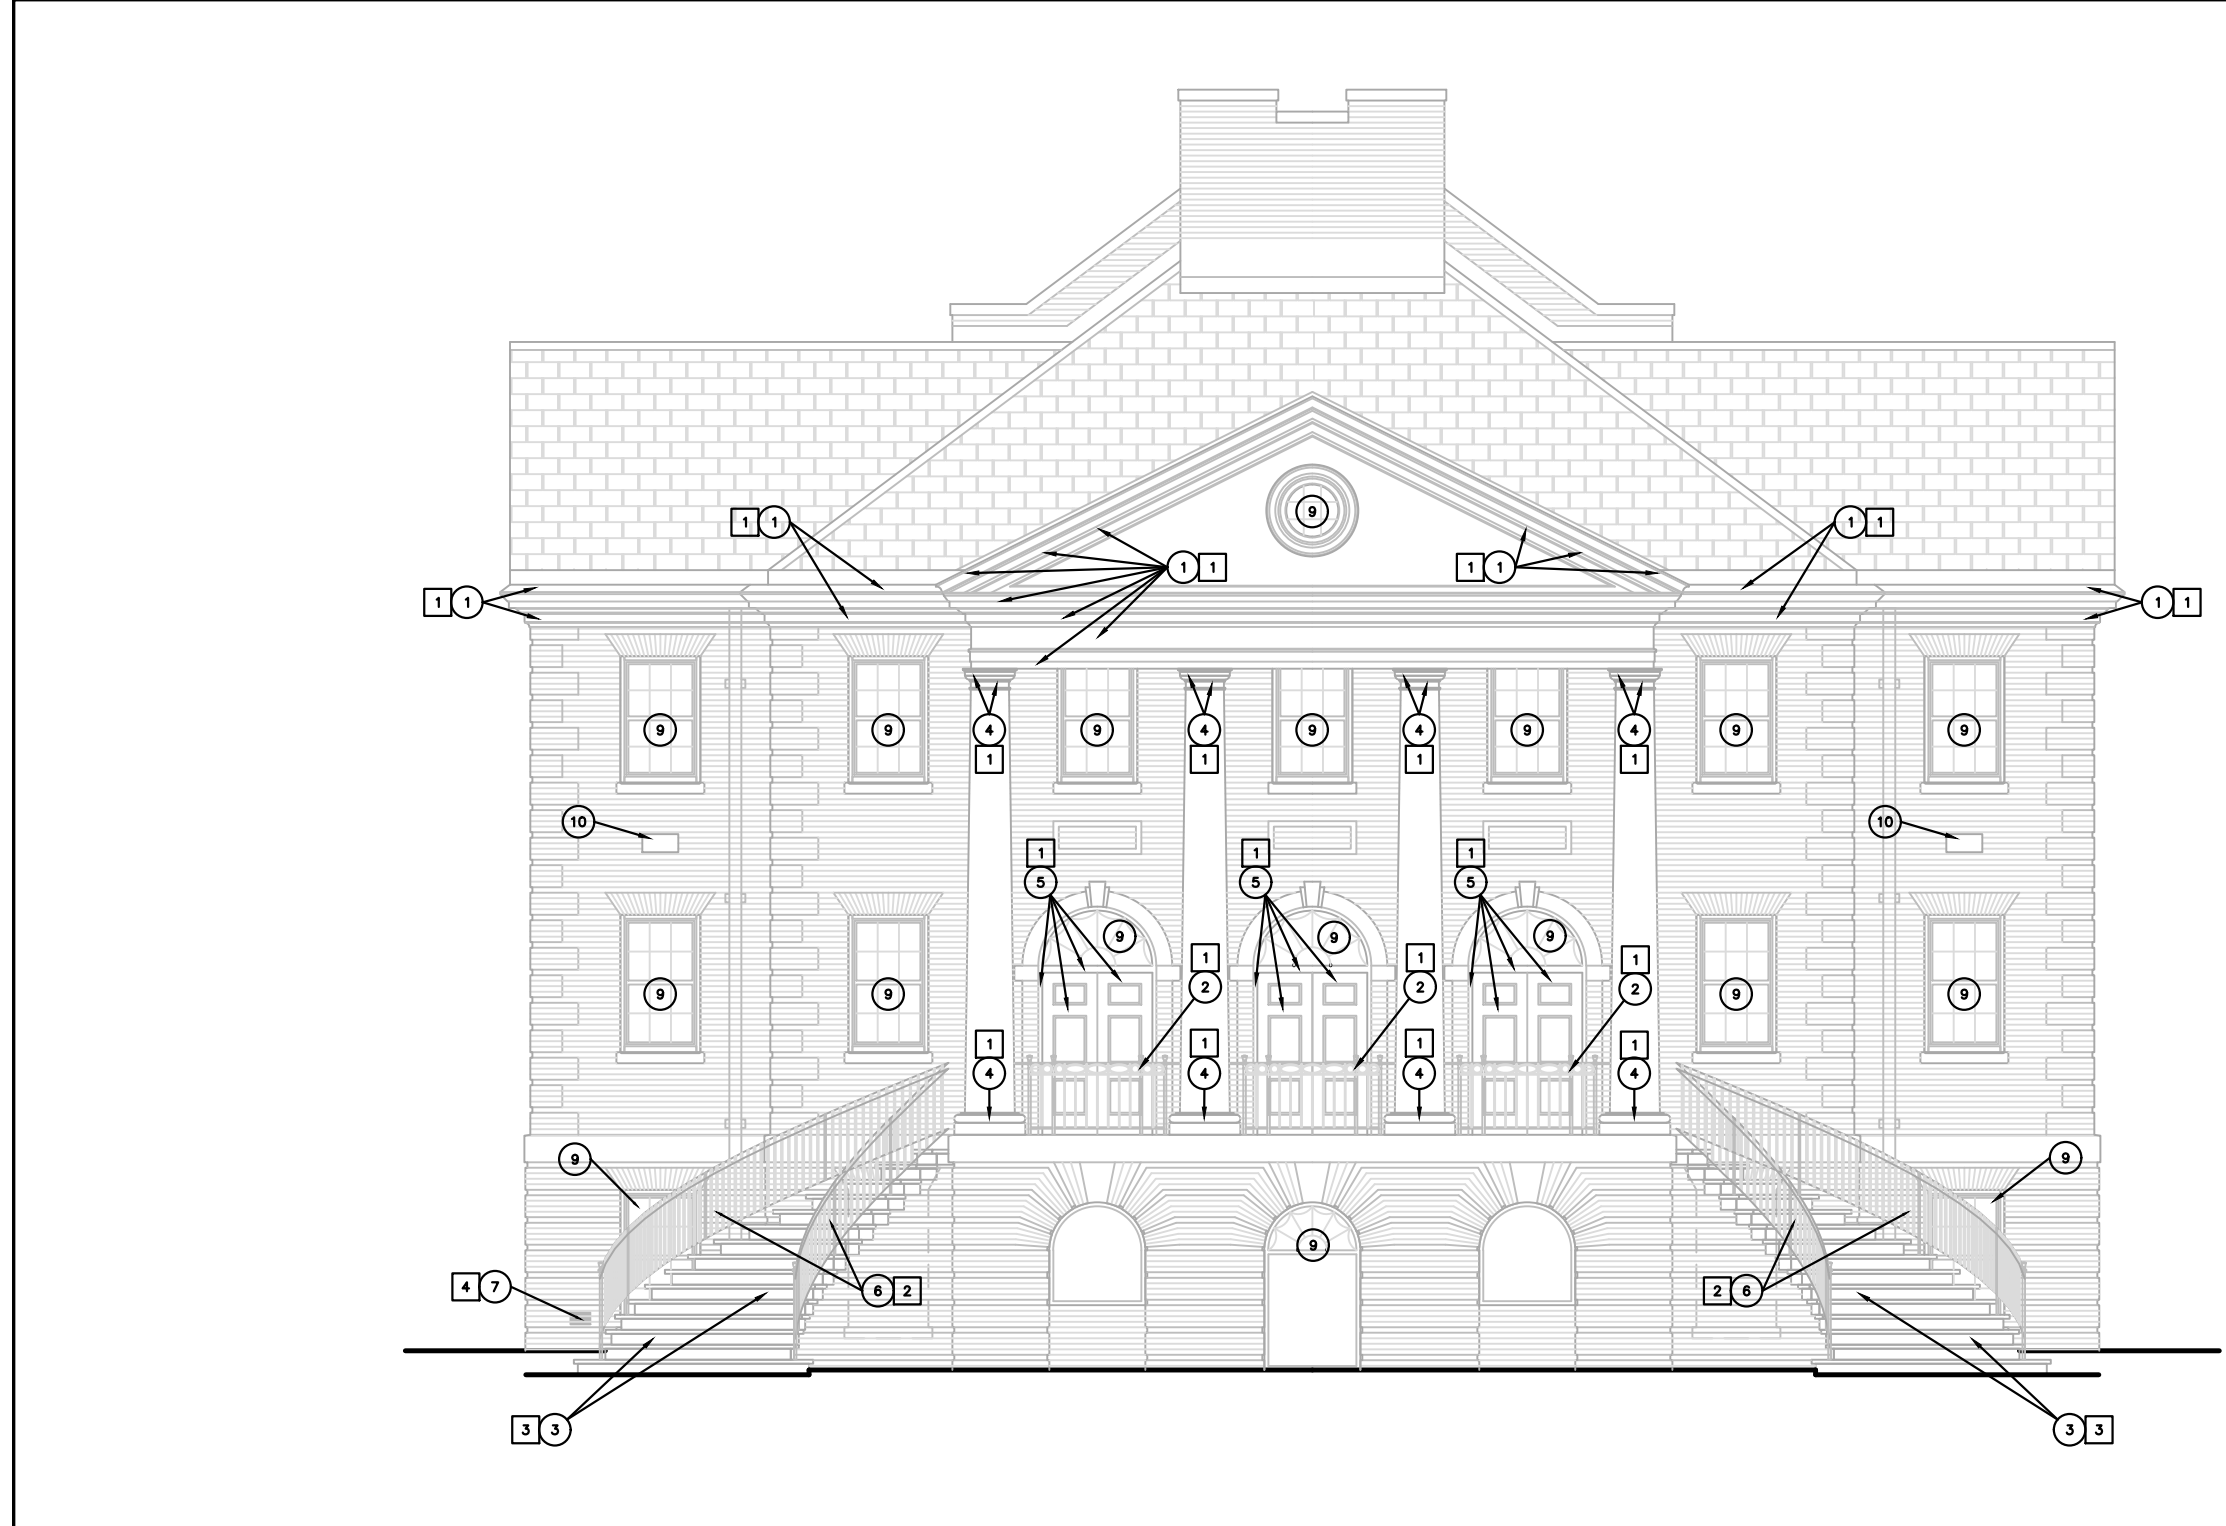


A EAST ELEVATION
1/2" = 1'-0"

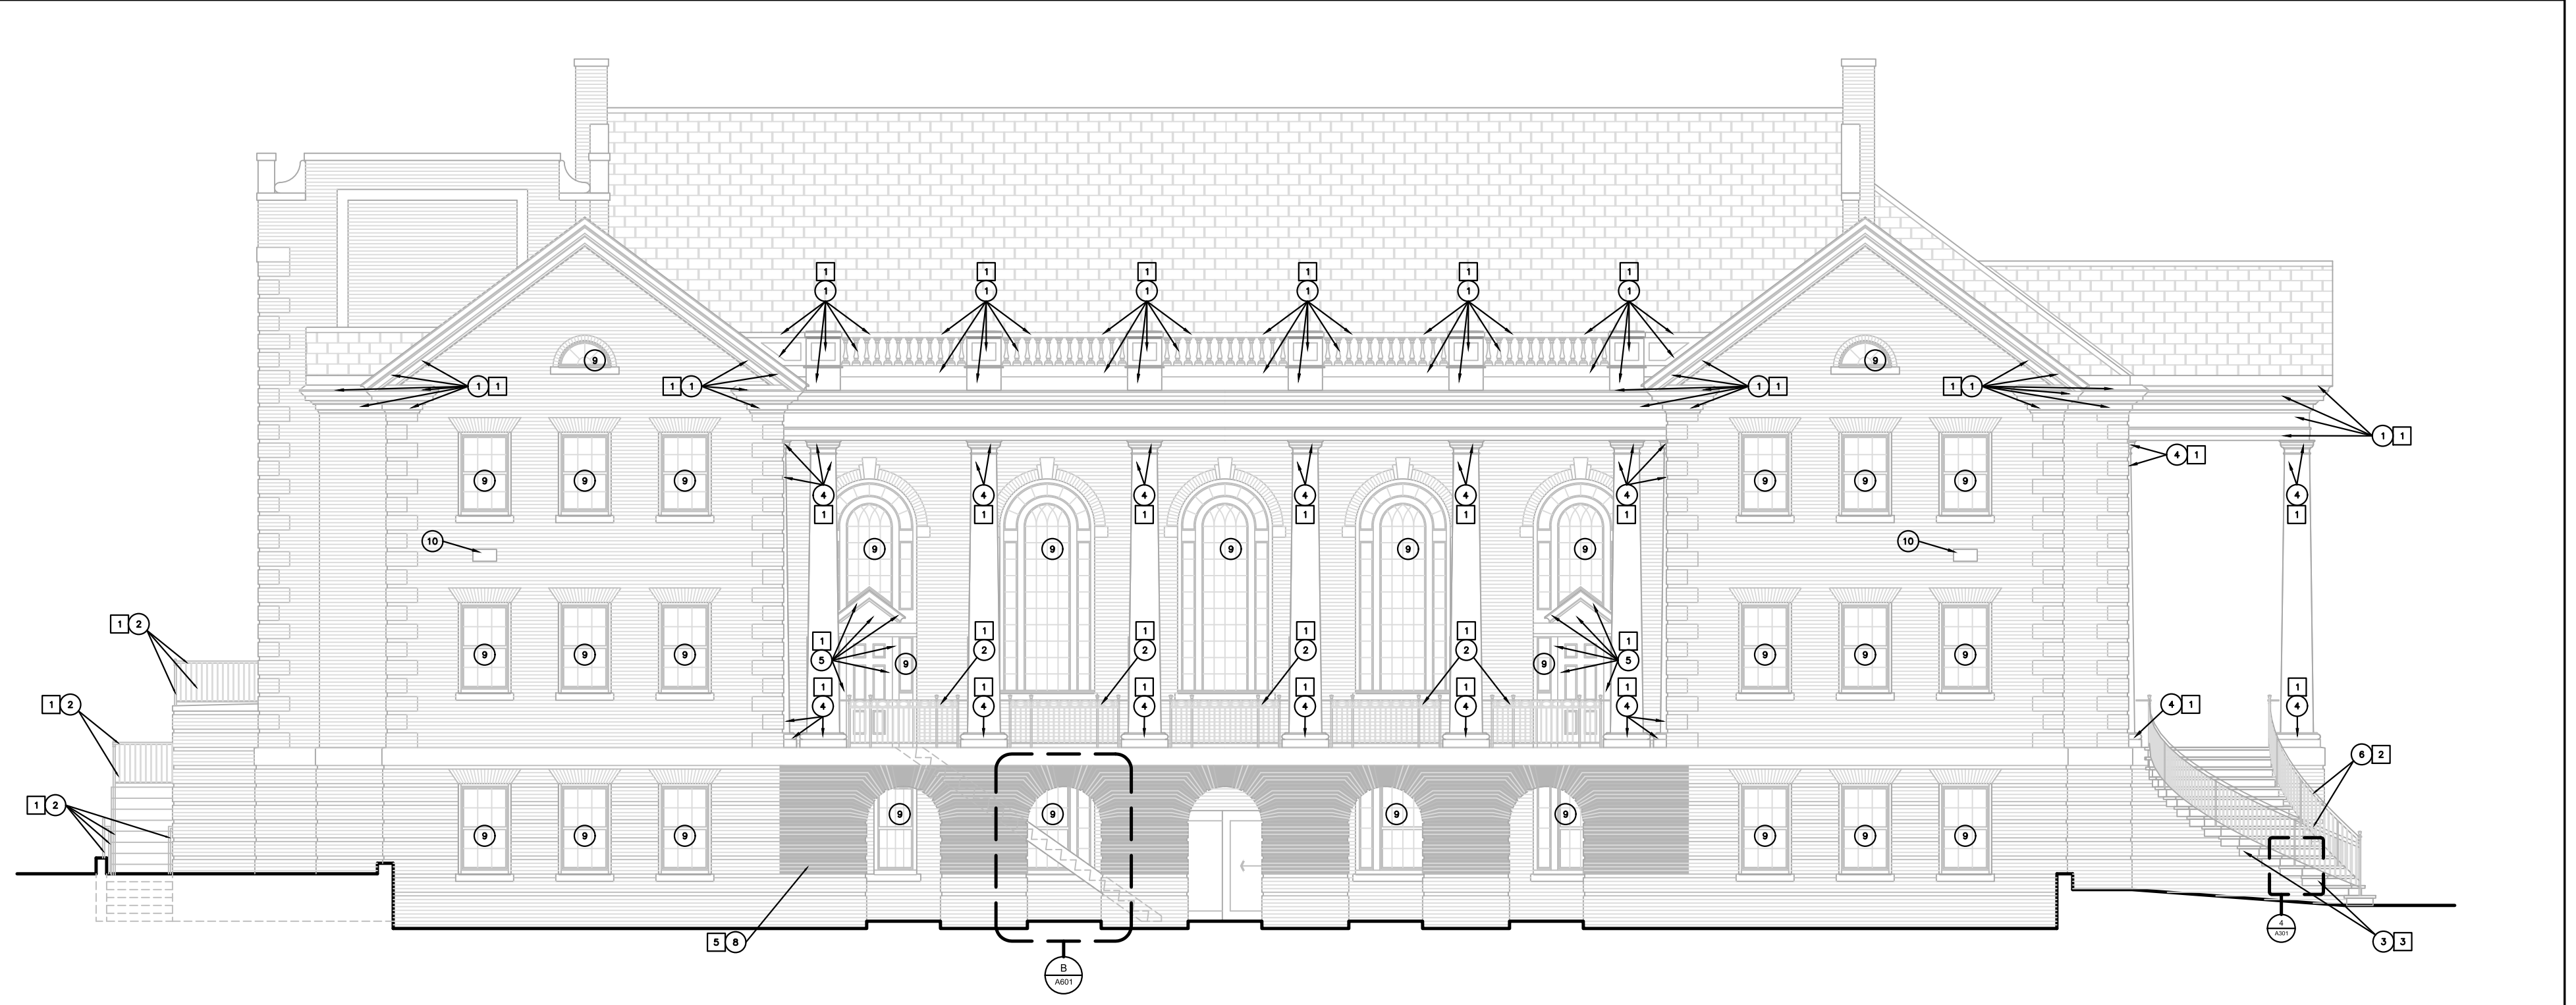

B SOUTH ELEVATION
1/2" = 1'-0"

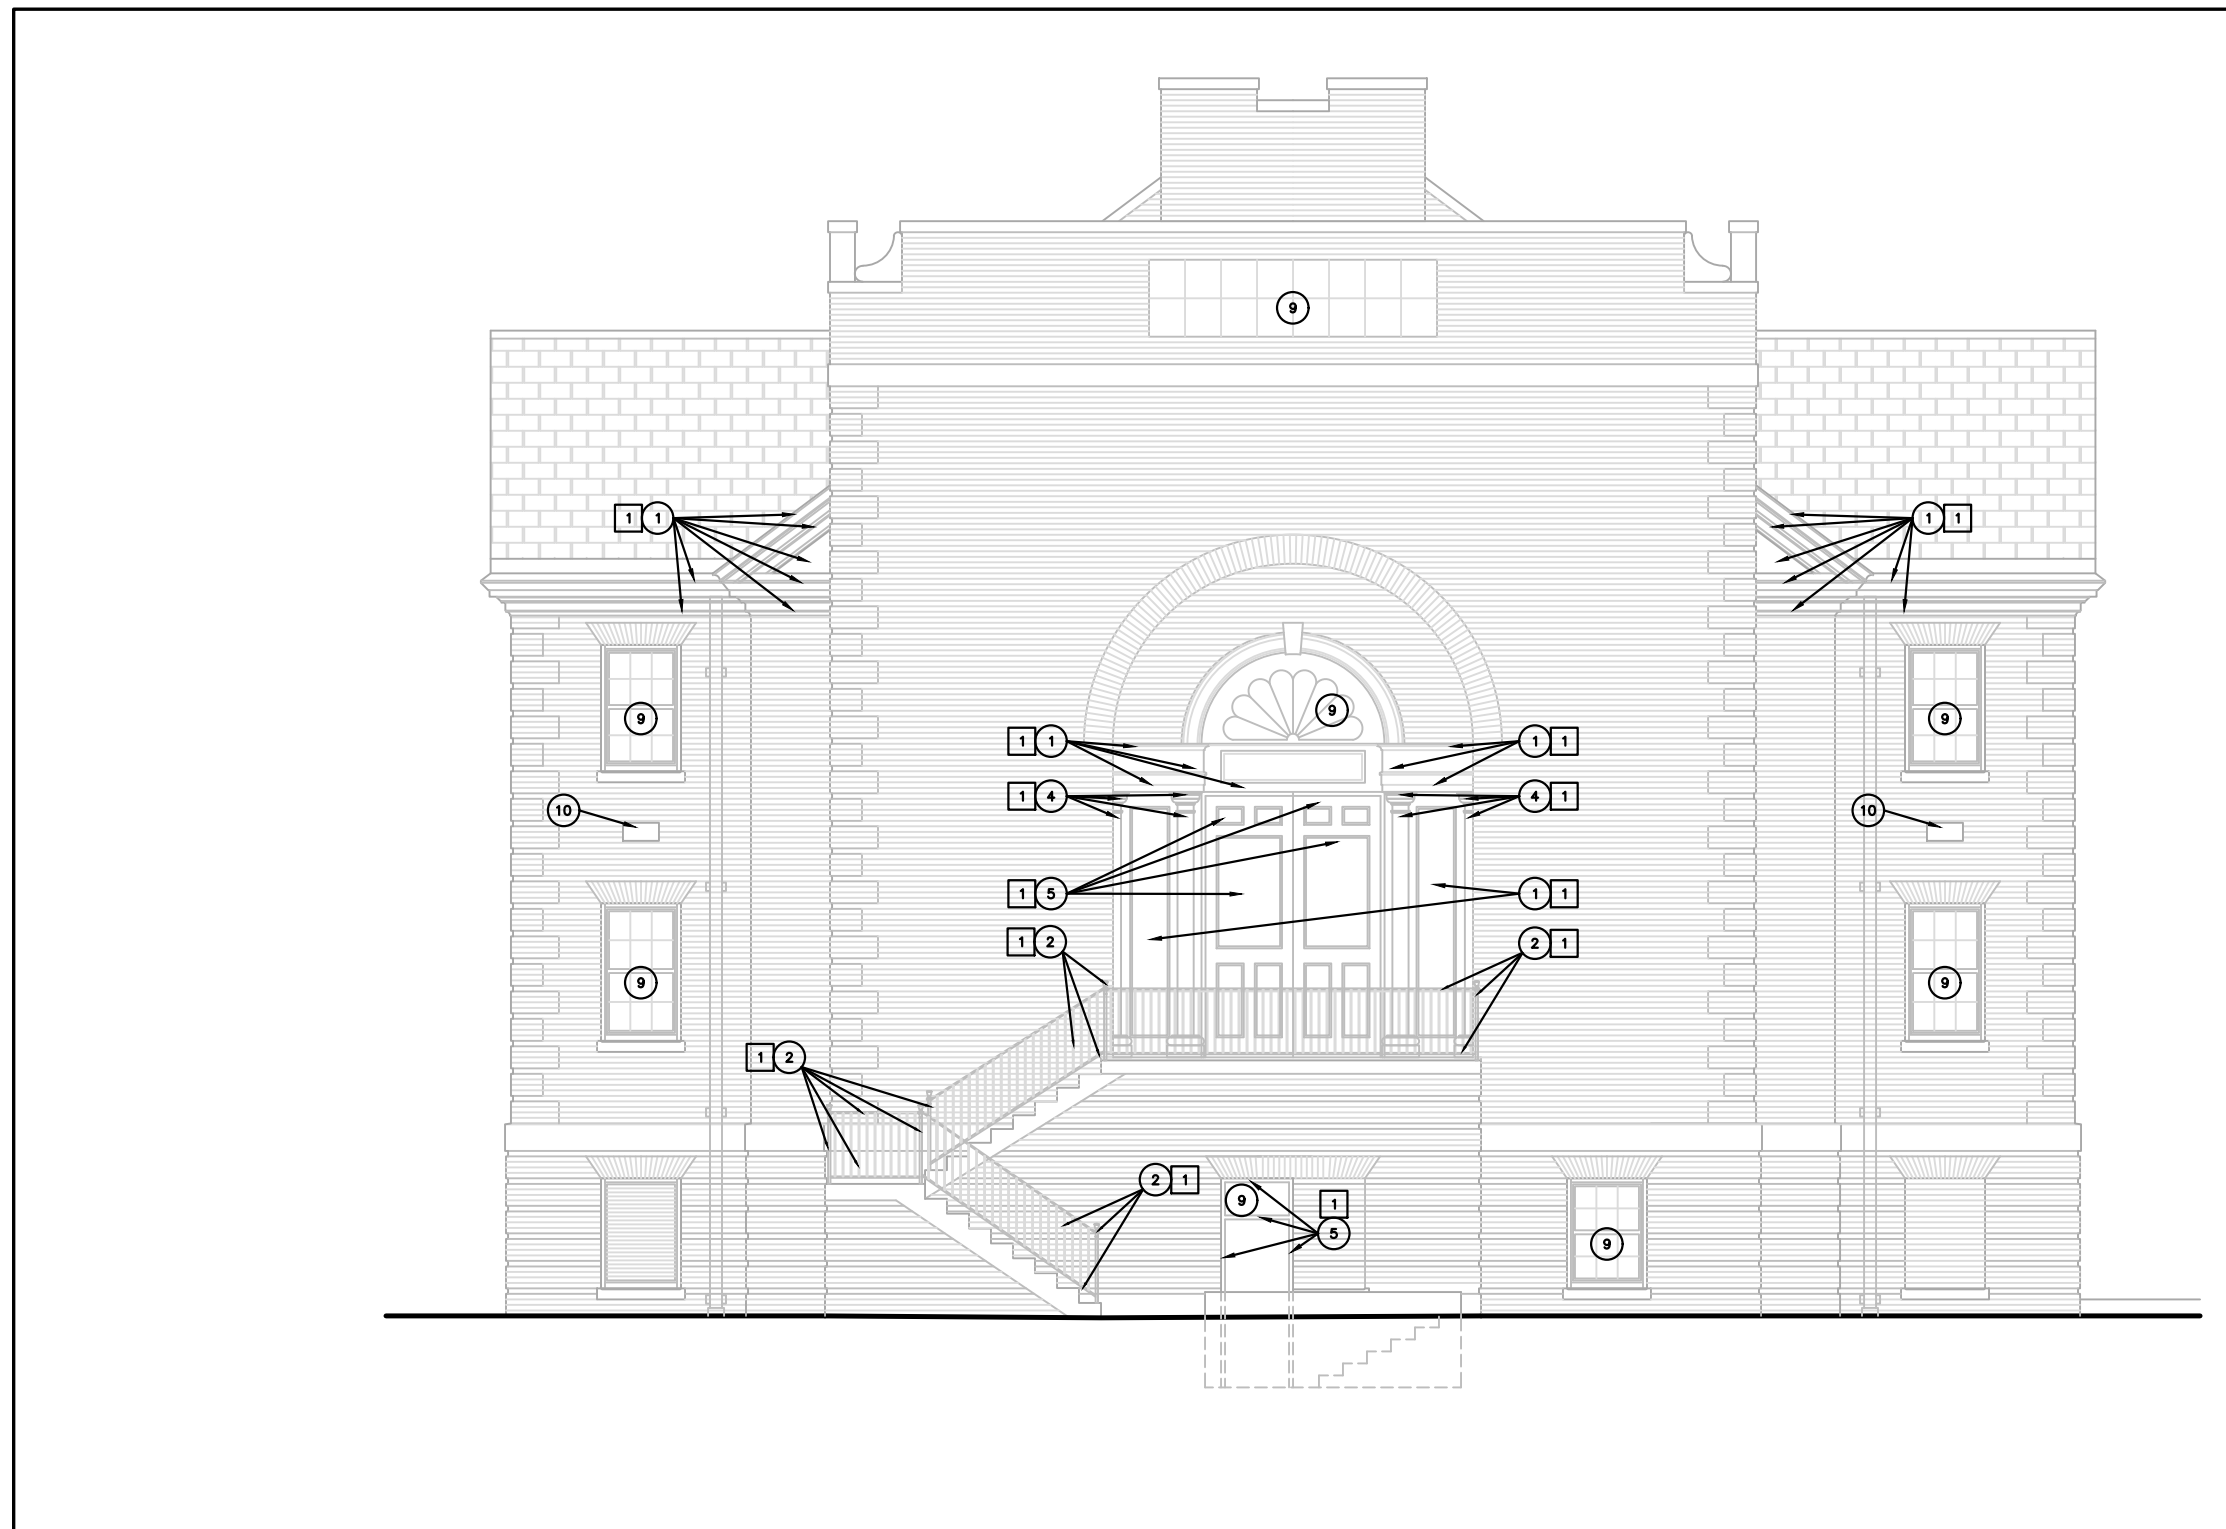

C WEST ELEVATION
1/2" = 1'-0"

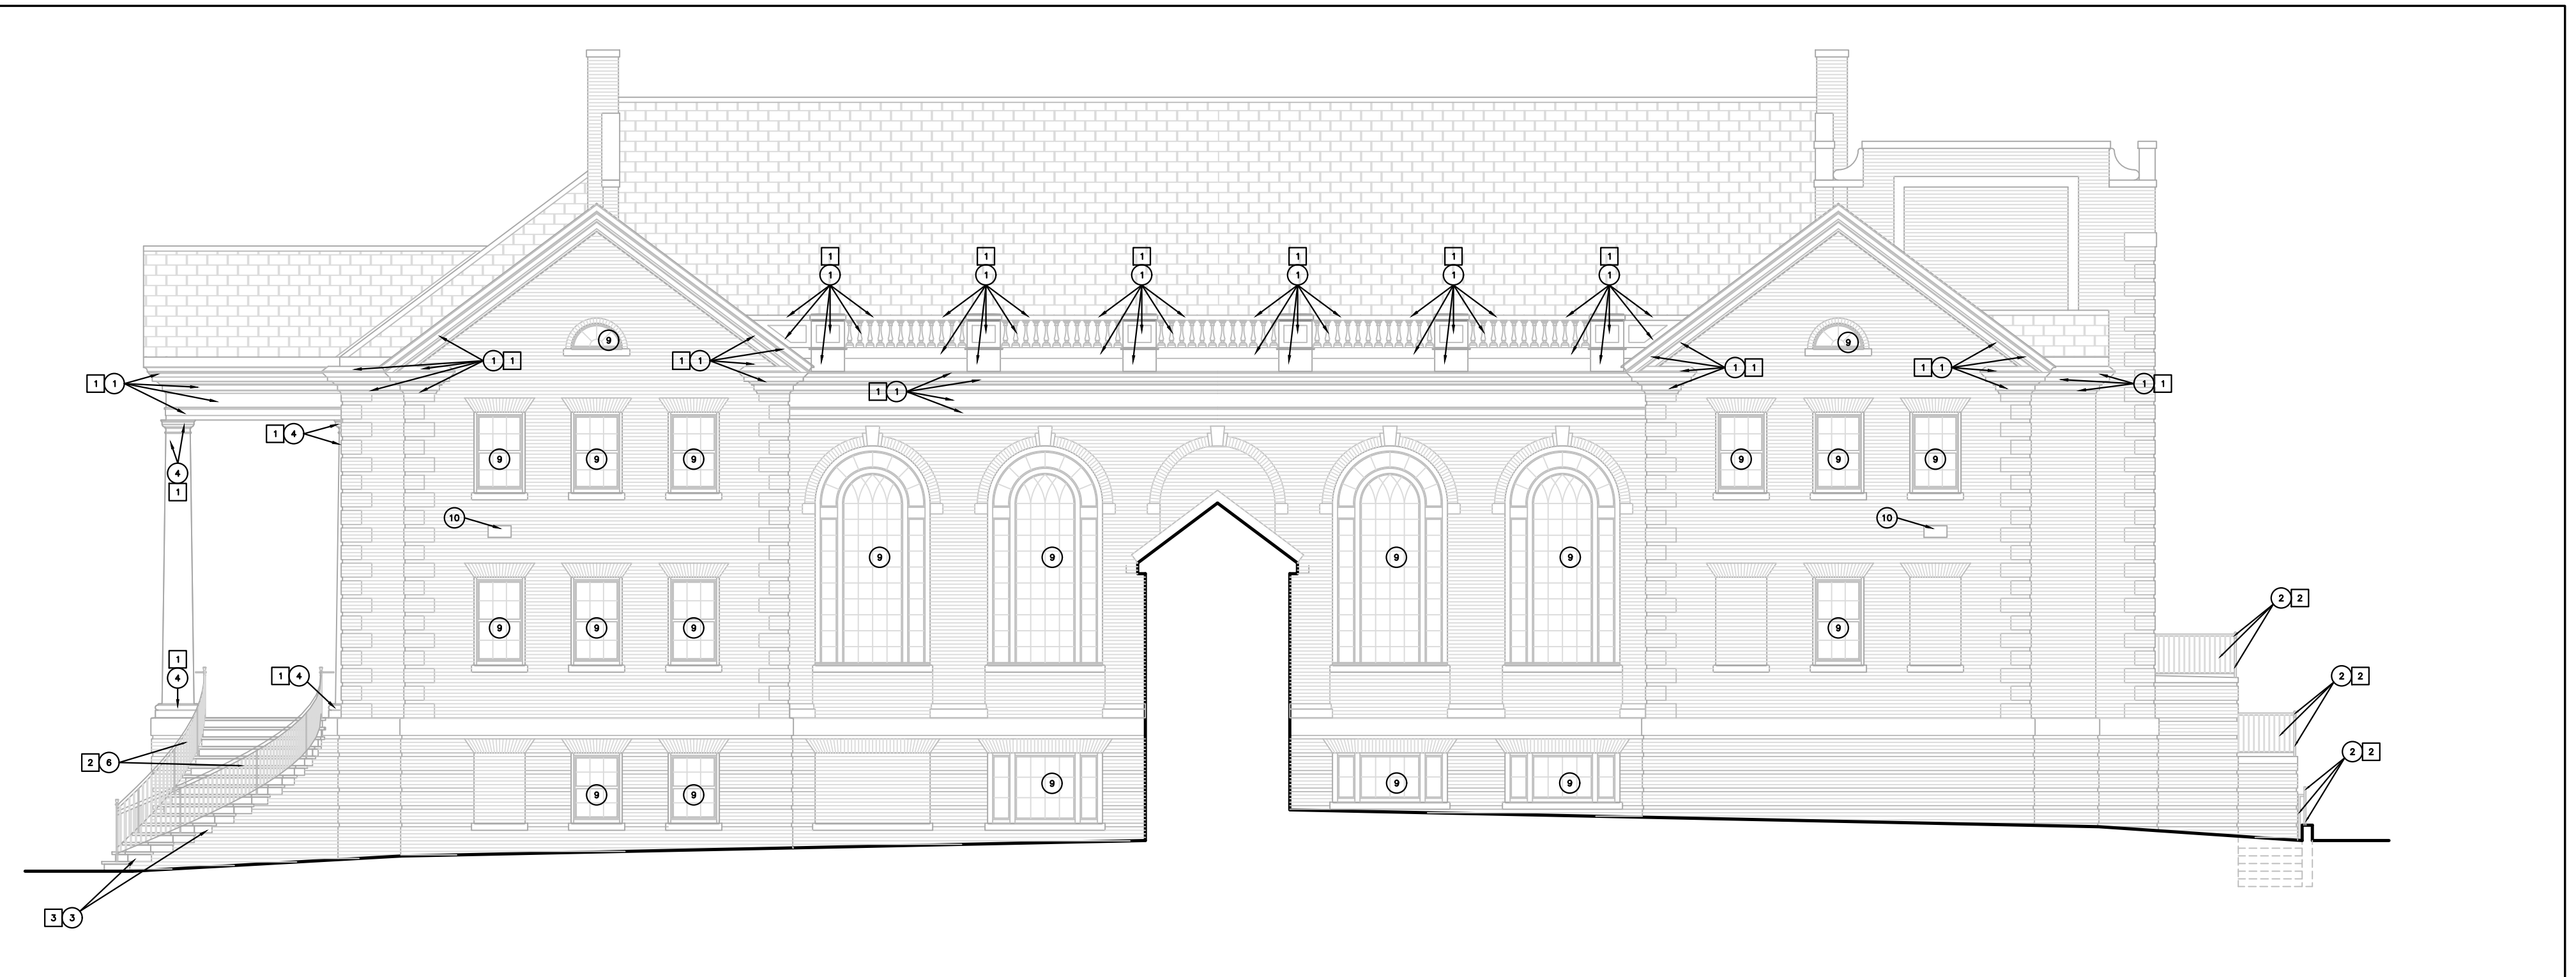


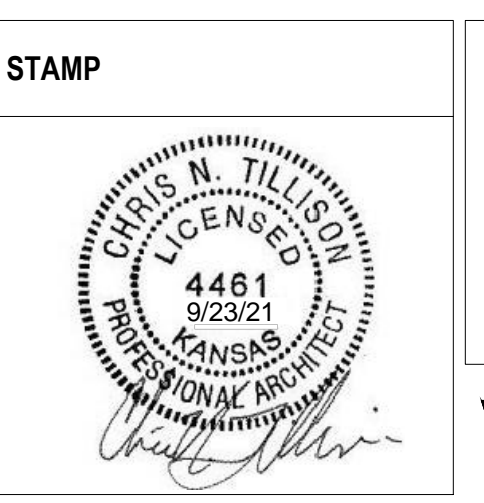
D NORTH ELEVATION
1/2" = 1'-0"

6/14/2009 12:39:03 PM

Revisions:	Date:

ARCHITECT/ENGINEER OF RECORD

 <p>3705 North 200th Street Elkhorn, Nebraska 68022 Phone: 402.291.6941</p>	 <p>165 S. Rock Island Suite 200 Wichita, KS 67202 (316) 634-1111</p>
--	--



Office of Construction and Facilities Management
VA U.S. Department of Veterans Affairs

Drawing Title
EXTERIOR ELEVATIONS

Approved: Project Director

Phase
BID DOCUMENTS

FULLY SPRINKLERED

Project Title
Renovate and Repair Structural, Building 4

Location
Wichita, KS

Issue Date
09/23/21



Checked
CNT

Drawn
RAG

Project Number
589A7-21-108

Building Number
4

Drawing Number
A-201

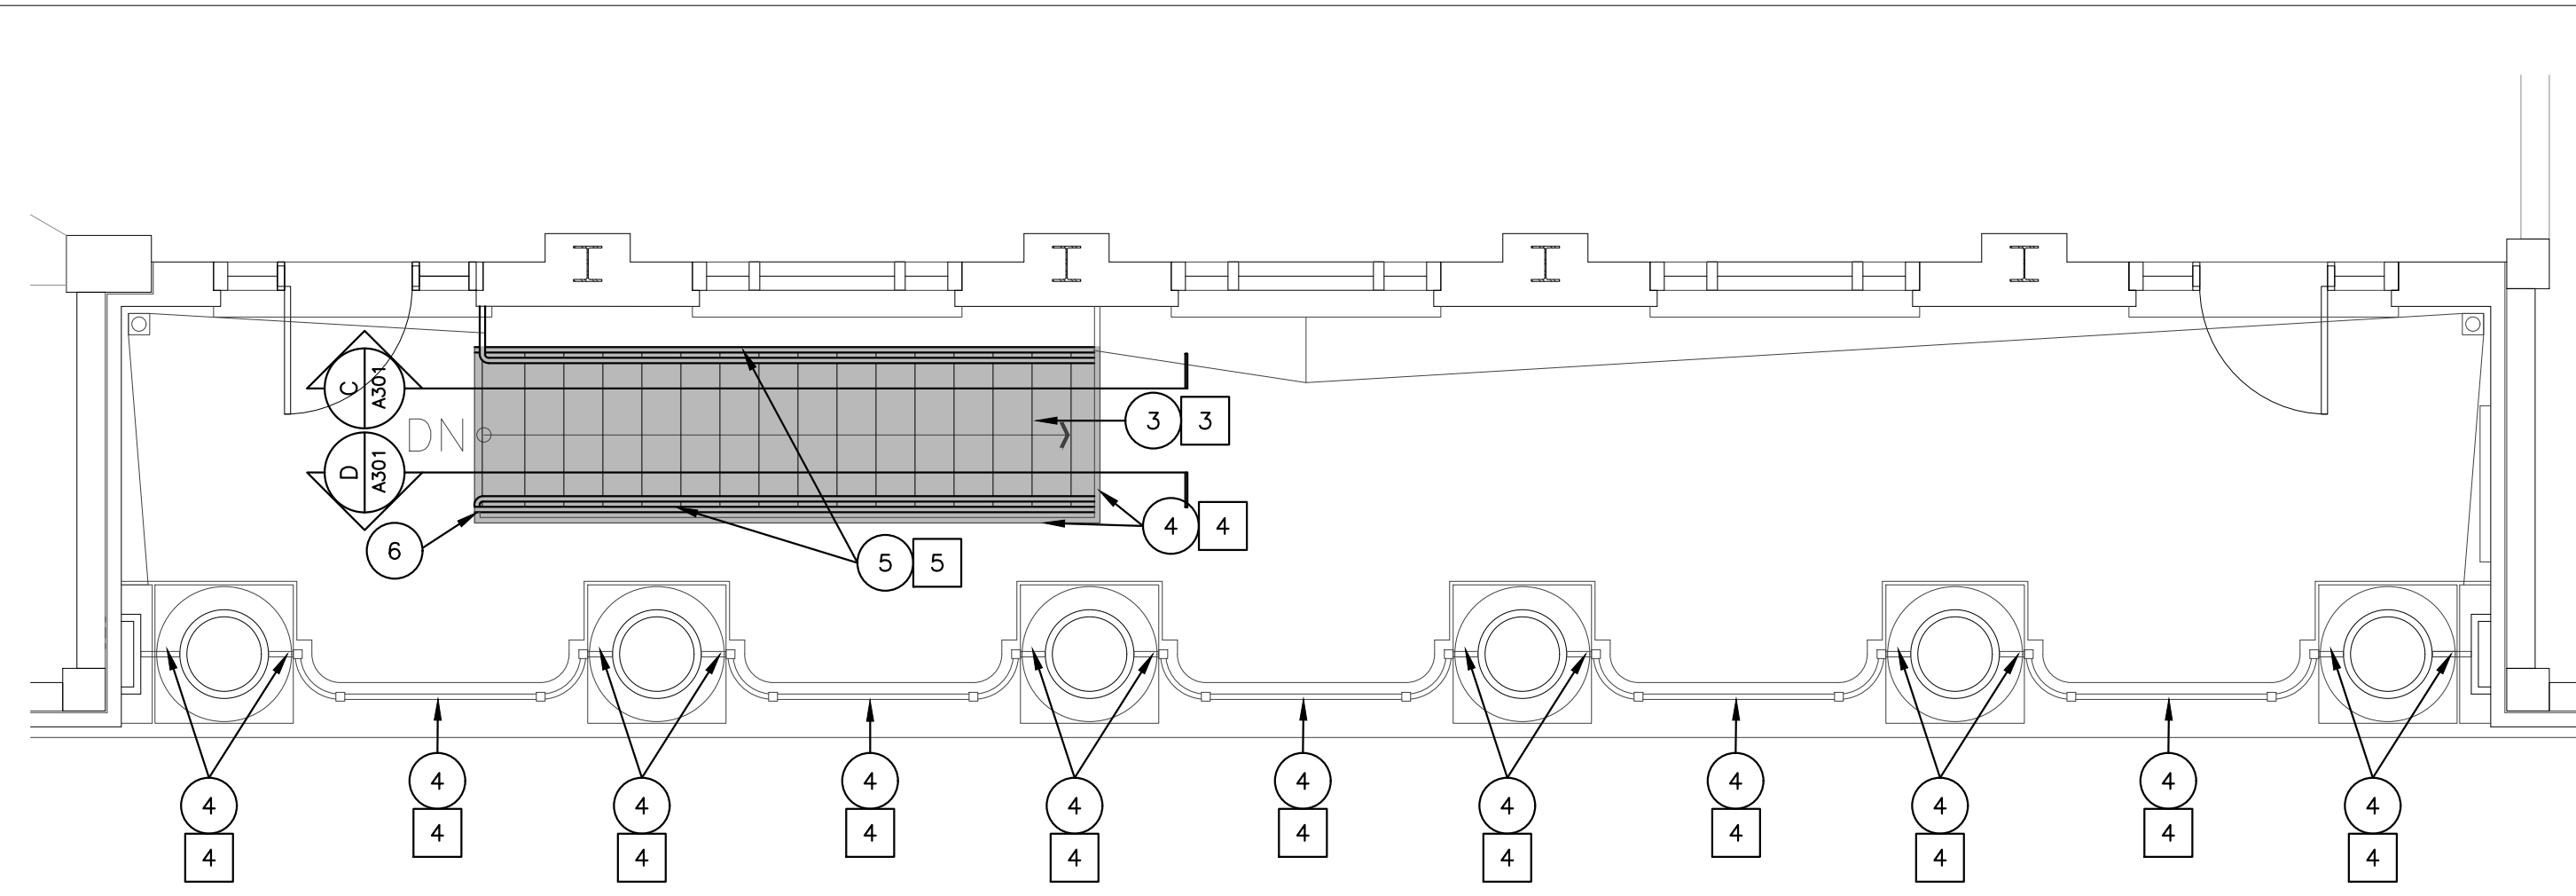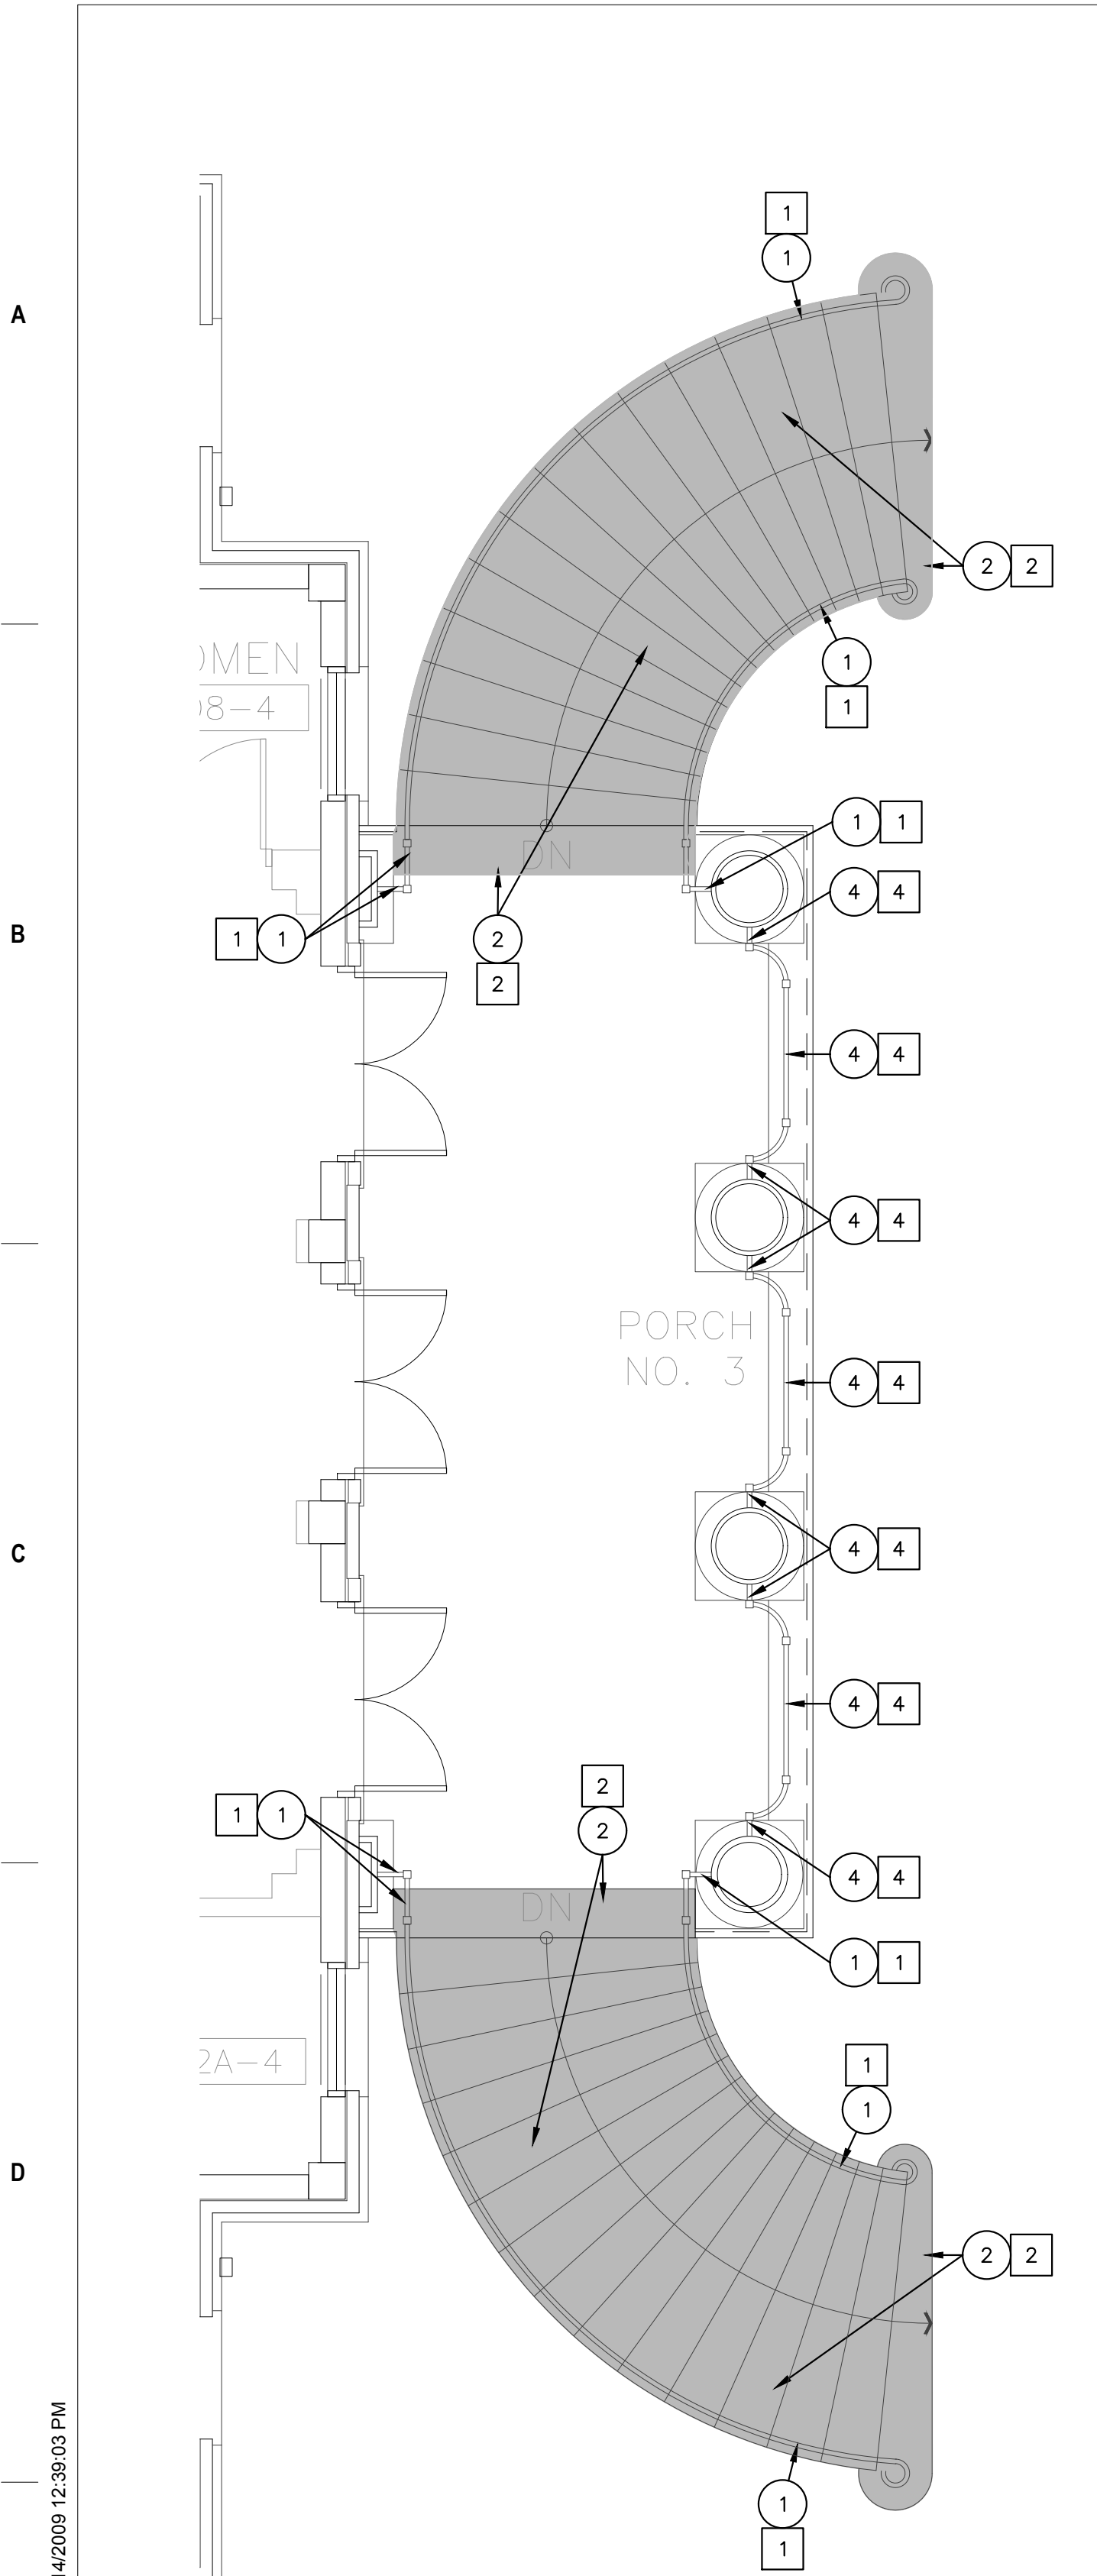

DEMOLITION NOTES

- 1 REMOVE WROUGHT IRON RAILING ON CURVED EAST STEPS, SALVAGE FOR REINSTALLATION. SCRAPE OFF LOOSE PAINT.
- 2 REMOVE ALL CAST STONE STAIR TREADS
- 3 REMOVE SOUTH EXTERIOR STAIR AND RAILING, PREPARE FOR NEW STEEL STAIR.
- 4 SCRAPE OFF LOOSE PAINT ON BALCONY RAILING.


PLAN NOTES

- 1 PRIME BASE METAL PER SPECS. REPAINT ALL SURFACES OF RAILING TO MATCH EXISTING. REINSTALL INTO NEW CAST STONE TREADS PER DETAIL 4/A301.
- 2 INSTALL NEW CAST STONE TREADS, REF. SPECS. FIELD VERIFY SIZE TO MATCH EXISTING- USE EXISTING STAIR AS A TEMPLATE.
- 3 INSTALL NEW STEEL AND CONCRETE STAIRS. SEE SECTIONS C & D/A301, ELEVATION E/A301, AND DETAILS 3,5,6/A301
- 4 PRIME BASE METAL PER SPECS. REPAINT ALL SURFACES OF BALCONY RAILING TO MATCH EXISTING.
- 5 INSTALL NEW STEEL STAIR RAILING. SEE DETAILS 1 & 2/A301.
- 6 WELD NEW STEEL STAIR RAILING TO EXISTING STEEL BALCONY RAILING. SEE DETAIL 3/A301.




GENERAL NOTES

1. PROTECT MATERIALS TO REMAIN DURING CONSTRUCTION.
2. PROTECT BUILDING SIDING, SIDEWALKS, LAWNS, ETC. DURING CONSTRUCTION.
3. MAINTAIN, PROTECT, AND RESET EXISTING METAL CURB FLASHING AND OTHER METAL OR ALUMINUM FLASHINGS FOR REUSE, UNLESS OTHERWISE NOTED.
4. FIELD VERIFY ALL DIMENSIONS.

LEGEND

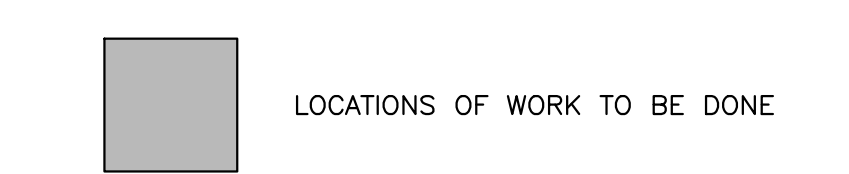


A SOUTH EXTERIOR STAIRS
1/4" = 1'-0" FIRST LEVEL

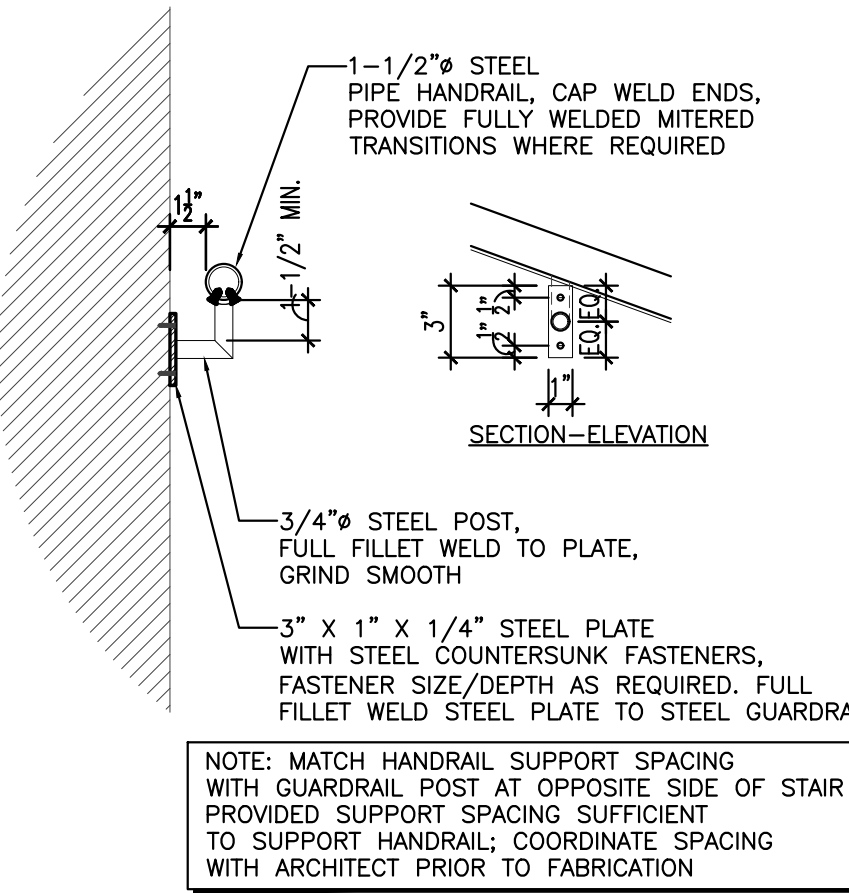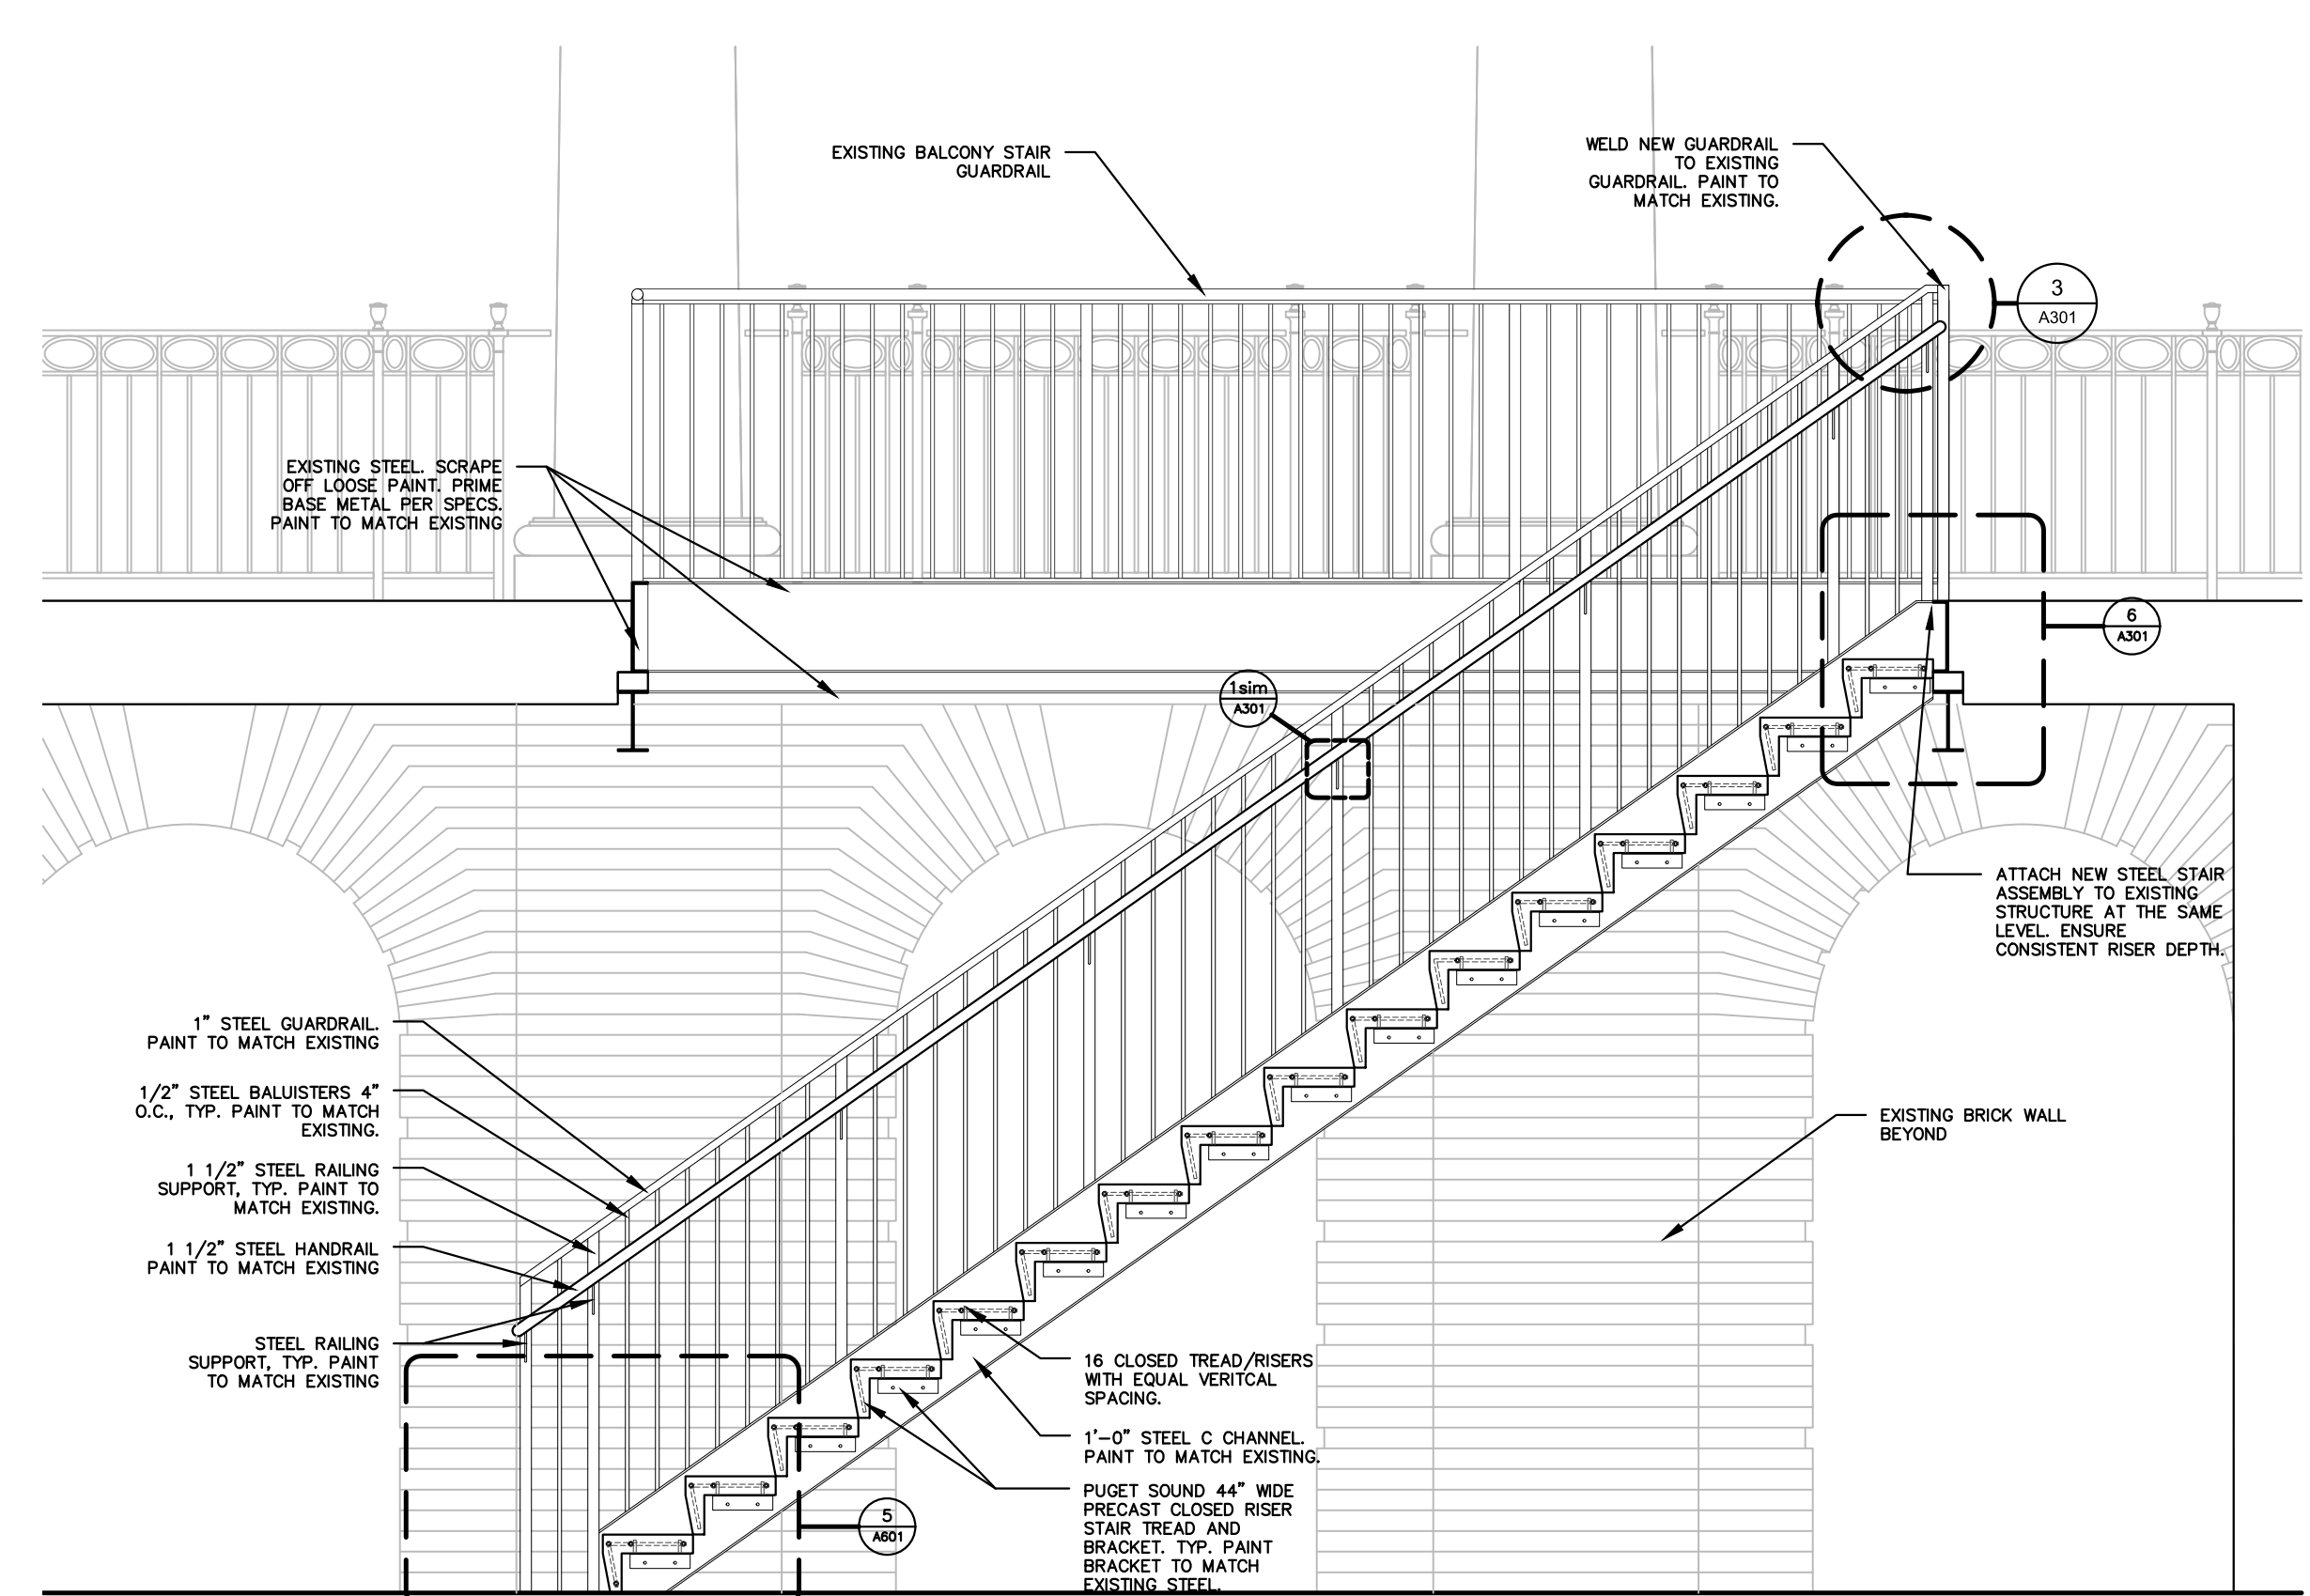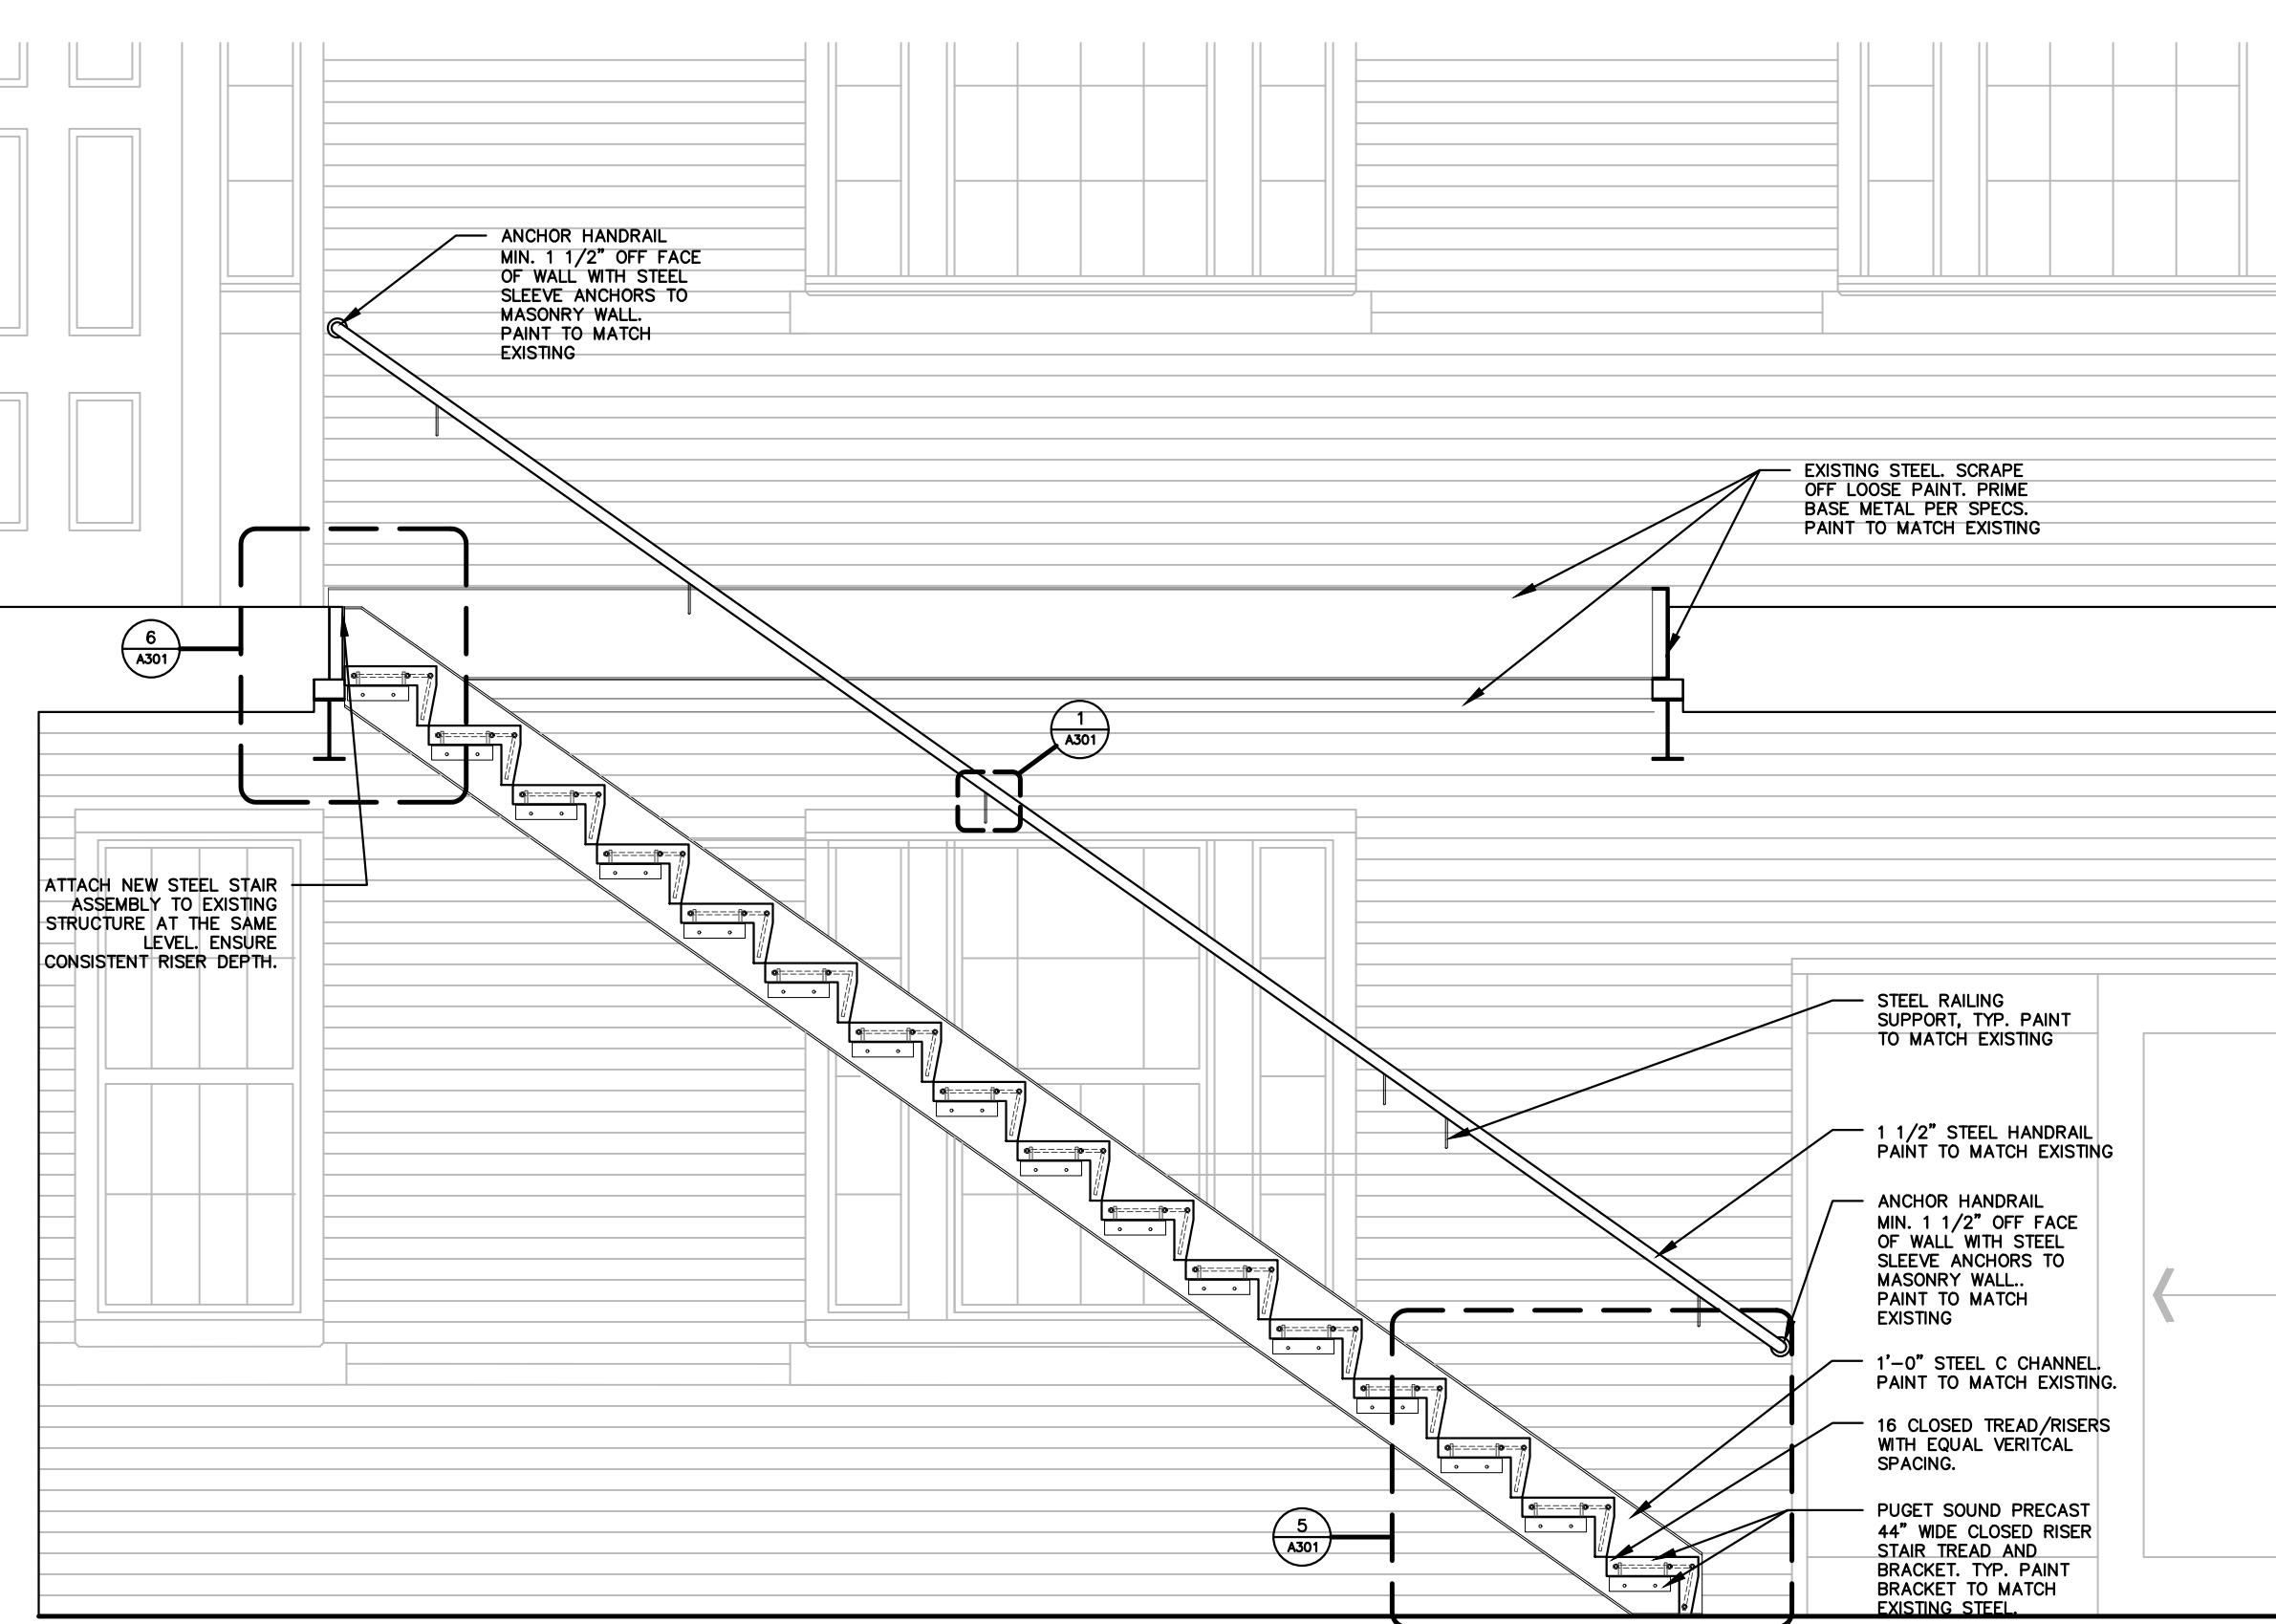


1 ELEVATION AND SECTION @ WALL HANDRAIL
1/2" = 1'-0"

C STAIR SECTION
1/2" = 1'-0" NORTH-FACING


D STAIR SECTION
1/2" = 1'-0" SOUTH-FACING

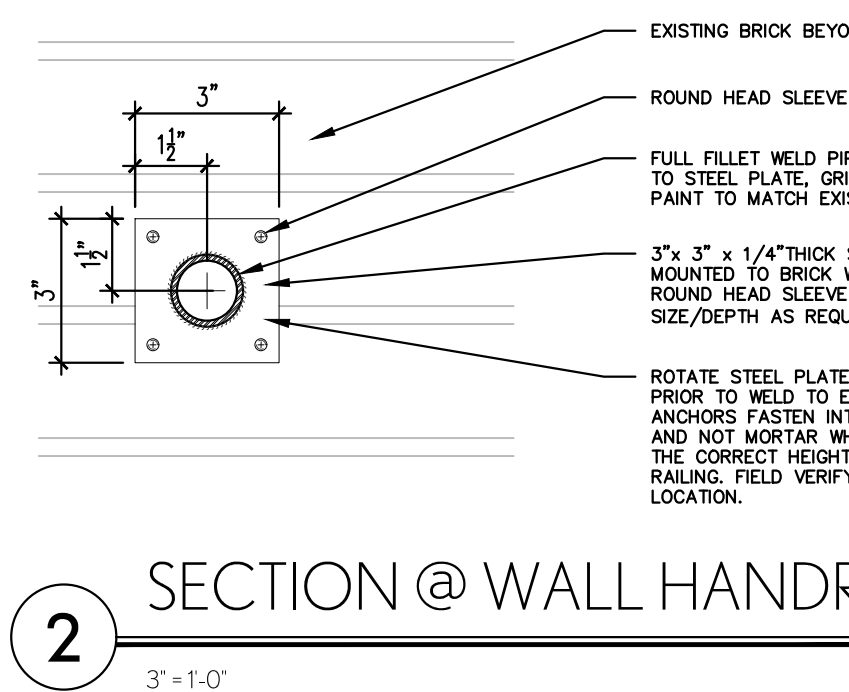


2 SECTION @ WALL HANDRAIL
3" = 1'-0"

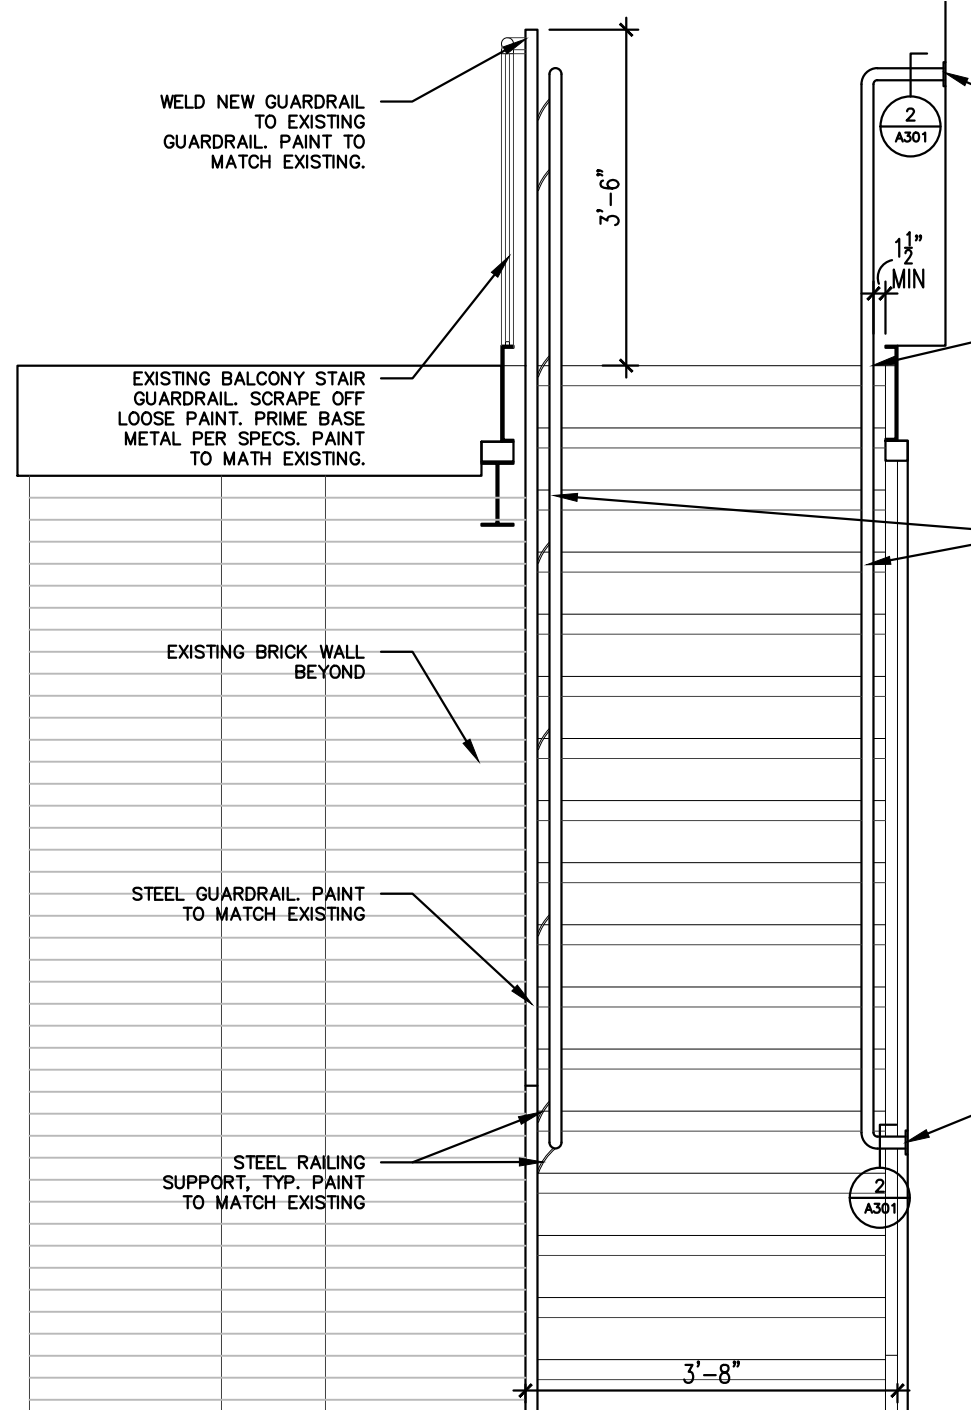

E STAIR ELEVATION
1/2" = 1'-0" WEST-FACING

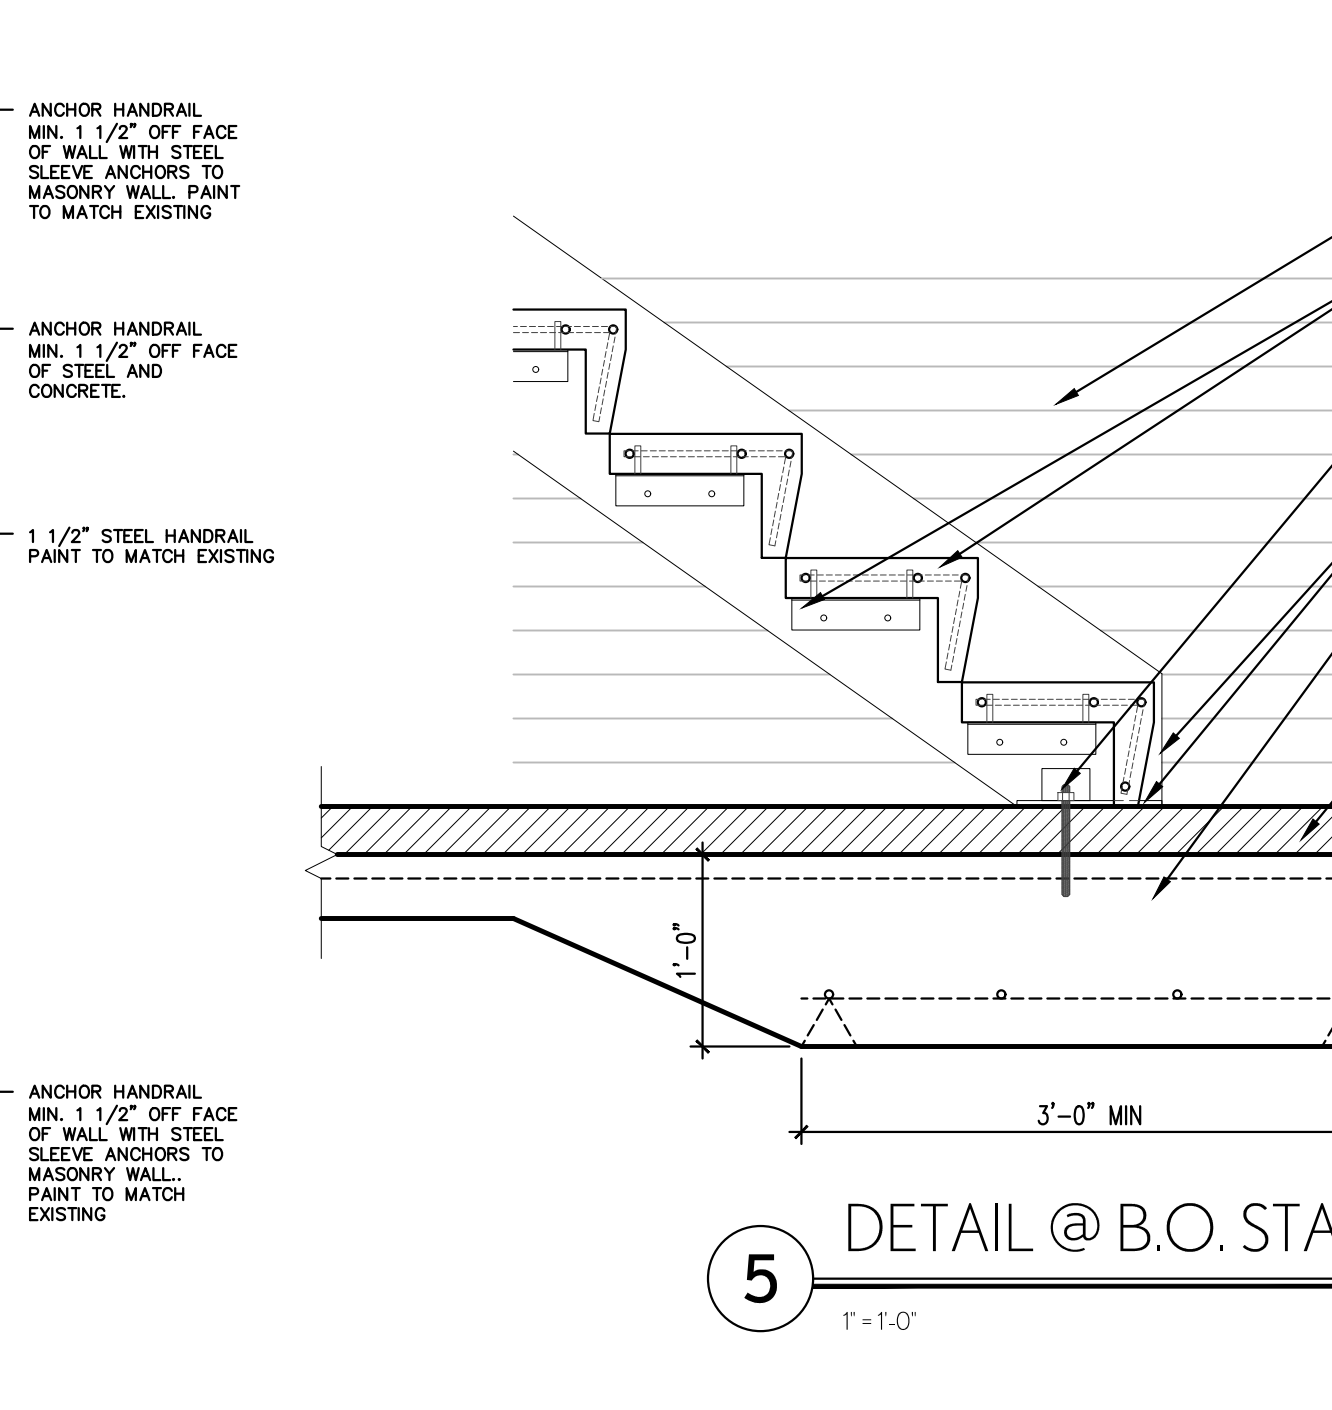


5 DETAIL @ B.O. STAIR
1" = 1'-0"

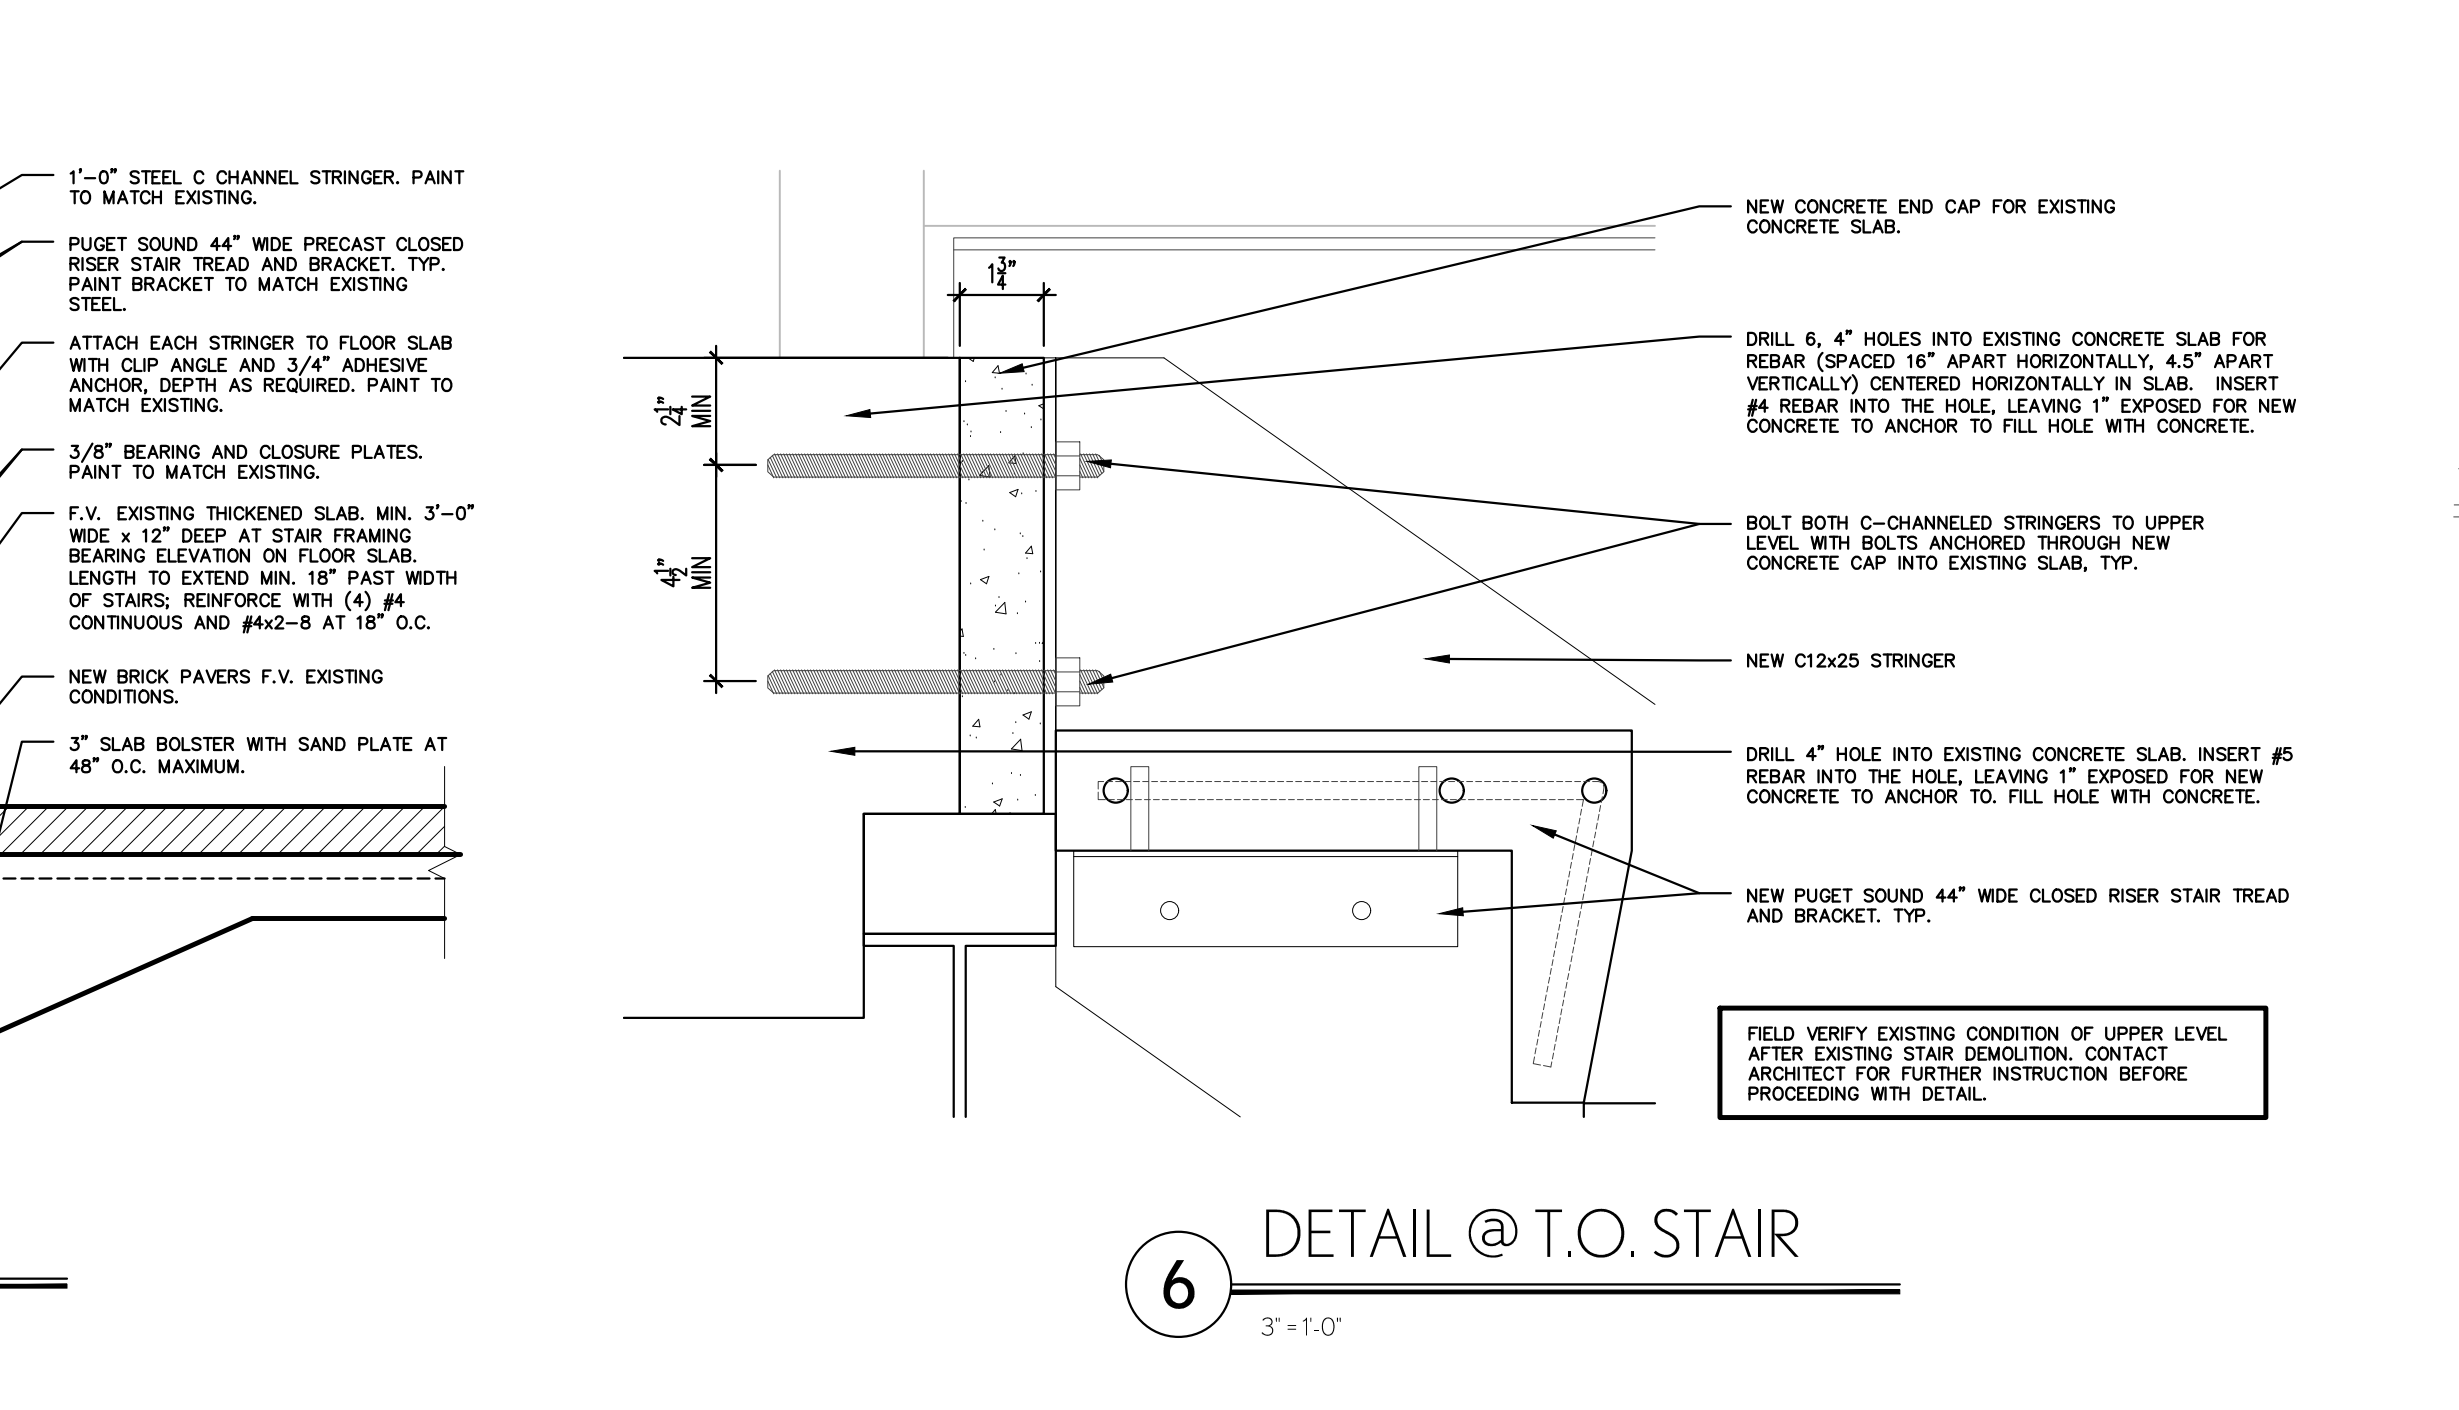


6 DETAIL @ T.O. STAIR
3" = 1'-0"

B FRONT CURVED STAIRS
1/4" = 1'-0" FIRST LEVEL

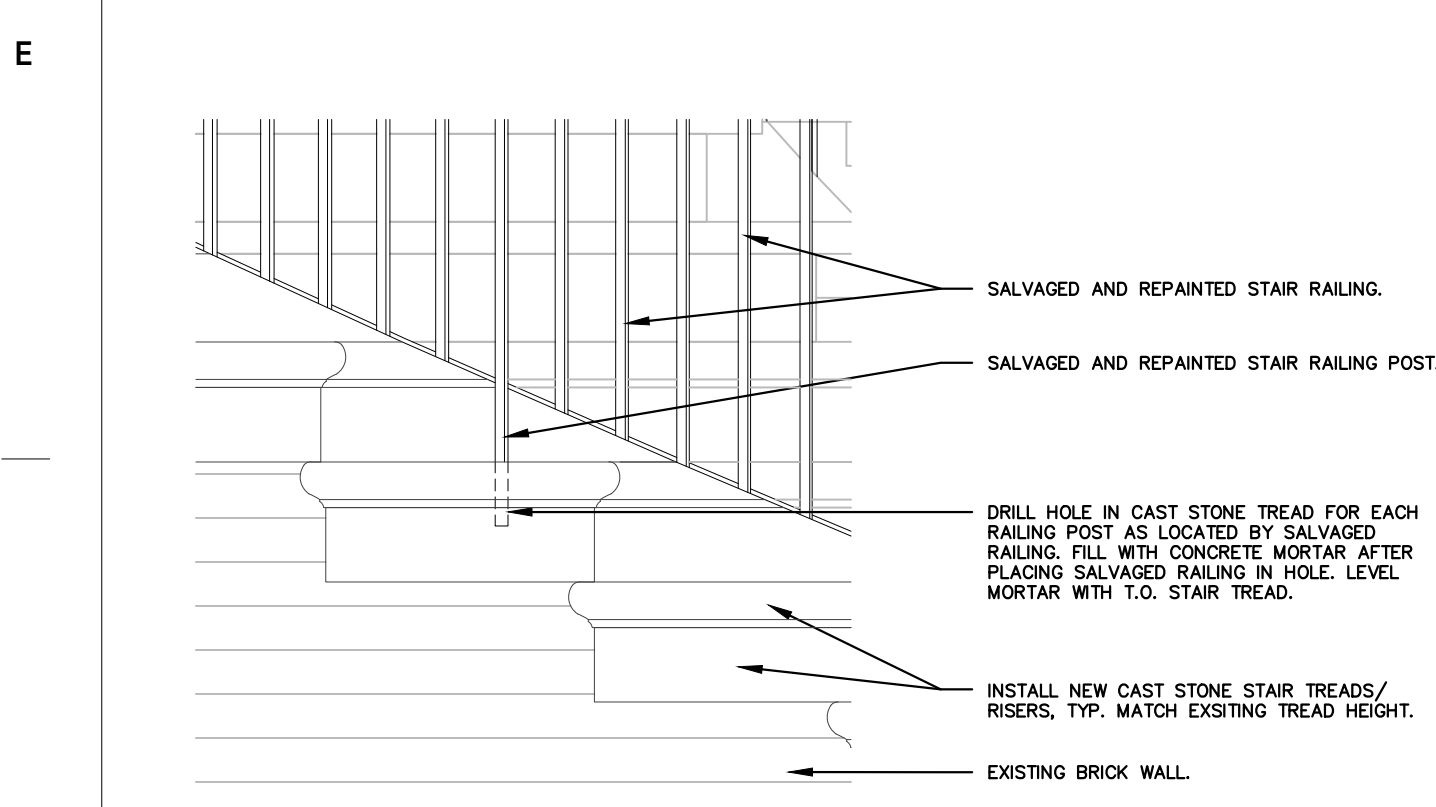

4 DETAIL @ CAST STONE STAIR
1" = 1'-0"

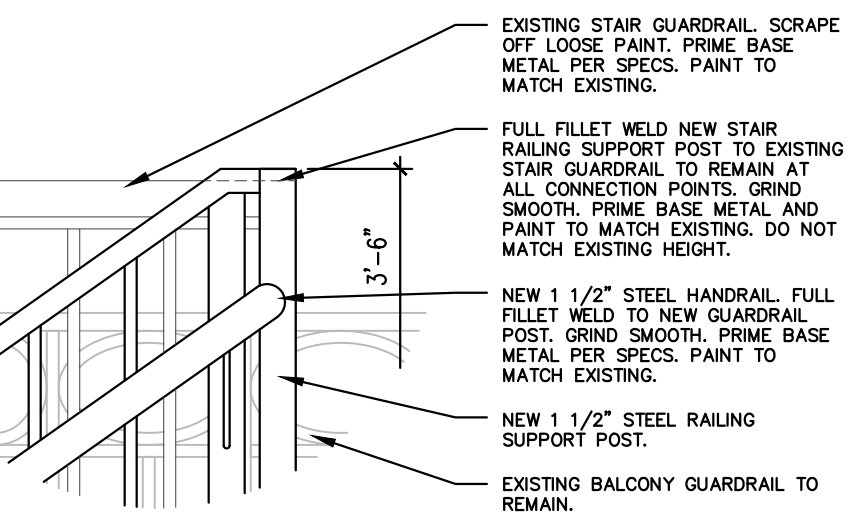

3 DETAIL @ T.O. STAIR
1/2" = 1'-0"

Revisions:	Date:

ARCHITECT/ENGINEER OF RECORD

ALESIA
ARCHITECTURE

3705 North 200th Street
Elkhorn, Nebraska 68022
Phone: 402 291 6941

Alloy
ARCHITECTURE

165 S. Rock Island Suite 200
Wichita, KS 67202
(316) 634-1111

STAMP

Office of Construction and Facilities Management
VA U.S. Department of Veterans Affairs

Drawing Title
ENLARGED PLANS & STAIR DETAILS

Approved: Project Director

Phase
BID DOCUMENTS

FULLY SPRINKLERED

Project Title
Renovate and Repair Structural, Building 4

Location
Wichita, KS

Issue Date
09/23/2021


Checked
CNT

Drawn
RAG


Project Number
589A7-21-108

Building Number
4


Drawing Number
A-301

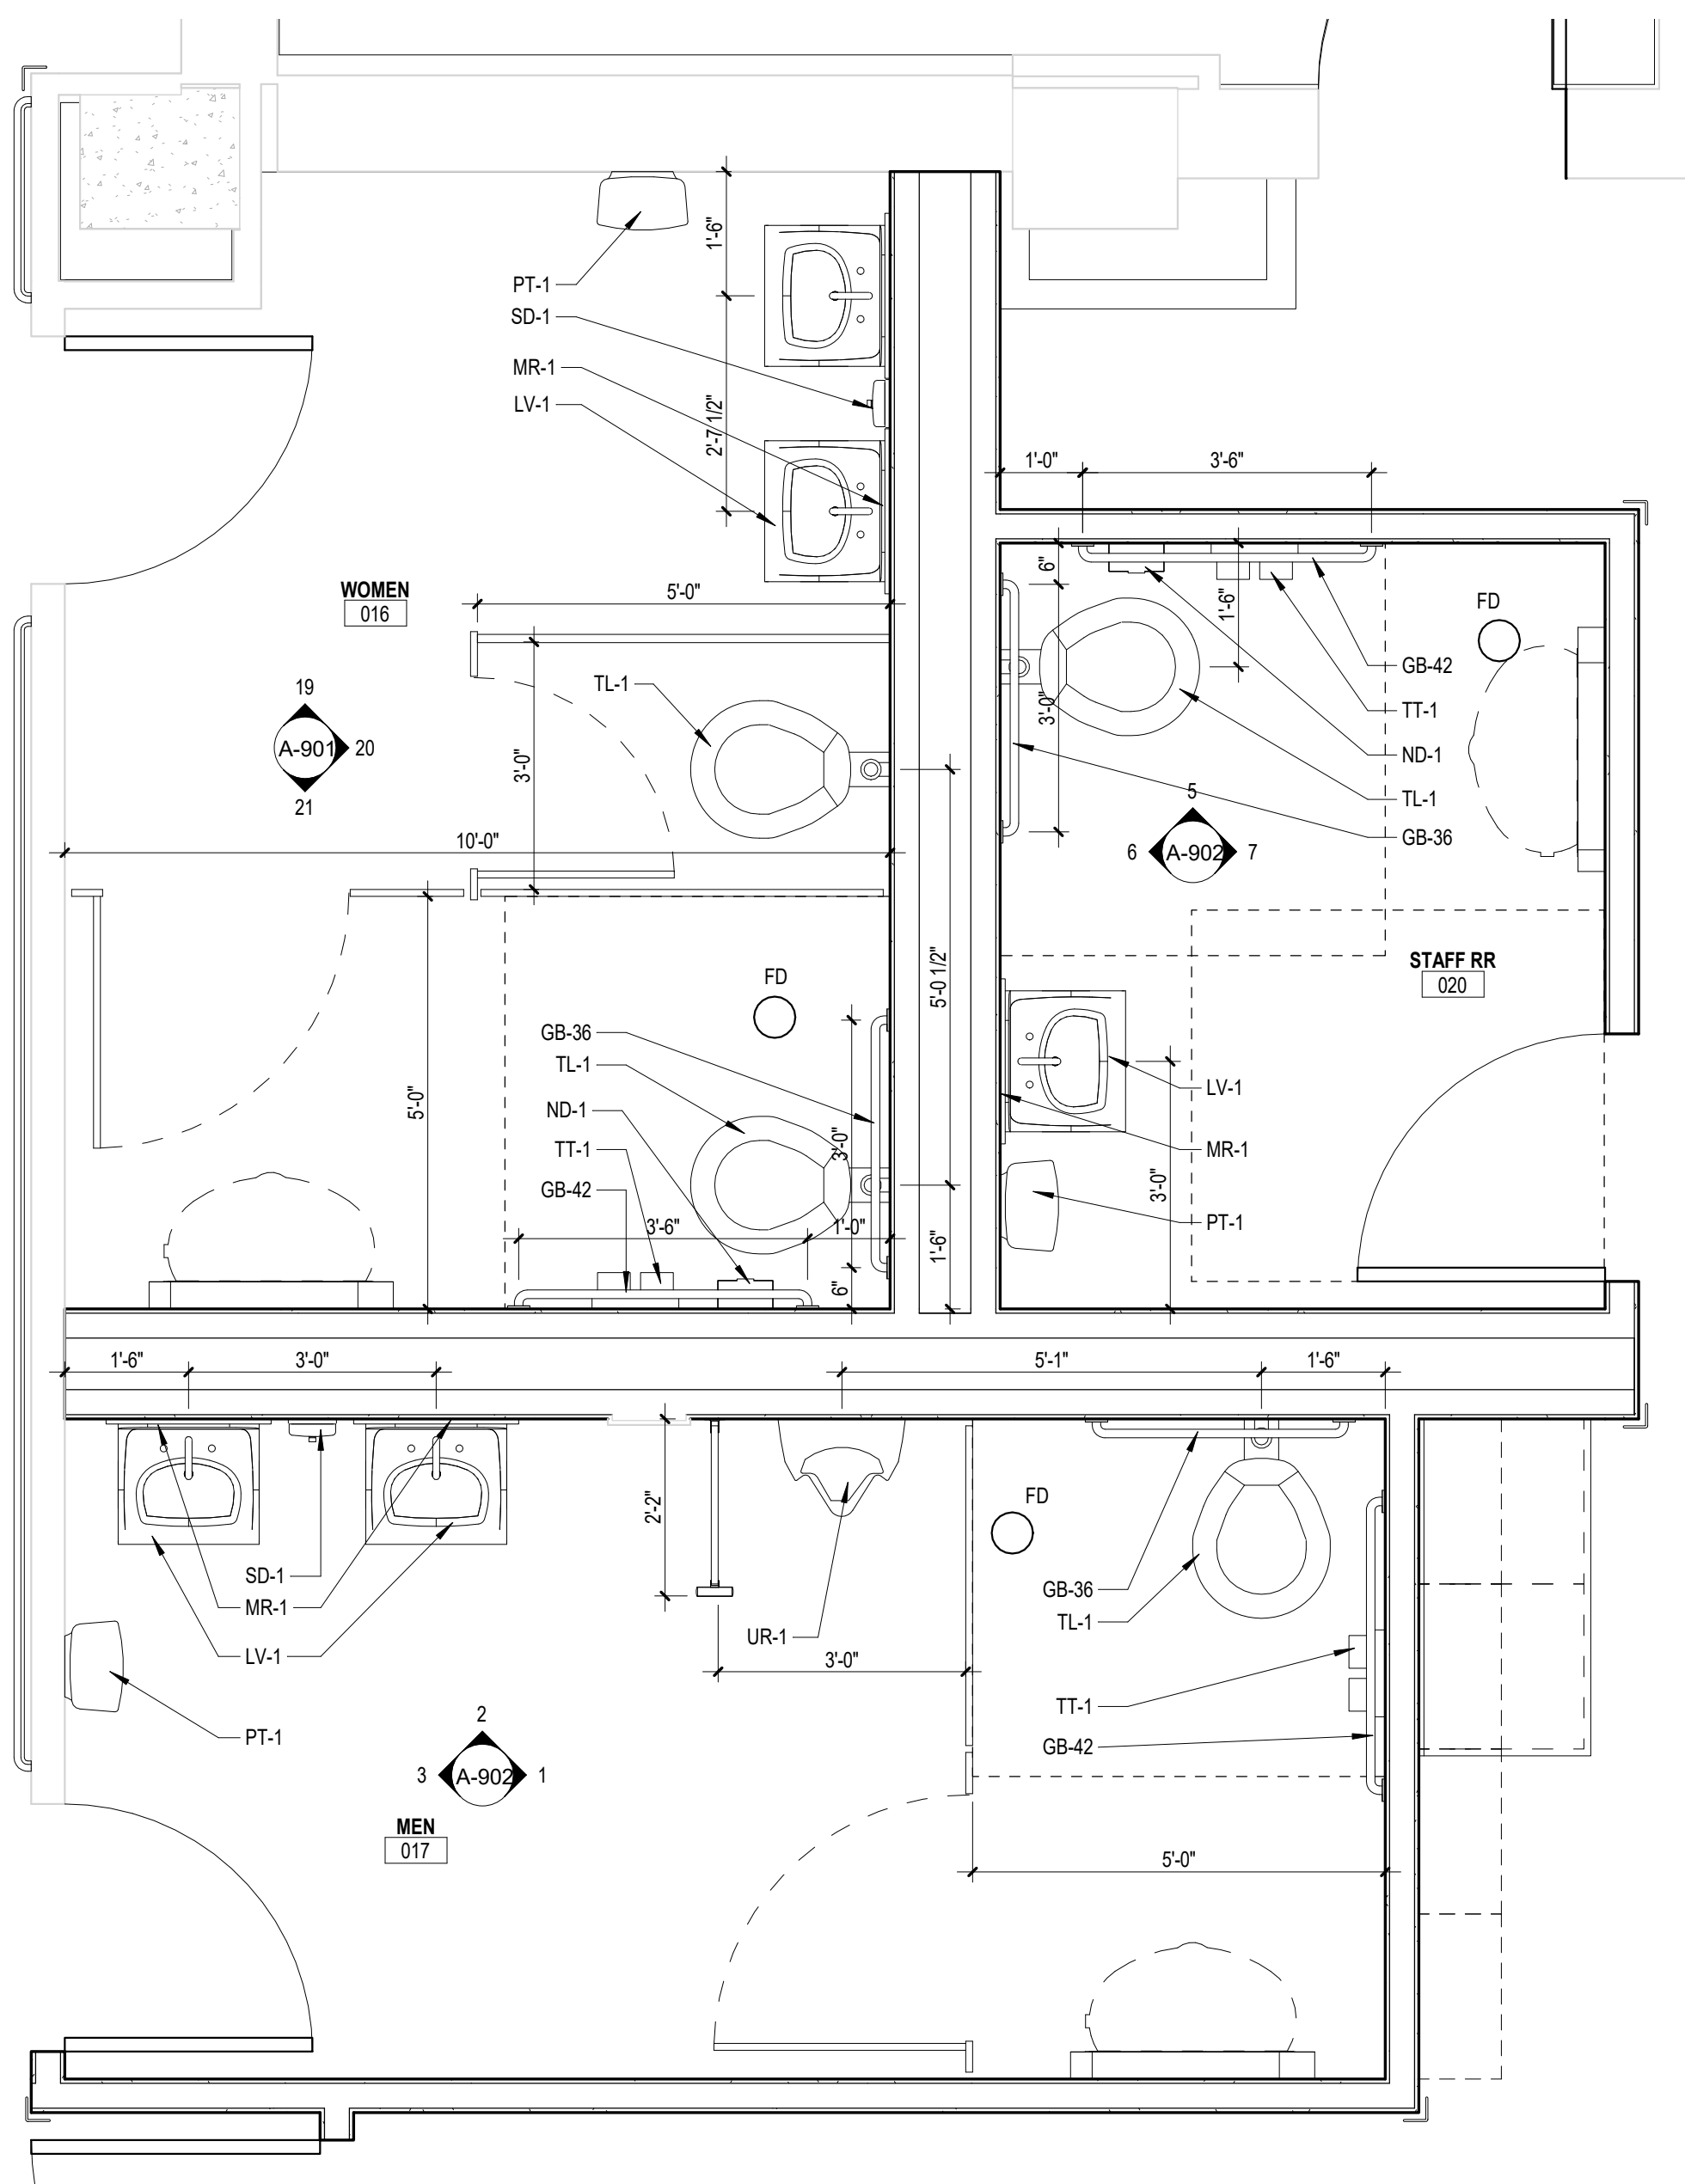

1 BASEMENT - RESTROOMS
1/2" = 1'-0"

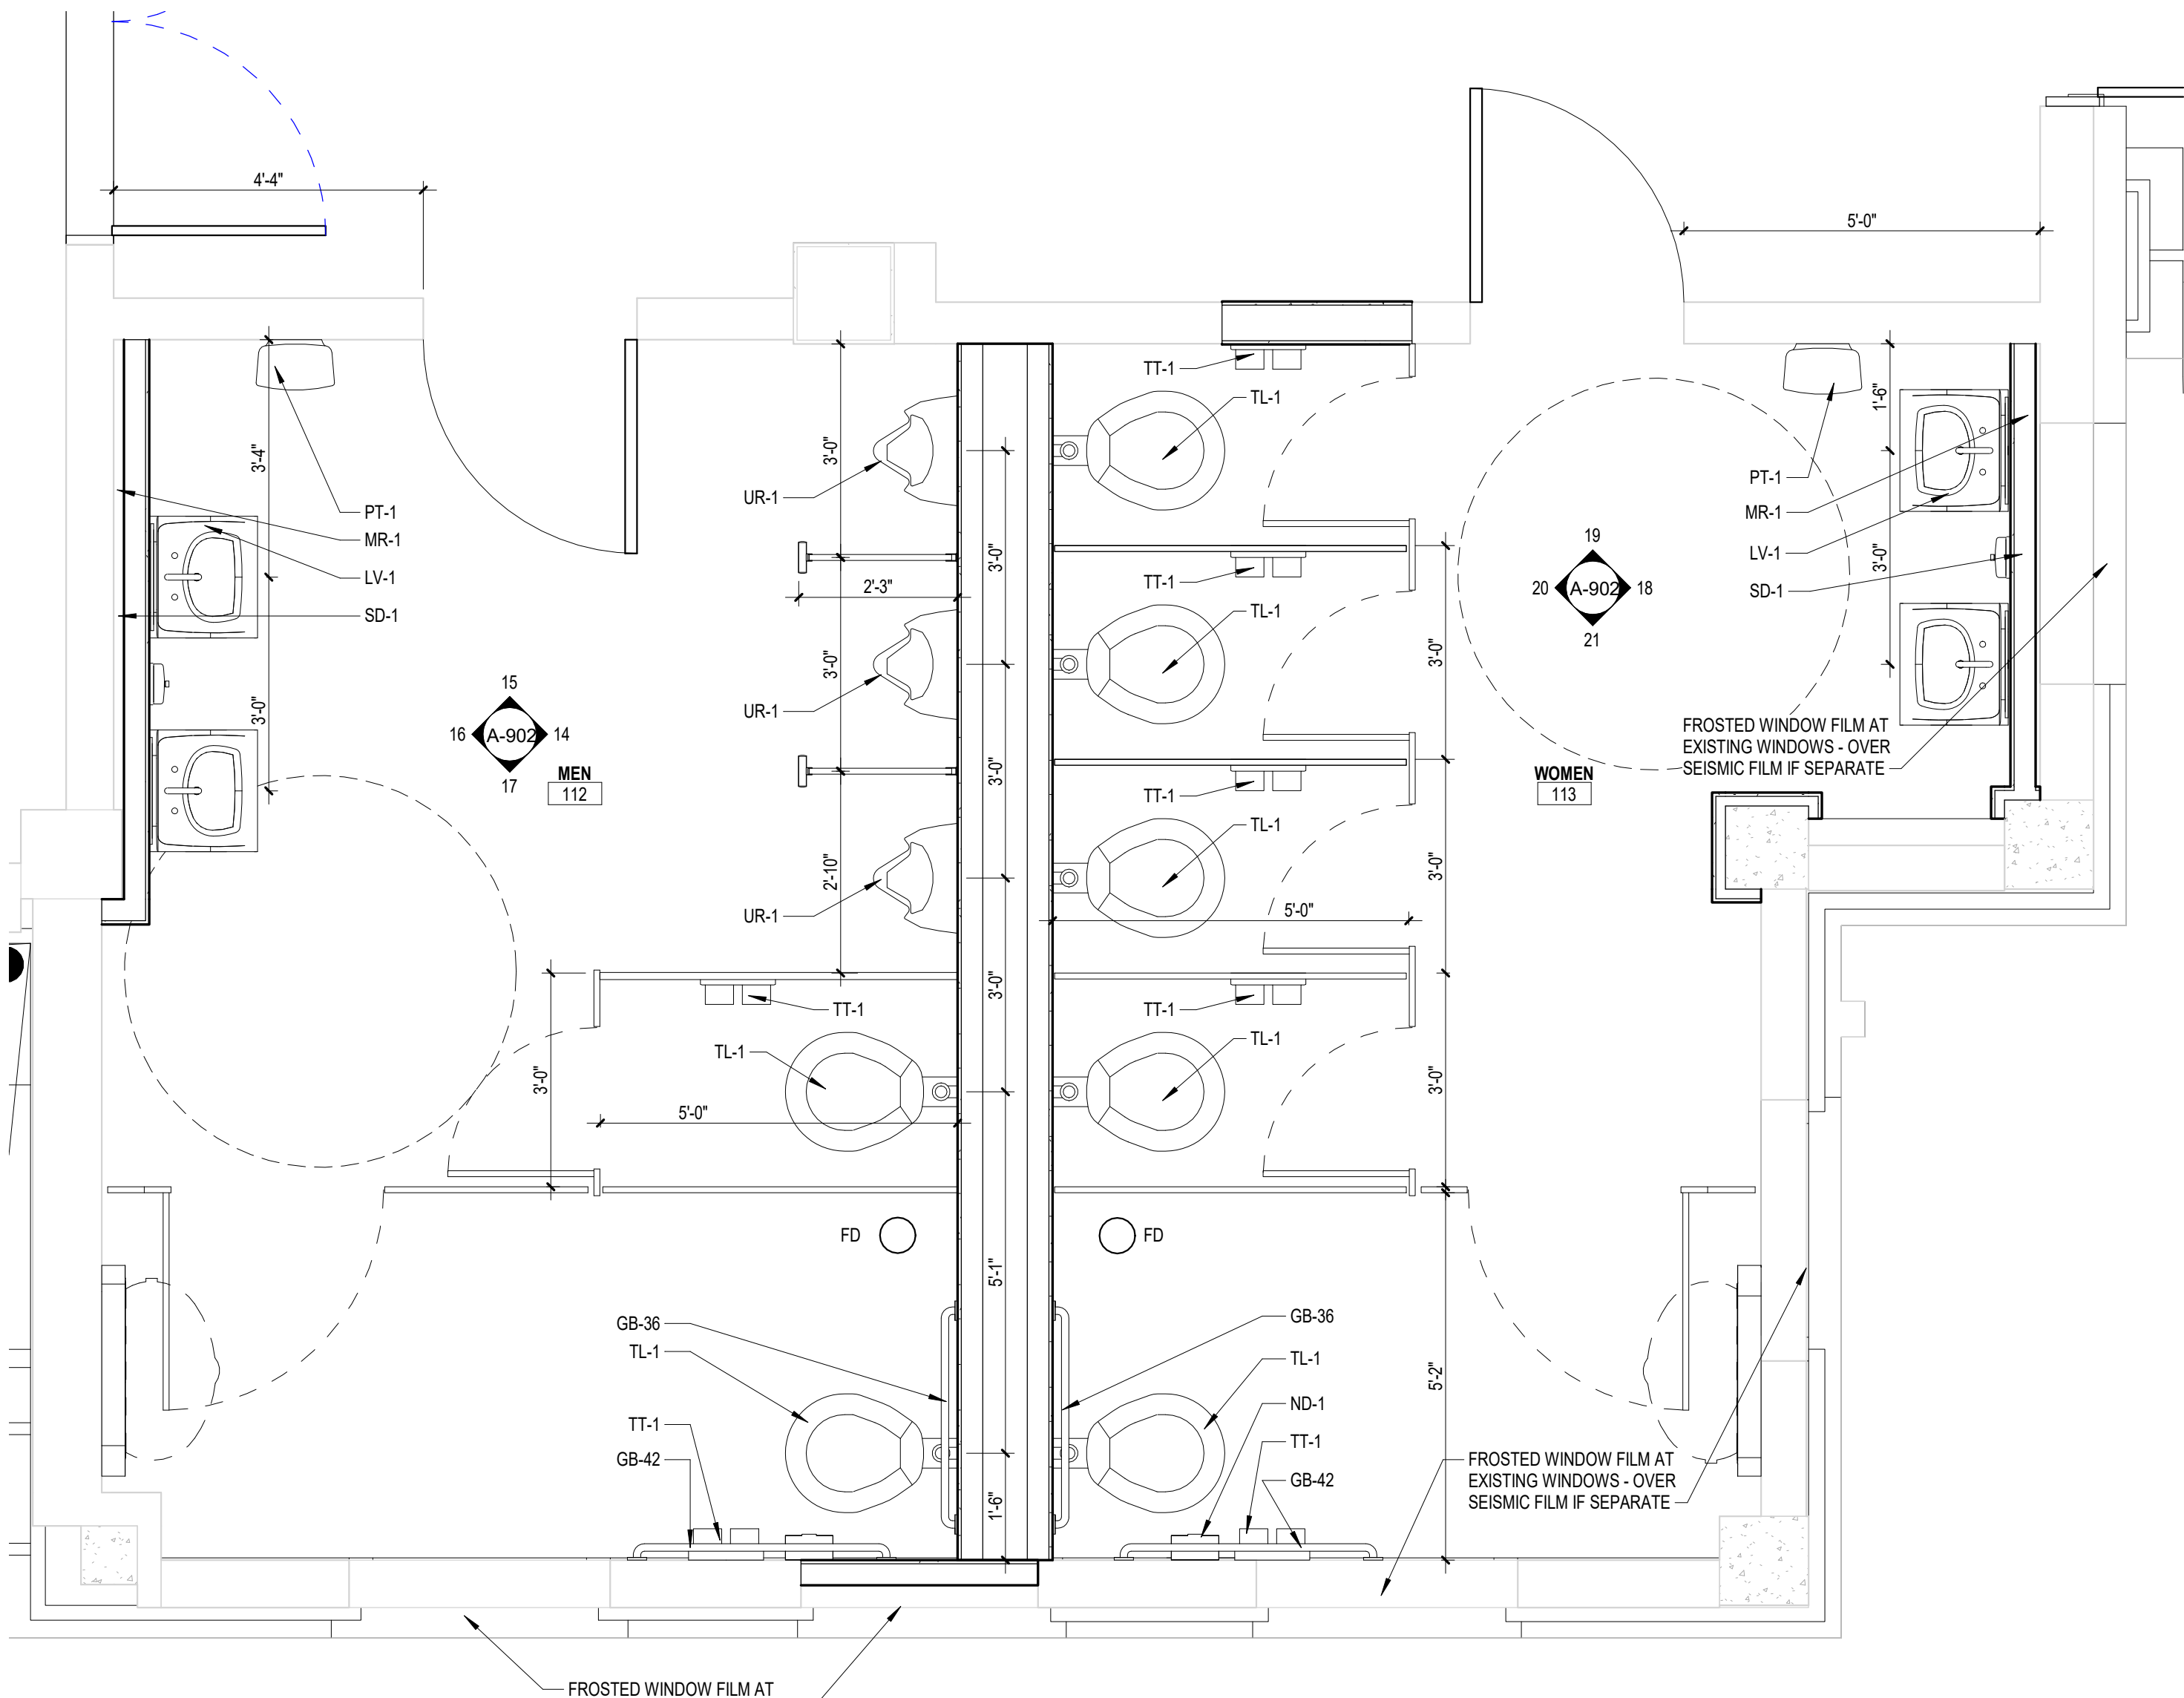

2 FIRST FLOOR - RESTROOMS
1/2" = 1'-0"

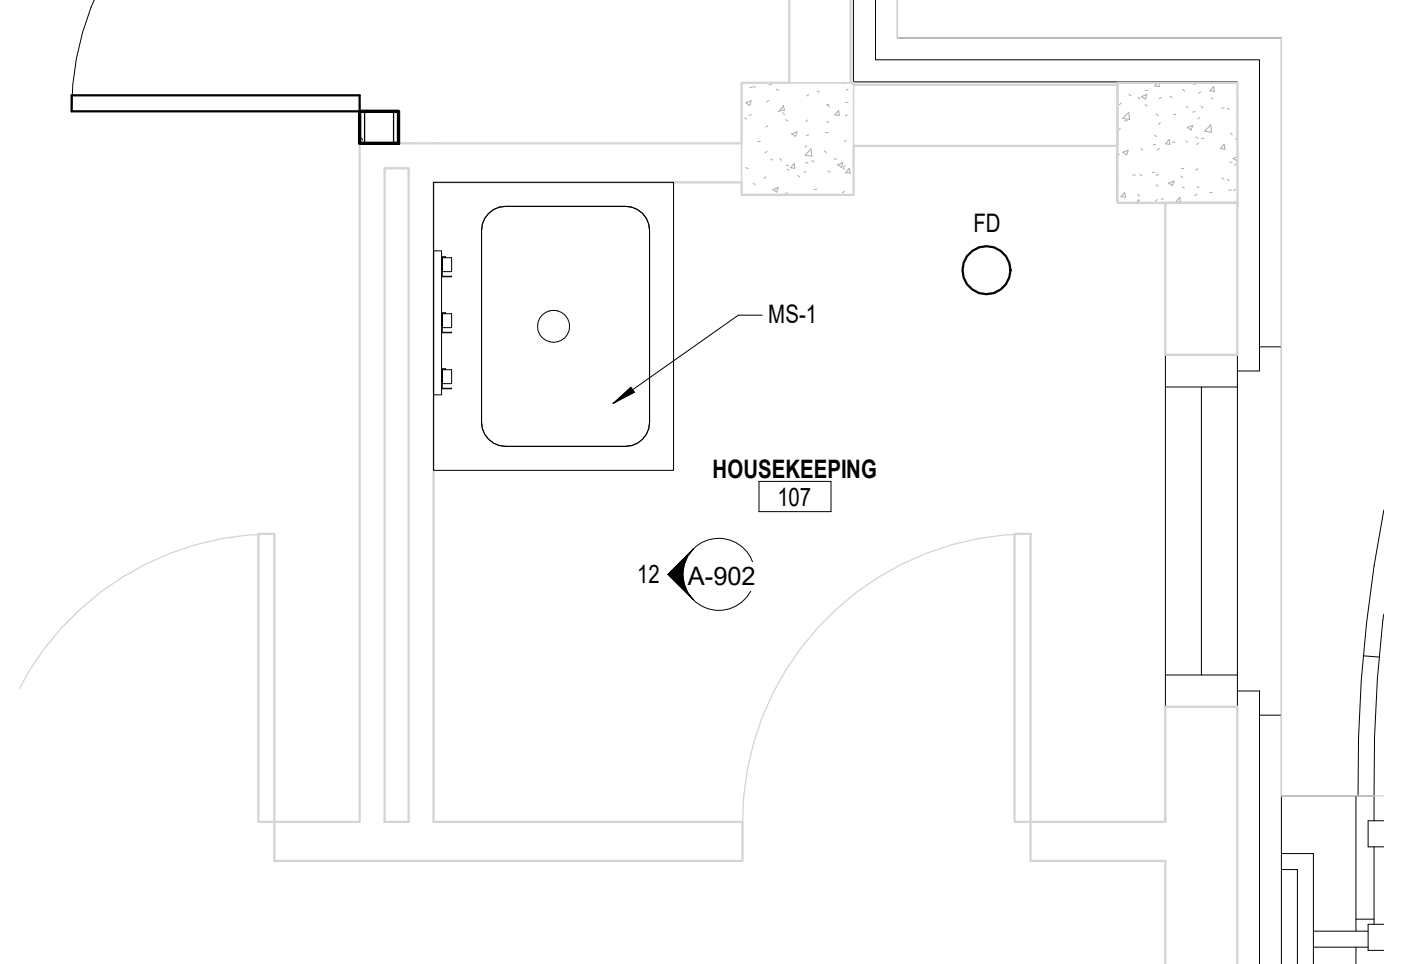

3 FIRST FLOOR - HOUSEKEEPING
1/2" = 1'-0"

BIM 360/2021-10 589A7-21-108 - Renovate and Repair Structural Building 4/21-1022-103.rvt
 9/23/2021 9:47:10 PM
 VA FORM 08 - 6231

Revisions:	Date:

ARCHITECT/ENGINEER OF RECORD

ALESIA ARCHITECTURE


Alesia Architecture P.C.
3705 North 200th Street
Elkhorn, Nebraska 68022
Phone: 402.291.6941

IMEG Corp.

15 Sunnyside Drive,
Suite 104
St. Louis, MO 63143
Phone: (314) 951-2534

SHAFER STEVENS SCHAAP STRUCTURAL ENGINEERS

9910 North 48th Street, Ste 204, Omaha, NE 68152
402.455.7698 www.s3ep.com

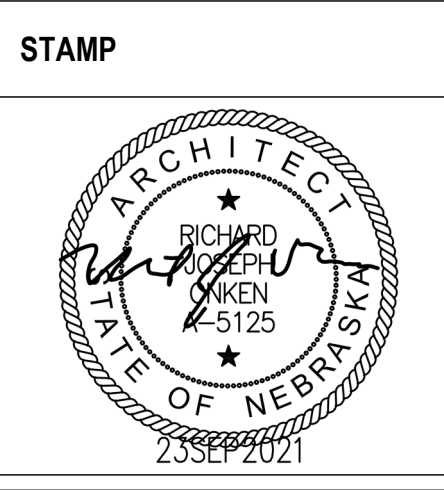

Office of Construction and Facilities Management


VA U.S. Department of Veterans Affairs

Drawing Title	ENLARGED PLANS - INTERIOR
Approved:	


Phase	BID DOCUMENTS
	FULLY SPRINKLERED

Project Title	Renovate and Repair Structural, Building 4		
Location	Wichita, KS		
Issue Date	Checked	Drawn	
9/23/2021			

Project Number	589A7-21-108
Building Number	4
Drawing Number	A-302

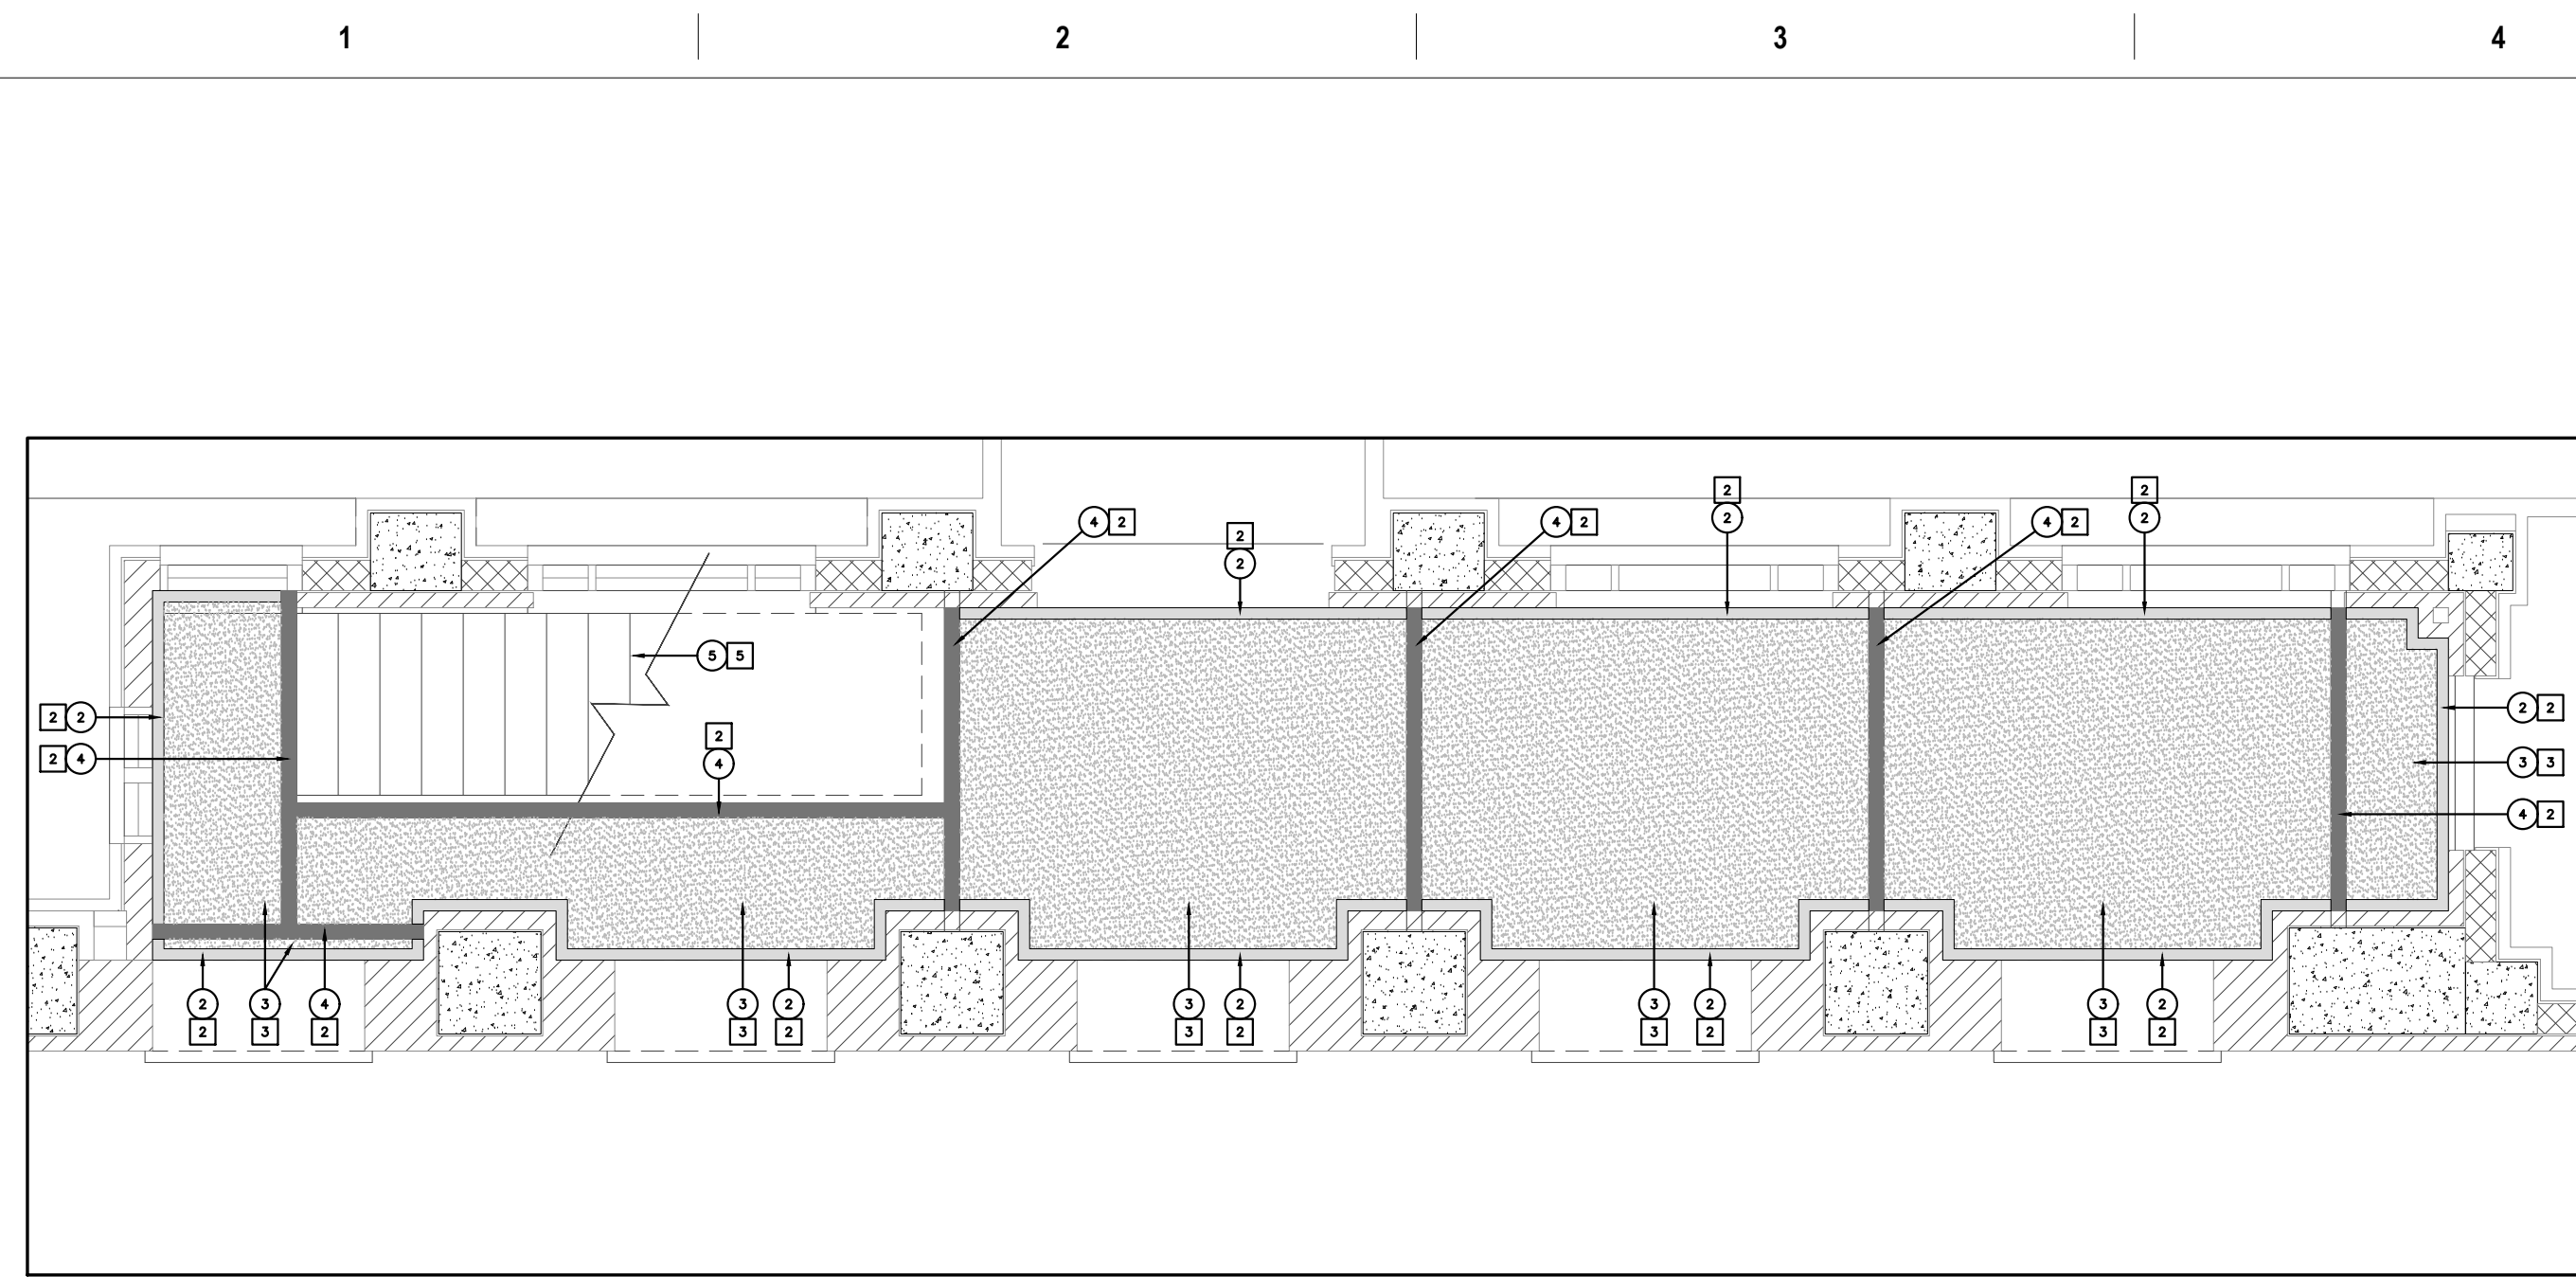

A SOUTH SOFFIT REFLECTED CEILING PLAN
1/4" = 1'-0" FIRST FLOOR

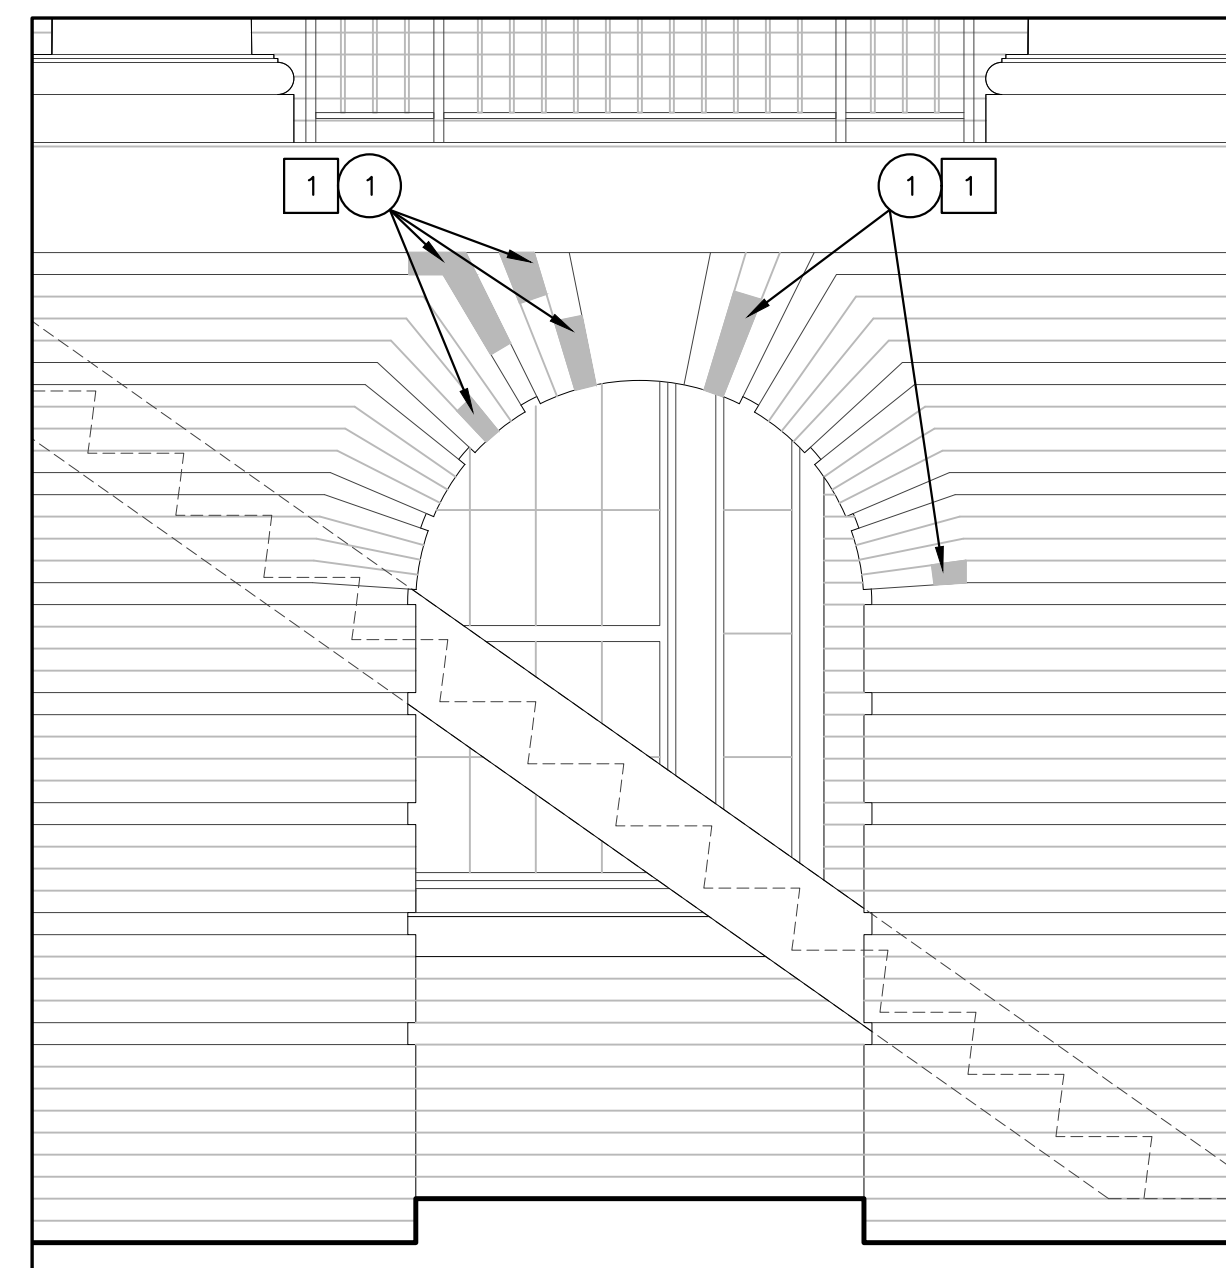

B ENLG. ARCHWAY
1/2" = 1'-0" EXTERIOR ELEVATION

DEMOLITION NOTES

- 1 REMOVE DAMAGED BRICK AND SURROUNDING MORTAR IN SHADED AREA.
- 2 SCRAPE OFF LOOSE PAINT
- 3 REMOVE EXISTING PLASTER
- 4 REMOVE EXISTING BRICK PAVERS
- 5 REMOVE EXISTING STEEL STAIRS AND RAILING. SEE DETAIL A/A301

LEGEND


- LOCATIONS OF WORK TO BE DONE
- 3/4" THICK CEMENTITIOUS PLASTER ON 2"x 1/4" WOODEN LATHE.

PLAN NOTES

- 1 INSTALL NEW CUSTOM SHAPED BRICK AND MORTAR TO MATCH ADJACENT AS SHOWN IN SHADED AREA. TOOL MORTAR TO MATCH EXISTING ADJACENT. SEE PLAN NOTE B ON SHEET A201.
- 2 REPAINT WOOD TRIM TO MATCH EXISTING.
- 3 REAPPLY NEW PLASTER AND PAINT TO MATCH EXISTING
- 4 PRIME BASE METAL PER SPECS. REPAINT ALL SURFACES OF METAL TO MATCH EXISTING.
- 5 INSTALL NEW STEEL STAIRS AND RAILING. SEE DETAIL A/A301
- 6 INSTALL NEW BRICK PAVERS IN 3x3 PARQUET PATTERN AS SHOWN.

GENERAL NOTES

- 1. PROTECT EXISTING ROOFTOP EQUIPMENT AND MATERIALS TO REMAIN DURING CONSTRUCTION.
- 2. PROTECT BUILDING SIDING, SIDEWALKS, LAWNS, ETC. DURING CONSTRUCTION.
- 3. MAINTAIN, PROTECT, AND RESET EXISTING METAL CURB FLASHING AND OTHER METAL OR ALUMINUM FLASHINGS FOR REUSE, UNLESS OTHERWISE NOTED.
- 4. FIELD VERIFY ALL DIMENSIONS.

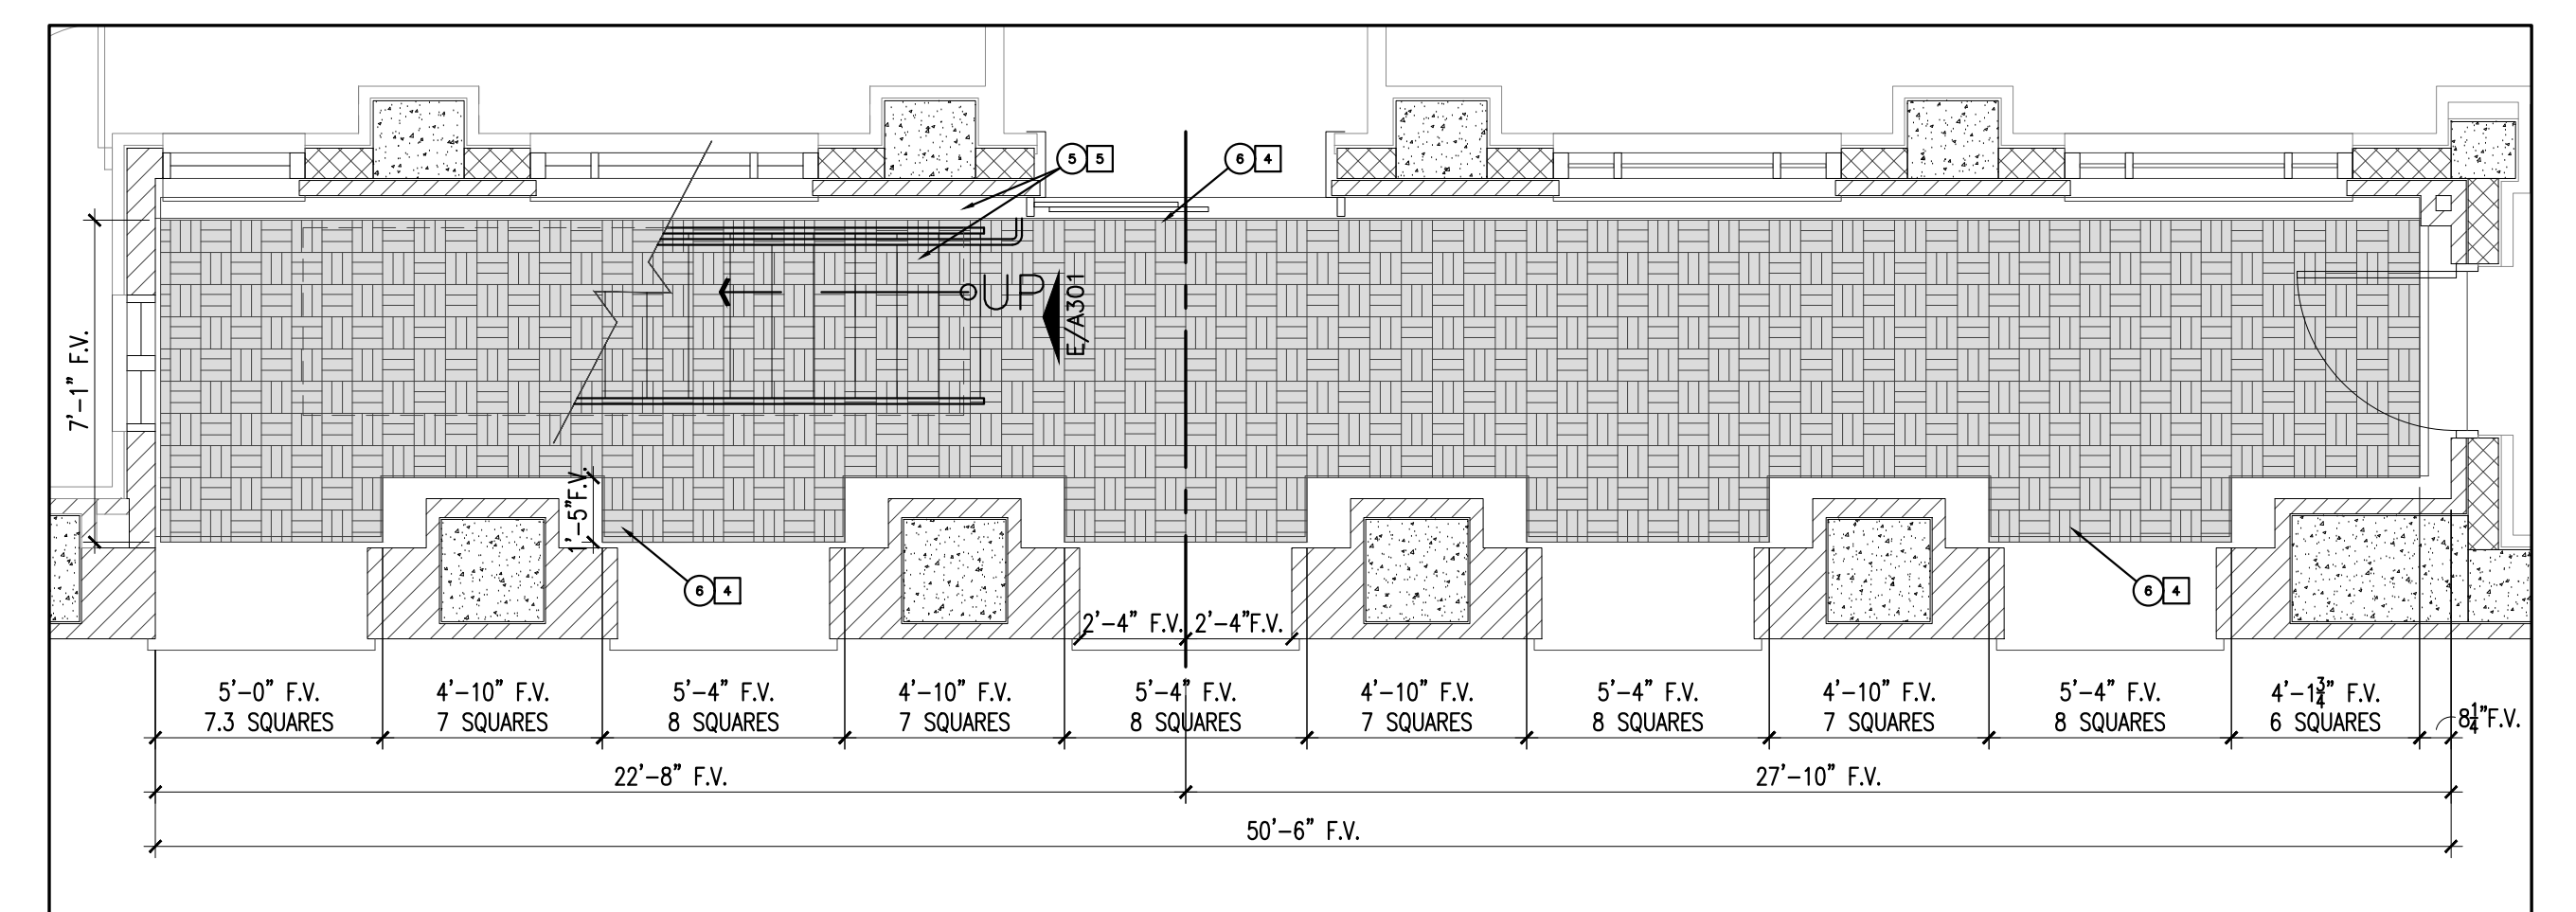

C SOUTH PAVERS PLAN
1/4" = 1'-0" FIRST FLOOR

6/14/2025 12:30:03 PM


File Path

Revisions:	Date:

ARCHITECT/ENGINEER OF RECORD

3705 North 200th Street
Elkhorn, Nebraska 68022
Phone: 402.291.6941

165 S. Rock Island Suite 200
Wichita, KS 67202
(316) 634-1111

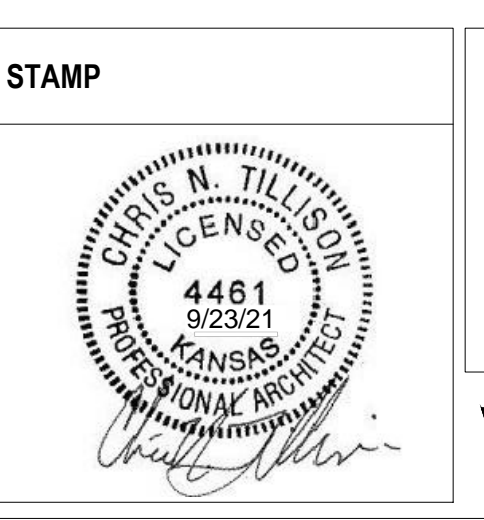

Office of Construction and Facilities Management



VA U.S. Department of Veterans Affairs

Drawing Title	Phase
EXTERIOR DETAILS	BID DOCUMENTS
Approved: Project Director	FULLY SPRINKLERED

Project Title	Project Number
Renovate and Repair Structural, Building 4	589A7-21-108
Location	Building Number
Wichita, KS	4
Issue Date	Checked
09/23/2021	CNT
Drawn	Drawn
RAG	RAG




Project Title	Project Number
Renovate and Repair Structural, Building 4	589A7-21-108
Location	Building Number
Wichita, KS	4
Issue Date	Checked
09/23/2021	CNT
Drawn	Drawn
RAG	RAG

9/26/2021 12:06:05 PM
9/26/2021 12:06:05 PM
9/26/2021 12:06:05 PM
9/26/2021 12:06:05 PM
9/26/2021 12:06:05 PM

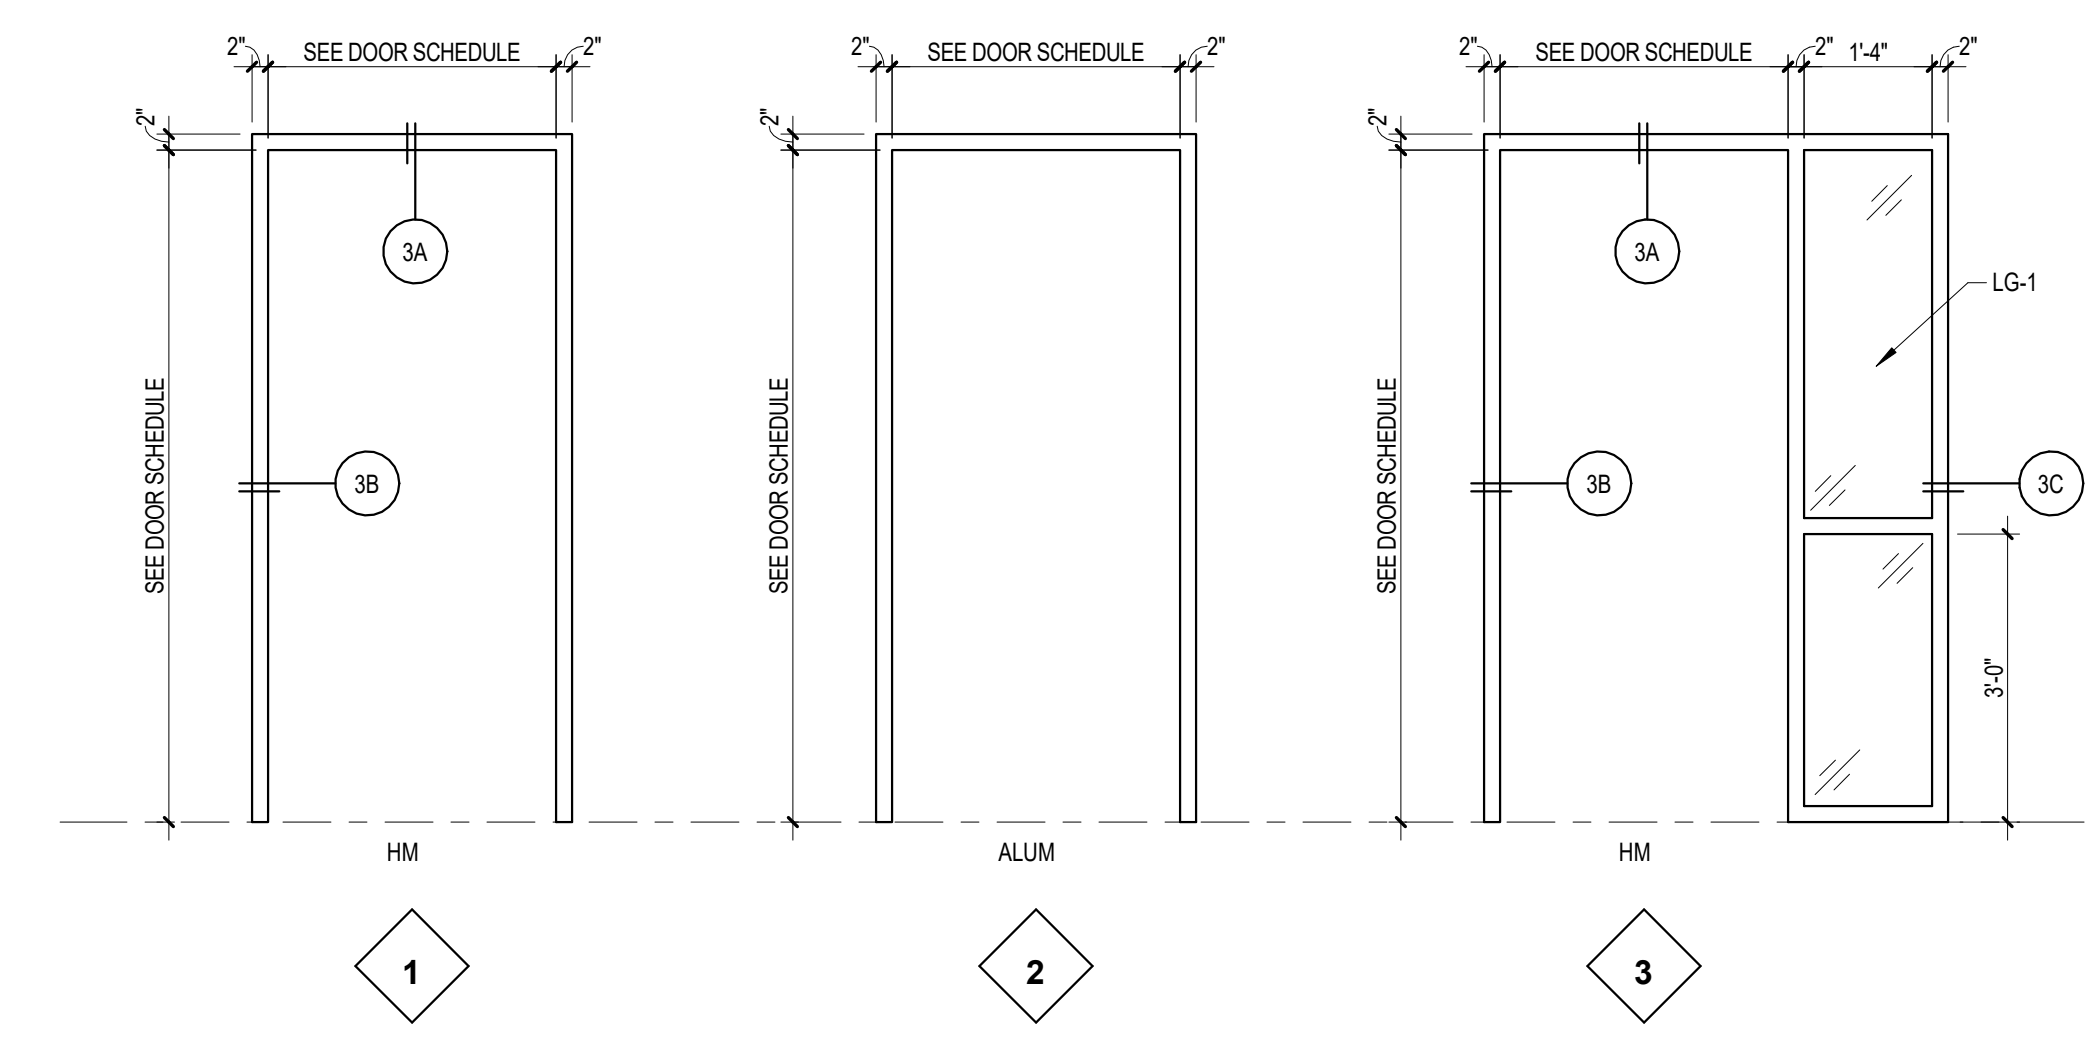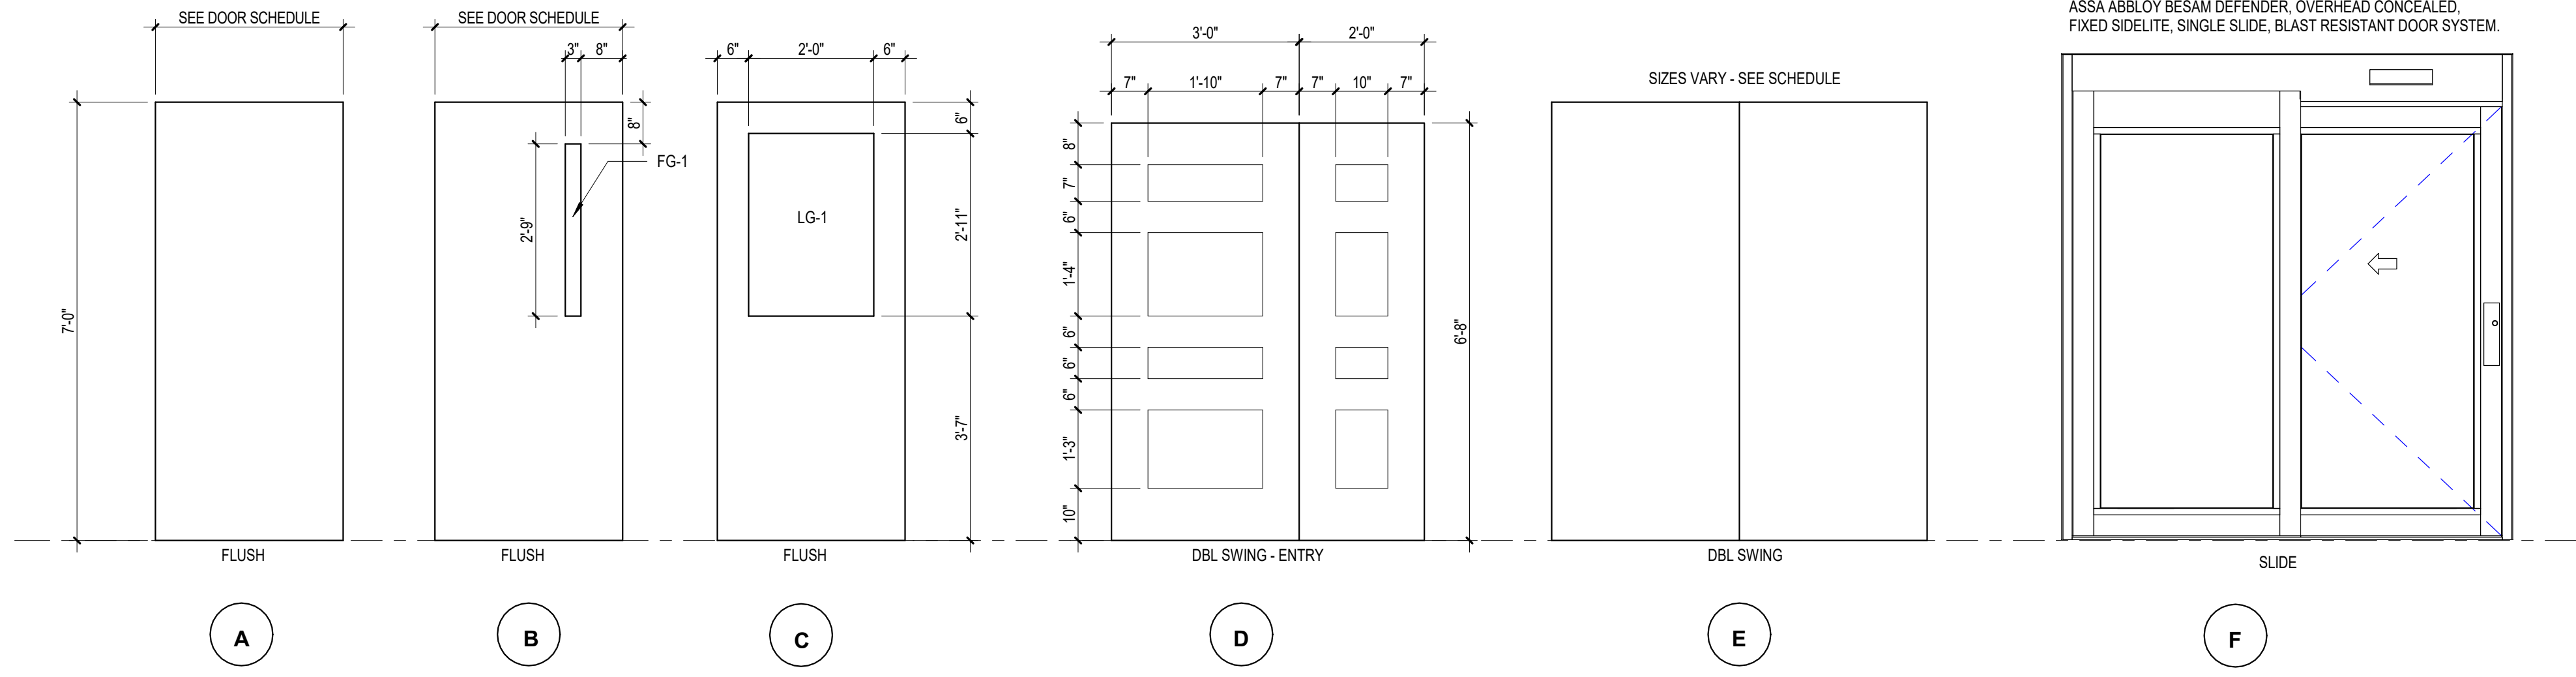

1 DOOR TYPES
1/2" = 1'-0"

2 DOOR FRAME TYPES
1/2" = 1'-0"

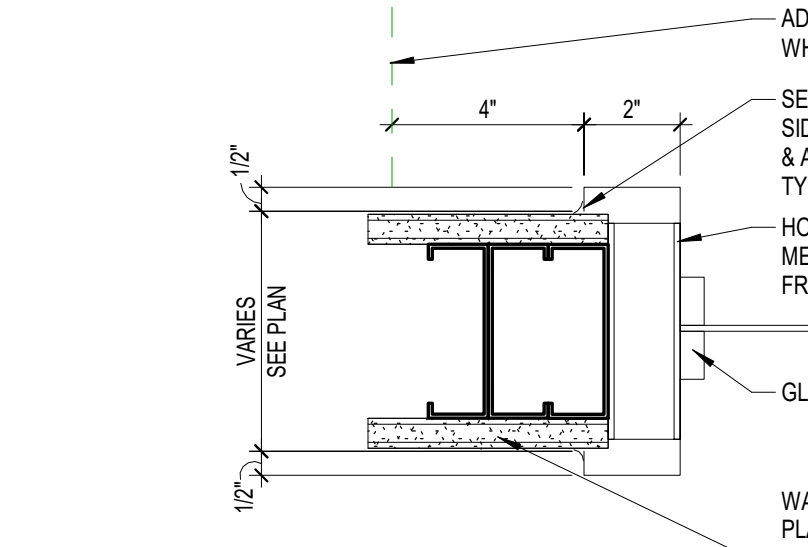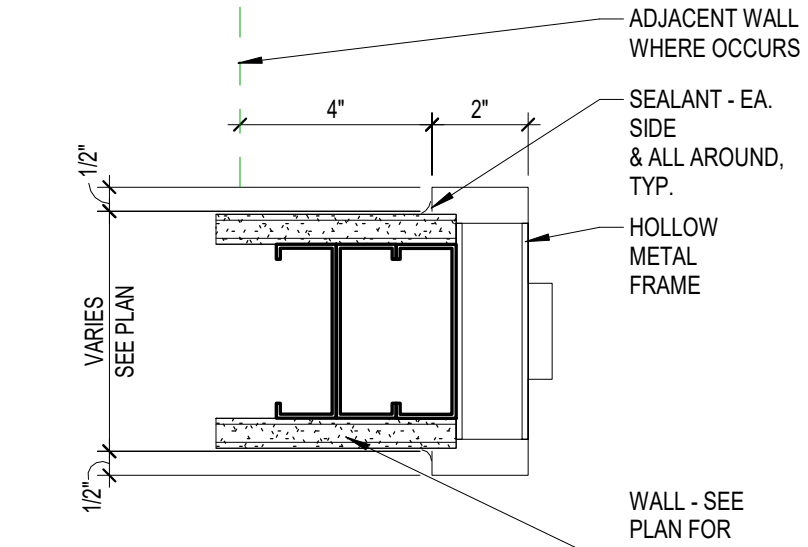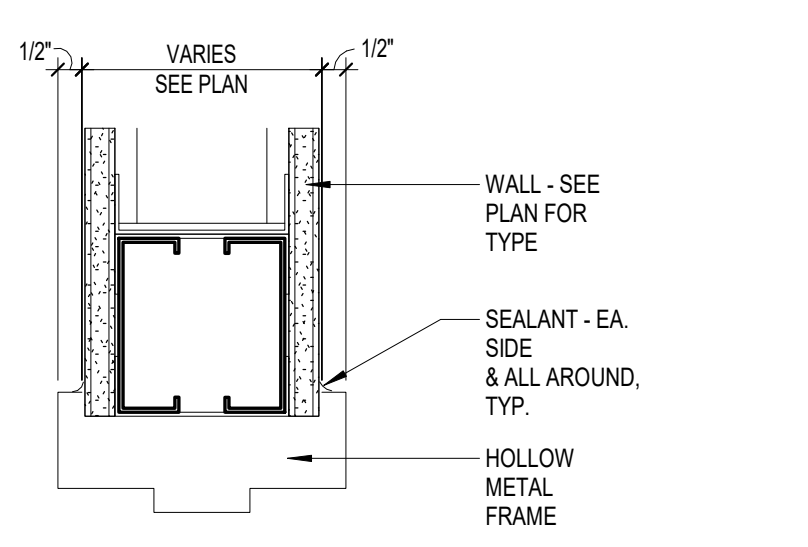


A HEAD
3" = 1'-0"

B JAMB
3" = 1'-0"

C JAMB
3" = 1'-0"

3 DOOR FRAME DETAILS
3" = 1'-0"

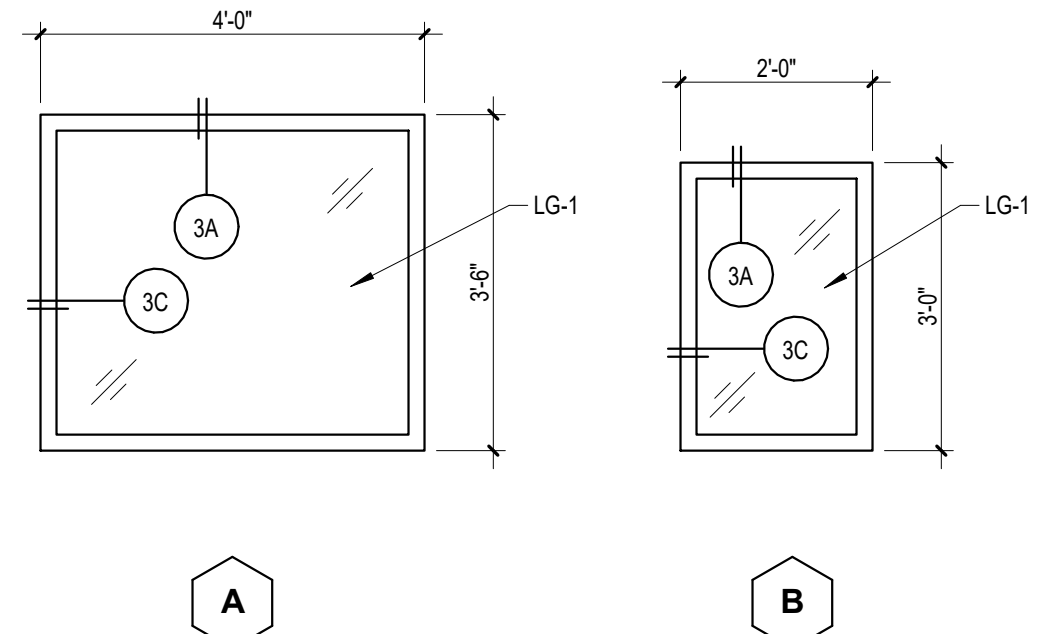

4 WINDOW TYPES
1/2" = 1'-0"

DOOR SCHEDULE												
DOOR NUMBER	ROOM NAME	Width	Height	HARDWARE	DOOR MATERIAL	DOOR TYPE	DOOR FINISH	FRAME TYPE	FRAME MATERIAL	FRAME FINISH	FIRE RATING	NOTES
001	VESTIBULE	6'-8"	7'-0"	SH-1	AL	F			AL			EXISTING SLIDING DOOR
002	VESTIBULE	7'-2"	7'-9"	BY MANUF.	AL	F			AL			COORD. WITH SECURITY SCREENING SYSTEM
003	WAITING	3'-6"	7'-0"	4A-A	WD	A	ST-2	3	HM	P-4		ADD
004	RECEPTION	3'-0"	7'-0"	3E	WD	A	ST-2	1	HM	P-4		
005	HOUSEKEEPING	3'-0"	7'-0"	SH3-A	WD	A	ST-2	1	HM	P-4		
006A	CORRIDOR	3'-6"	7'-0"	4A-A	HM	B	P-4	1	HM	P-4		ADO
006B	CORRIDOR	3'-6"	7'-0"	4E-A	WD	A	ST-2	1	HM	P-4		
007	EXAM ROOM	3'-6"	7'-0"	1Q	WD	A	ST-2	1	HM	P-4		
008	EXAM ROOM	3'-6"	7'-0"	1Q	WD	A	ST-2	1	HM	P-4		
009	EXAM ROOM	3'-6"	7'-0"	1Q	WD	A	ST-2	1	HM	P-4		
010A	CORRIDOR	3'-6"	7'-0"	3E	WD	A	ST-2	1	HM	P-4		
010B	CORRIDOR	3'-6"	7'-0"	E4-A	HM	A	P-4	1	HM	P-4		
011	LOCKED STORAGE	3'-0"	7'-0"	4E	WD	A	ST-2	1	HM	P-4		
012	STORAGE	3'-0"	7'-0"	5D								EXISTING
014B	OFFICE	3'-0"	7'-0"	3E	WD	A	ST-2	1	HM	P-4		
015	WORK ROOM	3'-6"	7'-0"	5D	WD	A	ST-2	1	HM	P-4		
016	WOMEN	3'-0"	7'-0"	4B-A	WD	A	ST-2	1	HM	P-4		ADO
017	MEN	3'-0"	7'-0"	4B-A	WD	A	ST-2	1	HM	P-4		ADO
018	CORRIDOR	3'-6"	7'-0"	4A-A	WD	C	ST-2	1	HM	P-4		ADO
019A	CONFERENCE	3'-6"	7'-0"	SH3	WD	A	ST-2	1	HM	P-4		
019B	CONFERENCE	3'-0"	7'-0"	SH3	WD	A	ST-2	1	HM	P-4		
020	STAFF RR	3'-0"	7'-0"	2G	WD	A	ST-2	1	HM	P-4		
021A	STAIRS	3'-6"	7'-0"	SH4B	HM	B	P-4	1	HM	P-4		60 MIN
021B	STAIRS	3'-0"	7'-0"	SH4B	HM	B	P-4	1	HM	P-4		60 MIN
022	ELECTRICAL	3'-0"	7'-0"	5F-A	HM	A	P-4	1	HM	P-4		
023	ELECTRICAL	3'-0"	7'-0"	5F-B	HM	A	P-4	1	HM	P-4		
024	STORAGE / MAILOUTS	3'-6"	7'-0"	4E	WD	A	ST-2	1	HM	P-4		
028A	OFFICE	3'-0"	7'-0"	3E	WD	A	ST-2	1	HM	P-4		
028B	OFFICE	3'-6"	7'-0"	E4-A								EXISTING
029	OFFICE	3'-0"	7'-0"	3E	WD	A	ST-2	1	HM	P-4		
030	STORAGE	3'-6"	7'-0"	SH3	WD	A	ST-2	1	HM	P-4		
031	DATA CLOSET	6'-10"	6'-8"	11-A	HM	B	P-4	1	HM	P-4		
032	ELECTRICAL	2'-6"	7'-0"	5F-A	HM	A	P-4	1	HM	P-4		
033	MECHANICAL	3'-0"	7'-0"	5F-A	HM	A	P-4	1	HM	P-4		
034	FENCE GATE	13'-0"	8'-0"		Steel							
100	KITCHEN	3'-0"	7'-0"	EXIST								EXISTING
100A	PANTRY STORAGE	3'-6"	7'-0"	SH3-A								
101	EDUCATION PROGRAM	6'-10"	6'-8"	SH-1	WD	A	ST-2	1	HM	P-4		EXISTING
102	STORAGE	2'-8"	7'-0"	EXIST	WD	A	ST-2	1	HM	P-4		
102A	MECHANICAL	6'-0"	7'-0"	11-A	HM	E	P-4	1	HM	P-4		
103	ANTE ROOM	3'-6"	7'-0"	EXIST								EXISTING
103A	ANTE ROOM	3'-0"	7'-0"	EXIST								EXISTING
104	CORRIDOR	3'-0"	7'-0"	EXIST								EXISTING
105	STORAGE	3'-0"	7'-0"	SH3-A								90 MIN
106	DATA CLOSET	6'-0"	7'-0"	5F-A	WD	A	ST-2	1	HM	P-4		45 MIN
107	HOUSEKEEPING	3'-0"	7'-0"	5D-A								EXISTING
108A	LOBBY	6'-4"	7'-0"	E9-A	HM	D	P-4	1	HM	P-4		
108B	LOBBY	5'-0"	6'-8"	E9-A	HM	D	P-4	1	HM	P-4		
108C	LOBBY	5'-4"	7'-0"	E9-A	HM	D	P-4	1	HM	P-4		
108D	LOBBY	5'-4"	7'-0"	E9	WD	D	ST-2	1	HM	P-4		45 MIN
108E	LOBBY	5'-4"	7'-0"	E9	WD	D	ST-2	1	HM	P-4		45 MIN
111	EDUCATION PROGRAM	3'-6"	7'-0"	EXIST								EXISTING
111A	EDUCATION PROGRAM	3'-0"	7'-0"	E4-A								EXISTING
111B	EDUCATION PROGRAM	3'-0"	7'-0"	E4-A								EXISTING
111C	OFFICE	3'-0"	7'-0"	3D-A								EXISTING
112	MEN	3'-0"	7'-0"	4B	WD	A	ST-2	1	HM	P-4		45 MIN
113	WOMEN	3'-0"	7'-0"	4B	WD	A	ST-2	1	HM	P-4		45 MIN
201	OPEN OFFICE	3'-0"	7'-0"	SH4B	HM	B	P-4	1	HM	P-4		60 MIN
202	CONFERENCE	3'-0"	7'-0"	3E	WD	A	ST-2	1	HM	P-4		
203	DIGITAL PRESS	3'-0"	7'-0"	3E	WD	A	ST-2	1	HM	P-4		
207	STUDIO	3'-0"	7'-0"	3E	WD	A	ST-2	1	HM	P-4		
208A	STAIRS	3'-0"	7'-0"	SH4B	HM	B	P-4	1	HM	P-4		60 MIN
208B	STAIRS	3'-0"	7'-0"	SH4B	HM	B	P-4	1	HM	P-4		60 MIN
209	STORAGE	2'-8"	7'-0"	SH3-A								60 MIN


Revisions:	Date:

ARCHITECT/ENGINEER OF RECORD

ALESIA ARCHITECTURE
Alesia Architecture P.C.
3705 North 200th Street
Elkhorn, Nebraska 68022
Phone: 402.291.6941

IMEG STRUCTURAL ENGINEERS
IMEG Corp.
15 Sunbeam Drive,
Suite 104
St. Louis, MO 63143
Phone: (314) 951-2534

SHAFFER STEVENS SCHAAP STRUCTURAL ENGINEERS
9910 North 48th Street, Ste 204, Omaha, NE 68152
402.455.7698 www.s3pc.com

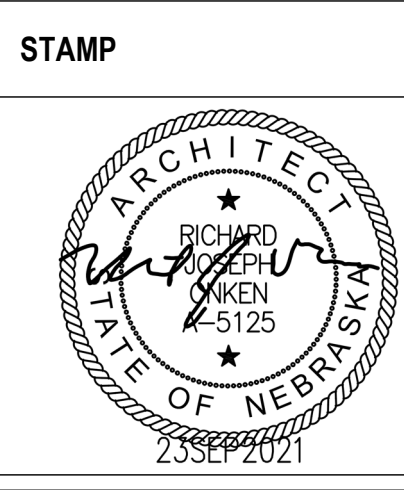

Office of Construction and Facilities Management

VA U.S. Department of Veterans Affairs

Drawing Title
INTERIOR DOOR AND WINDOW FRAME ELEVATIONS AND DETAILS

Approved:

Phase
BID DOCUMENTS

FULLY SPRINKLERED

Project Title
Renovate and Repair Structural, Building 4

Location
Wichita, KS

Issue Date
9/23/2021

Checked
[]

Drawn
[]

Project Number
589A7-21-108

Building Number
4

Drawing Number
A-701

ROOM FINISH SCHEDULE

Table with 10 columns: ROOM NUMBER, ROOM NAME, FLOOR, BASE, NORTH WALLS SOUTH WEST, CEILING MATERIAL, REMARKS. Rows include VESTIBULE, CORRIDOR, WAITING, RECEPTION, HOUSEKEEPING, etc.

FINISH SCHEDULE REMARKS:

- A. PROTECTIVE WALL PANEL WP-3 AND REQUIRED TRIM & TOP CAP FROM TOP OF 6" BASE TO 4'-0" A.F.F., PT-1 ABOVE.
B. PROTECT EXISTING FINISHES DURING INSTALLATION OF HANDICAP WHEELCHAIR LIFT IN EDUCATION ROOM 111...
C. PROVIDE FIELD TILE IN T-1 TO 6'-6" ABOVE FINISHED FLOOR WITH ACCENT TILE T-3 AT 5' TO 5'-6" WITH ONE FULL TILE OF T-1 ABOVE...
D. PROVIDE PAINTED 3/4" FIRE RETARDANT PLYWOOD OVER ALL WALLS WHERE DATA EQUIPMENT OCCURS.
E. PROVIDE QT-1 BASE WITH CT-1 TO 4'-0" A.F.F. WITH PT-1A ABOVE...
F. PROVIDE WP-4 TO ALIGN WITH TOP OF COUNTERTOP ON EAST AND WEST WALLS.
G. PROVIDE COVERED BASE TO 6" A.F.F. WITH BRUSHED ALUMINUM TOP CAP FOR A FINISHED INSTALLATION.
H. VERIFY PAINT TO MATCH EXISTING.

GENERAL NOTES:


- 1. ANY FINISHES REQUIRED BUT NOT SHOWN IN THIS SCHEDULE SHALL BE APPROVED BY THE COR.
2. SEE RELECTED CEILING PLAN FOR CEILING AND SOFFIT HEIGHTS.
3. CEILING SOFFITS TO BE PAINTED PT-9.
4. ALL WELDED SHEET FLOORING TO BE HEAT WELDED. WHERE NOTED TO BE COVERED, COVERED BASE SHALL BE 6" A.F.F.

SIGNAGE SCHEDULE

Table with 5 columns: ID NUMBER, VA ROOM NUMBER, ROOM NAME, MOUNTING, CONTENTS, TYPE. Rows include CORRIDOR, WAITING, RECEPTION, EXAM ROOM, LOCKED STORAGE, WORK ROOM, OFFICE, MEN, WOMEN, CONFERENCE RM, STAFF RR, STAIR, ELECTRICAL, STORAGE / MAILOUTS, OFFICE, OPEN OFFICE, MECHANICAL, ELEVATOR, PANTRY / STORAGE, EDUCATION PROGRAM, MECHANICAL, HOUSEKEEPING, LOBBY, EDUCATION PROGRAM, MEN, WOMEN, BALCONY, STAIR, OPEN OFFICE, CONFERENCE, DIGITAL PRESS, STUDIO, STAIR.

SIGNAGE NOTES

- 1. SEE VA SIGNAGE DESIGN GUIDE CHAPTER 9 FOR SIGN TYPES AND INSTALLATION REQUIREMENTS https://www.cfm.va.gov/tll/signs/Signage09-Interior.pdf

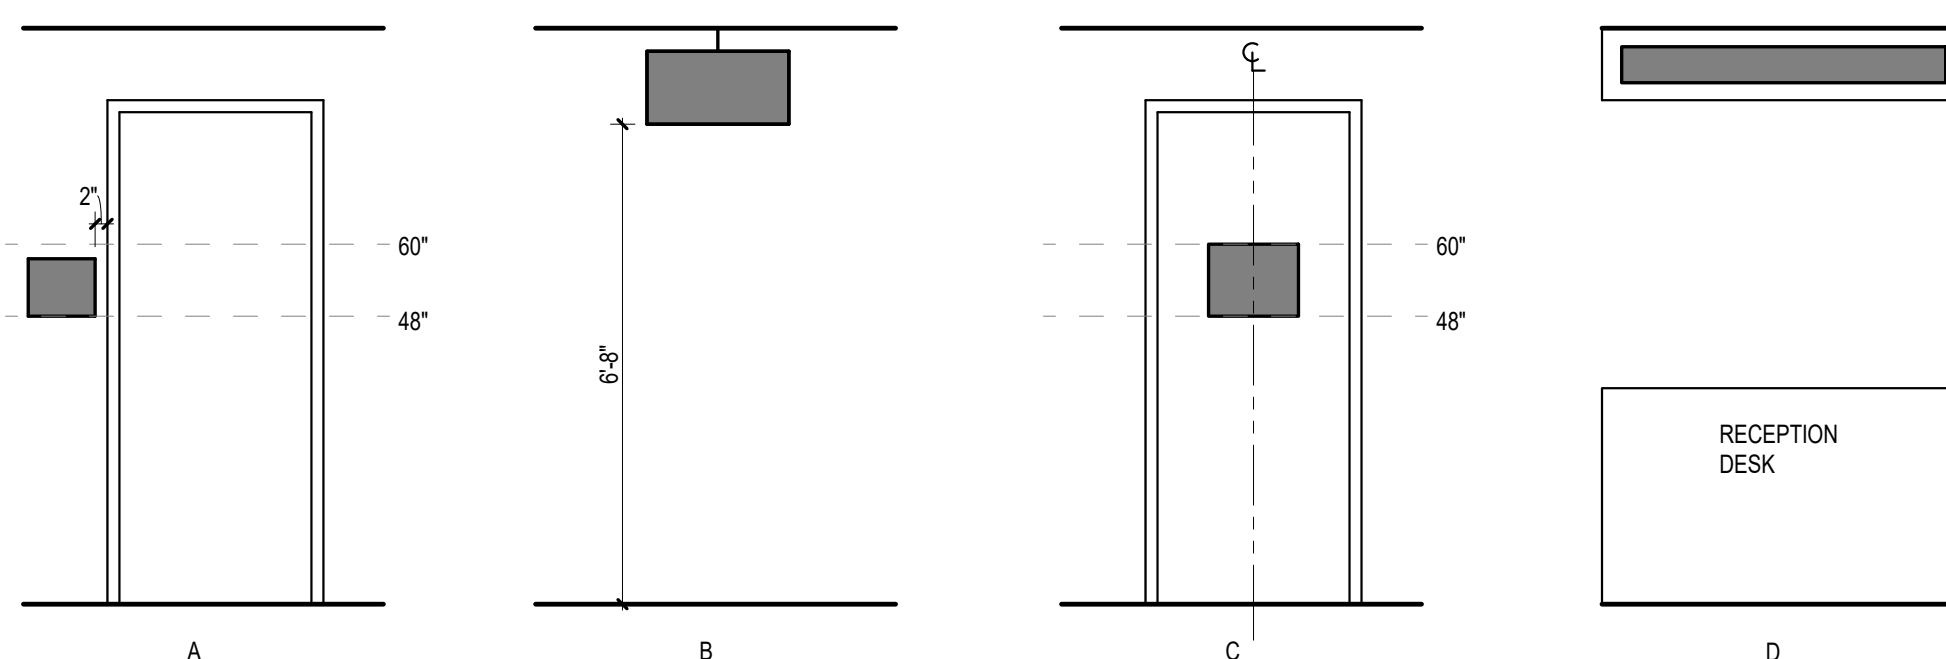

MOUNTING LOCATIONS

3/8" = 1'-0"

ABBREVIATIONS:

V VA PROVIDED / INSTALLED
C CONTRACTOR PROVIDED / INSTALLED

EQUIPMENT SCHEDULE


Table with 5 columns: KEY, JSN, DESCRIPTION, PROVIDED, INSTALLED. Rows include ACUSTICAL PANELS, MAGNETIC WHITEBOARD, BABY CHANGING STATION, CREDENZA WITH HUTCH, OFFICE CHAIR, SIDE CHAIR W/ ARMS, CONFERENCE CHAIR, CLOCK, COMPUTER W/ DUAL FLAT PANEL MONITORS, CRASH RAIL, DRINKING FOUNTAIN, DESK, DESK - L SHAPED, EYE WASH STATION - WALL MOUNTED, FILING CABINET - LATERAL - HALF HEIGHT, FILE CABINET - LEGAL, FLAMMABLE STORAGE CABINET, GRAB BAR 18", GRAB BAR 30", GRAB BAR 36", GRAB BAR 42", GLOVE DISPENSER, GARMENT HOOK, HAND RAIL, HAND SANITIZER DISPENSER, LAUNDRY SINK, DRILL PRESS, BAND SAW, JACK STAND - SHOE REPAIR, SOLE CUTTER - BENCH MOUNTED, SEWING MACHINE, FINISHING MACHINE, VACUUM FORMING SYSTEM, FUME HOOD, INFRARED OVEN, GRINDER / POLISHER, GRINDER, SANDER - BELT, MACHINIST'S VISE, SANDBLASTER, CARVER, LAVATORY, MOP HOLDER, MIRROR, MOP SINK, MICROWAVE, SANITARY NAPKIN DISPOSAL, OFFICE PARTITION, PARALLEL BARS, PRIVACY CURTAIN - TRACK ONLY, TELEPHONE, PRINTER, PLOTTER, PAPER TOWEL DISPENSER W/ SENSOR, PAPER TOWEL DISPENSER - SS, FRIDGE / FREEZER, ROLLER SHADES, SOAP DISPENSER, SINK FAUCET, SERVICE SINK FAUCET, GLOVE DISPENSER / SHARPS / WASTE, OVERHEAD HARNESS / TRACK SYSTEM, INTEGRATED CORIAN SINK, SHREDDER, STOOL - SELF ADJUSTING, SHELVING STORAGE UNIT, WIRE, 72H60W18D, CONFERENCE TABLE - 14, CONFERENCE TABLE - 6, WORK TABLE, TOILET - WALL HUNG, TOILET TISSUE DISPENSER, TELEVISION HDTV 60", TELEVISION BRACKET - WALL MTD - TILT/ANGLE, URINAL, WORK BENCH, WORK BENCH - SEWING, WORK CENTER, WHEEL CHAIR, WASTE PAPER BASKET, WASTE RECEPTACLE - WALL MOUNT, EXAM CHAIR.

9/25/2021 9:47:15 PM
BM 36012021-03 589A7-21-108 - Renovate and Repair Structural Building 4/921-103103.vrt

Revisions table with columns for Revisions and Date.

ARCHITECT/ENGINEER OF RECORD
ALEZIA ARCHITECTURE
Allesia Architecture P.C.
3705 North 200th Street
Elkhorn, Nebraska 68022
Phone: 402.291.6941

IMEG CORP.
IMEG Corp.
15 Sureson Drive,
Suite 104
St. Louis, MO 63143
Phone: (314) 951-2534

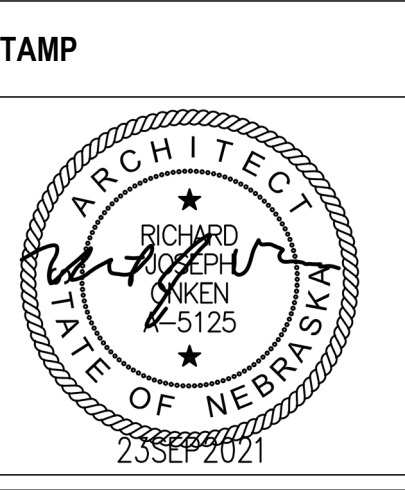

Office of Construction and Facilities Management
U.S. Department of Veterans Affairs


Drawing Title: FINISH SCHEDULES
Approved:

Phase: BID DOCUMENTS
FULLY SPRINKLERED


Project Title: Renovate and Repair Structural, Building 4
Location: Wichita, KS
Issue Date: 9/23/2021
Checked:
Drawn:
Project Number: 589A7-21-108
Building Number: 4
Drawing Number: A-801

A


A

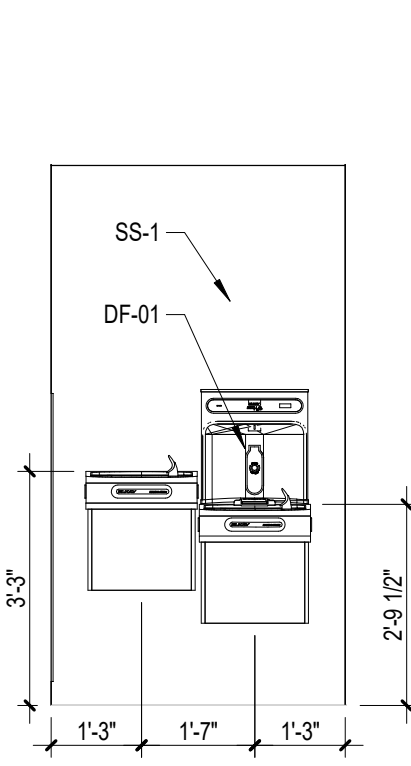


1 Corridor 002 - West
3/8" = 1'-0"

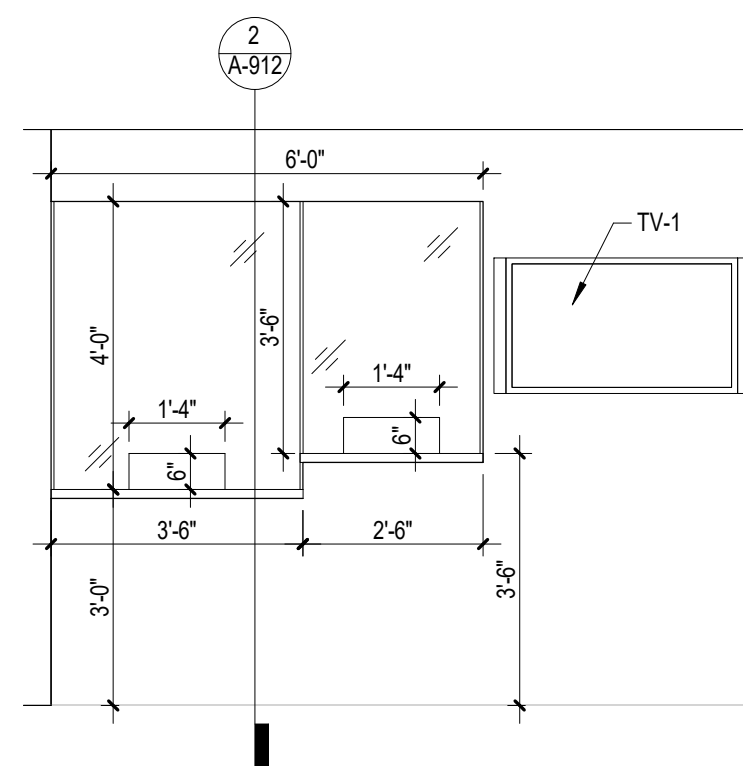


2 Waiting 003 - West
3/8" = 1'-0"

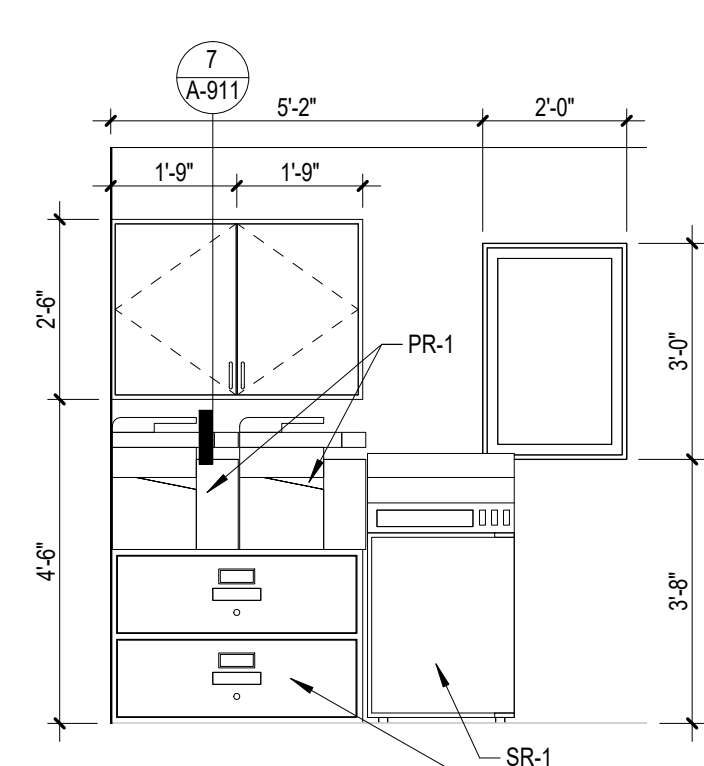


3 Reception 004 - West
3/8" = 1'-0"

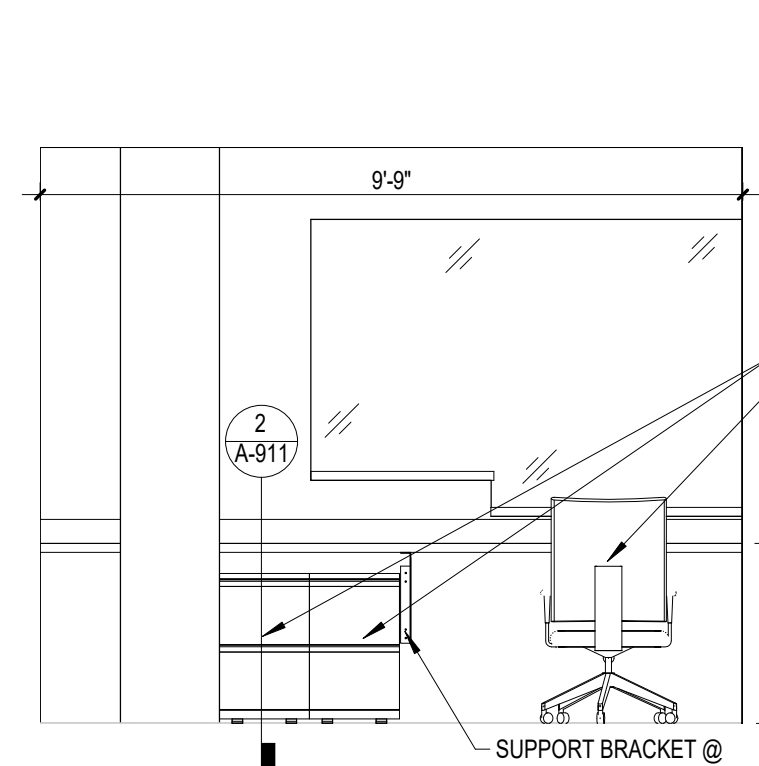

4 Reception 004 - East
3/8" = 1'-0"

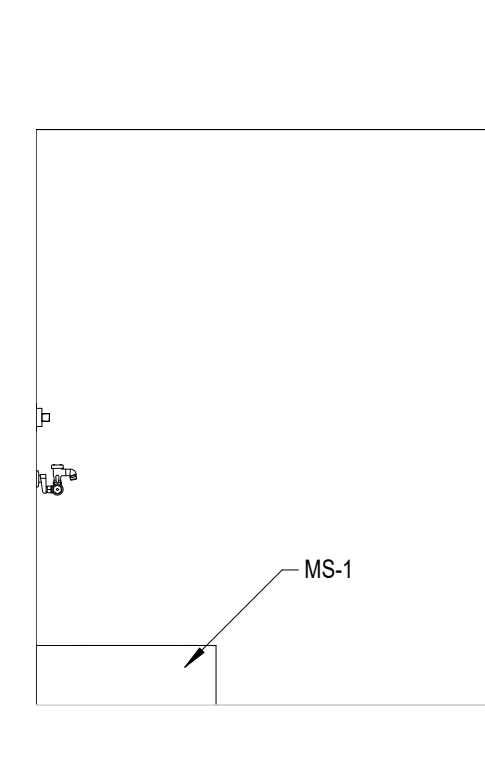


5 Housekeeping 005 - West
3/8" = 1'-0"

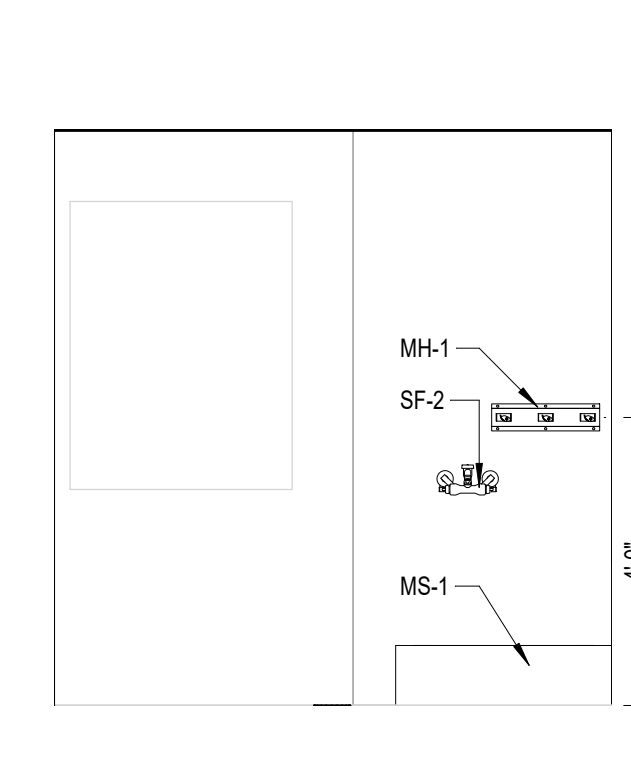


6 Housekeeping 005 - South
3/8" = 1'-0"

B


B

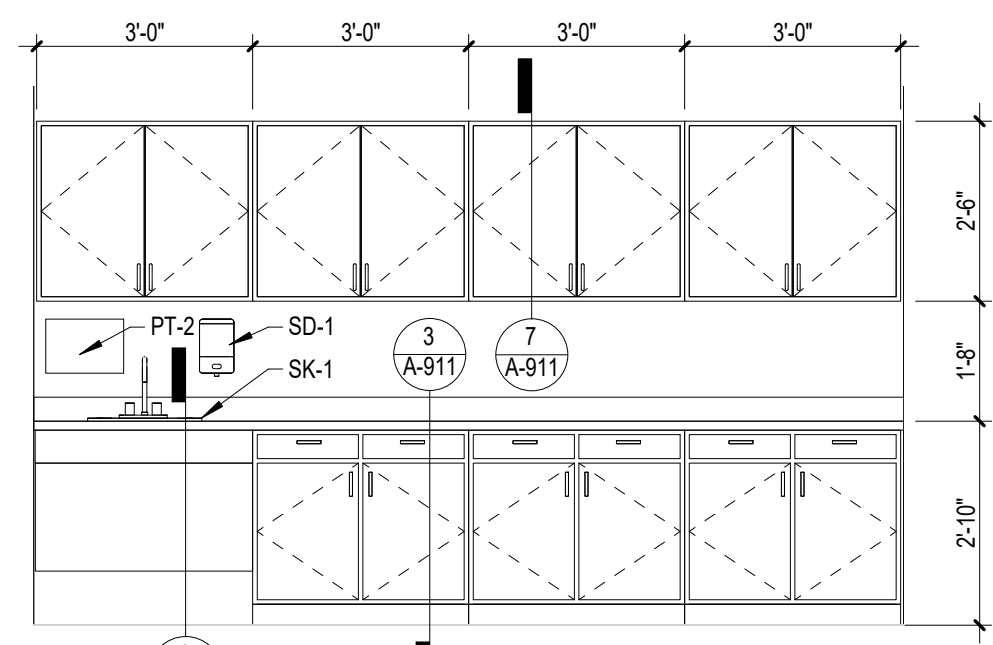


7 Exam Room 007 - North
3/8" = 1'-0"

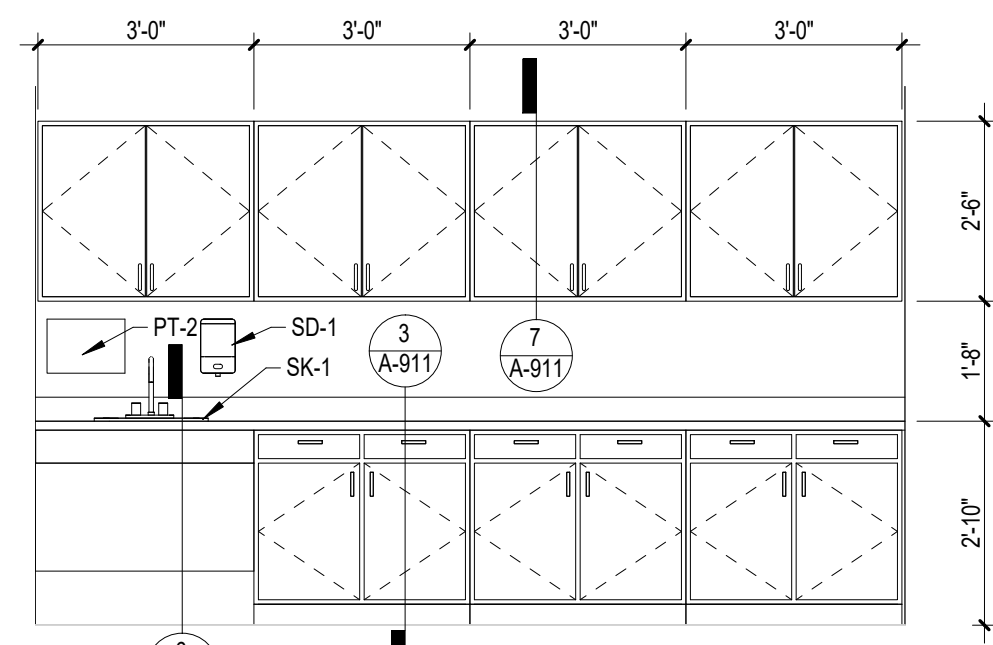


8 Exam Room 008 - North
3/8" = 1'-0"

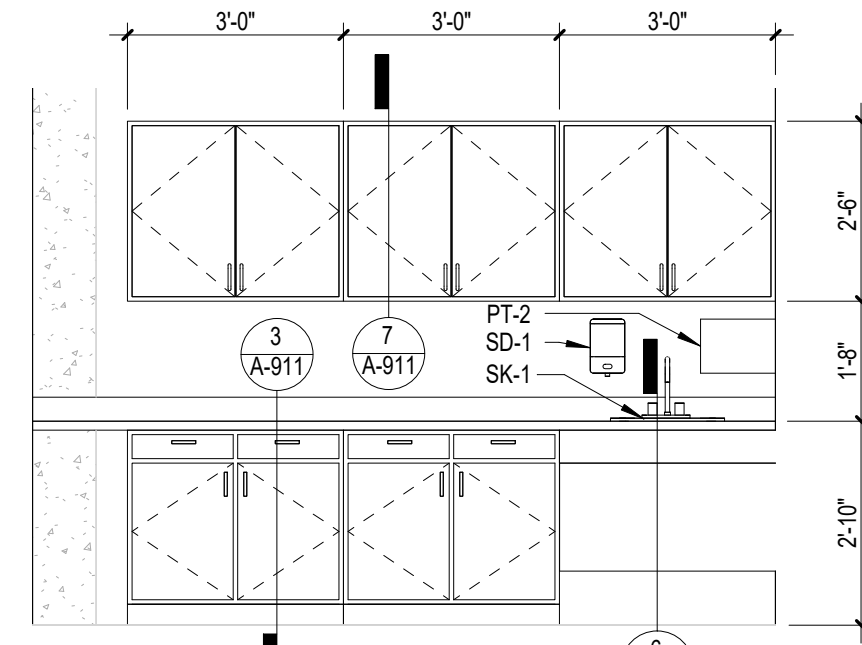

9 Exam Room 009 - North
3/8" = 1'-0"

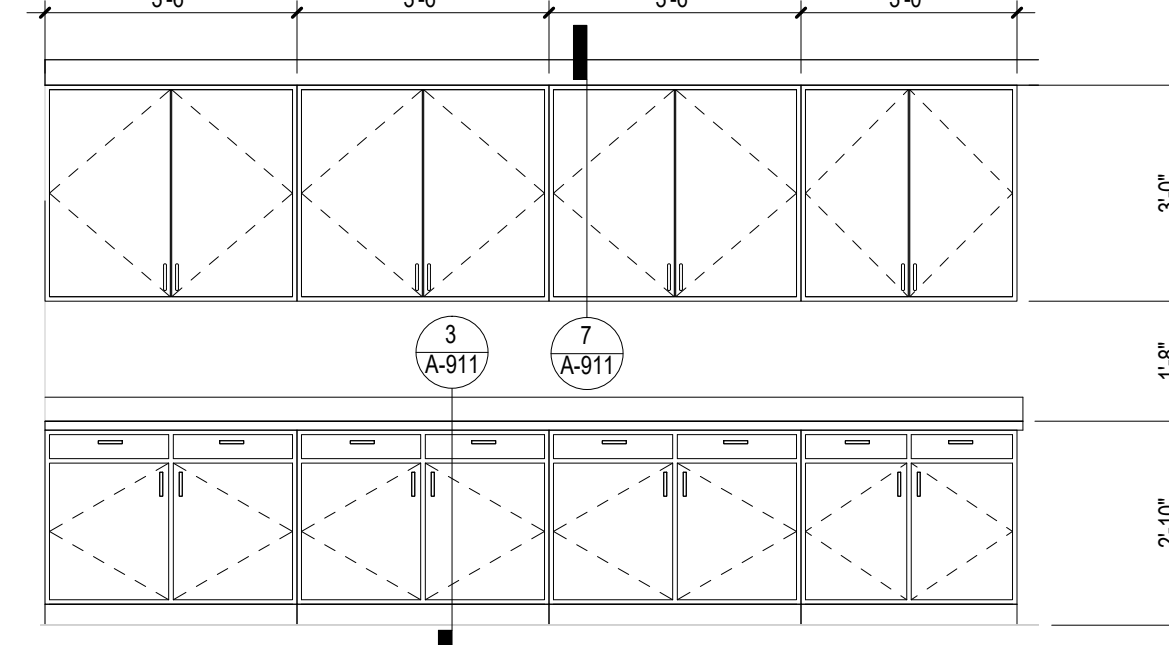


10 Corridor 010 - North
3/8" = 1'-0"

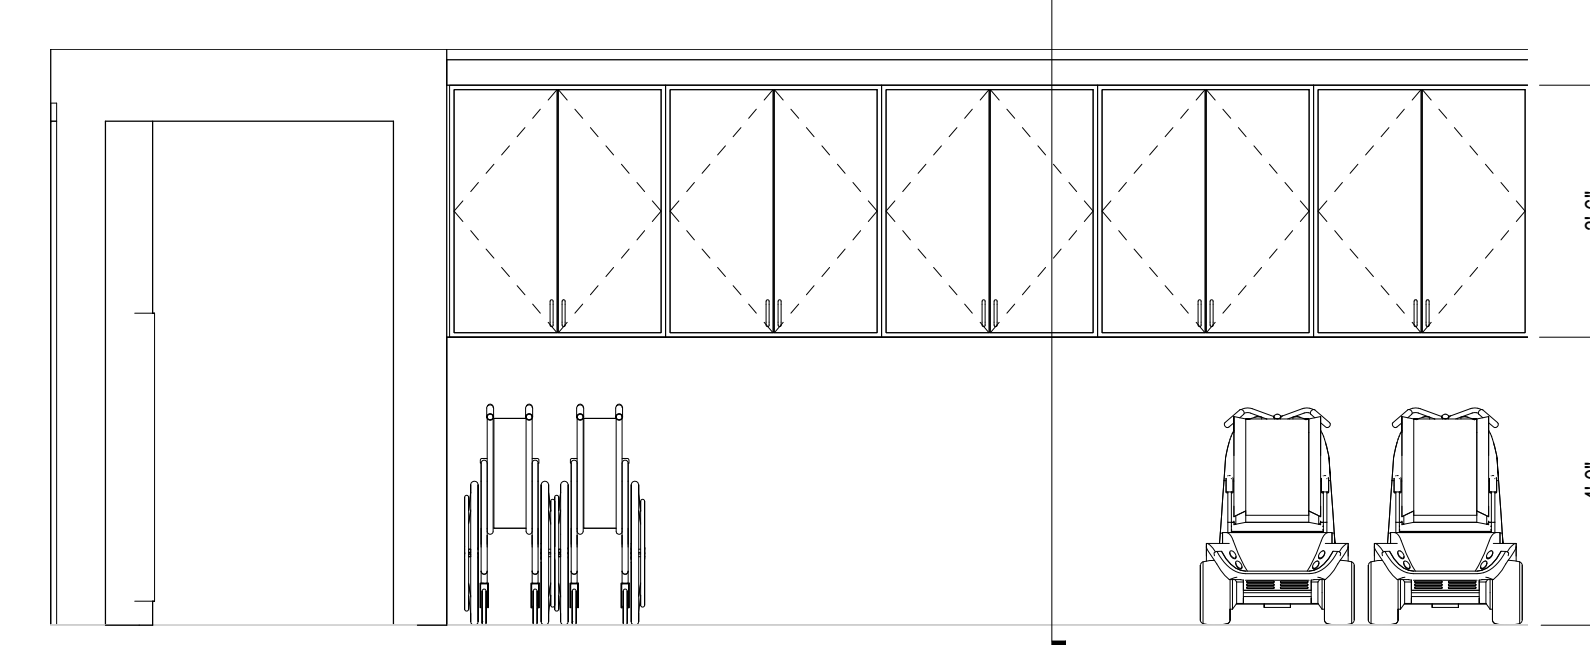


11 Corridor 010 - South
3/8" = 1'-0"

C


C

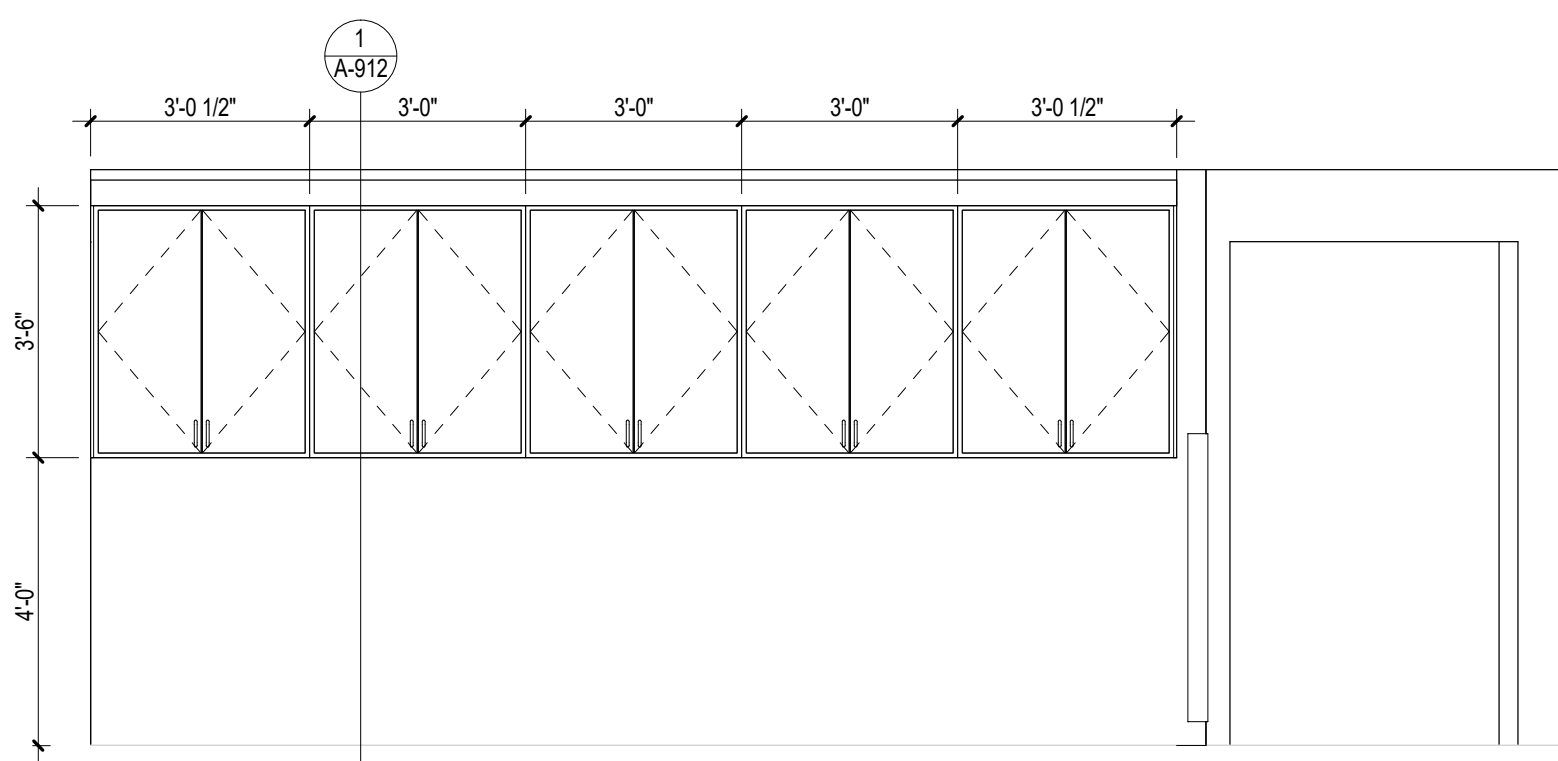


12 Work Room 013 - North
3/8" = 1'-0"

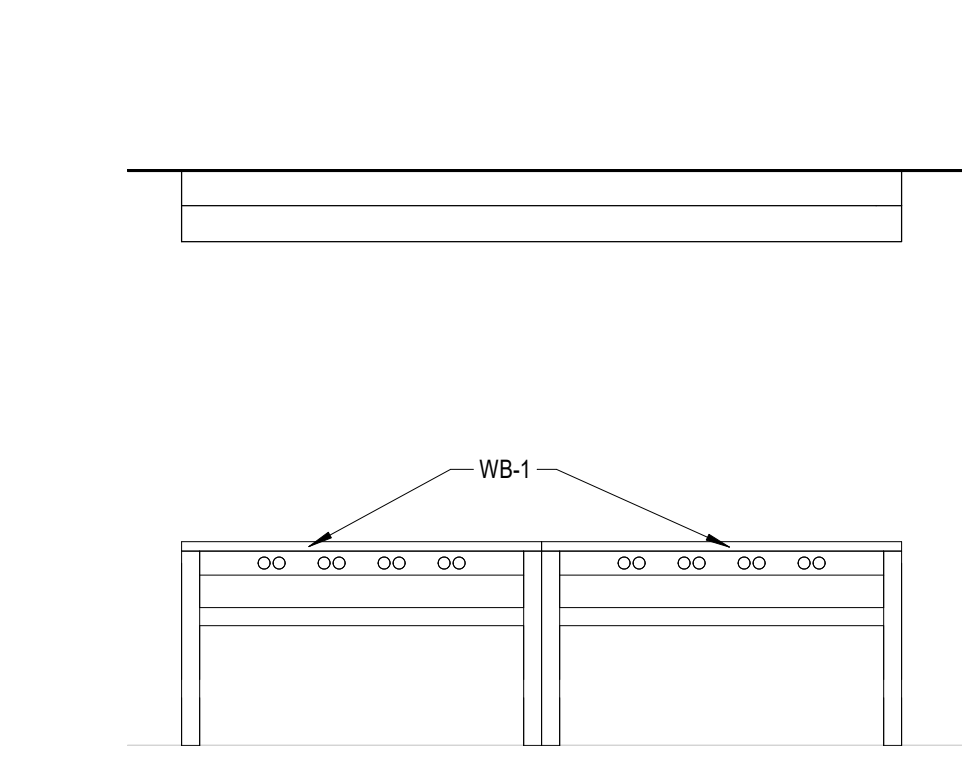


13 Work Room 013 - Mid South
3/8" = 1'-0"

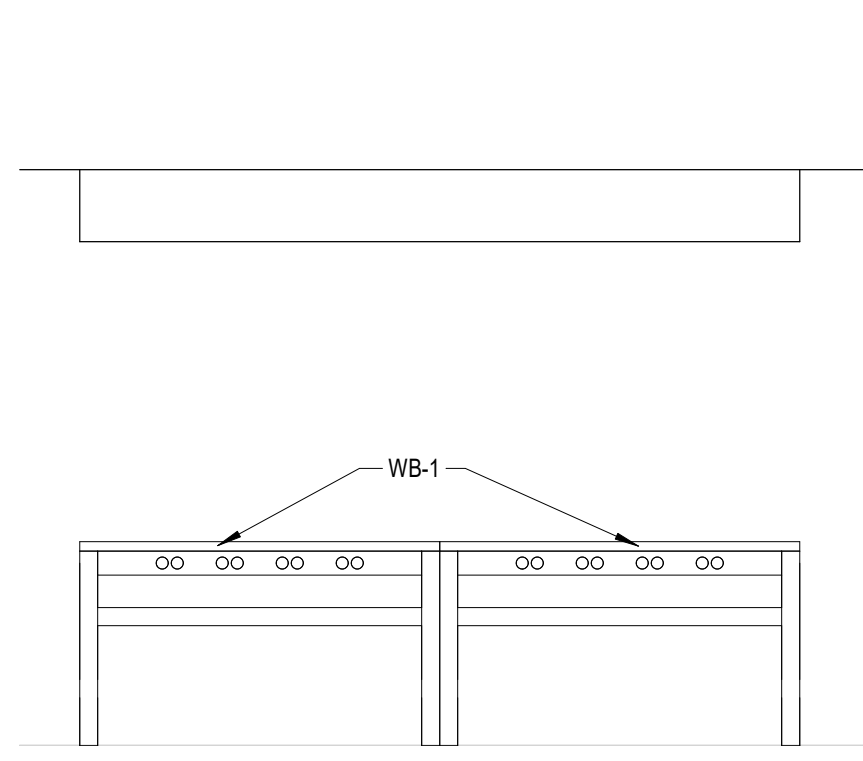


14 Work Room 013 - Mid North
3/8" = 1'-0"

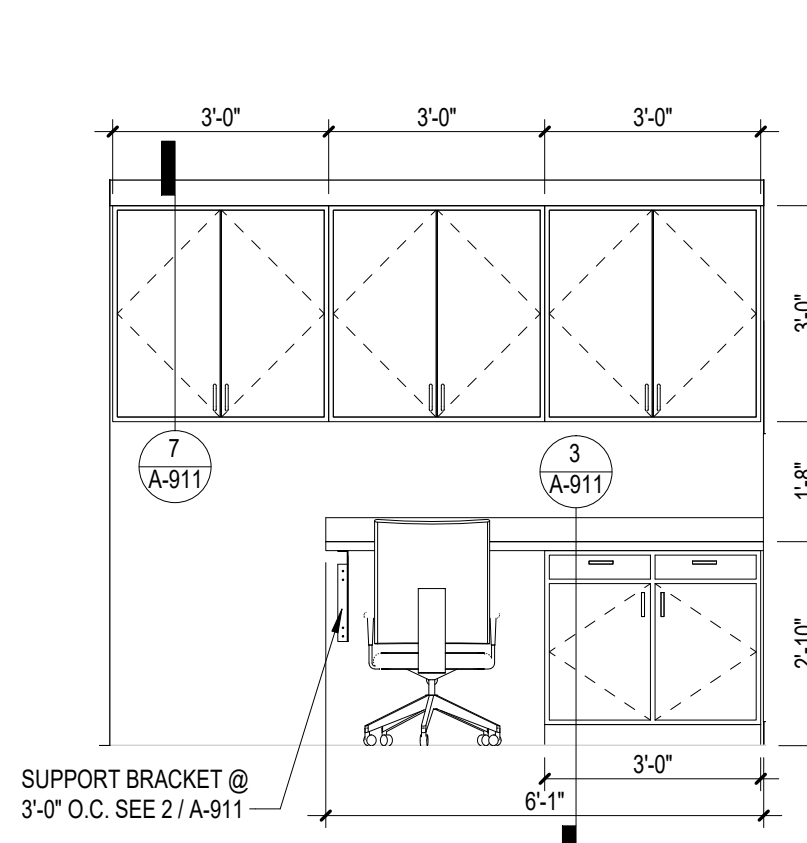

15 Work Room 013 - South
3/8" = 1'-0"

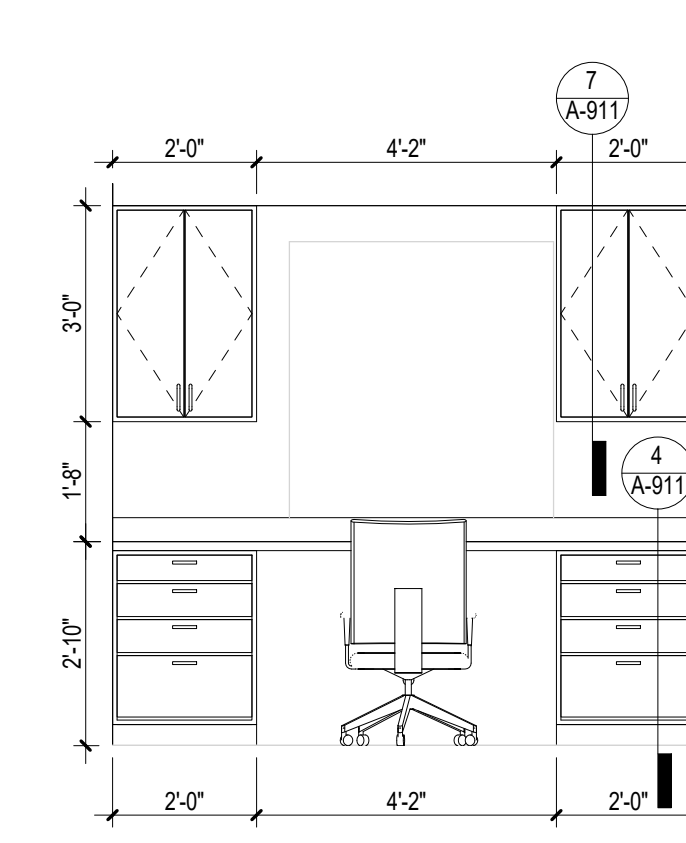


16 Work Room 013 - West
3/8" = 1'-0"

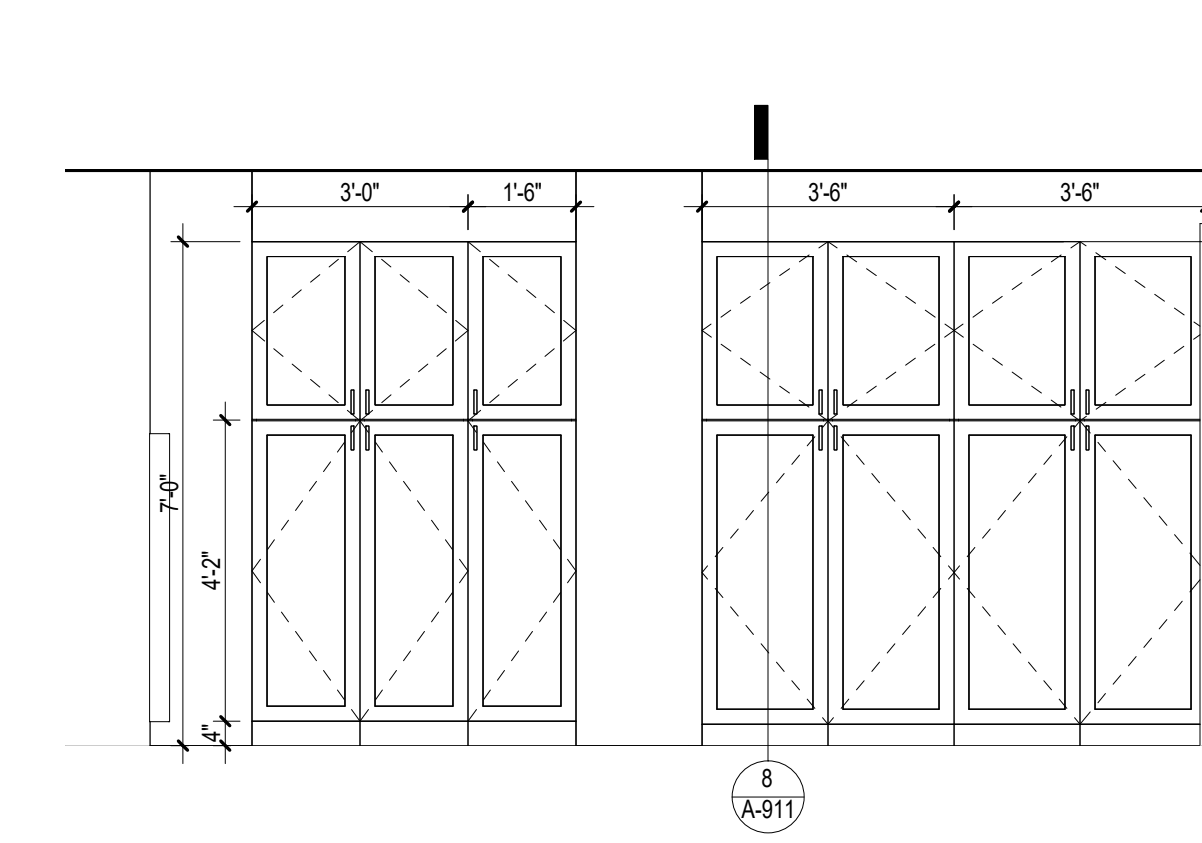


17 Work Room 013 - East
3/8" = 1'-0"

D


D

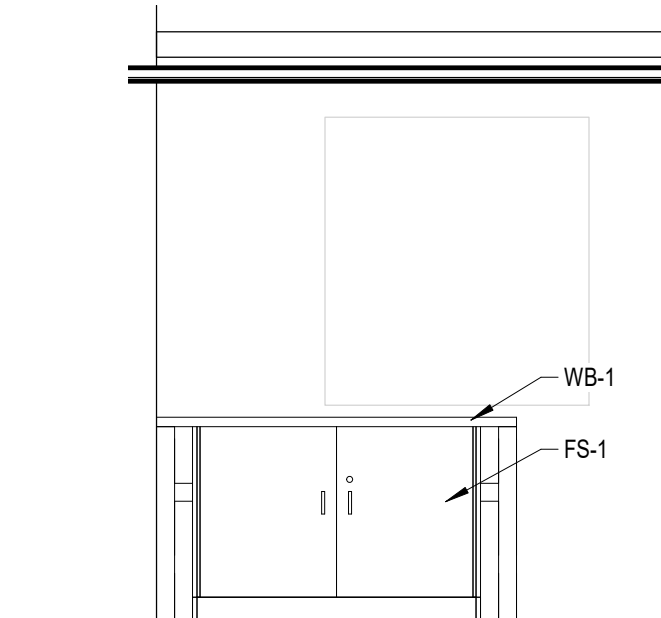


18 Work Room 015 - South
3/8" = 1'-0"

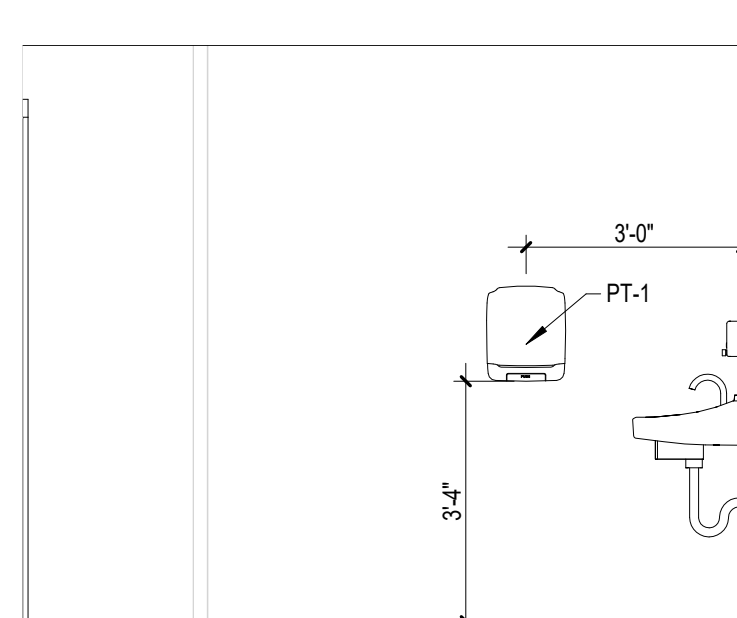


19 Women 016 - North
3/8" = 1'-0"

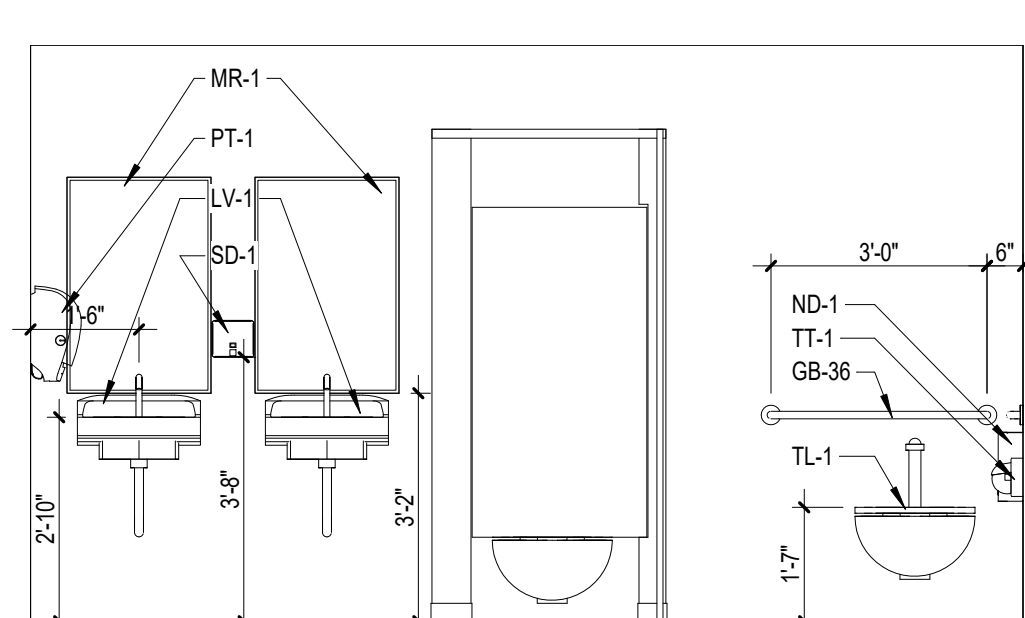

20 Women 016 - East
3/8" = 1'-0"

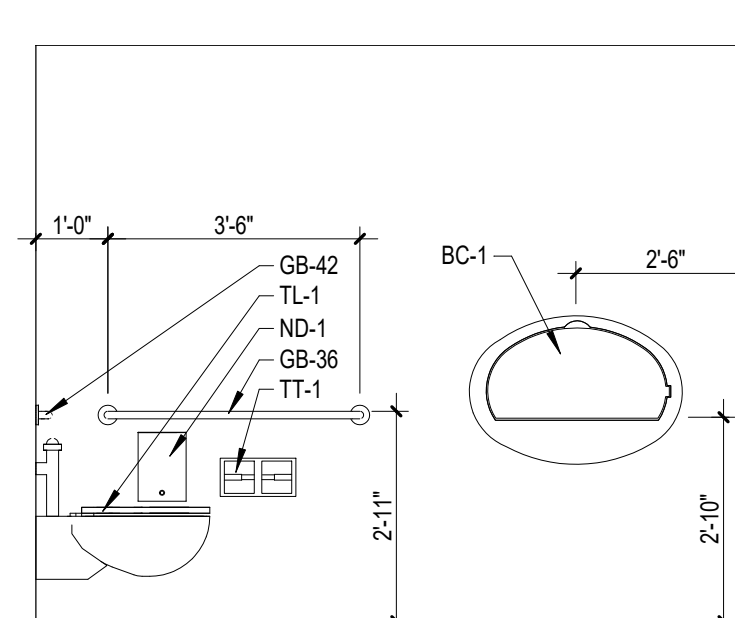

21 Women 016 - South
3/8" = 1'-0"

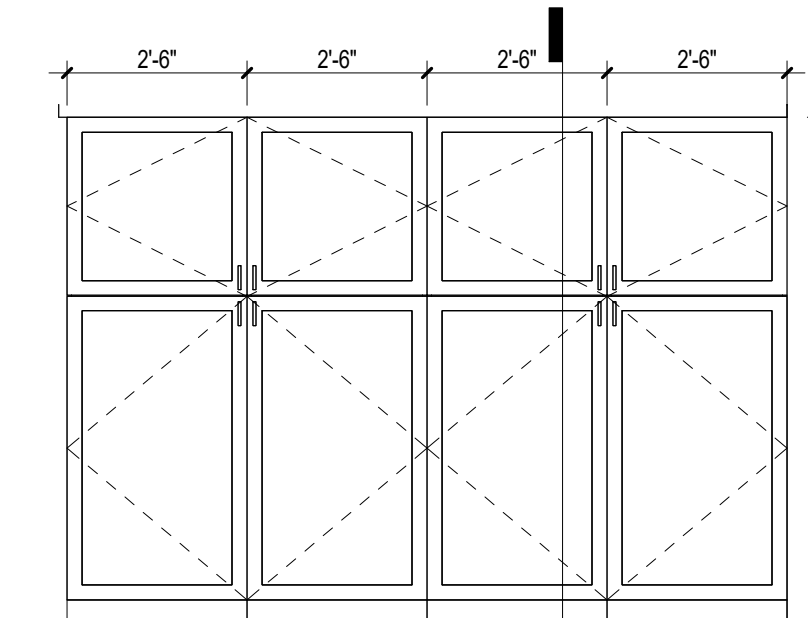

22 Corridor 018 - South
3/8" = 1'-0"

E

E

F

F

9/23/2021 9:47:21 PM
9/23/2021 9:47:21 PM
BIM 360://2021-03-30/A7-21-108 - Renovate and Repair Structural Building 4/R21-102/103.rvt

Revisions:	Date:

ARCHITECT/ENGINEER OF RECORD

ALESIA ARCHITECTURE
Alesia Architecture P.C.
3705 North 200th Street
Elkhorn, Nebraska 68022
Phone: 402.291.6941

IMEG S3
SHAFER STEVENS SCHAAP STRUCTURAL ENGINEERS
IMEG Corp.
15 Saurman Drive,
Suite 104
St. Louis, MO 63143
Phone: (314) 951-2534

9910 North 48th Street, Ste 204, Omaha, NE 68152
402.455.7698
www.s3cp.com

STAMP

Office of Construction and Facilities Management

VA U.S. Department of Veterans Affairs

Drawing Title
INTERIOR ELEVATIONS

Approved:

Phase
BID DOCUMENTS

FULLY SPRINKLERED

Project Title
Renovate and Repair Structural, Building 4

Location
Wichita, KS

Issue Date
9/23/2021

Checked


Drawn

Project Number
589A7-21-108


Building Number
4

Drawing Number
A-901


A

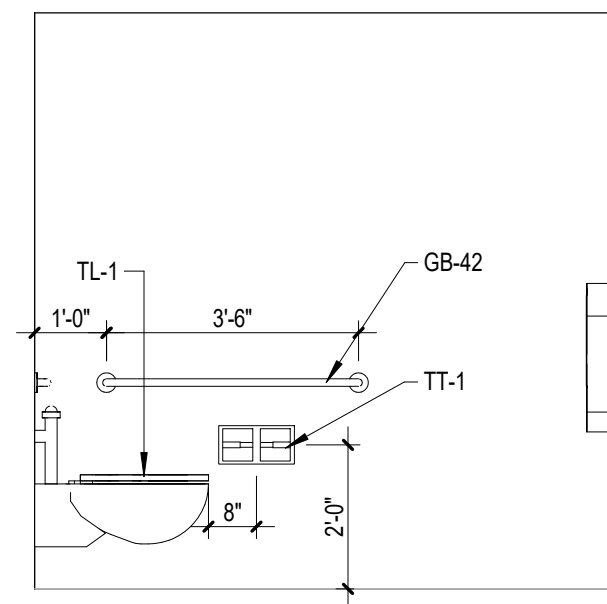


1 Men 017 - East
3/8" = 1'-0"

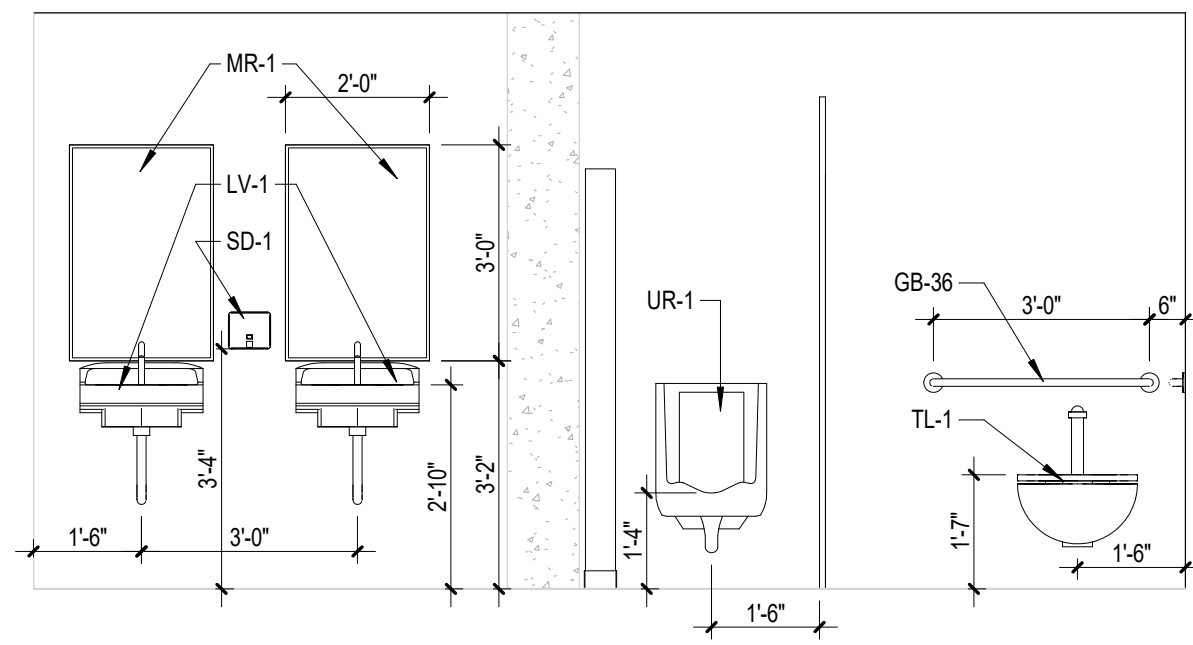


2 Men 017 - North
3/8" = 1'-0"

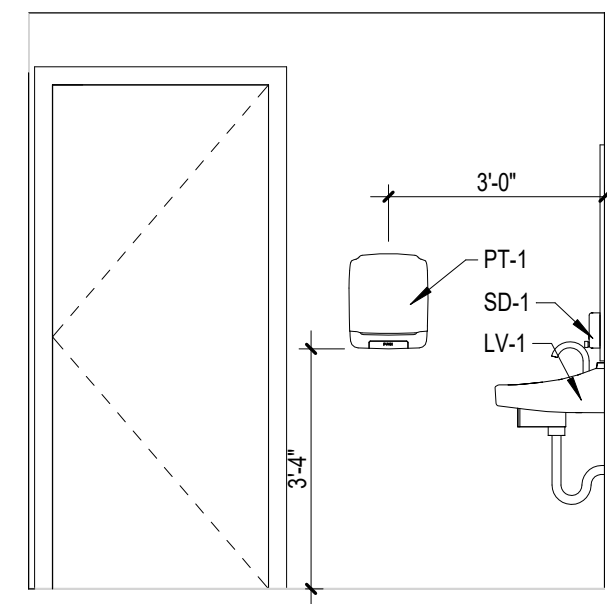


3 Men 017 - West
3/8" = 1'-0"

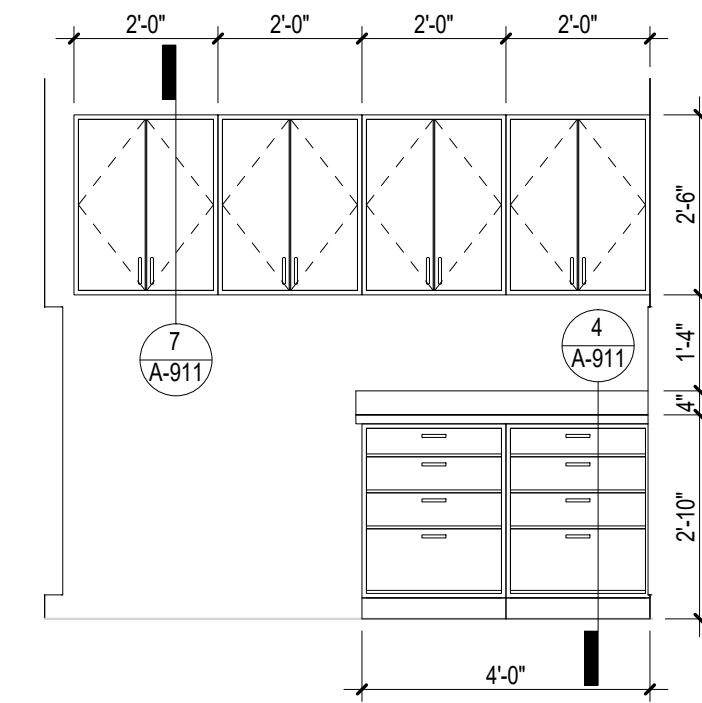


4 Corridor 018 - West
3/8" = 1'-0"

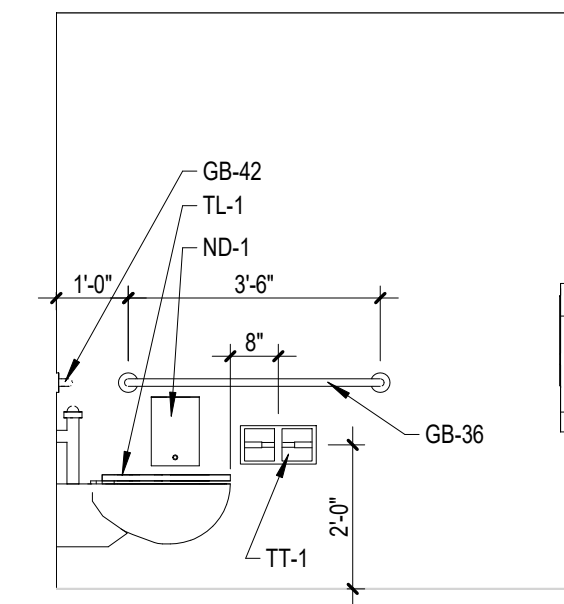

5 Staff 020 - North
3/8" = 1'-0"

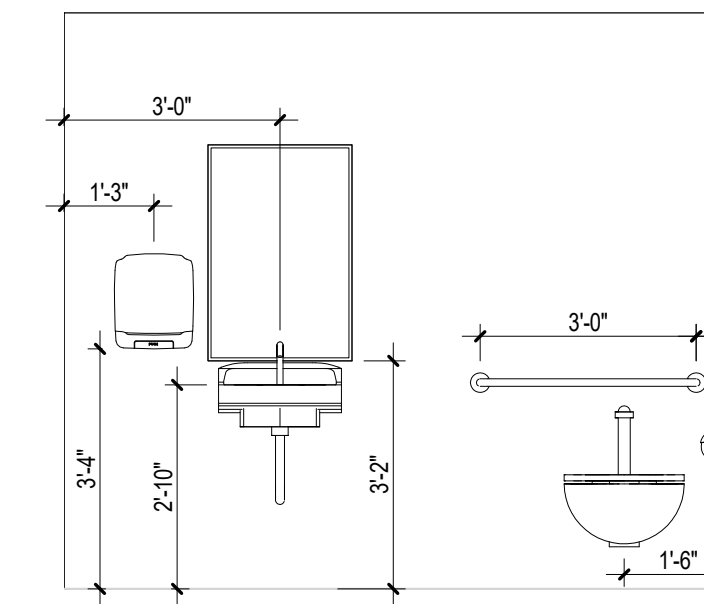


6 Staff 020 - West
3/8" = 1'-0"

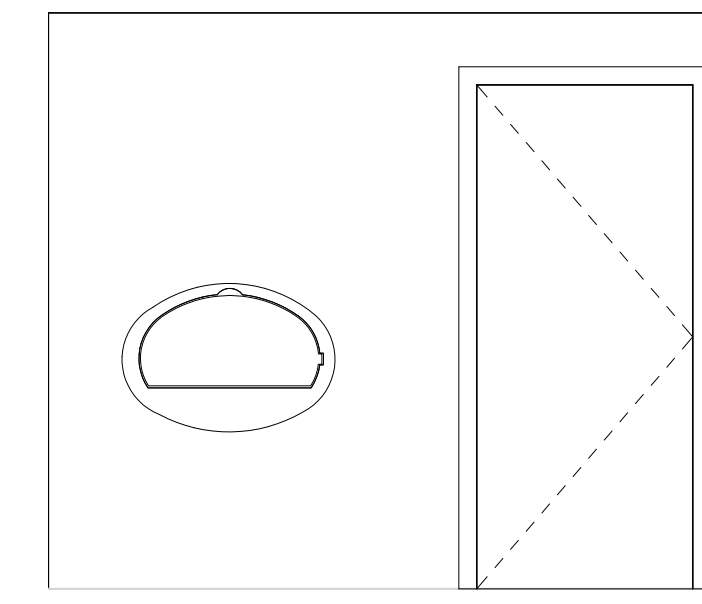


7 Staff 020 - East
3/8" = 1'-0"


B

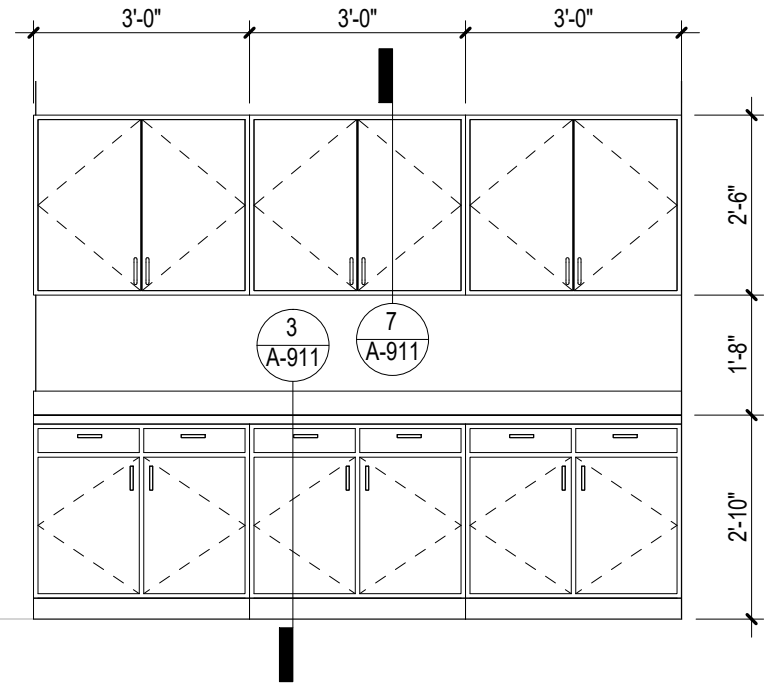


8 Storage / Mailouts 024 - North
3/8" = 1'-0"

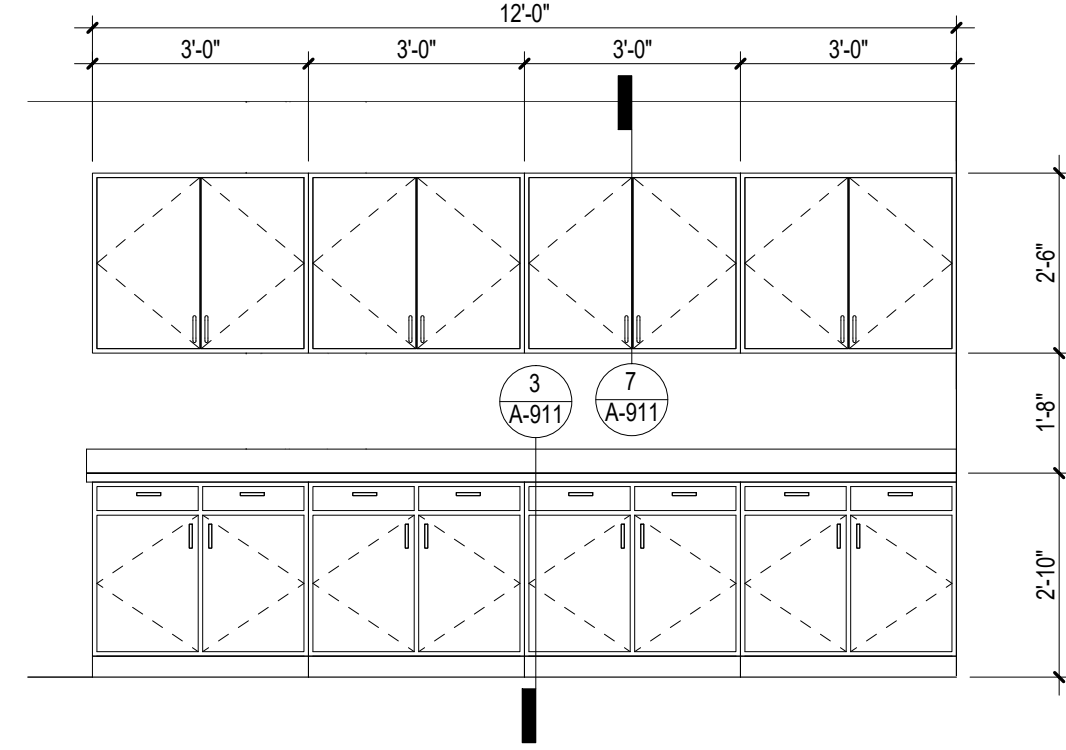


9 Storage / Mailouts 024 - West
3/8" = 1'-0"

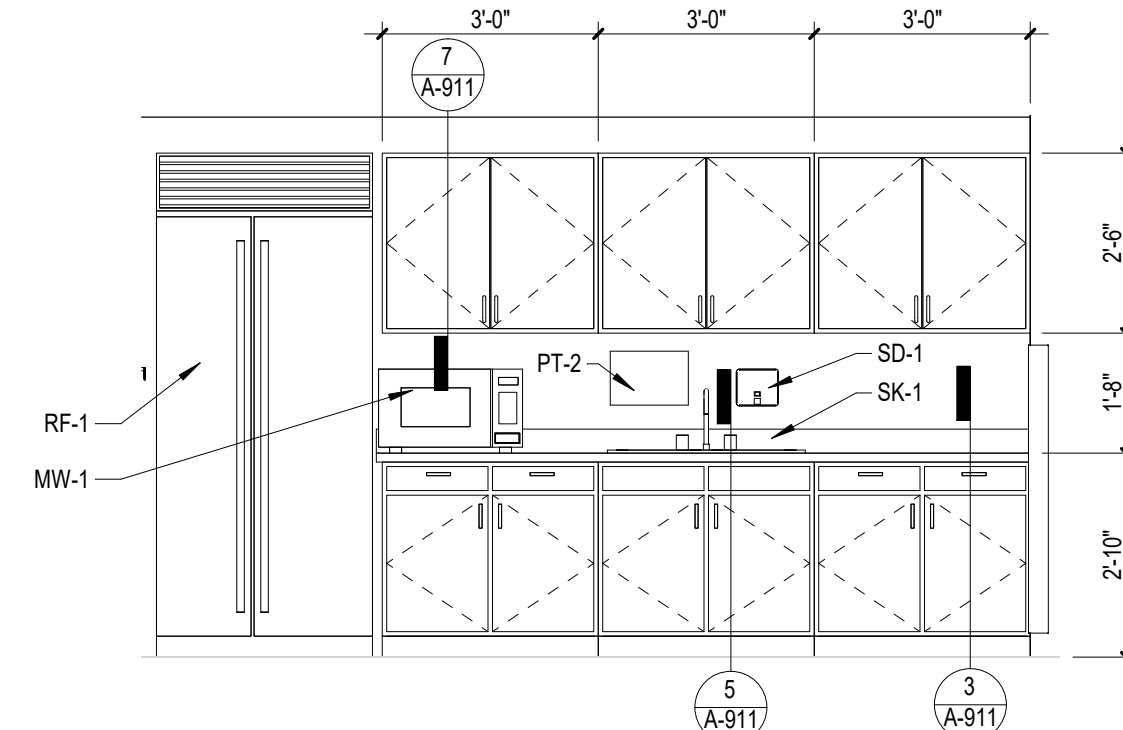

10 Open Office 027 - West
3/8" = 1'-0"

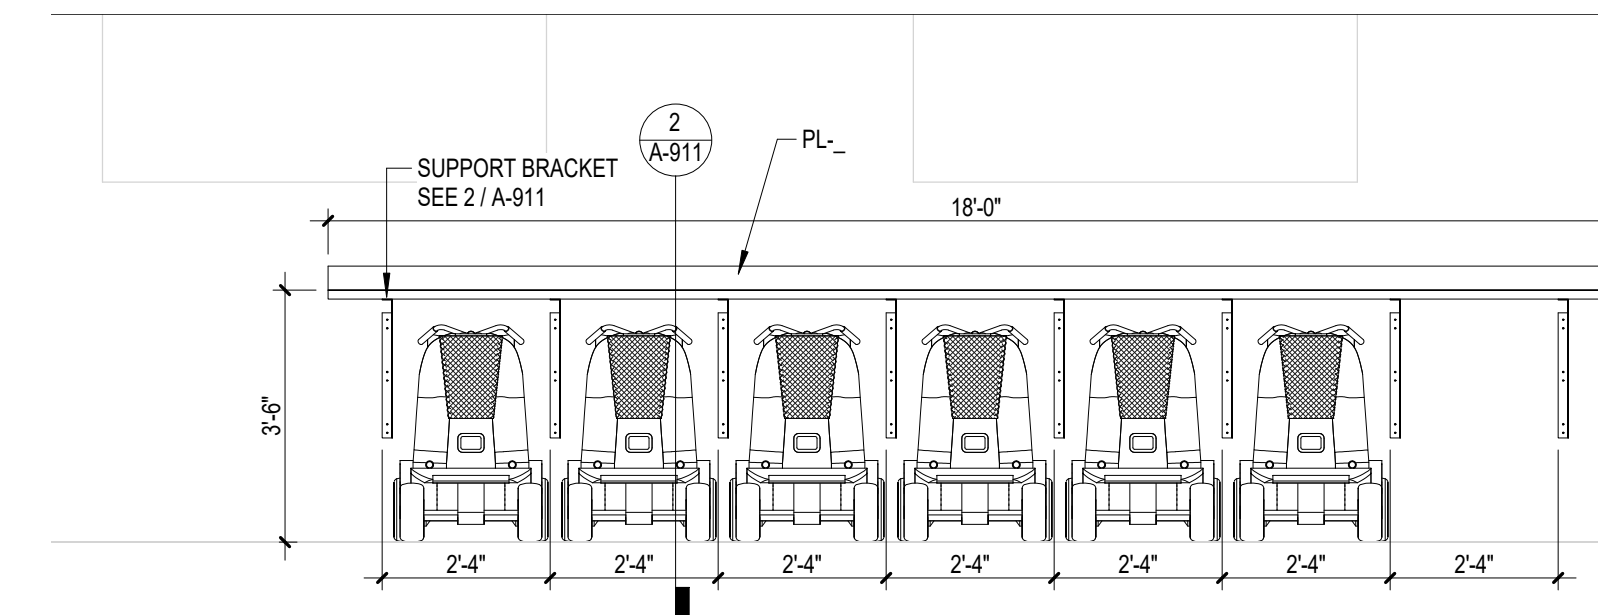


11 Storage 028 - North
3/8" = 1'-0"

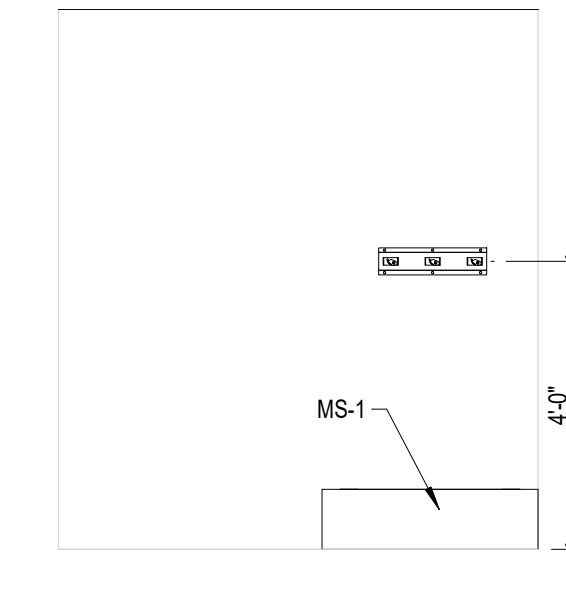


12 Housekeeping 107 - West
3/8" = 1'-0"


C

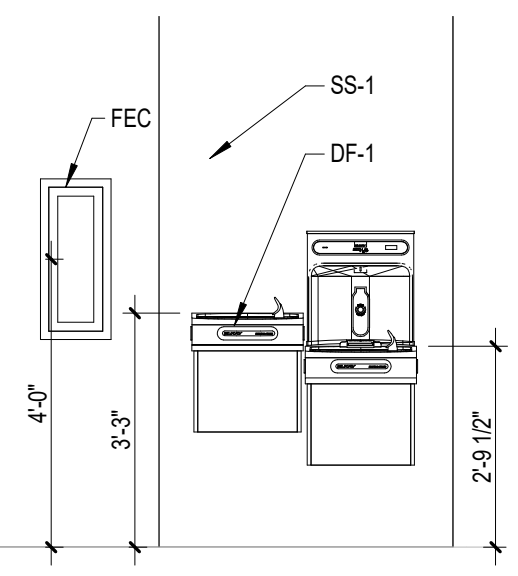


13 Lobby 109 - North
3/8" = 1'-0"

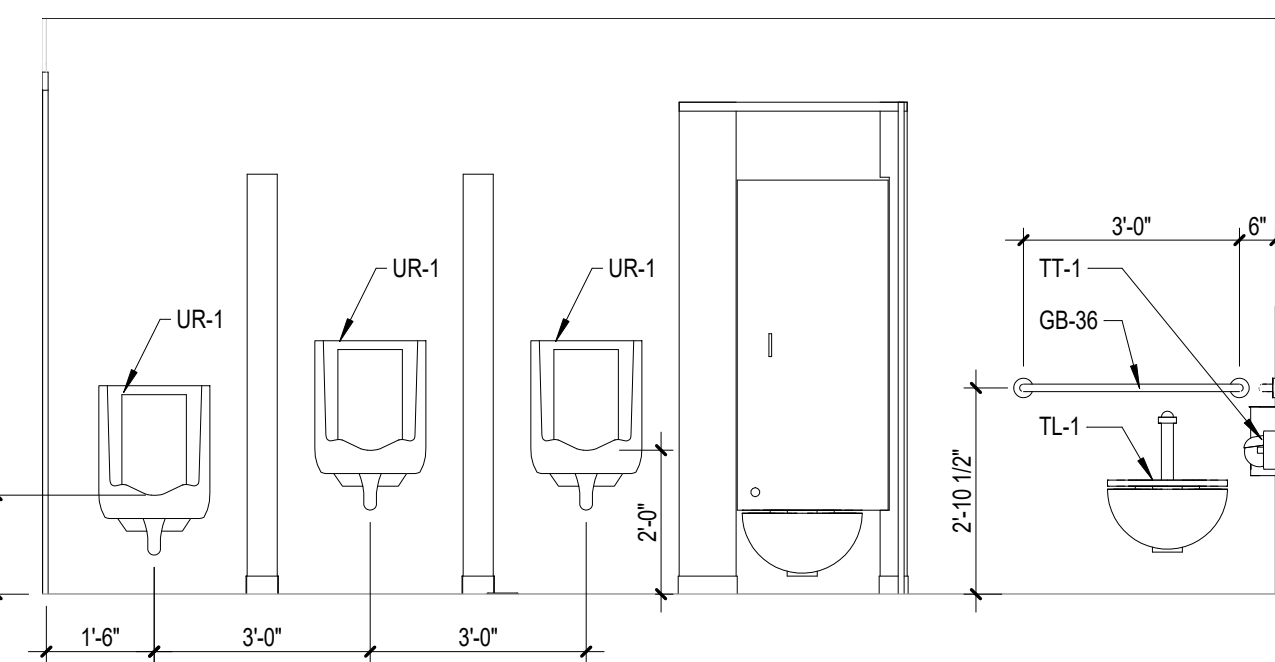


14 Men 112 - East
3/8" = 1'-0"

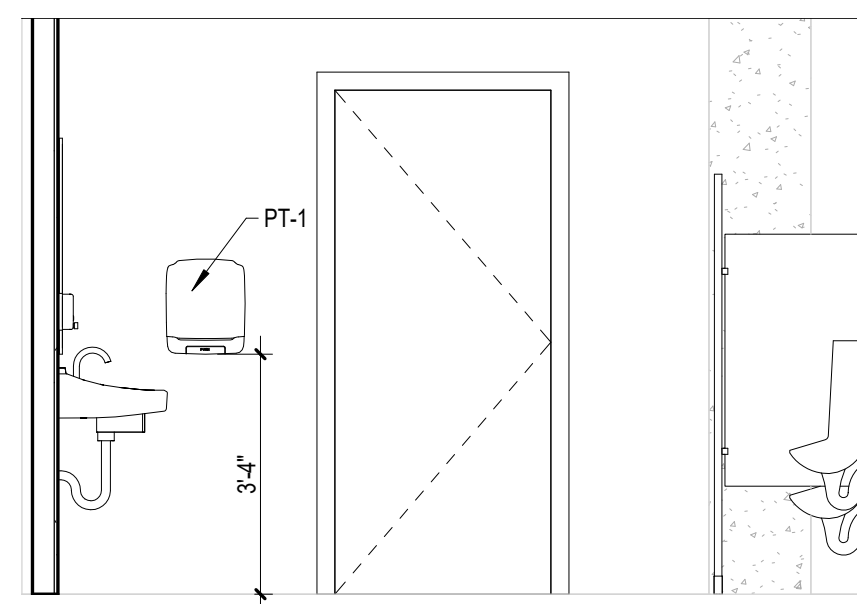

15 Men 112 - North
3/8" = 1'-0"

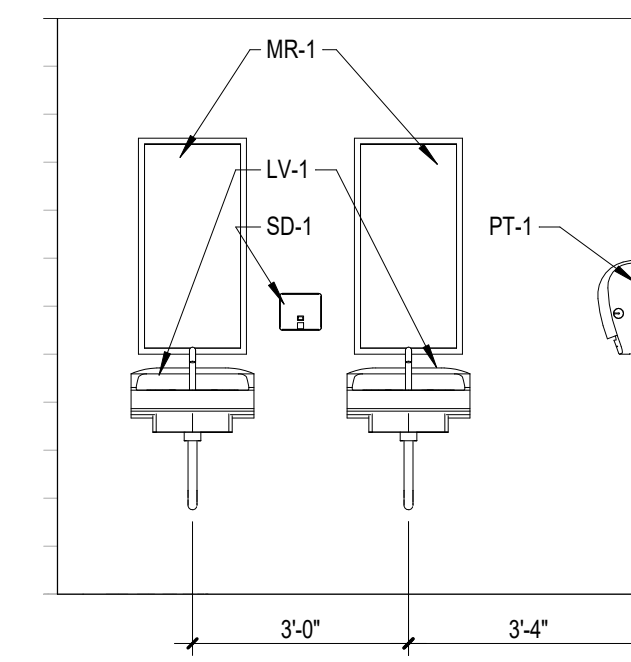


16 Men 112 - West
3/8" = 1'-0"

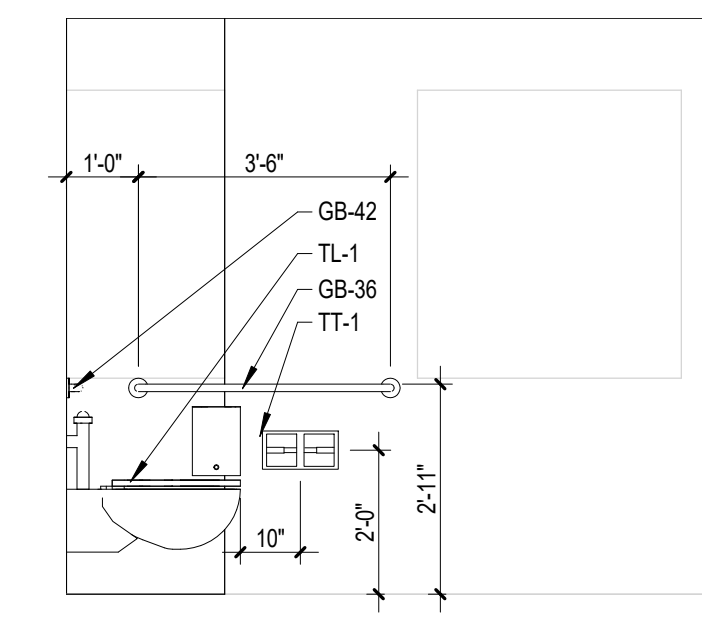


17 Men 112 - South
3/8" = 1'-0"


D

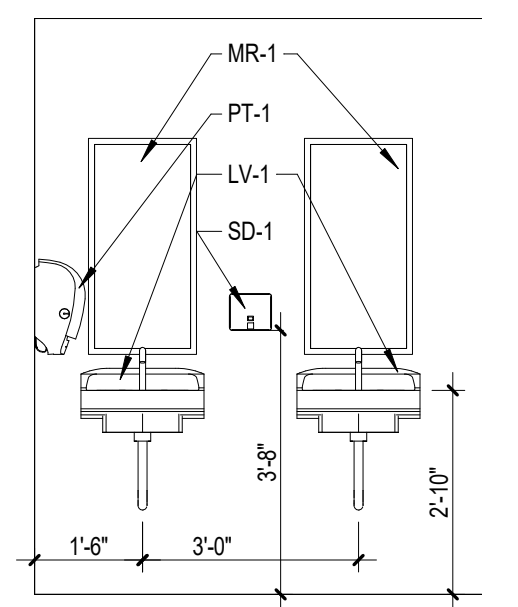


18 Women 113 - East
3/8" = 1'-0"

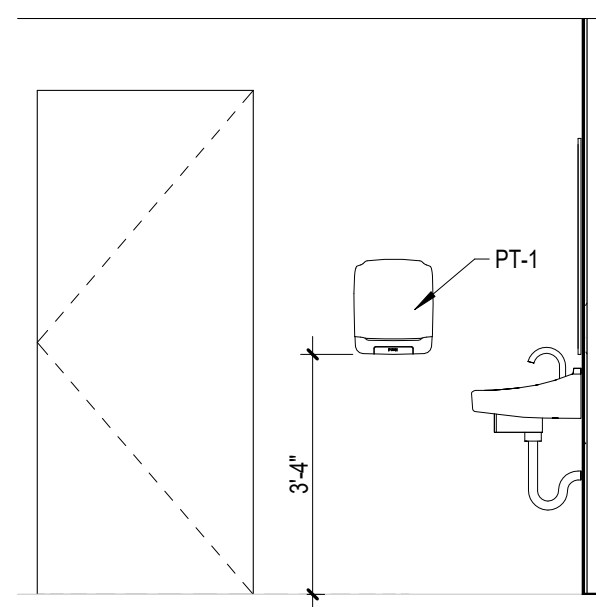


19 Women 113 - North
3/8" = 1'-0"

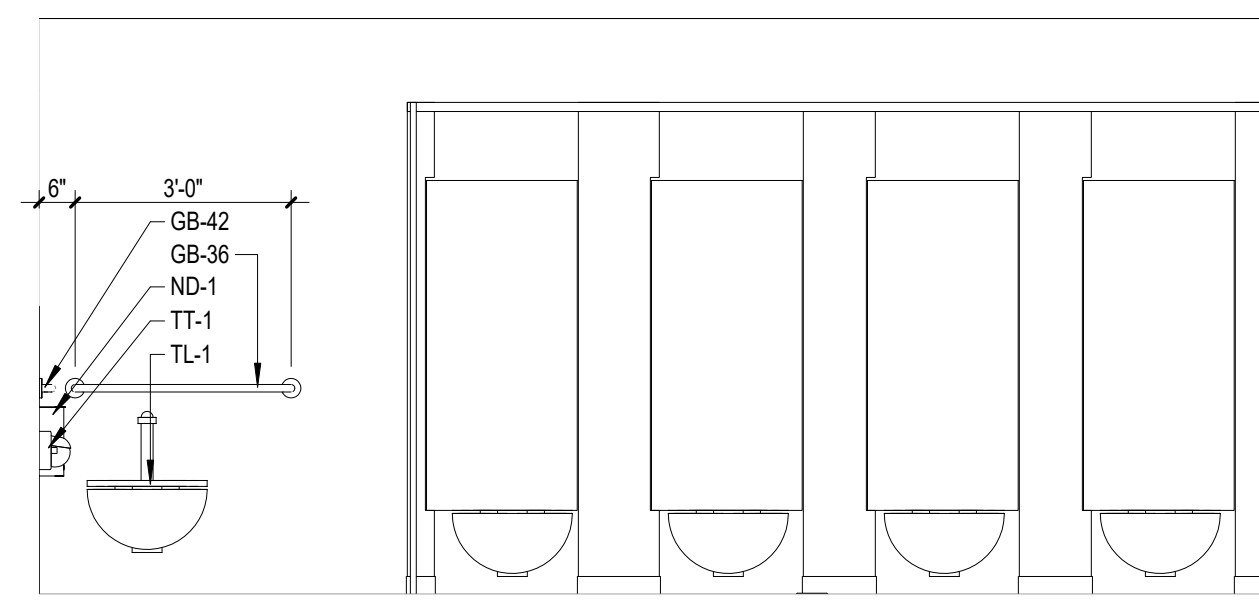

20 Women 113 - West
3/8" = 1'-0"

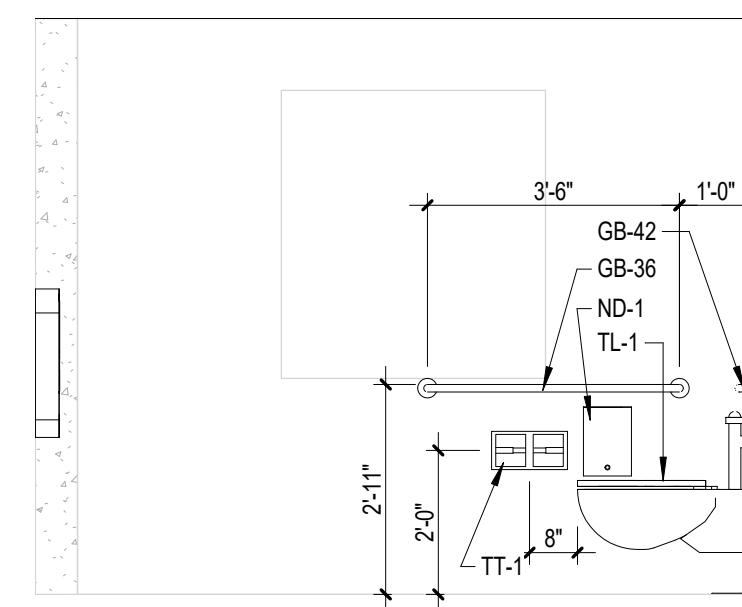

21 Women 113 - South
3/8" = 1'-0"

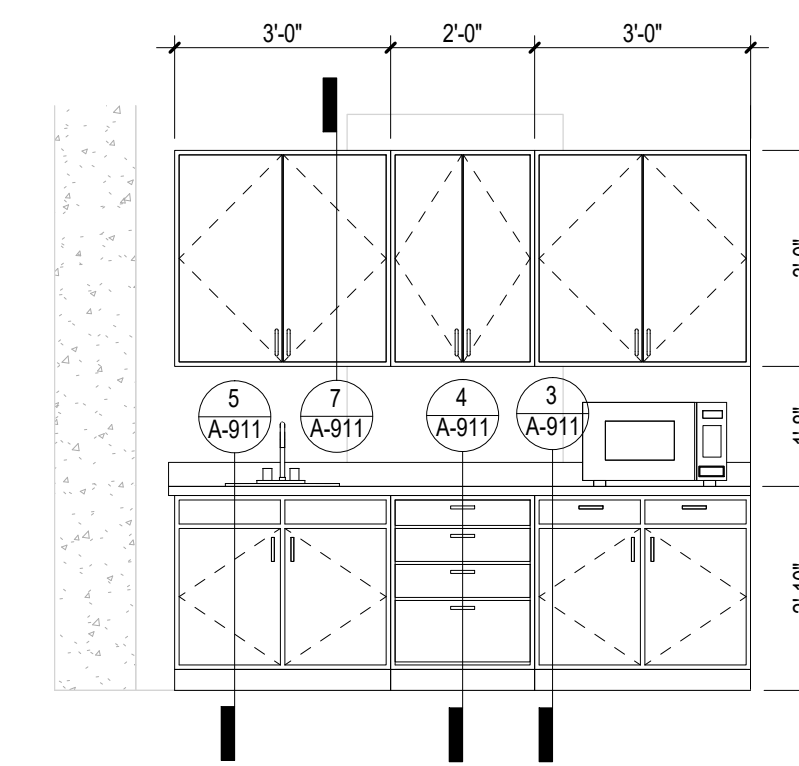

22 Kitchen 100 - South
3/8" = 1'-0"

E

F

9/23/2021 9:47:25 PM
 BIM 360://021-103-589A7-21-108 - Renovate and Repair Structural Building 4/21-102103.rvt

Revisions:	Date:

ARCHITECT/ENGINEER OF RECORD

ALESIA ARCHITECTURE
 Alesia Architecture P.C.
 3705 North 200th Street
 Elkhorn, Nebraska 68022
 Phone: 402.291.6941

IMEG S3
 SHAFER STEVENS SCHAAP
 STRUCTURAL ENGINEERS
 IMEG Corp.
 15 Sureson Drive,
 Suite 104
 St. Louis, MO 63143
 Phone: (314) 951-2534

STAMP

Professional Engineer Seal for Richard Schaffner, State of Nebraska, No. 25125, dated 9/23/2021.

Office of Construction and Facilities Management

VA U.S. Department of Veterans Affairs

Drawing Title
INTERIOR ELEVATIONS

Approved: _____

Phase
BID DOCUMENTS

FULLY SPRINKLERED

Project Title
Renovate and Repair Structural, Building 4

Location
Wichita, KS

Issue Date
9/23/2021

Checked _____
 Drawn _____


Project Number
589A7-21-108

Building Number
4


Drawing Number
A-902

A
B
C
D
E
F


A
B
C
D
E
F

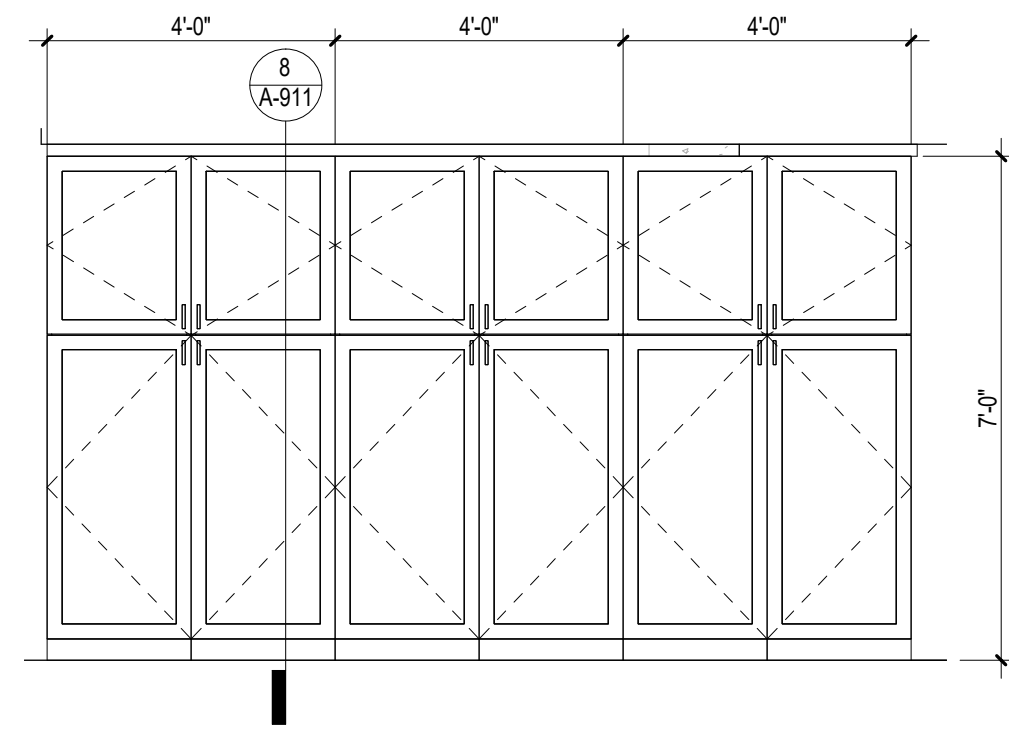


1 Open Office 201 - West
3/8" = 1'-0"

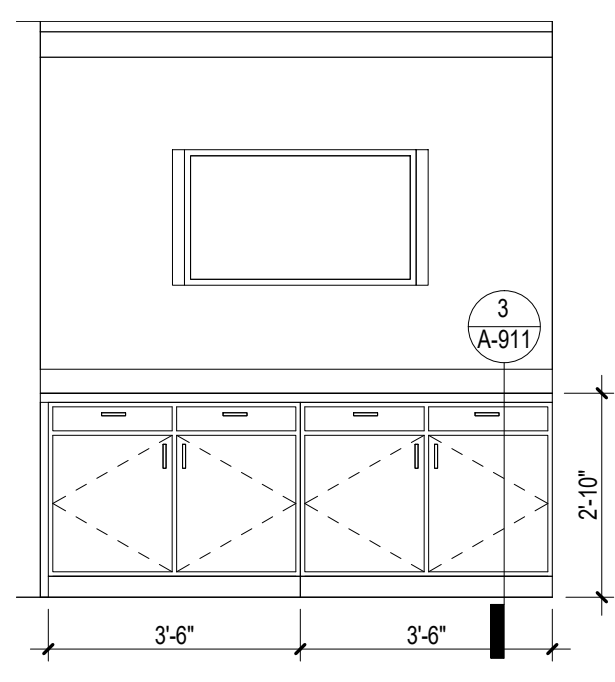


2 Conference 202 - South
3/8" = 1'-0"

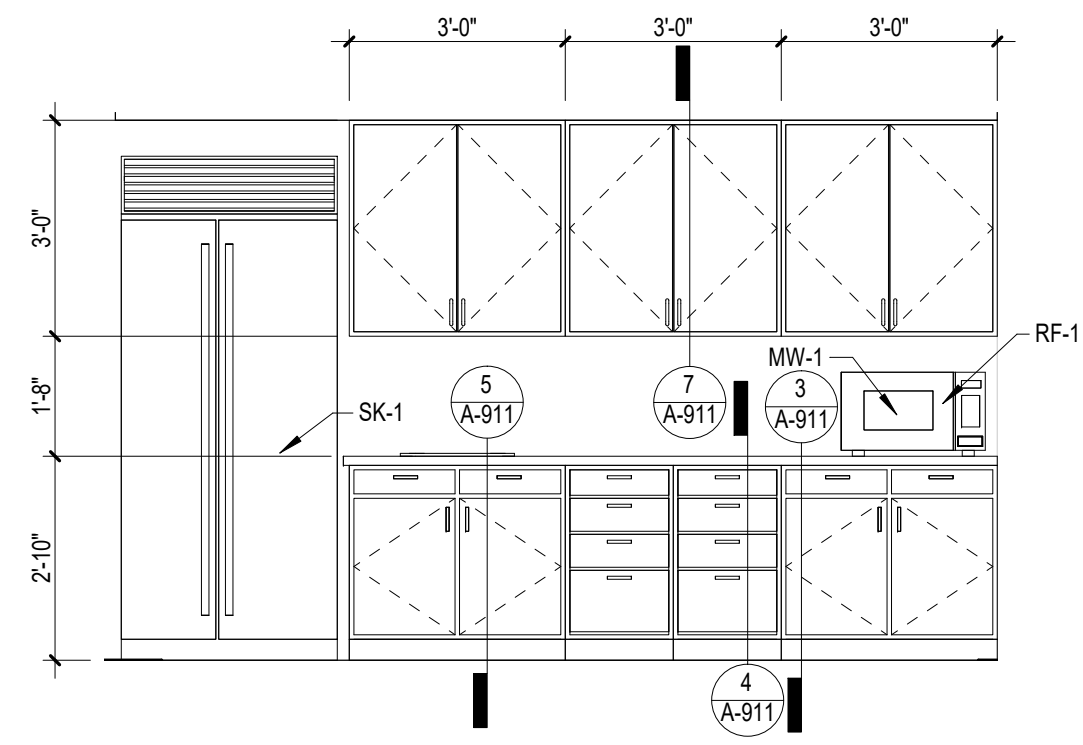

3 Kitchen 205 - South
3/8" = 1'-0"

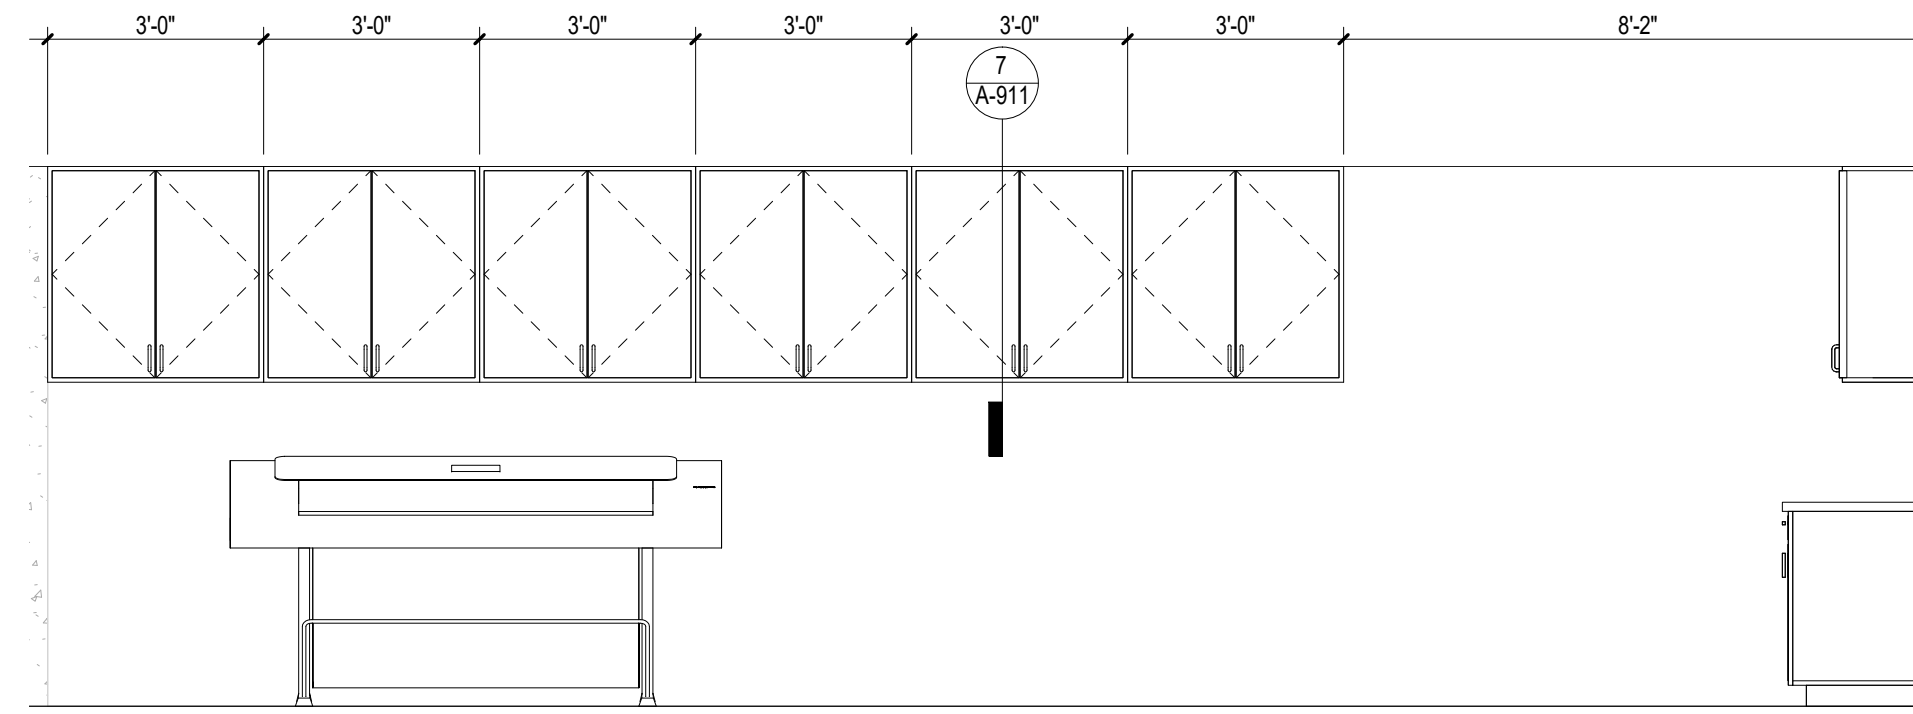

4 Digital Print 206 - West
3/8" = 1'-0"

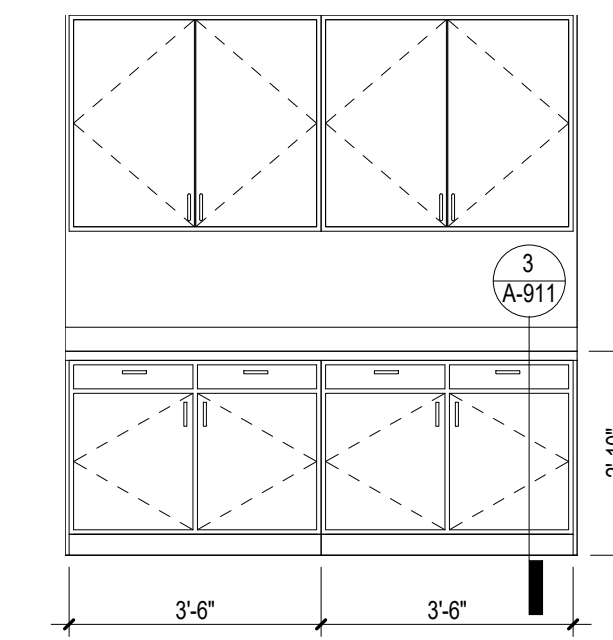

5 Digital Print 206 - North
3/8" = 1'-0"

BIM 360://2021-03-30/9A7-21-108 - Renovate and Repair Structural Building 4/R21-102-103.rvt
 9/23/2021 9:47:34 PM
 VA FORM 08 - 6231

Revisions:	Date:

ARCHITECT/ENGINEER OF RECORD

ALESIA ARCHITECTURE
 Alesia Architecture P.C.
 3705 North 200th Street
 Elkhorn, Nebraska 68022
 Phone: 402.291.6941

IMEG Corp.
 15 Sureson Drive,
 Suite 104
 St. Louis, MO 63143
 Phone: (314) 951-2534

SHAFER STEVENS SCHAAP STRUCTURAL ENGINEERS
 9910 North 48th Street, Ste 204, Omaha, NE 68152
 402.455.7698 www.s3pc.com

STAMP

Office of Construction and Facilities Management

Drawing Title
INTERIOR ELEVATIONS

Approved:

Phase
BID DOCUMENTS

FULLY SPRINKLERED

Project Title
 Renovate and Repair Structural, Building 4

Location
 Wichita, KS

Issue Date
 9/23/2021

Checked


Drawn

Project Number
 589A7-21-108


Building Number
 4

Drawing Number
A-903


A B C D E F

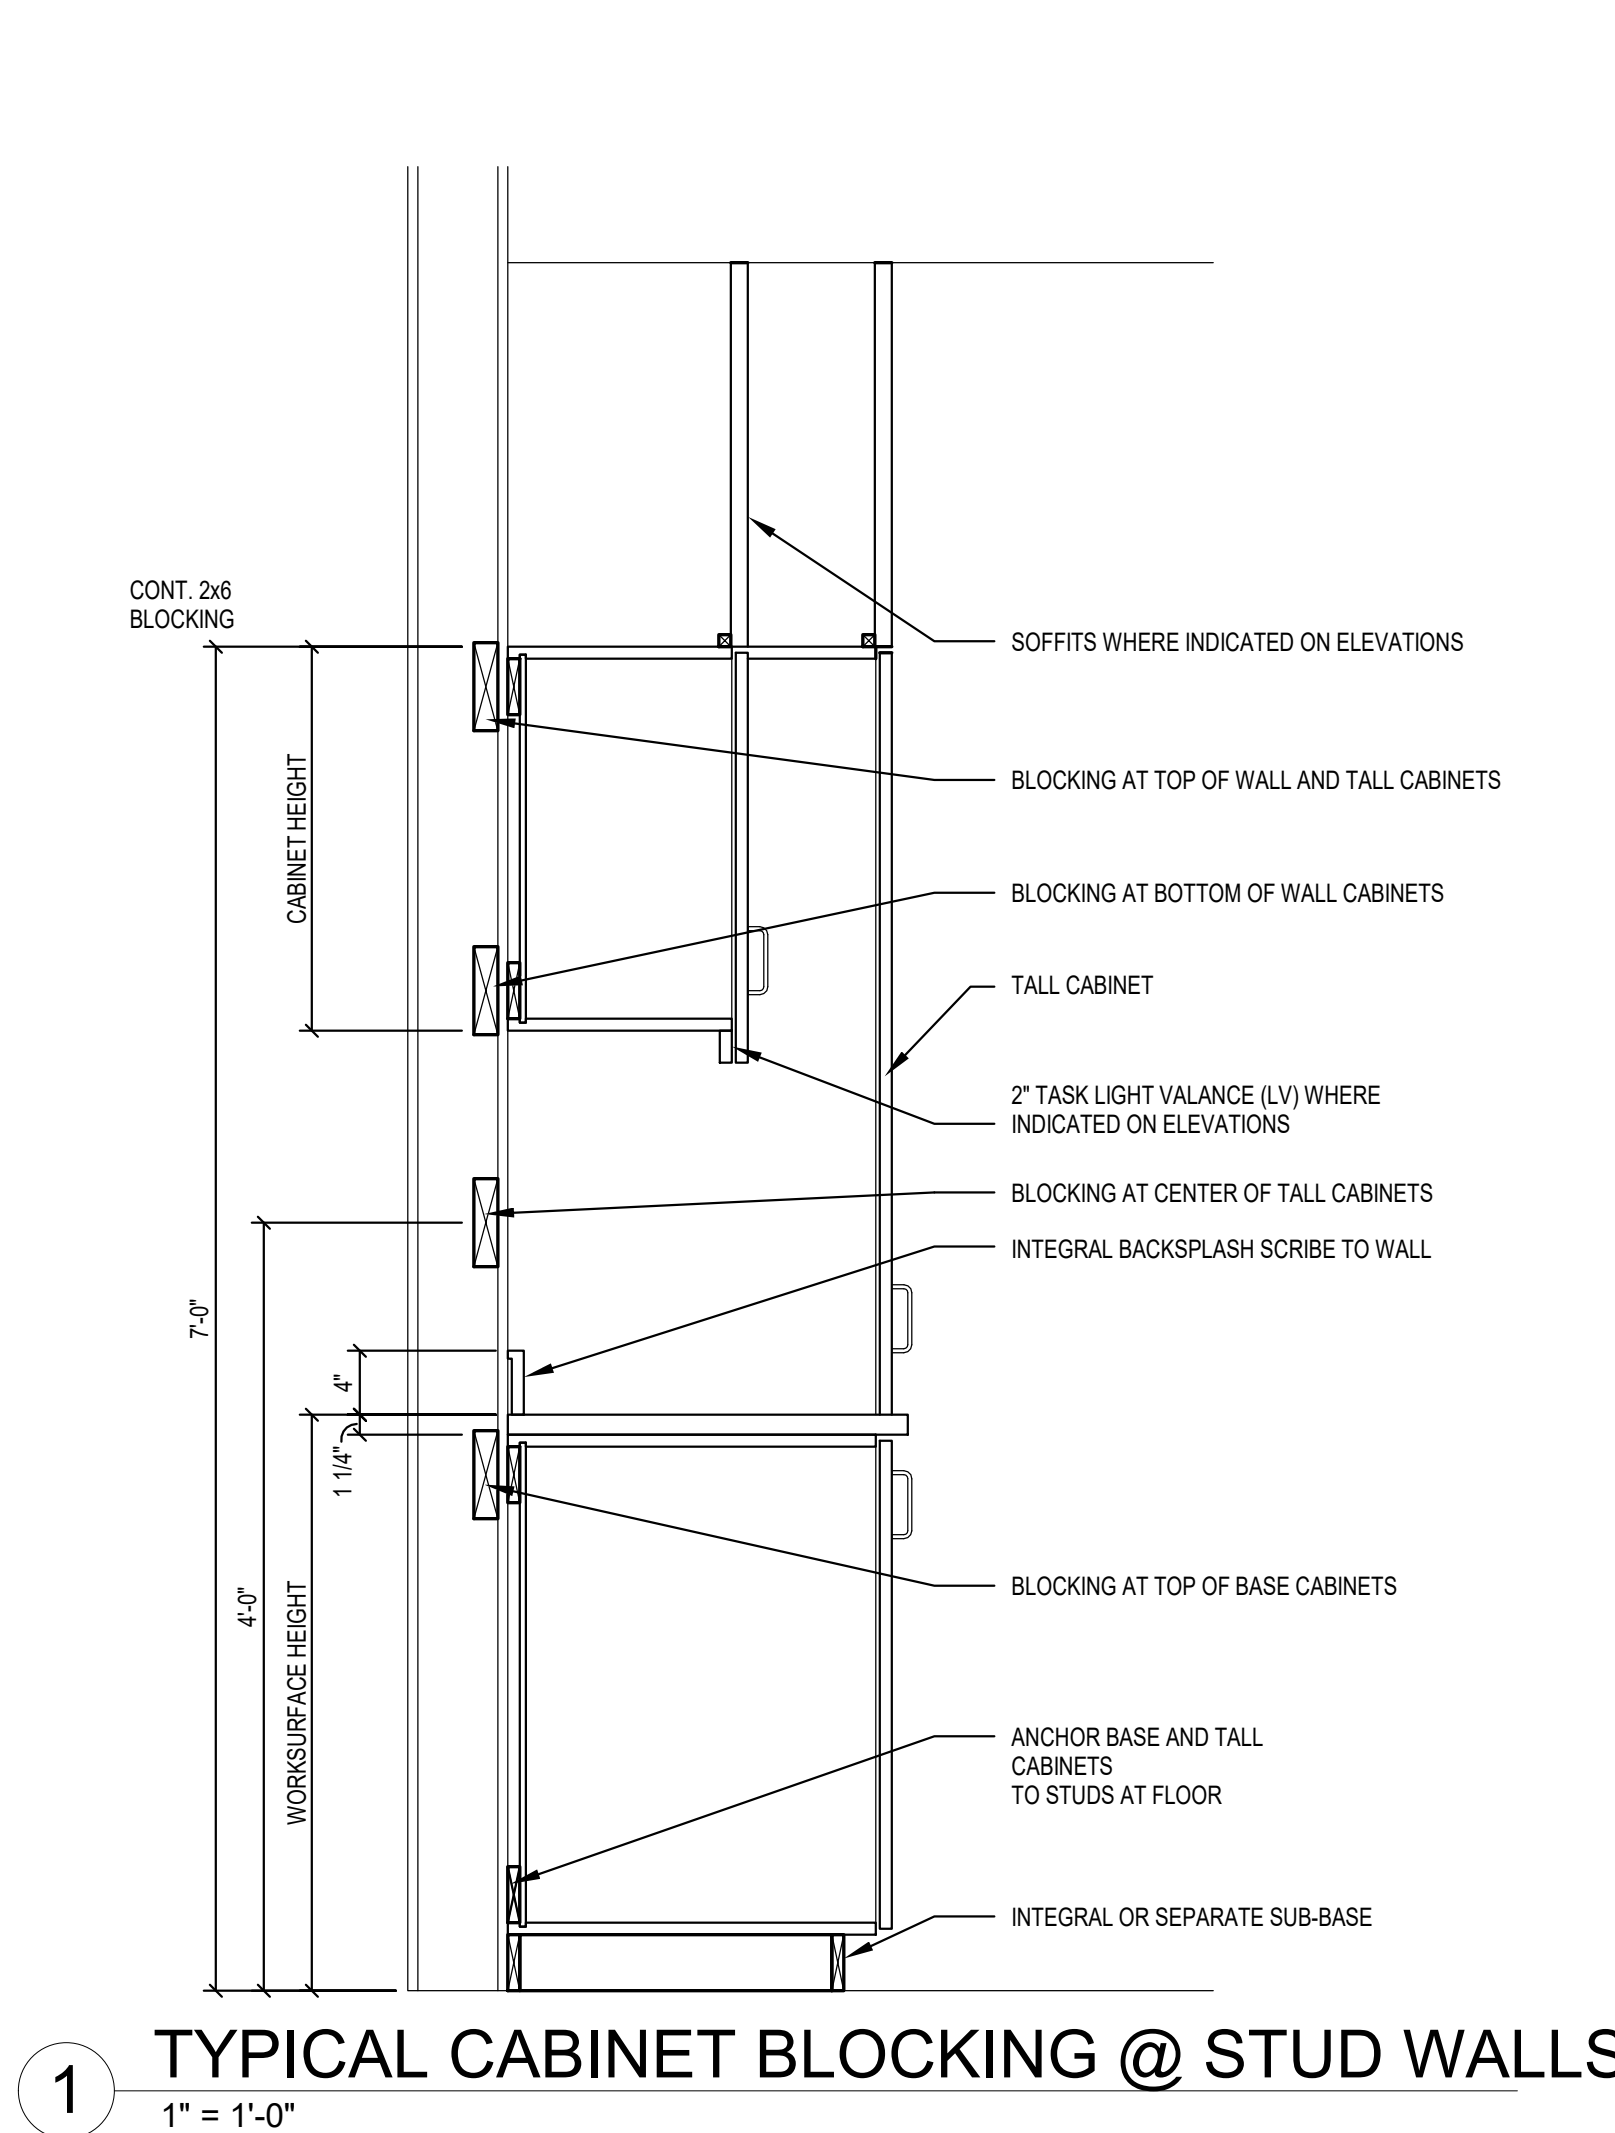


1 TYPICAL CABINET BLOCKING @ STUD WALLS
1" = 1'-0"

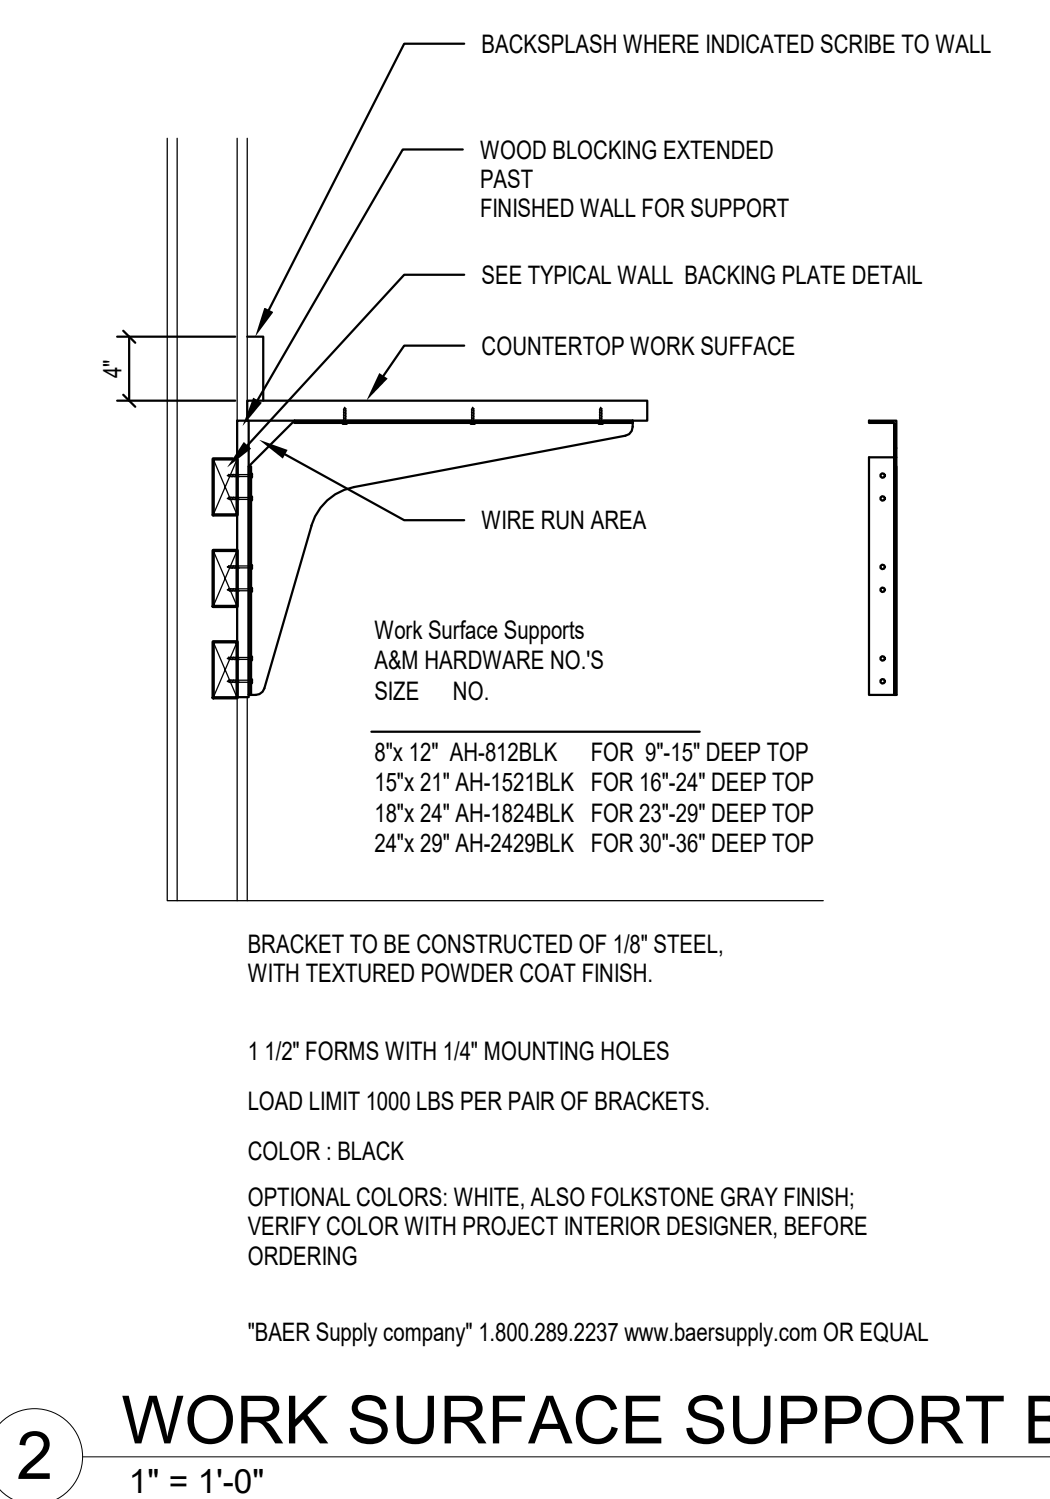


2 WORK SURFACE SUPPORT BRACKET
1" = 1'-0"

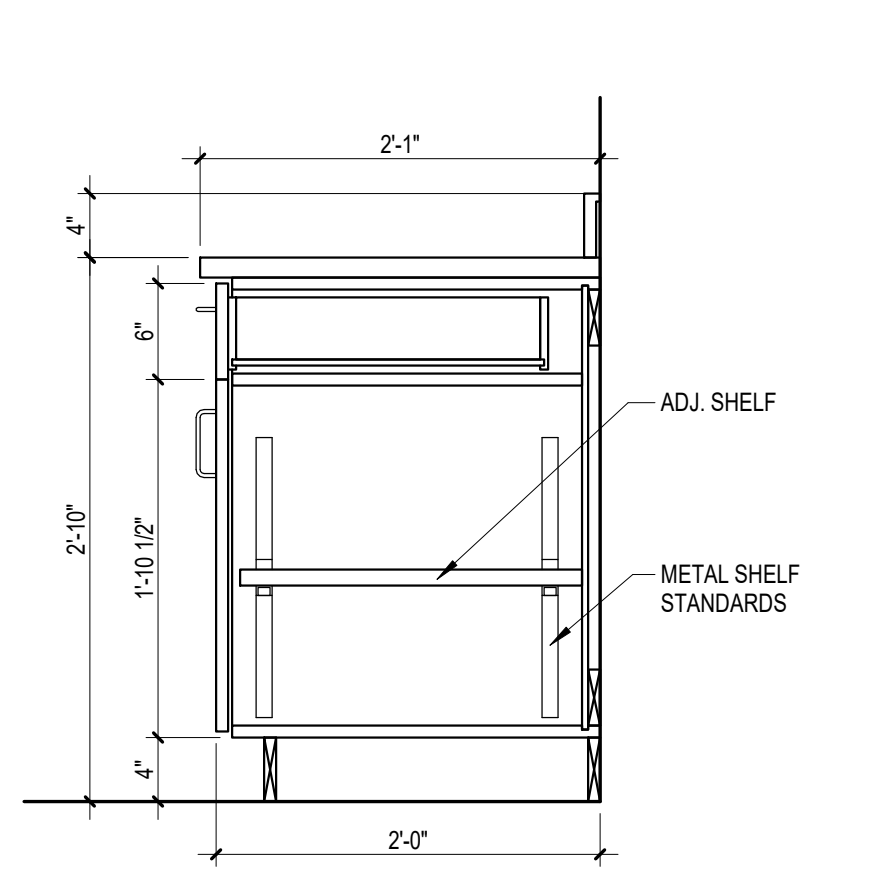


3 BASE W/ DOOR & DRAWER
1" = 1'-0"

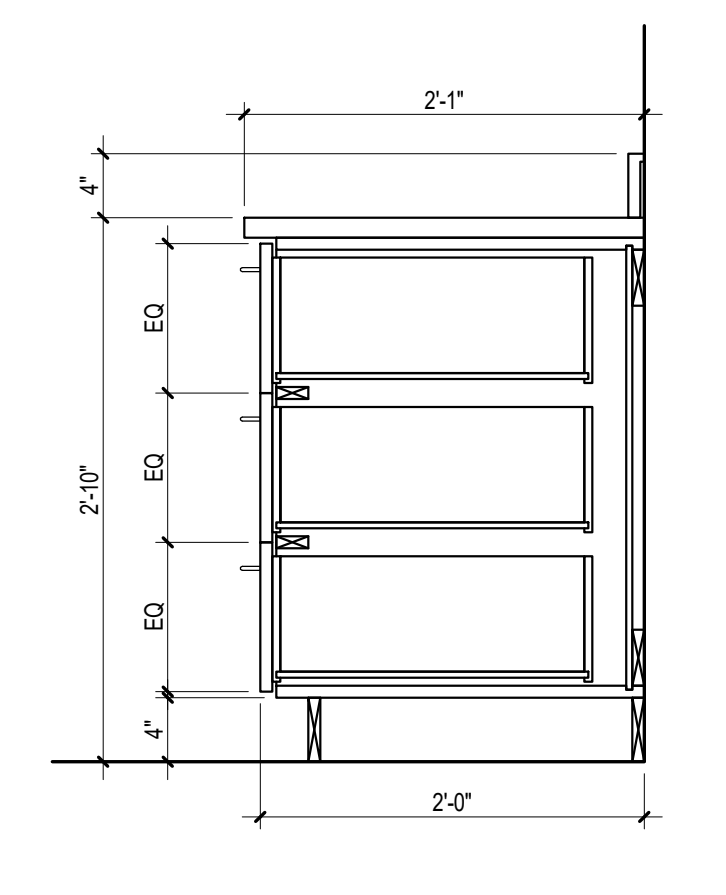


4 BASE W/ DRAWERS
1" = 1'-0"

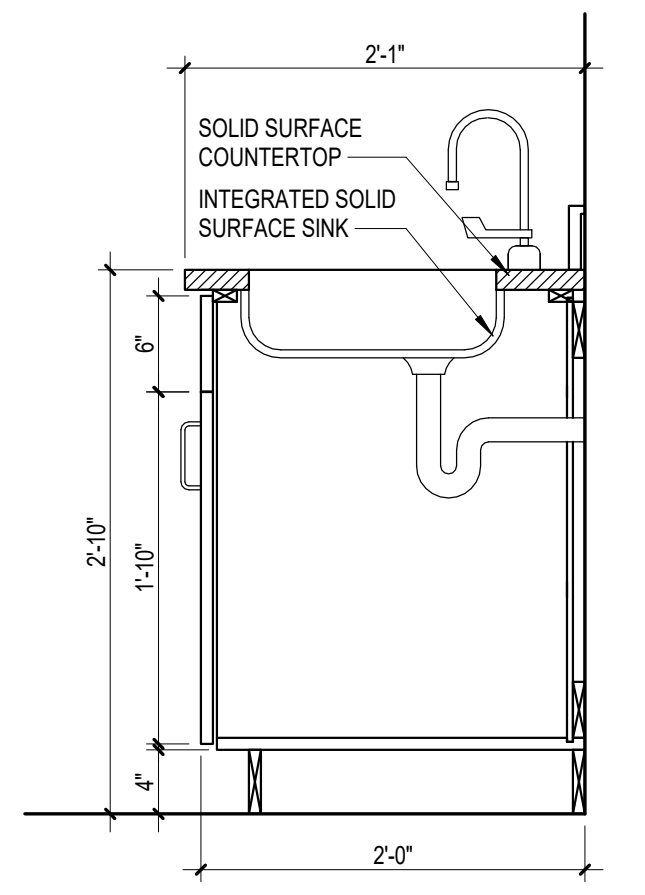


5 BASE W/ SINK
1" = 1'-0"

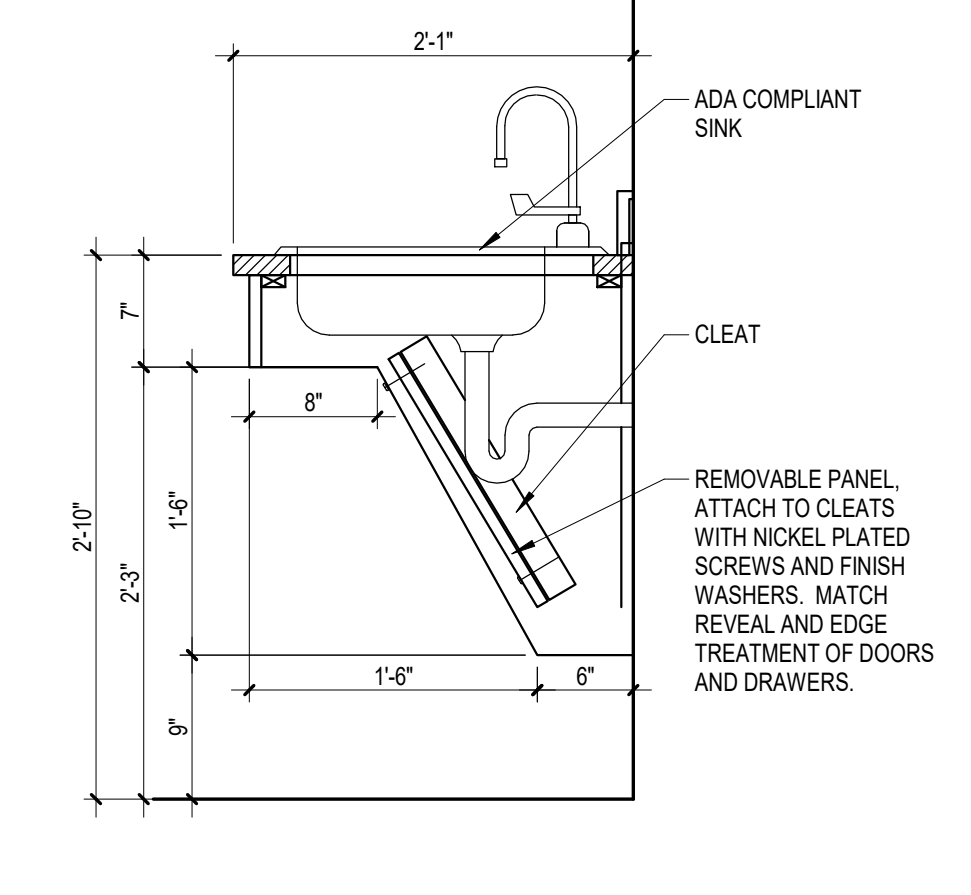


6 ADA BASE W/ SINK
1" = 1'-0"

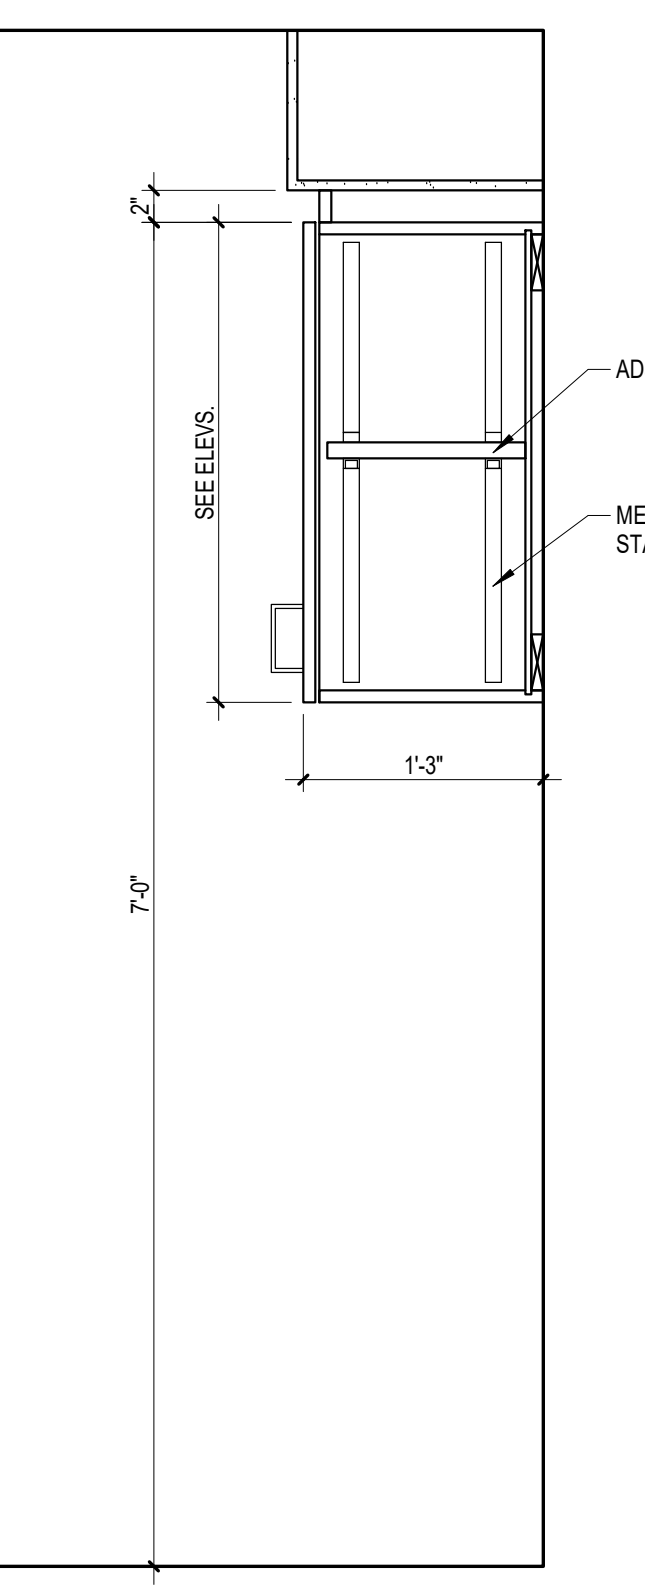


7 UPPER W/ DOORS
1" = 1'-0"

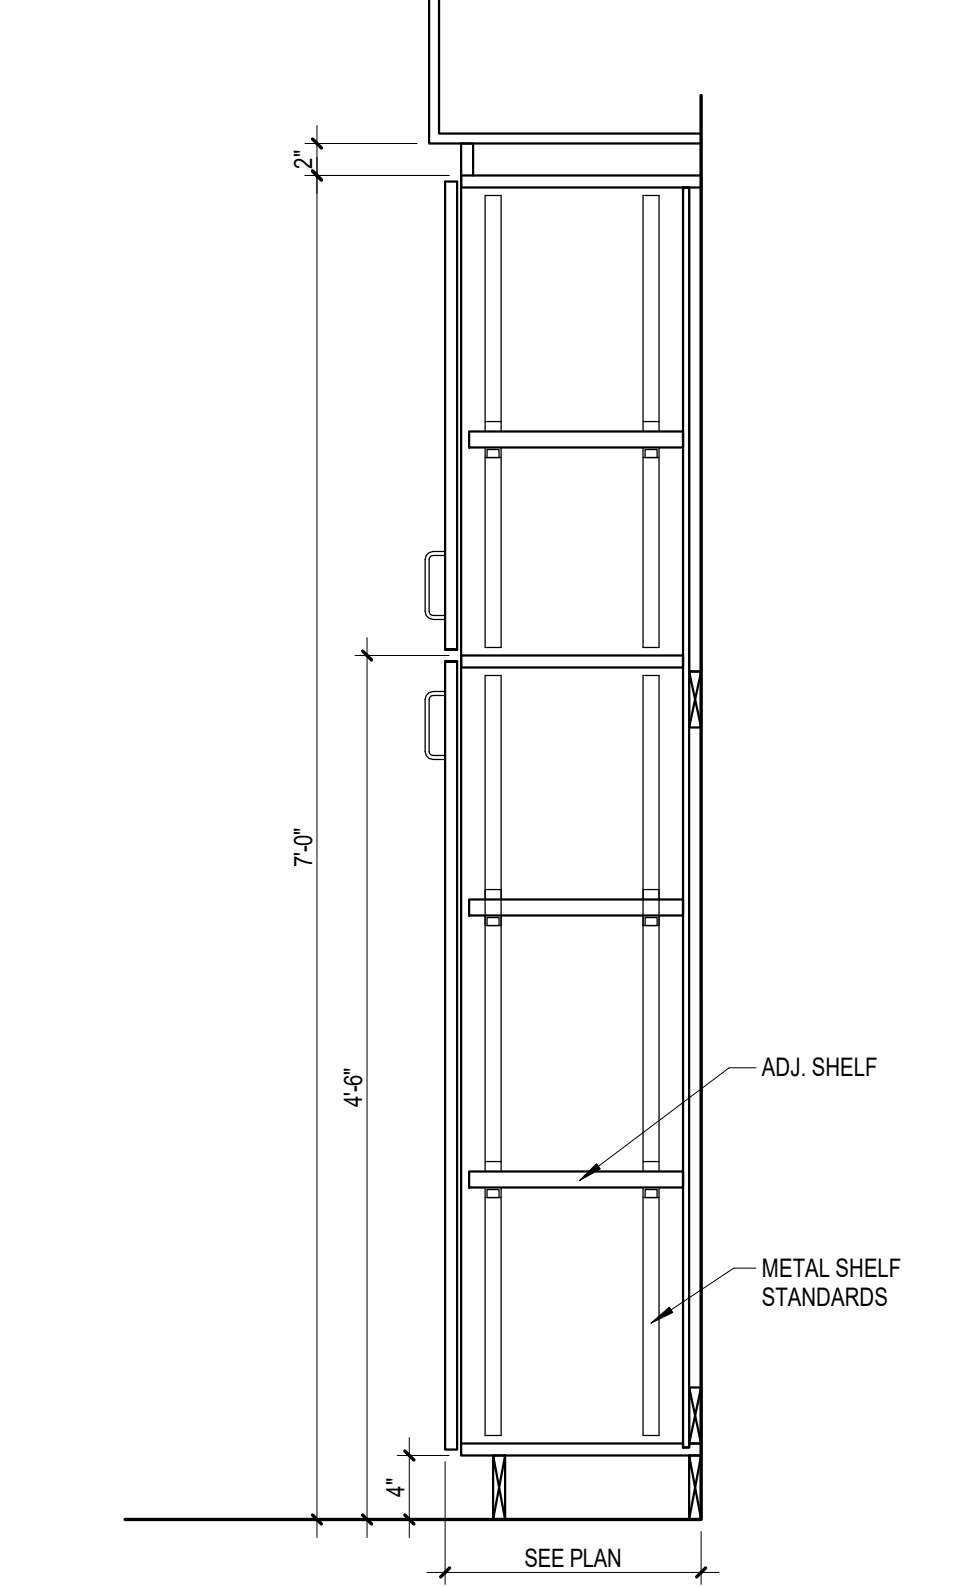

8 FULL HEIGHT CABINET
1" = 1'-0"

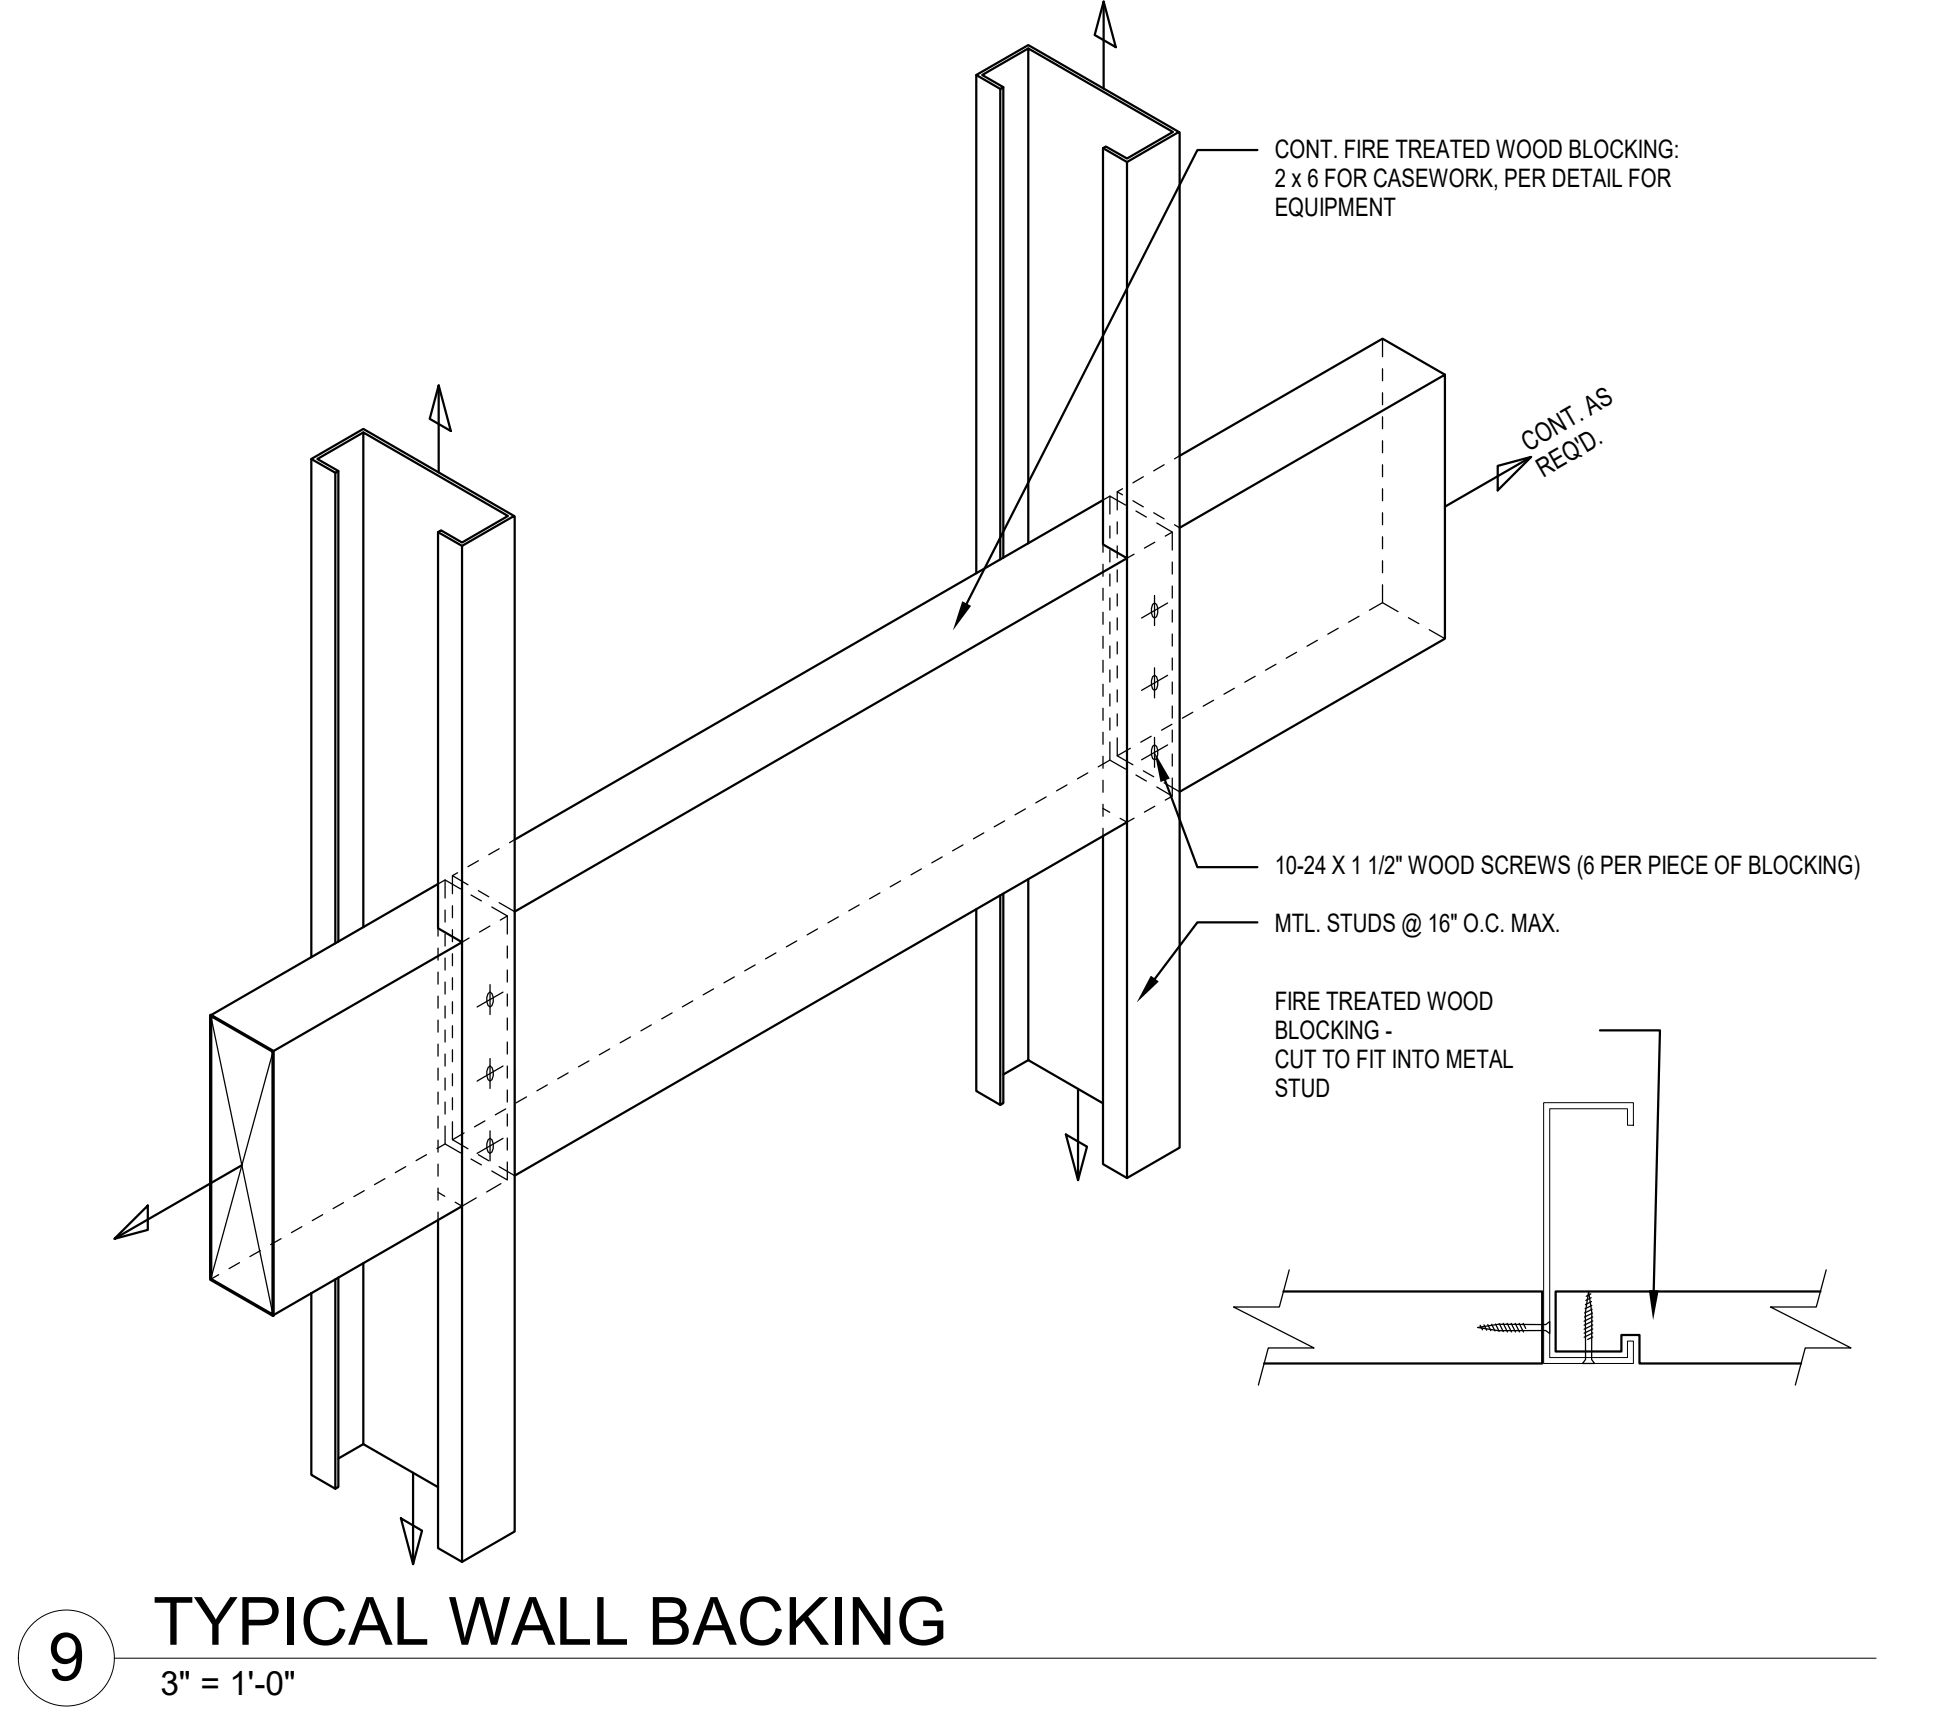

9 TYPICAL WALL BACKING
3\"/>

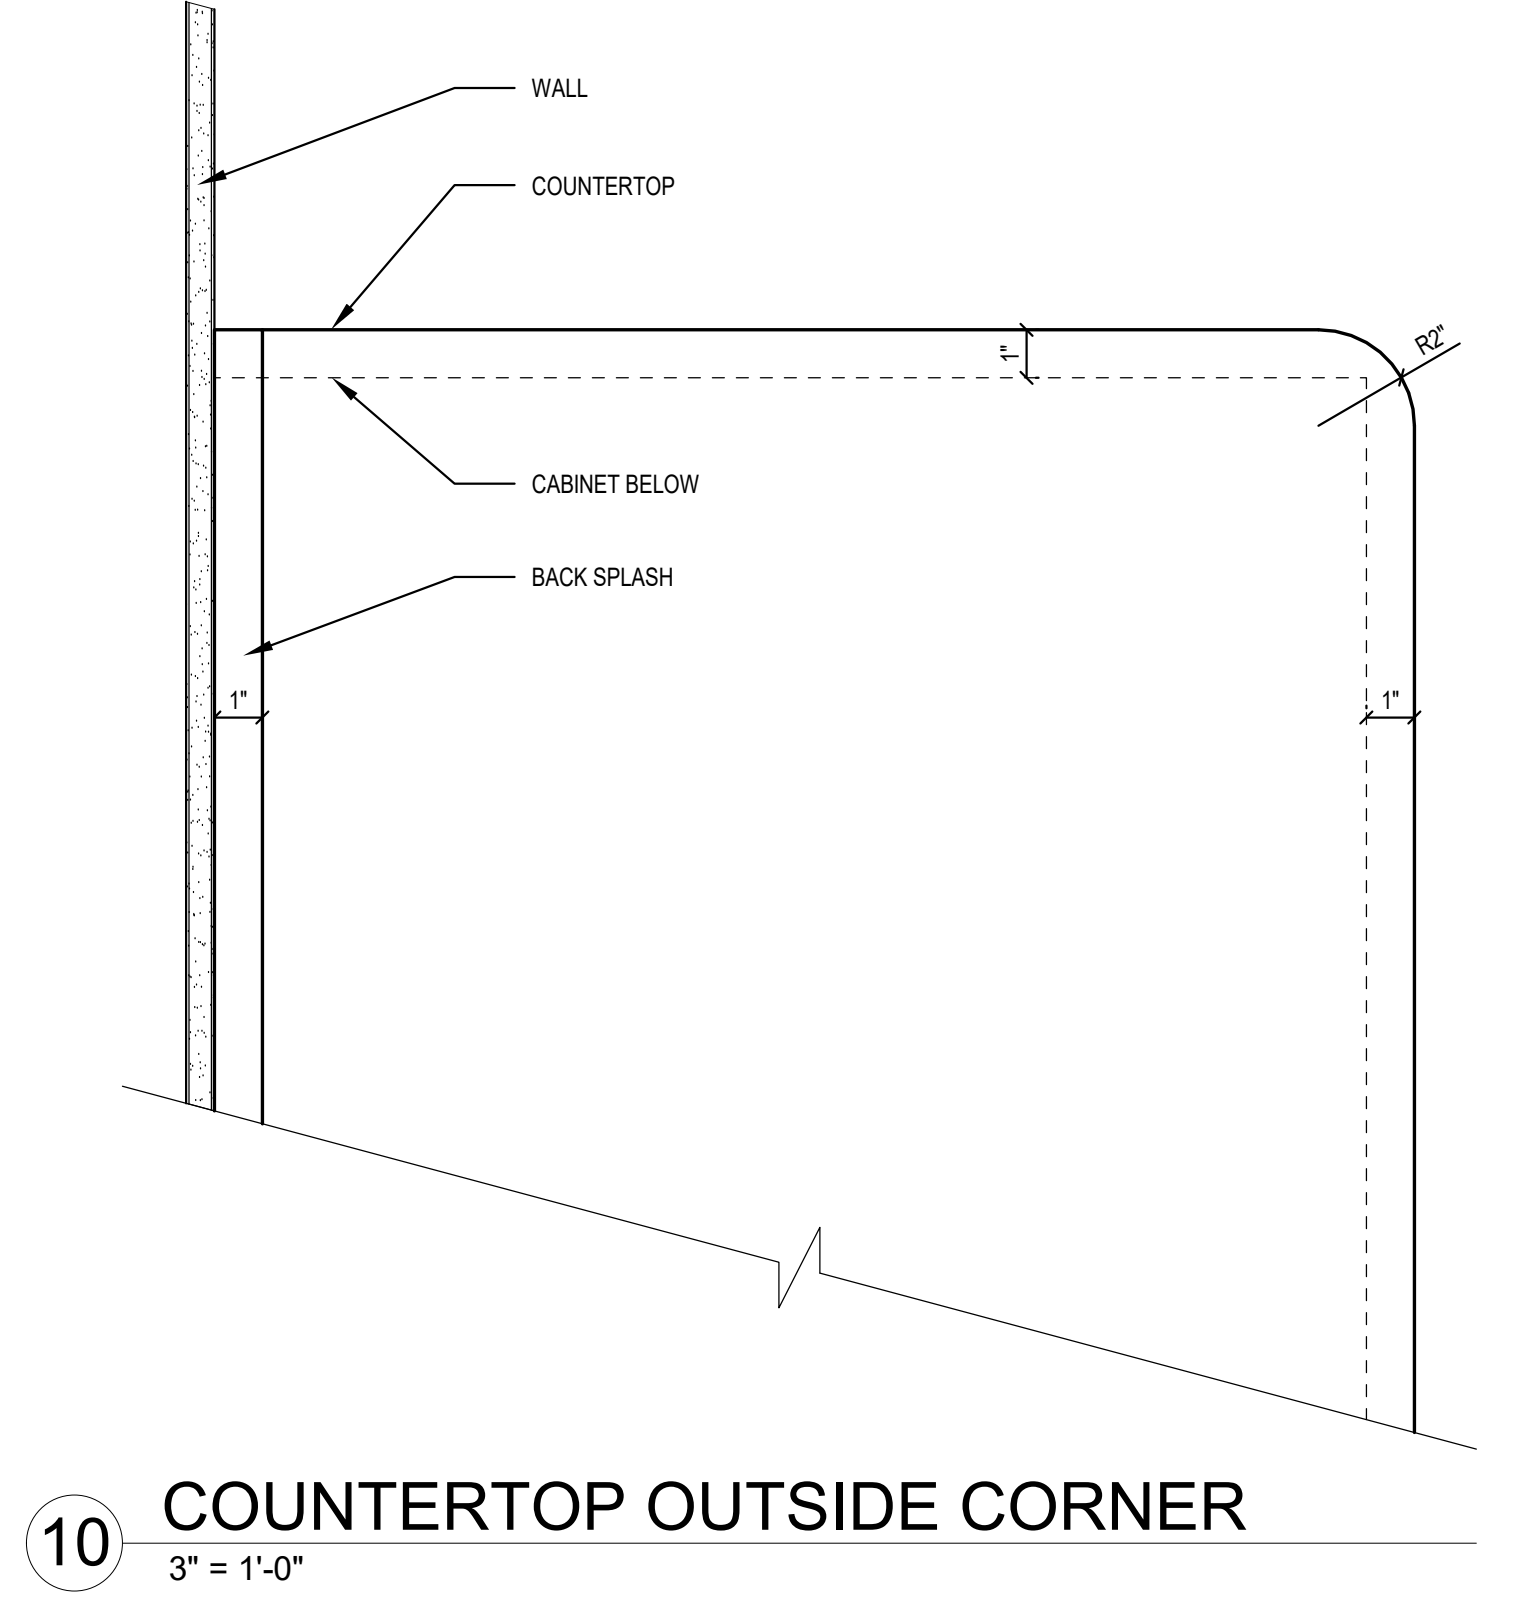

10 COUNTERTOP OUTSIDE CORNER
3\"/>

ABBREVIATIONS	GENERAL NOTES
<p>ADJ ADJUSTABLE</p> <p>AFF ABOVE FINISHED FLOOR</p> <p>AM ACCOUSTICAL MATERIAL</p> <p>AP ACCESS PANEL</p> <p>B BLANK (NOT USED)</p> <p>CA CODE ALERT</p> <p>CT COMPUTER TERMINAL</p> <p>EEM EMERGENCY ELECTRICAL OUTLET</p> <p>D DATATELEPHONE</p> <p>C CRITICAL</p> <p>FAX FACSIMILE</p> <p>FDSC FILE DRAWER (FURNITURE)</p> <p>FE FINISHED END PANEL</p> <p>FI FILM ILLUMINATOR</p> <p>FN FINISHED</p> <p>GD GARBAGE DISPOSAL</p> <p>GL GLOVE DISPENSER</p> <p>GR CORD GROMMET</p> <p>HD HEAVY DUTY</p> <p>J J-BOX</p> <p>KA ARTICULATING KEYBOARD TRAY</p> <p>L LOCK</p> <p>LG LEGAL FILE DRAWER</p> <p>LT LETTER FILE DRAWER</p> <p>LV LIGHT VALANCE</p> <p>MDF MEDIUM DENSITY FIBERBOARD</p> <p>N ELECTRICAL OUTLET</p> <p>O OXYGEN OUTLET</p> <p>OFDI OWNER FURNISHED/OWNER INSTALLED</p> <p>PB PARTICLE BOARD</p> <p>PD PENCIL DRAWER</p> <p>PL PLASTIC LAMINATE</p> <p>PT PLASTER TRAP</p> <p>PM PATIENT MONITORING</p> <p>PT PRINTER</p> <p>PTS PNEUMATIC TUBE STATION</p> <p>R RADIUS</p> <p>RP REMOVABLE PANEL</p> <p>SB SUPPORT BRACKET</p> <p>SB1 STEEL SUPPORT BRACKET</p> <p>SB2 CONCEALED SUPPORT BRACKET</p> <p>SC SHARPS CONTAINER</p> <p>SPM SOLID POLYMER MATERIAL</p> <p>SS STAINLESS STEEL</p> <p>T TELEPHONE</p> <p>TB TACK BOARD</p> <p>TL TASK LIGHT</p> <p>UC UNDERCOUNTER</p> <p>V VACUUM</p> <p>VS VACUUM SLIDE</p> <p>WM WIRE MOLD</p>	<p>1. ARCHITECTURAL CASEWORK ELEVATIONS ARE COVERED UNDER SPECIFICATION SECTION 04116 AND 12331.</p> <p>2. ALL GENERAL NOTES ARE REQUIRED THROUGHOUT CASEWORK SPEC SHEETS UNLESS NOTED OTHERWISE AT SPECIFIC LOCATION ON THE DRAWINGS.</p> <p>3. COUNTERTOPS SHALL BE SELF EDGED PLASTIC LAMINATE AND 2\"/> </p>

9/23/2021 9:47:36 PM
9/23/2021 10:38:42:21-103 - Renewate and Repair Structural Building 4/621-102103.rvt
VA FORM 08 - 6231


Revisions:	Date:

ARCHITECT/ENGINEER OF RECORD

ALESIA ARCHITECTURE
Alesia Architecture P.C.
3705 North 200th Street
Elkhorn, Nebraska 68022
Phone: 402.291.6941

IMEG STRUCTURAL ENGINEERS
IMEG Corp.
15 Sunnen Drive,
Suite 104
St. Louis, MO 63143
Phone: (314) 951-2534

SHAFFER STEVENS SCHAAP STRUCTURAL ENGINEERS
9910 North 48th Street, Ste 204, Omaha, NE 68152
402.455.7698 www.s3cp.com

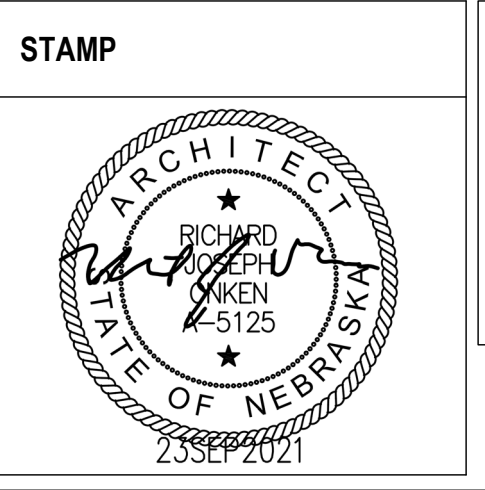

Office of Construction and Facilities Management

VA U.S. Department of Veterans Affairs

Drawing Title: **CASEWORK SECTIONS AND DETAILS**

Phase: **BID DOCUMENTS**

Project Title: **Renovate and Repair Structural, Building 4**

Location: **Wichita, KS**

Issue Date: **9/23/2021**

Checked: Drawn:

Project Number: **589A7-21-108**

Building Number: **4**

Drawing Number: **A-911**

FULLY SPRINKLERED

Project Title: **Renovate and Repair Structural, Building 4**

Location: **Wichita, KS**

Issue Date: **9/23/2021**

Checked: Drawn:

Project Number: **589A7-21-108**

Building Number: **4**

Drawing Number: **A-911**

A

B

C

D

E

F

A


B

C


D

E


F

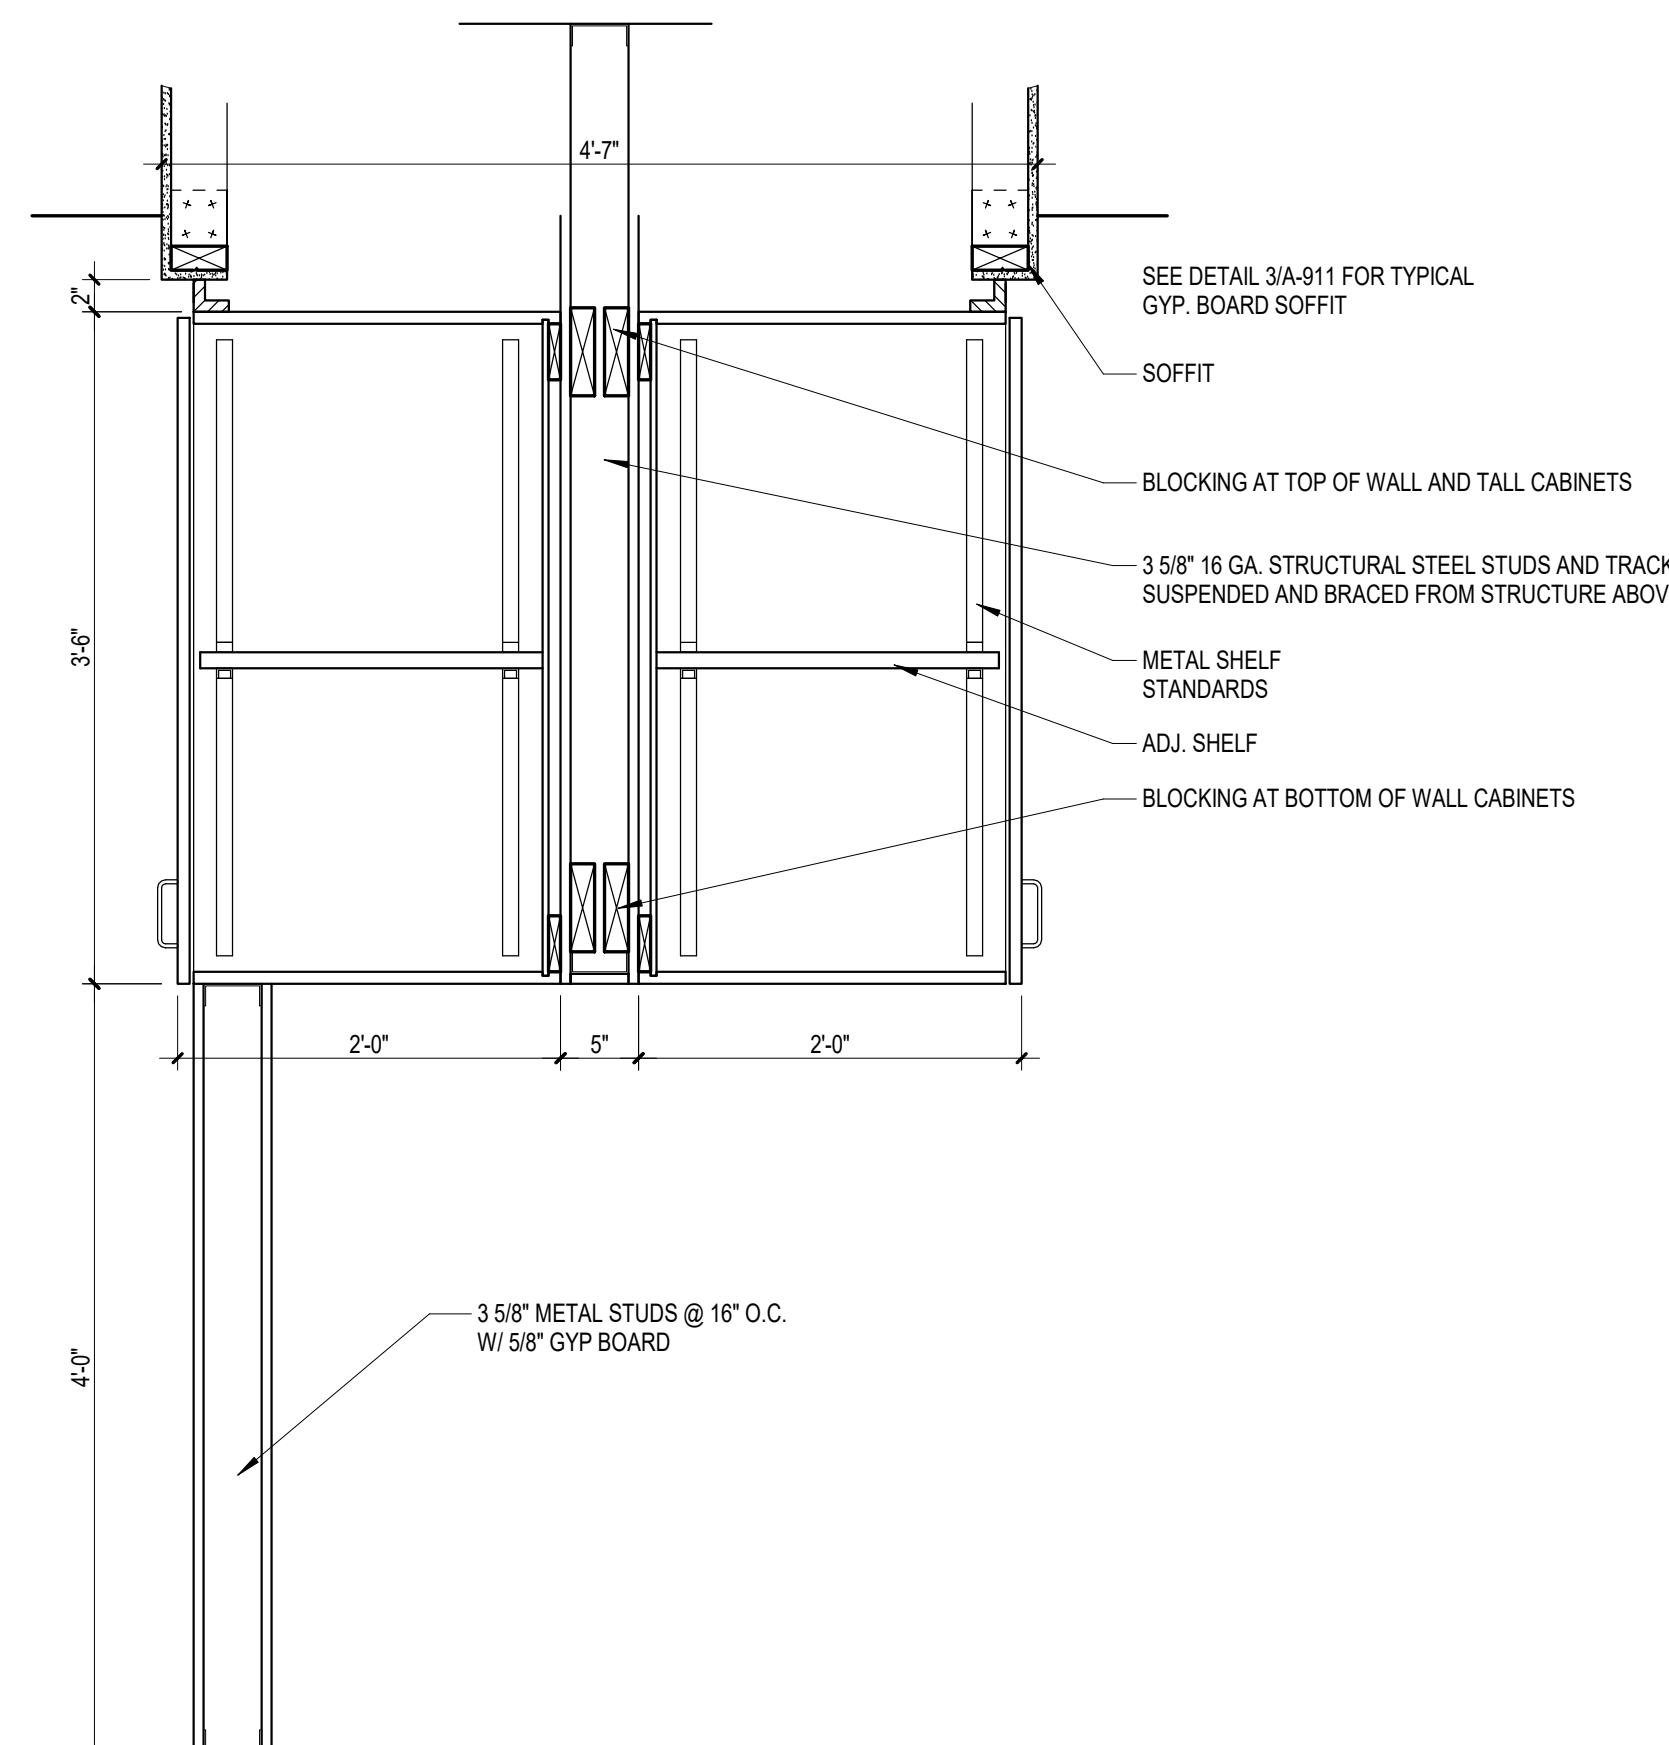


1 UPPER CABINETS @ STORAGE
1" = 1'-0"

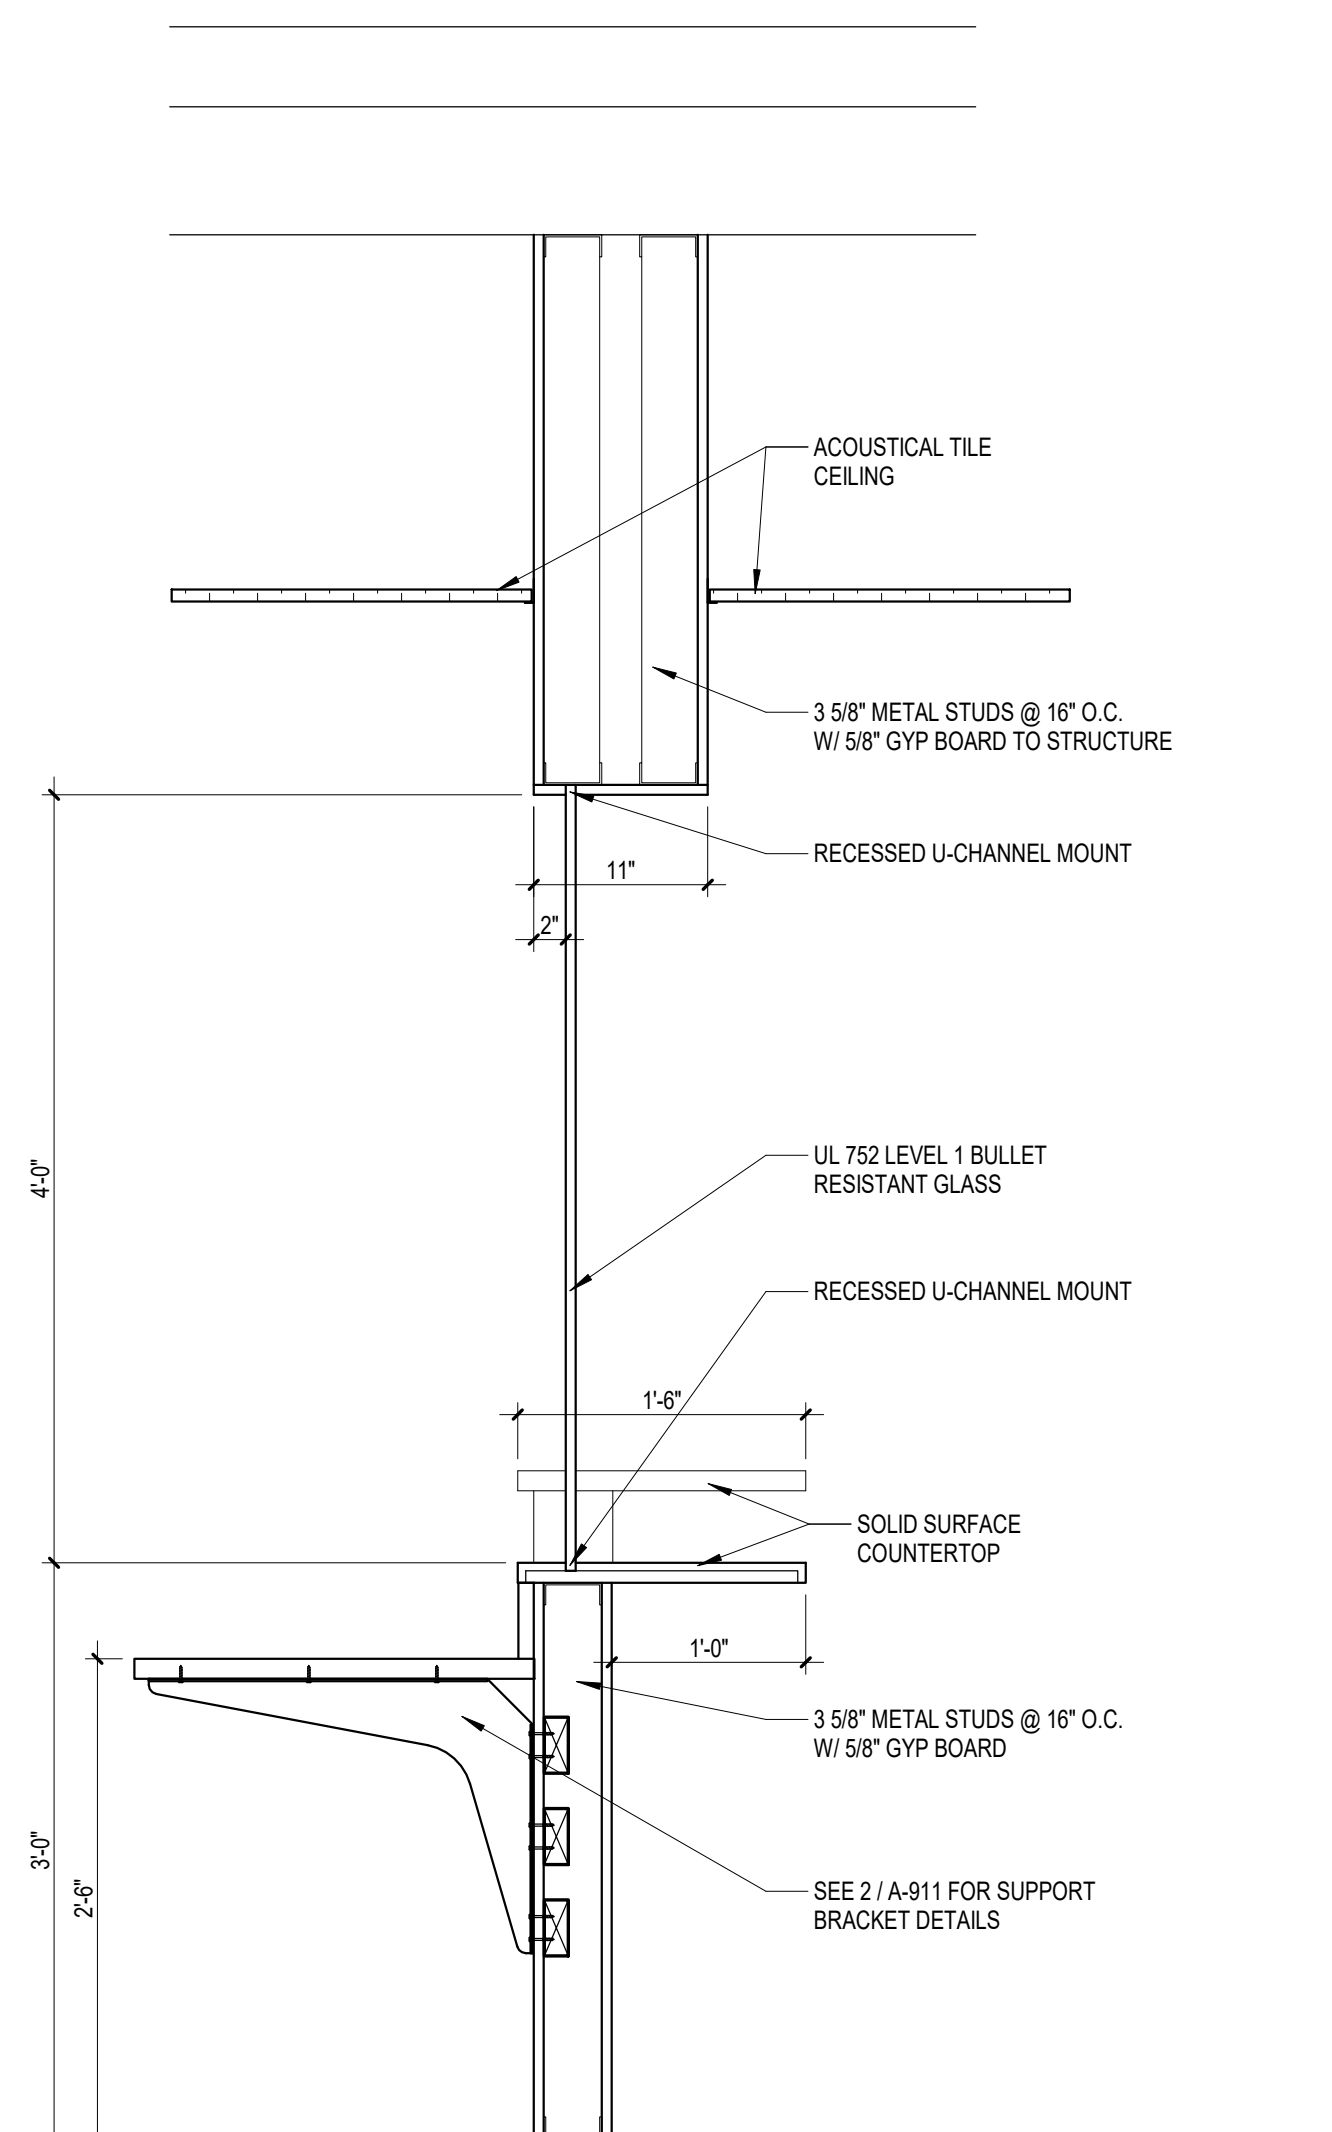

2 CHECK-IN WINDOW @ RECEPTION
1" = 1'-0"

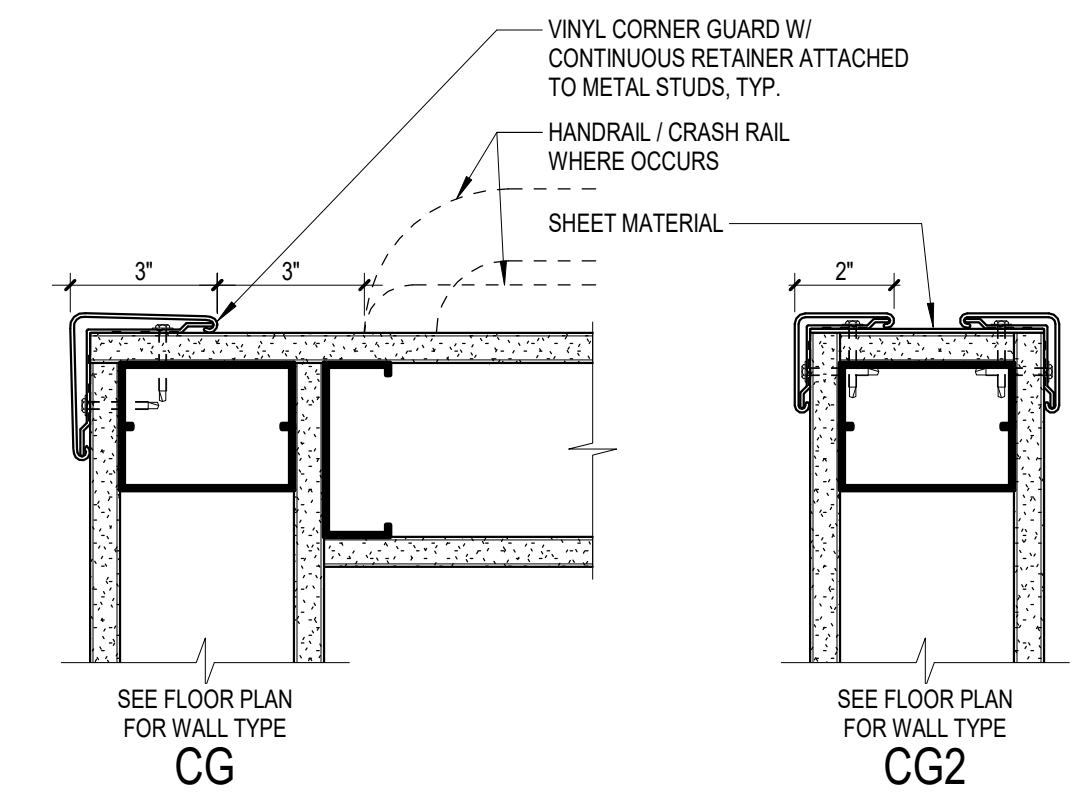

3 CORNER GUARDS
3" = 1'-0"

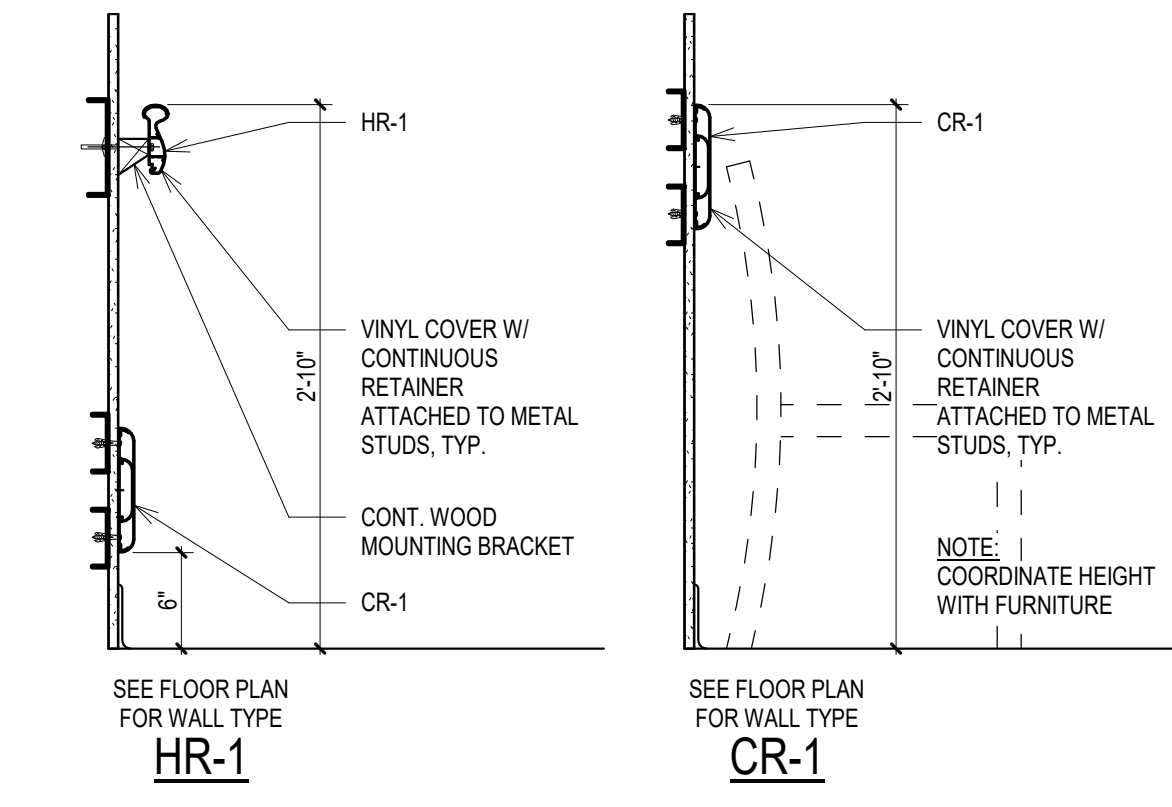

4 HANDRAIL / CRASHRAIL
1" = 1'-0"

9/23/2021 9:47:37 PM
 BIM 360://2021-03-589A7-21-108 - Renovate and Repair Structural Building 4/21-102-103.rvt


Revisions:	Date:

ARCHITECT/ENGINEER OF RECORD

ALESIA ARCHITECTURE
 Alesia Architecture P.C.
 3705 North 200th Street
 Elkhorn, Nebraska 68022
 Phone: 402.291.6941

IMEG Corp.
 15 Sureson Drive,
 Suite 104
 St. Louis, MO 63143
 Phone: (314) 951-2534

SHAFER STEVENS SCHAAP STRUCTURAL ENGINEERS
 9910 North 48th Street, Ste 204, Omaha, NE 68152
 402.455.7698 www.s3pe.com

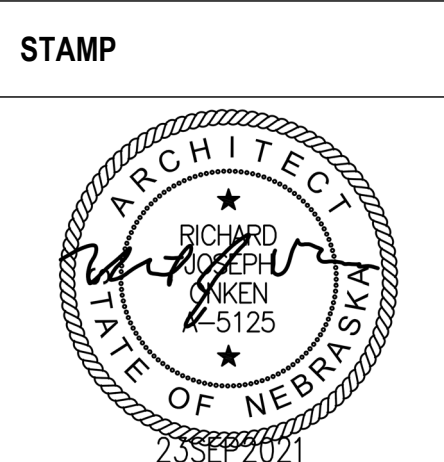

Office of Construction and Facilities Management
 VA U.S. Department of Veterans Affairs

Drawing Title
CASEWORK SECTIONS AND DETAILS
 Approved:

Phase
BID DOCUMENTS
FULLY SPRINKLERED

Project Title
 Renovate and Repair Structural, Building 4
 Location
 Wichita, KS
 Issue Date
 9/23/2021
 Checked
 Drawn

Project Number
 589A7-21-108
 Building Number
 4
 Drawing Number
A-912