		Engineering: IMEG Corp. 15 Sunnen Drive, Suite 104 St. Louis, MO 63143 (314) 645-1132 Date:	<u>A/E:</u> Calvin L. Hinz Architects P.C. 3705 N. 200th Street Elkhorn, NE 68022 (402) 291-6941			14176 ANSA ANSA ANSA ANSA ANSA ANSA ANSA ANS	truction acilities gement S. Departme Veterans
		CONSULTANT	ARCHITECT/ENGIN	EER OF REC	DRD ST/		ice of
F				TR-#	TELECOMMU	NICATIONS ROOM	
				TYP UNO +# EF-# MC-#	TYPICAL UNLESS NOT MOUNTING H ENTRANCE F MAIN CROSS	-CONNECT	
_				AFF BFC C J-BOX RL SIM	ABOVE FINIS BELOW FINIS CONDUIT JUNCTION BO RELOCATE O SIMILAR	HED CEILING	
Е				ABBR:	TECHNC DESCRIPT	DLOGY ABBREVIATION KE	<u>Y</u>
				ELECTRICA INFORMATI	L FLOOR PLANS ON.	FALLED IN E.C. PROVIDED FLOOR BOX. REFER TO S AND ELECTRICAL EQUIPMENT SCHEDULE FOR AE FOR NEW, EXISTING TO REMAIN, OR DEMO LINE TY	DITIONAL
				INFORMATI 2. SYMBOL SU SCHEDULE 3. REFER TO ADDITIONA 4. "##-##" SUB INDIVIDUAL	ON OUTLET SCI IBSCRIPT INDIC ON T501 FOR A CONTROLLED S INFORMATION SCRIPT AT CAM CAMERA REQU	ION OUTLET FACEPLATE CONFIGURATION. REFER HEDULE ON T501 FOR ADDITIONAL INFORMATION. ATES DEVICE TYPE. REFER TO TECHNOLOGY EQUI DDITIONAL INFORMATION. ECURITY SCHEME (CSS) TYPE SCHEDULE ON T501 I. IERAS INDICATES FLOOR NUMBER-CAMERA NUMBI JIREMENT SCHEDULE FOR ADDITIONAL INFORMATION TALLED IN E.C. PROVIDED FLOOR BOX. REFER TO	IPMENT FOR ER. REFER TO ON.
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		2 HOUR FIRE/SMOKE BARRIER 1 HOUR FIRE/SMOKE SHAFT ENCLOSURE				CONTINUATION GENERAL NOTES: VIATIONS LISTED MAY NOT BE APPLICABLE TO THIS	
_		2 HOUR SHAFT ENCLOSURE 1 HOUR FIRE/SMOKE BARRIER		C		CONDUIT SLEEVE	
		1 HOUR FIRE BARRIER 2 HOUR FIRE BARRIER 1 HOUR SHAFT ENCLOSURE				CONDUIT DOWN CONDUIT UP OR UP/DOWN	
с		MATERIALS REQUIRED TO COMPLY WITH THOS REFER TO ARCHITECTURAL PLANS FOR FLOOF ASSEMBLIES.			HËIGHT	LADDER RACK	
			RIER DESIGNATIONS		PA-S-W	FACILITY PAGING SPEAKER (WALL) CABLE TRAY, CHANNEL TRAY, BASKET	
_		ELSEWHERE IN A SCHEDULE	MATERIAL LIST, OR SYMBOL LIST TEM'S POINT OF CONNECTION/REMOVAL		<u>IC-VSS</u> <u>PA-S-C</u>	VIDEO INTERCOM STATION VIDEO INTERCOM STAFF STATION FACILITY PAGING SPEAKER (CEILING)	
		TAG-1 UNDERLINED TEXT INDICATES	ES THE REFERENCED OBJECT IS EXISTING		<u>N/A</u> IC-VS-W	VIDEO SURVEILLANCE CAMERA WITH LENS, WAL MOUNT OR CEILING MOUNT VIDEO INTERCOM STATION	L ?
в		EXISTING TO REMAIN OR WORK BY OTHERS EXISTING TO REMAIN OR WORK BY OTHERS EXISTING EXISTING EXISTING TO BE REMOVED B EXISTING UNDERFLOOR OR U	RGROUND (LONG DASHED PATTERN) (NARROW LINE) (OTHERS (SHORT DASHED PATTERN)		<u>NA</u>	T = TECHNOLOGY/TYPE D-DUAL TECHNOLOGY IR-INFRARED M-MICROV U-ULTRASONIC X-REQUEST-FOR-EXIT CARD ACCESS READER	VAVE
		LINE TYPE AND TAG KEY: NEW WORK BY THIS CONTRACTOR (WIDE LIN ————————————————————————————————————	IE)	M Τ	<u>ID-MD</u>	MOTION DETECTOR; LETTER INDICATES AS FOLL M = MOUNT C-CEILING D-DESK F-FLUSH H-HIDDEN M-MUI P-PEDESTAL R-RACK S-SURFACE W-WALL	
-		SIM IN MULTIPLE LO	LAR DETAIL REFERENCED CATIONS RED TO BY SECTION CUT S LOCATED ON <u>T101</u>	₩	AC-CR2	CARD ACCESS READER WITH KEYPAD; LETTER INDICATES AS FOLLOWS: M = MOUNT C - CEILING D - DESK F- FLUSH H - HIDDEN M - MULLION P - PEDESTAL R - RACK S - SURFACE W - WALL	
		1/8" = 1'-0"	PLAN OR DETAIL SCALE	#_# # © CSS	<u>N/A</u> <u>N/A</u>	TELEPHONE/DATA COMMUNICATION ELECTRICAL FLOOR BOX WITH TECHNOLOGY CONTROLLED SECURITY SCHEME SCHEDULE IDENTIFIER	1, 5. 1., 5.
A			INDICATES DIRECTION OF TRUE NORTH PLAN OR DETAIL NUMBER PLAN OR DETAIL NAME	$\begin{bmatrix} \mathbf{\nabla} \\ \mathbf{\nabla} \\ \mathbf{\nabla} \end{bmatrix}$	<u>SC-IO-W</u> <u>SC-IO-W</u> <u>SC-IO-F</u>	TELEPHONE/DATA COMMUNICATION WALL INFORMATION OUTLET, TELEVISION, MOUN AT +84" UNLESS OTHERWISE NOTED FLOOR INFORMATION OUTLET, COMBINATION	1. NTED 1. 1, 5.
		NAME LEVEL NAME 10' - 0" HEIGHT ABOVE PROJECT 0' - 0"	1 INDICATES NOTE USED TO DESCRIBE ADDITIONAL INFORMATION ABOUT WORK REQUIRED, SPECIFIC TO THE SHEET AND/OR DETAIL	SYMBOL:	EQUIPMENT LIST ABBREV.: <u>SC-IO-C</u>	DESCRIPTION: CEILING INFORMATION OUTLET, DATA COMMUNICATION ONLY, WIRELESS ACCESS POIL WALL INFORMATION OUTLET, COMBINATION	NOTE
			<u>V KEY</u>			INOLOGY SYMBOL LIST	

VIEW KEY							
UEVEL NAME HEIGHT ABOVE PROJECT 0' - 0"	1 INDICATES NOTE USED TO DESCRIBE ADDITIONAL INFORMATION ABOUT WORK REQUIRED, SPECIFIC TO THE SHEET AND/OR DETAIL						
IN	DICATES DIRECTION OF TRUE NORTH						
— Pl	AN OR DETAIL NUMBER						
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1/8" = 1'-0" PI	LAN OR DETAIL SCALE						
INDICATES SIMILA	AR DETAIL REFERENCED						
DETAIL REFERRE M101-SHEET DETAIL IS	D TO BY SECTION CUT						
) TAG KEY:							
THIS CONTRACTOR (WIDE LINE)						
NEW EXISTING TO BE REMOVED (SHO NEW UNDERFLOOR OR UNDER	ORT DASHED PATTERN) GROUND (LONG DASHED PATTERN)						
EMAIN OR WORK BY OTHERS (N	ARROW LINE)						
EXISTING EXISTING TO BE REMOVED BY C EXISTING UNDERFLOOR OR UN	OTHERS (SHORT DASHED PATTERN) DERGROUND (LONG DASHED PATTERN)						
OOES NOT MODIFY SCOPE.							
TAGS WITH DASH 'E' INDICATES	THE REFERENCED OBJECT IS EXISTING						
	ADDITIONAL INFORMATION CAN BE FOUND IATERIAL LIST, OR SYMBOL LIST						
INDICATES AN EXISTING SYSTE	M'S POINT OF CONNECTION/REMOVAL						

		NOLUGI SIMBUL LISI
SYMBOL:	EQUIPMENT LIST ABBREV.:	DESCRIPTION:
WAP	<u>SC-IO-C</u>	CEILING INFORMATION OUTLET, DATA COMMUNICATION ONLY, WIRELESS ACCESS POINT
# # V	<u>SC-IO-W</u>	WALL INFORMATION OUTLET, COMBINATION TELEPHONE/DATA COMMUNICATION
	<u>SC-IO-W</u>	WALL INFORMATION OUTLET, TELEVISION, MOUNTED AT +84" UNLESS OTHERWISE NOTED
#_# •	<u>SC-IO-F</u>	FLOOR INFORMATION OUTLET, COMBINATION TELEPHONE/DATA COMMUNICATION
#	<u>N/A</u>	ELECTRICAL FLOOR BOX WITH TECHNOLOGY
CSS	<u>N/A</u>	CONTROLLED SECURITY SCHEME SCHEDULE
₩	<u>AC-CR2</u>	CARD ACCESS READER WITH KEYPAD; LETTER INDICATES AS FOLLOWS: M = MOUNT C - CEILING D - DESK F- FLUSH H - HIDDEN M - MULLION P - PEDESTAL R - RACK S - SURFACE W - WALL
™ T	<u>ID-MD</u>	MOTION DETECTOR; LETTER INDICATES AS FOLLOWS M = MOUNT C-CEILING D-DESK F-FLUSH H-HIDDEN M-MULLION P-PEDESTAL R-RACK S-SURFACE W-WALL
		T = TECHNOLOGY/TYPE D-DUAL TECHNOLOGY IR-INFRARED M-MICROWAVE U-ULTRASONIC X-REQUEST-FOR-EXIT
	NA	CARD ACCESS READER
	<u>N/A</u>	VIDEO SURVEILLANCE CAMERA WITH LENS, WALL MOUNT OR CEILING MOUNT
ЬЦ	IC-VS-W	VIDEO INTERCOM STATION
	IC-VSS	VIDEO INTERCOM STAFF STATION
S	PA-S-C	FACILITY PAGING SPEAKER (CEILING)
<u>Ş</u>	PA-S-W	FACILITY PAGING SPEAKER (WALL)
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		CONDUIT SLEEVE
s		CONTINUATION
		GENERAL NOTES:
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	OLS AND ABBREV	/IATIONS REFER TO TECHNOLOGY SHEETS ONLY AS DE TO THE GENERAL TECHNOLOGY NOTES FOR ADDITION
INFORMA 3. ALL SYMB	TION. OLS LISTED ABO\	/E ARE FOR REFERENCE ONLY. REFER TO PLANS AND D REMAIN AND TO BE REMOVED ITEMS FOR ADDITIONA
INFORMA ⁻	TION. RISERS ON SHEI	ET(S): T401.
		CHNOLOGY SYMBOL NOTES:
INFORMA 2. SYMBOL S	TION OUTLET SCH SUBSCRIPT INDICA	ON OUTLET FACEPLATE CONFIGURATION. REFER TO IEDULE ON T501 FOR ADDITIONAL INFORMATION. ATES DEVICE TYPE. REFER TO TECHNOLOGY EQUIPMEI DDITIONAL INFORMATION.

	TECHNOLOGY ABBREVIATION KEY					
ABBR:	DESCRIPTION:					
AFF	ABOVE FINISHED FLOOR					
BFC	BELOW FINISHED CEILING					
С	CONDUIT					
J-BOX	JUNCTION BOX					
RL	RELOCATE OUTLET AND CABLES					
SIM	SIMILAR					
TYP	TYPICAL					
UNO	UNLESS NOTED OTHERWISE					
+#	MOUNTING HEIGHT ABOVE FINISHED FLOOR					
EF-#	ENTRANCE FACILITY					
MC-#	MAIN CROSS-CONNECT					
TR-#	TELECOMMUNICATIONS ROOM					

SUGGESTED MA	TRIX O	F RESPO	NSIBILIT	Y
ITEM:	SHOWN ON:	FURNISHED BY:	INSTALLED BY:	NOTES
TECHNOLOGY ROUGH-IN, REFER TO TECHNOLOGY EQUIPMENT SCHEDULE AND SPECIFICATIONS FOR DEFINITION	T-SERIES	E.C.	E.C.	3. 4.
INFORMATION OUTLET FACEPLATES, JACKS, AND TERMINATIONS	T-SERIES	T.C.	T.C.	
CONDUIT SLEEVES (WHEN SHOWN ON DRAWINGS)	T-SERIES	E.C.	E.C.	
CONDUIT SLEEVES (NOT SHOWN BUT REQUIRED FOR PROPER INSTALLATION OF SYSTEM)	N/A	T.C.	T.C.	2.4.
TELECOMMUNICATION SYSTEMS ROUGH-IN	T-SERIES	E.C. [T.C]	E.C.	1.
TELECOMMUNICATION EQUIPMENT, CABLING, AND TERMINATIONS	T-SERIES	T.C.	T.C.	
GROUNDING LUGS ON TECHNOLOGY EQUIPMENT	T-SERIES	T.C.	E.C.	6.
BONDING SYSTEM FOR TECHNOLOGY SYSTEM, REFER TO SPECIFICATION SECTION 27 05 26 FOR DEFINITION	T-SERIES	E.C.	E.C.	7.8.
LINE VOLTAGE POWER (+120V OR GREATER)	E-SERIES	E.C.	E.C.	
LINE VOLTAGE POWER (NOT SHOWN BUT REQUIRED FOR PROPER INSTALLATION OF SYSTEM)	N/A	T.C.	E.C.	2.4.
LINE VOLTAGE POWER FOR DOOR HARDWARE POWER SUPPLIES	ARCH SPEC	E.C.	E.C.	
LOW VOLTAGE CABLING FOR TECHNOLOGY SYSTEMS	T-SERIES	T.C.	T.C.	
CABLE HANGERS AND SUPPORTS OR OTHER CABLE ROUTING METHODS (OTHER THAN CONDUIT AND CABLE TRAY)	T-SERIES	T.C.	T.C.	5.
FLOOR BOX (ROUGH-IN)	T & E SERIES	E.C.	E.C.	

SUGGESTED MATRIX OF RESPONSIBILITY NOTES	

- LOCATIONS OF TELECOMMUNICATIONS ROUGH-INS SHALL BE INDICATED BY THE INFORMATION OUTLET SYMBOLS ON THE DRAWINGS. REFER TO THE TECHNOLOGY SYMBOL LIST FOR
- ADDITIONAL INFORMATION. BASED ON THE INHERENT DIFFERENCES IN PRODUCTS FROM VARIOUS MANUFACTURERS, ALL REQUIRED EQUIPMENT MAY NOT BE SHOWN ON THE DRAWINGS FOR ALL ACCEPTABLE
- MANUFACTURERS. INCLUDES BACKBOXES AND CONDUIT REQUIRED FOR THE TECHNOLOGY SYSTEMS
- INSTALLATION. THE E.C. SHALL BASE THE BID ON THE BASIS OF DESIGN SHOWN ON THE CONTRACT DOCUMENTS.
- ALL CHANGES TO THE SLEEVES, BACKBOXES, CONDUITS, AND POWER REQUIRED BECAUSE OF THE T.C.'S SELECTION OF AN ALTERNATE ACCEPTABLE MANUFACTURER OR FROM SYSTEM CONFIGURATIONS THAT ARE LEFT TO THE CHOICE OF THE CONTRACTOR SHALL BE INCLUDED IN THE T.C.'S BID. THIS BID SHALL INCLUDE INSTALLATION BY A LICENSED ELECTRICIAN.
- UNLESS TRADE RULES DICTATE OTHERWISE. FURNISHED AS PART OF THE EQUIPMENT WHEN POSSIBLE, OR FURNISHED TO THE E.C. FOR INSTALLATION IN THE FIELD.
- INCLUDES ALL CONDUCTORS, GROUND BARS, AND TERMINATIONS FOR THE COMPLETE BONDING SYSTEM REQUIRED BY THE SPECIFICATIONS.

TELECOM ROOM REFERENCES						
	DETAIL / SHEET	FLOOR PLAN				
TELECOM ROOM	REFERENCE	REFERENCE	ARCH ROOM NUMBER			
TR-1	NA	1/T-103	217			

TECHNOLOGY GENERAL NOTES:

- LIST ABBREVIATION" 2. REFER TO TECHNOLOGY EQUIPMENT SCHEDULE AND SPECIFICATIONS FOR FULL DESCRIPTIONS AND MANUFACTURERS OF ALL DEVICES. TECHNOLOGY MOUNTING SUBSCRIPT KEY: A MOUNT AT +6" TO CENTERLINE ABOVE COUNTER OR BACKSPLASH
- MOUNT ORIENTED HORIZONTALLY MOUNT IN CASEWORK MOUNT IN MODULAR FURNITURE MOUNT IN SURFACE RACEWAY S A SLASH IS USED BETWEEN TWO SUBSCRIPTS, E.G., A/H.

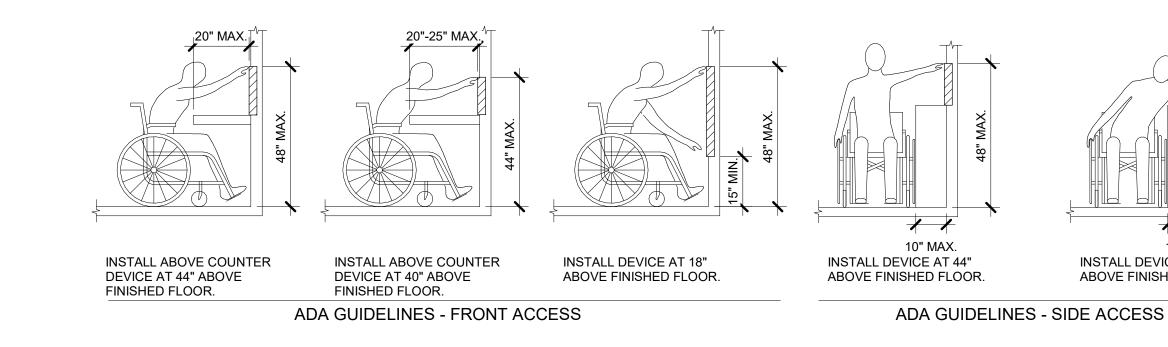
TECHNOLOGY INSTALLATION NOTES:

- 1. THE COMPLETE INSTALLATION SHALL BE IN ACCORDANCE WITH THE ADA STANDARDS FOR ACCESSIBLE DESIGN. REFER TO THE ADA GUIDELINES FOR ALL CONFIGURATION DETAILS ON THIS PAGE FOR ADDITIONAL INFORMATION.
- UNLESS OTHERWISE INDICATED ON THE PLANS OR IN THE SPECIFICATIONS. CONDUIT IN MECHANICAL ROOMS AND STORAGE ROOMS WITHOUT CEILINGS MAY BE EXPOSED ON BUILDING STRUCTURE.
- OF 6" HORIZONTALLY. BOXES ON OPPOSITE SIDES OF FIRE RATED WALLS SHALL BE OFFSET A MINIMUM OF 24" HORIZONTALLY. "THRU-THE-WALL" BOXES SHALL NOT BE ALLOWED WITHOUT PRIOR WRITTEN APPROVAL OF THE ARCHITECT/ENGINEER. 4. VERIFY ALL FURNITURE, MODULAR FURNITURE, AND EQUIPMENT LOCATIONS WITH
- THE ACTUAL TELECOMMUNICATIONS INSTALLATION, ADJUST OUTLETS OR CONNECTION LOCATIONS TO ACCOMMODATE FURNITURE AND/OR EQUIPMENT. 5. TELECOMMUNICATIONS EQUIPMENT SHALL BE MOUNTED TO ALLOW ACCESS TO
- DEVICES ON EQUIPMENT SUPPLIED BY ANOTHER CONTRACTOR SHALL BE APPROVED IN ADVANCE BY THE OTHER CONTRACTOR. 6. CONTRACTOR SHALL BE RESPONSIBLE FOR ALL OPENINGS REQUIRED IN WALLS. ALL OPENINGS SHALL BE REPAIRED TO MATCH EXISTING BY A QUALIFIED CONTRACTOR AT THE EXPENSE OF THIS CONTRACTOR. ALL CONDUITS THROUGH WALLS SHALL BE GROUTED OR SEALED INTO OPENINGS.
- ALL MATERIALS USED TO SEAL PENETRATIONS OF FIRE RATED WALLS AND FLOORS SHALL BE TESTED AND CERTIFIED AS A SYSTEM PER ASTM E814 STANDARDS FOR FIRE TESTS OF THROUGH-PENETRATION FIRESTOPS. REFER TO DIVISION 7 FOR ADDITIONAL INFORMATION AND REQUIREMENTS SPECIFIC TO FIRESTOPPING. REMOVE AND REINSTALL ALL CEILING TILES AS REQUIRED FOR THE EXECUTION OF
- REPLACE CEILING TILES WITH IDENTICAL MATERIAL WHERE DAMAGED BY THIS CONTRACTOR. 9. FLUSH MOUNT ALL TELECOMMUNICATION OUTLETS AT +18" FROM FLOOR (CENTERLINE

WHEN CONDUIT IS SPECIFIED EXPOSED.

- 1. THE DRAWINGS INDICATE EXISTING ITEMS TO BE REMOVED. THE DRAWINGS ARE INTENDED TO INDICATE THE SCOPE OF WORK REQUIRED AND DO NOT INDICATE EVERY
- SITE PRIOR TO SUBMITTING A BID AND VERIFY EXISTING CONDITIONS. ITEMS (i.e. SPEAKERS, SWITCHES, ETC.) REMOVED AND NOT RELOCATED REMAIN THE
- DISPOSAL OF MATERIAL THE OWNER DOES NOT WANT TO REUSE OR RETAIN. (i.e., FOR MAINTENANCE PURPOSES). 3. EXISTING TO REMAIN DEVICES WITHIN OR ADJACENT TO THE PATH OF CONSTRUCTION
- PRIOR TO REMOVAL, PROTECTED FROM DAMAGE, AND RE-INSTALLED IN ITS ORIGINAL LOCATION DURING THE NEW CONSTRUCTION PHASE OF THE PROJECT. 4. OBTAIN APPROVAL FROM THE OWNER BEFORE TURNING OFF THE POWER TO
- EQUIPMENT, SYSTEMS, PANELS, ETC. COORDINATE ALL OUTAGES WITH OWNER. CONDUIT CONCEALED IN WALL CONSTRUCTION MAY BE ABANDONED IN PLACE IF NOT AFFECTED BY OTHER CONSTRUCTION.
- 5. ALL CONDUIT SHALL BE REMOVED WHERE WALLS ARE BEING REMOVED. WHERE CONDUIT IS IN THE CONCRETE SLAB, CUT OFF FLUSH, PULL OUT WIRE, AND PLUG. WHERE CONDUIT IS RUN EXPOSED, ALL ASSOCIATED CLAMPS, SUPPORTS, HANGERS, ETC., SHALL ALSO BE REMOVED.
- 6. COORDINATE ALL WORK WITH OTHER CONTRACTORS AT THE JOB SITE BEFORE REMOVING EXISTING EQUIPMENT AND INSTALLING NEW ITEMS.
- EXISTING CONDUIT SHALL NOT BE ALLOWED. BONDING CONDUCTORS SHALL BE INSTALLED IN ALL REUSED CONDUIT TO ASSURE PROPER GROUND PATH. 8. EQUIPMENT REMOVAL IN CERTAIN LOCATIONS MAY REQUIRE THE INSTALLATION OF A
- CONDUIT AND WIRING AS REQUIRED TO MAINTAIN POWER TO REMAINING EQUIPMENT. 9. DEVICES TO BE REMOVED SHALL HAVE ALL CONNECTED WIRING REMOVED TO THE SOURCE.
- 10. DEVICES NOT TO BE REMOVED SHALL BE PROTECTED FROM THE ENVIRONMENT, AND ALL ASSOCIATED CABLE/RACEWAYS ARE TO REMAIN AND BE PROTECTED. T.C. SHALL BE RESPONSIBLE FOR REPAIR OF ANY INTERRUPTIONS TO PROTECTED DEVICES. 11. REFER TO SPECIFICATIONS SECTION 27 05 00 AND 27 05 05 FOR ADDITIONAL INFORMATION.

	TECHNOLOGY S
T-000	TECHNOLOGY COVERSHEET
T-101	BASEMENT PLAN - TECHNOLOGY
T-102	FIRST FLOOR PLAN - TECHNOLOGY
T-103	SECOND FLOOR PLAN - TECHNOLC
T-301	TECHNOLOGY DETAILS
T-401	TECHNOLOGY DIAGRAMS
T-501	TECHNOLOGY SCHEDULES
TD101	BASEMENT PLAN - TECHNOLOGY D
TD102	FIRST FLOOR PLAN - TECHNOLOGY
TD103	SECOND FLOOR PLAN - TECHNOLC
GRAND TOTAL: 10)



ADA STANDARDS FOR ACCESSIBLE DESIGN

of ction ilities	Drawing Title TECHNOLOGY COVERSHEET	Phase BID DOCUMENTS	Project Title Renovate and Repair S Building 4	
Pepartment erans s	Approved:	FULLY SPRINKLERED	Location Wichita, KS Issue Date 9/23/2021 Check	
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1. ####### INDICATES TECHNOLOGY EQUIPMENT SCHEDULE ITEM LABELED AS "EQUIPMENT

2. CONCEAL ALL CONDUIT IN WALLS, PARTITIONS, ABOVE CEILING, IN FLOOR SLAB, ETC. 3. BOXES LOCATED ON OPPOSITE SIDES OF NON-RATED WALLS SHALL BE OFFSET A MINIMUM

ARCHITECTURAL PLANS, ELEVATIONS, AND REVIEWED SHOP DRAWINGS. PRIOR TO MAKING ELECTRICAL AND MECHANICAL EQUIPMENT. ALL MOUNTING OF TELECOMMUNICATION

TELECOMMUNICATIONS WORK THAT IS OUTSIDE THE CONTRACT LIMITS OF CONSTRUCTION.

DIMENSION), EXCEPT WHERE OTHERWISE NOTED. OUTLETS MAY BE SURFACE MOUNTED

TECHNOLOGY DEMOLITION NOTES

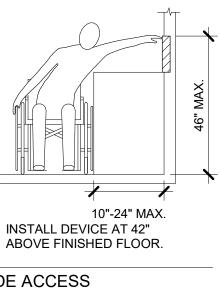
BOX. CONDUIT, OR WIRE THAT MUST BE REMOVED. THE CONTRACTOR SHALL VISIT THE PROPERTY OF THE OWNER. THE CONTRACTOR SHALL BE RESPONSIBLE FOR THE

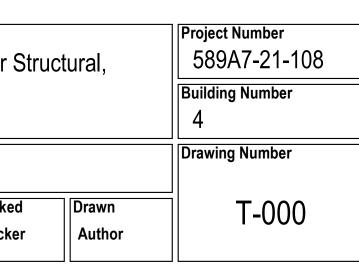
SHALL BE PROTECTED IN PLACE. DEVICES THAT MUST BE REMOVED SHALL BE TESTED

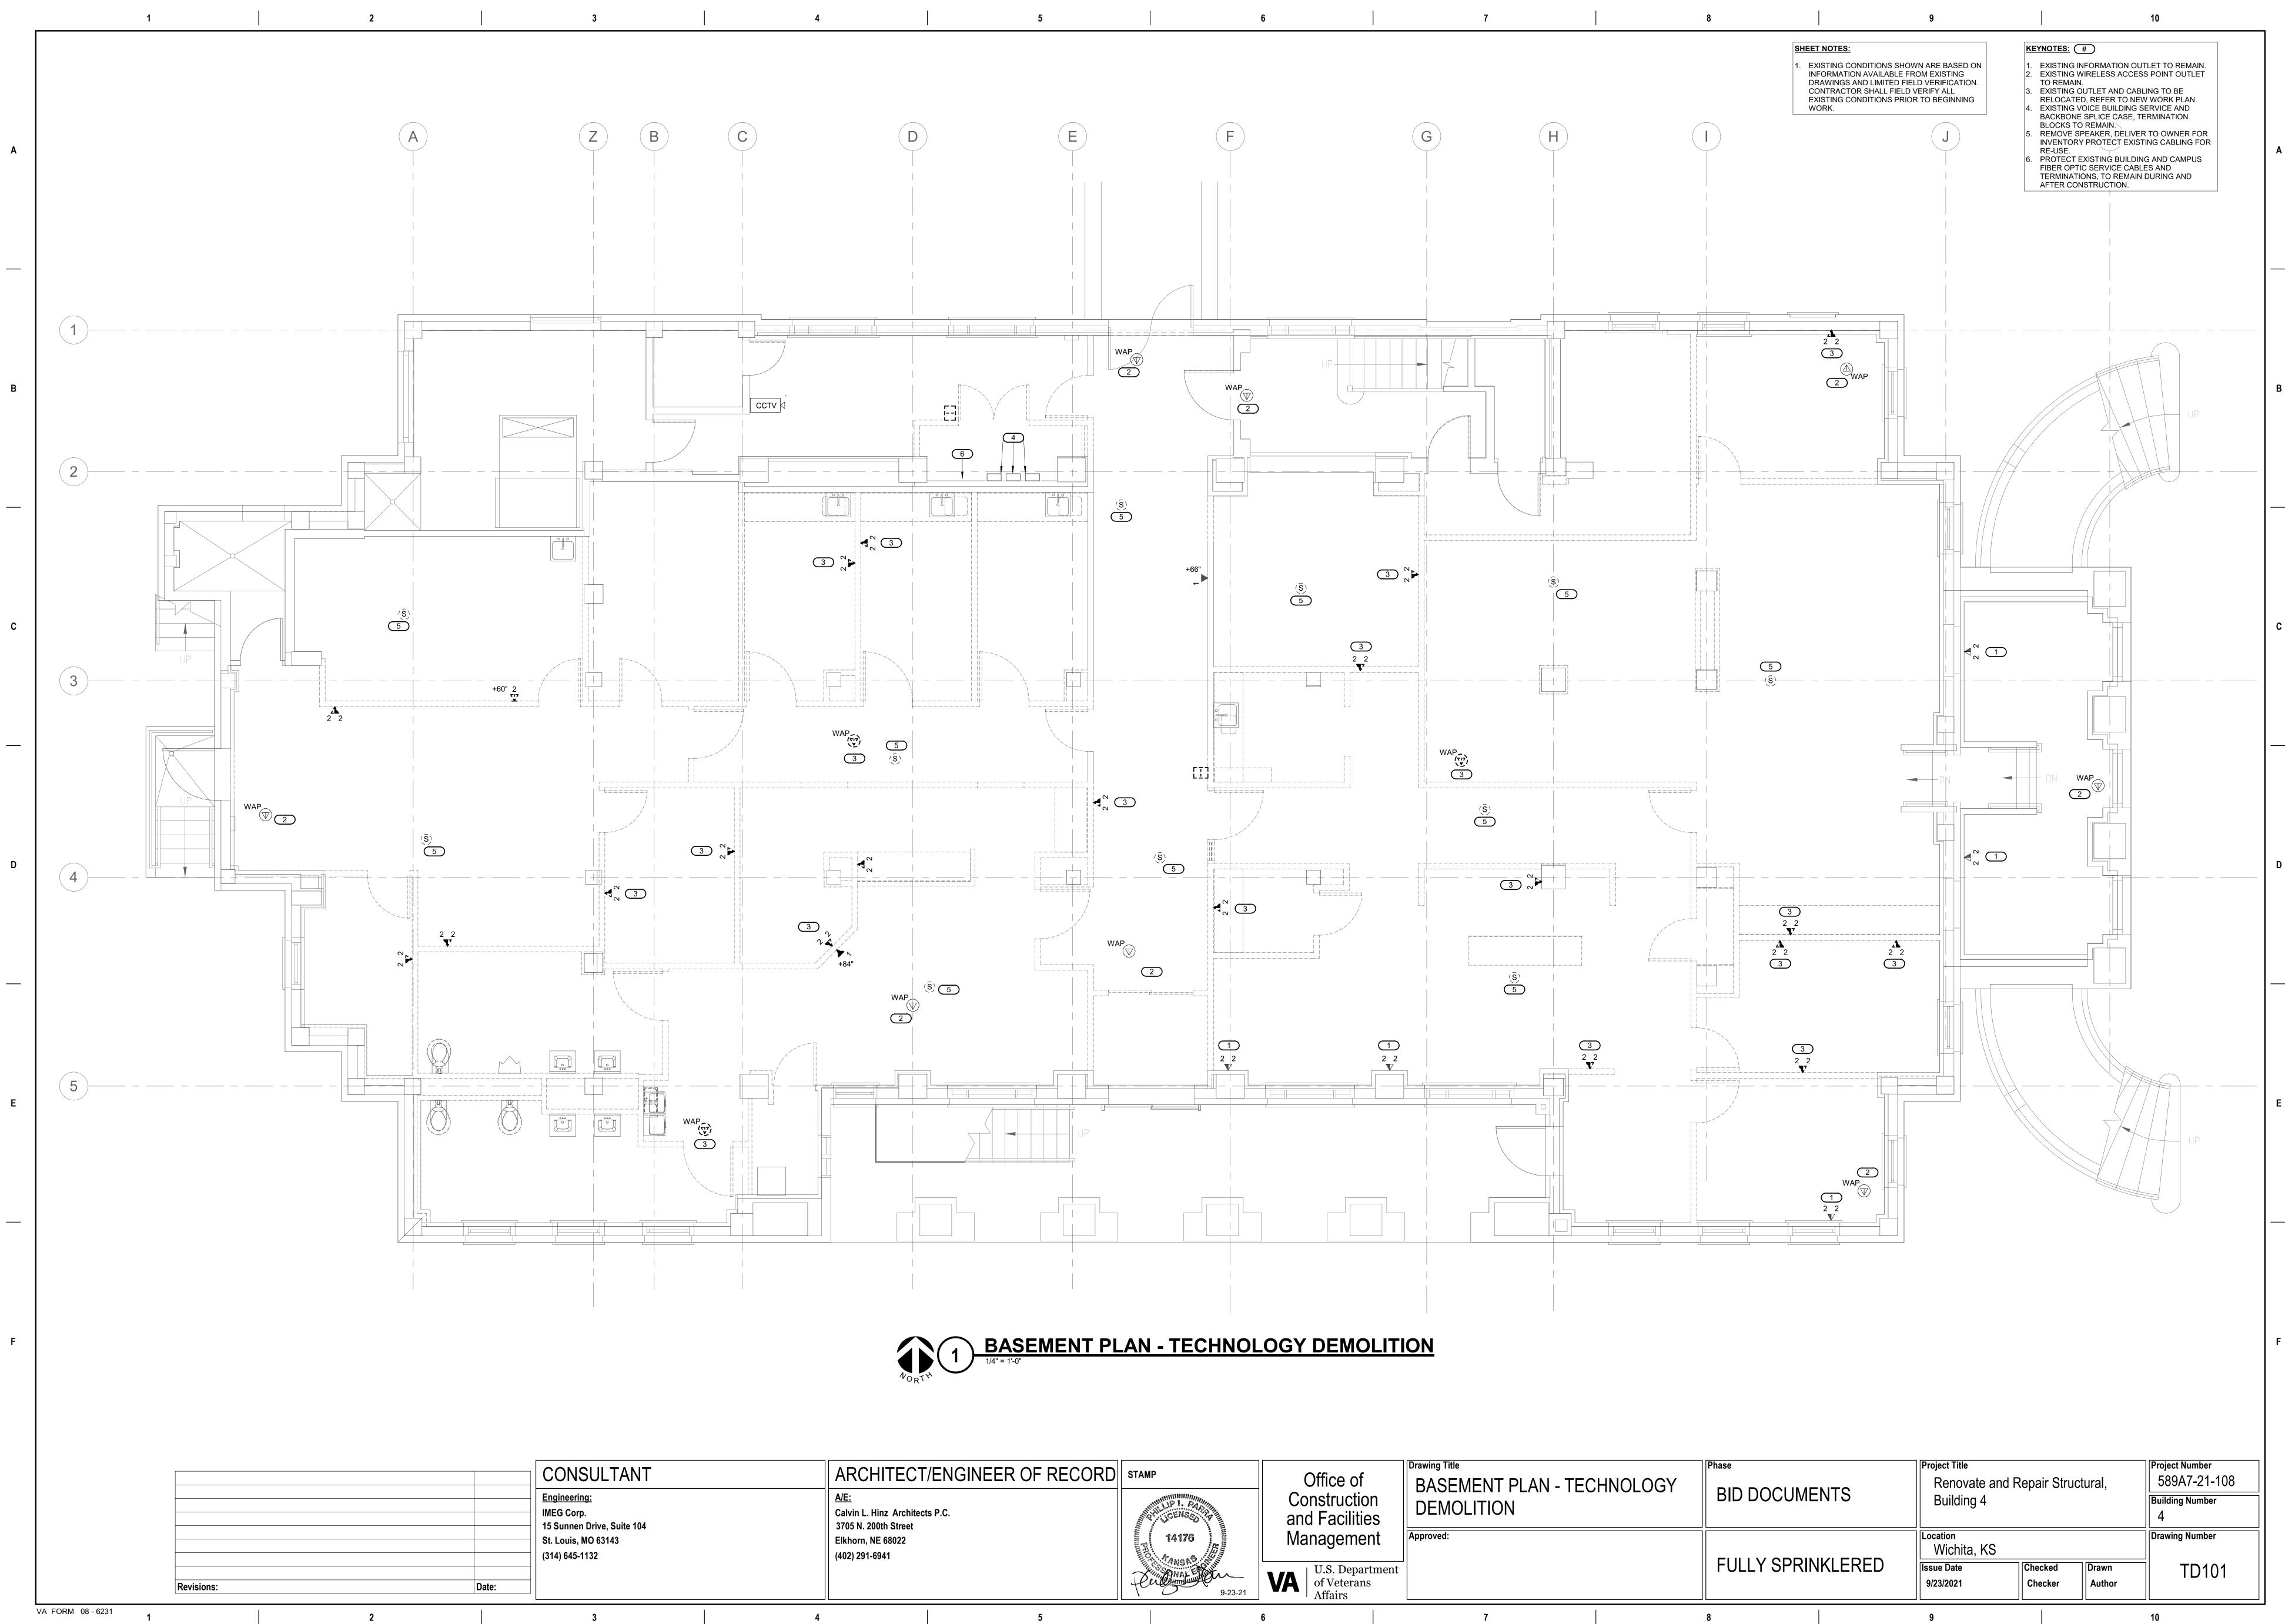
7. EXISTING CONDUIT IN GOOD CONDITION, MAY BE REUSED IN PLACE. RELOCATING JUNCTION BOX TO RECONNECT CIRCUITS THAT REMAIN IN OPERATION. EXTEND

SHEET INDEX

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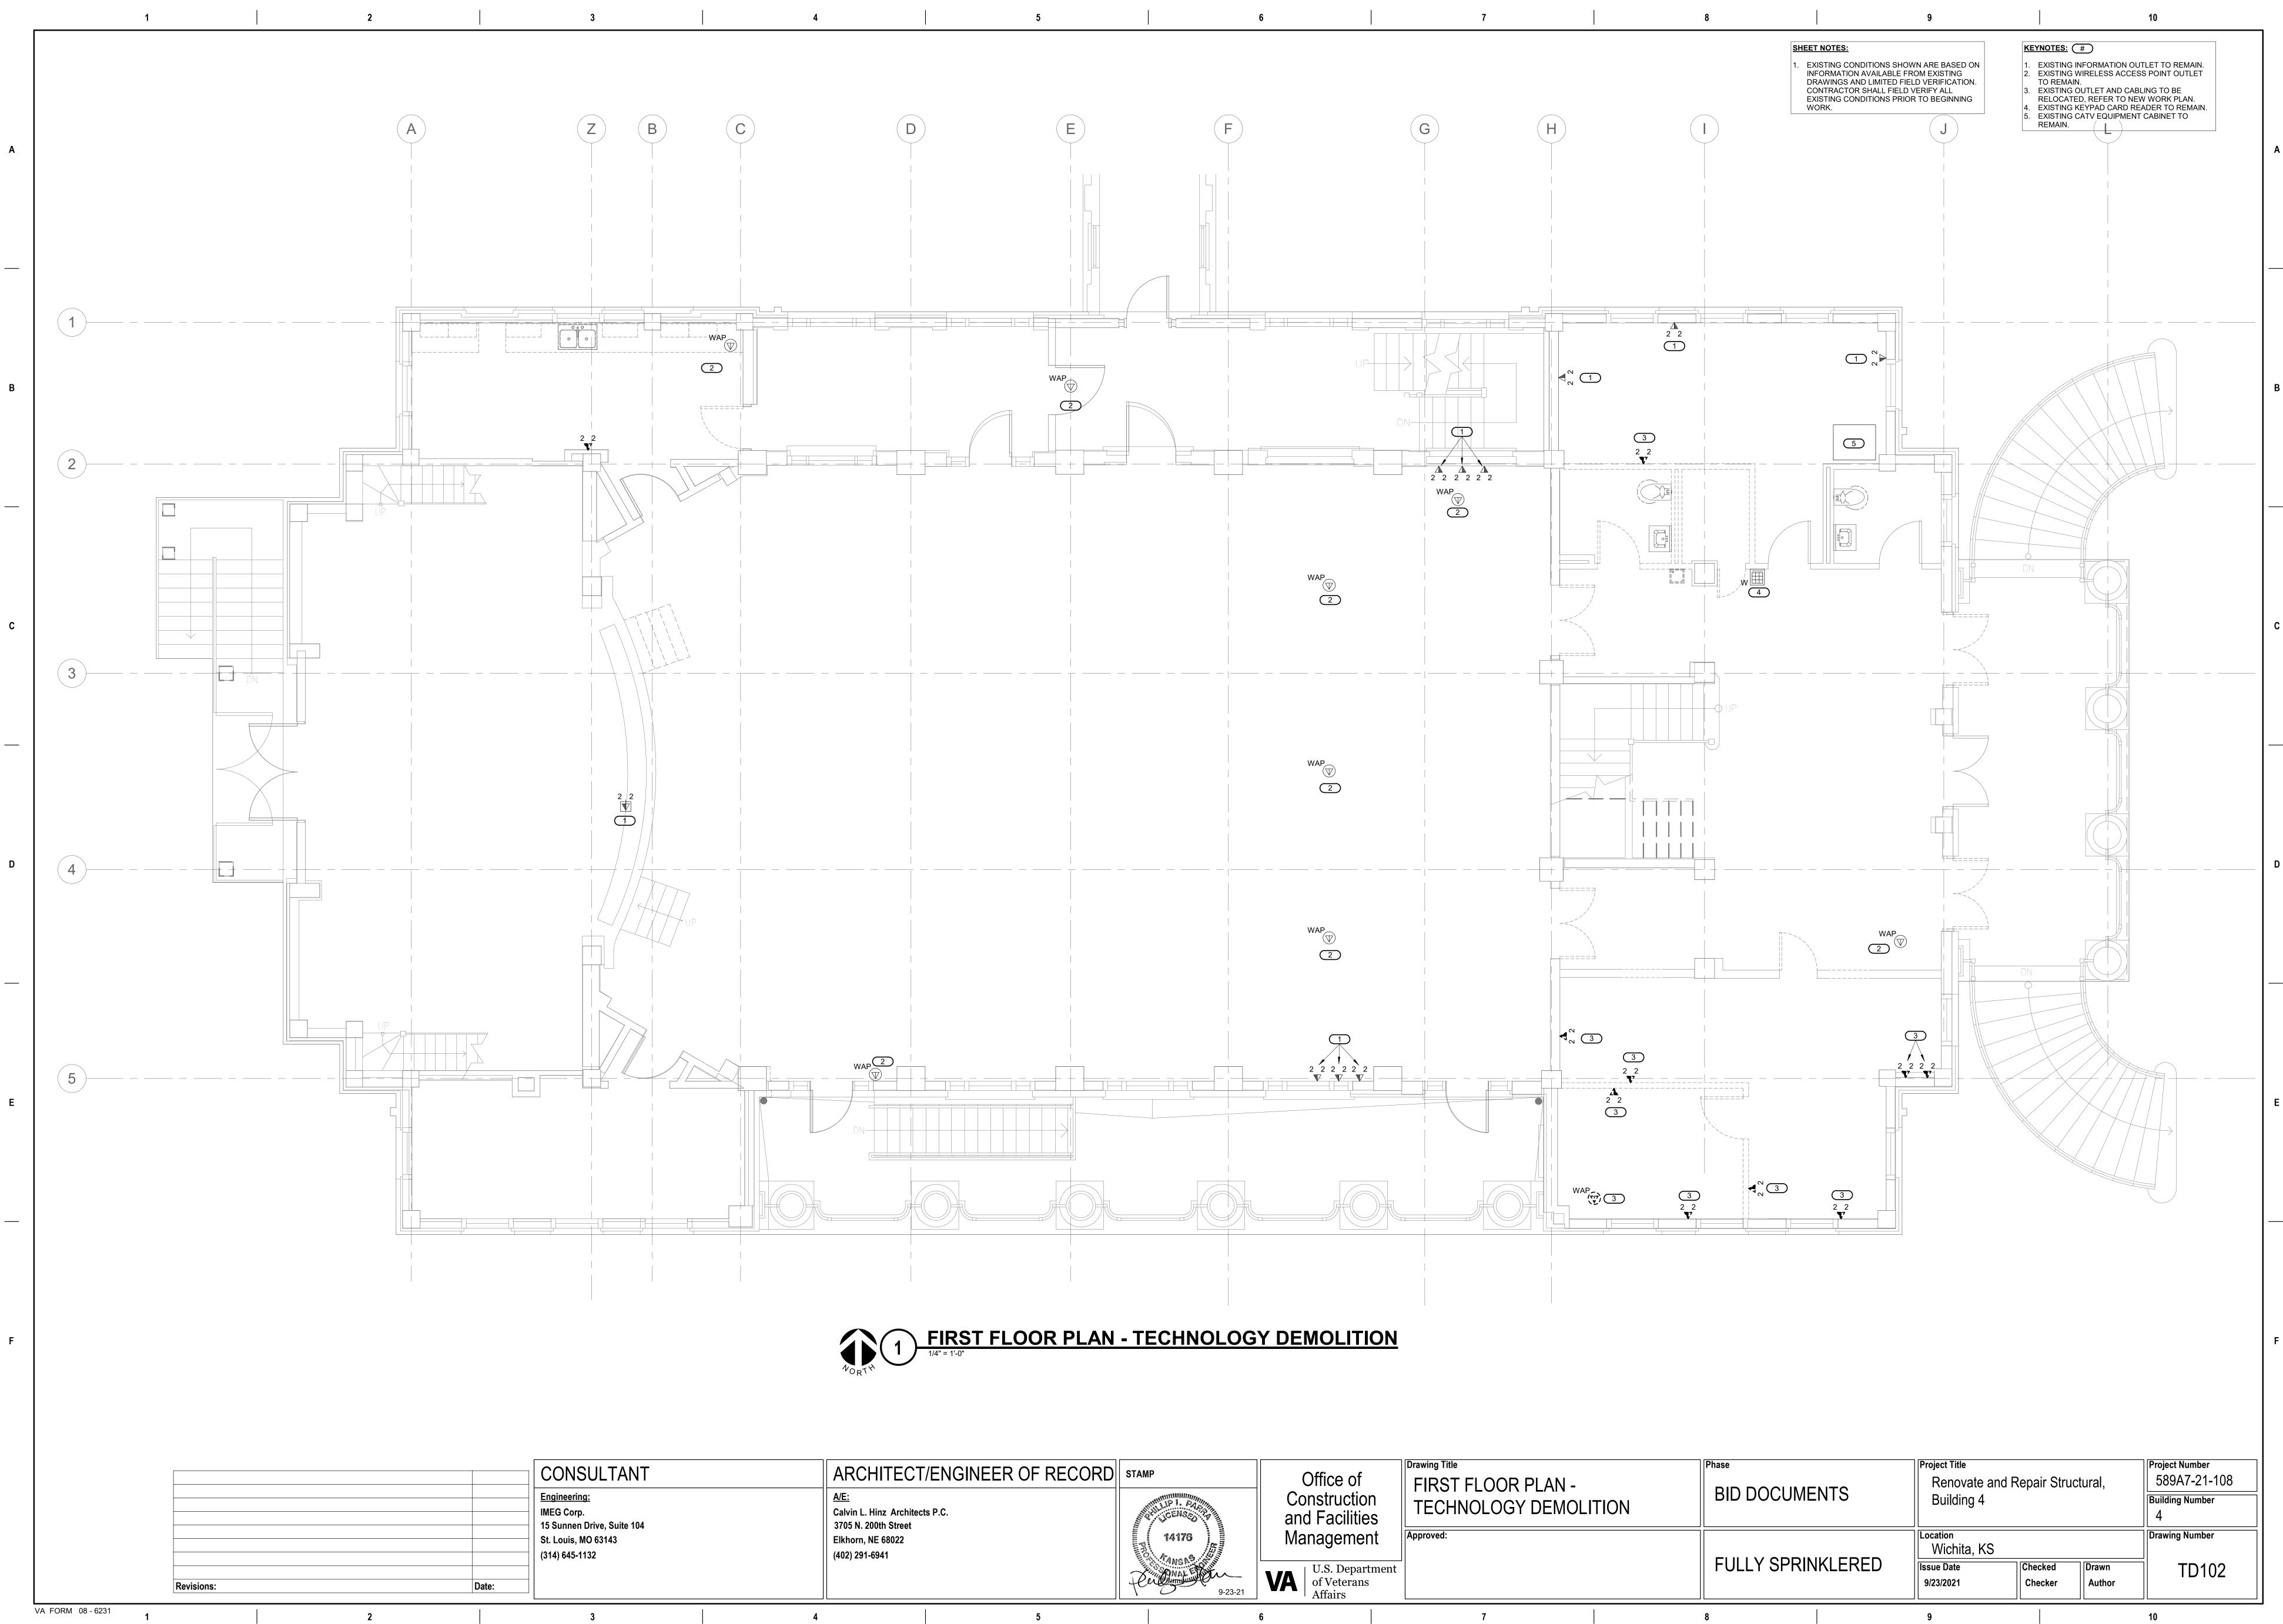






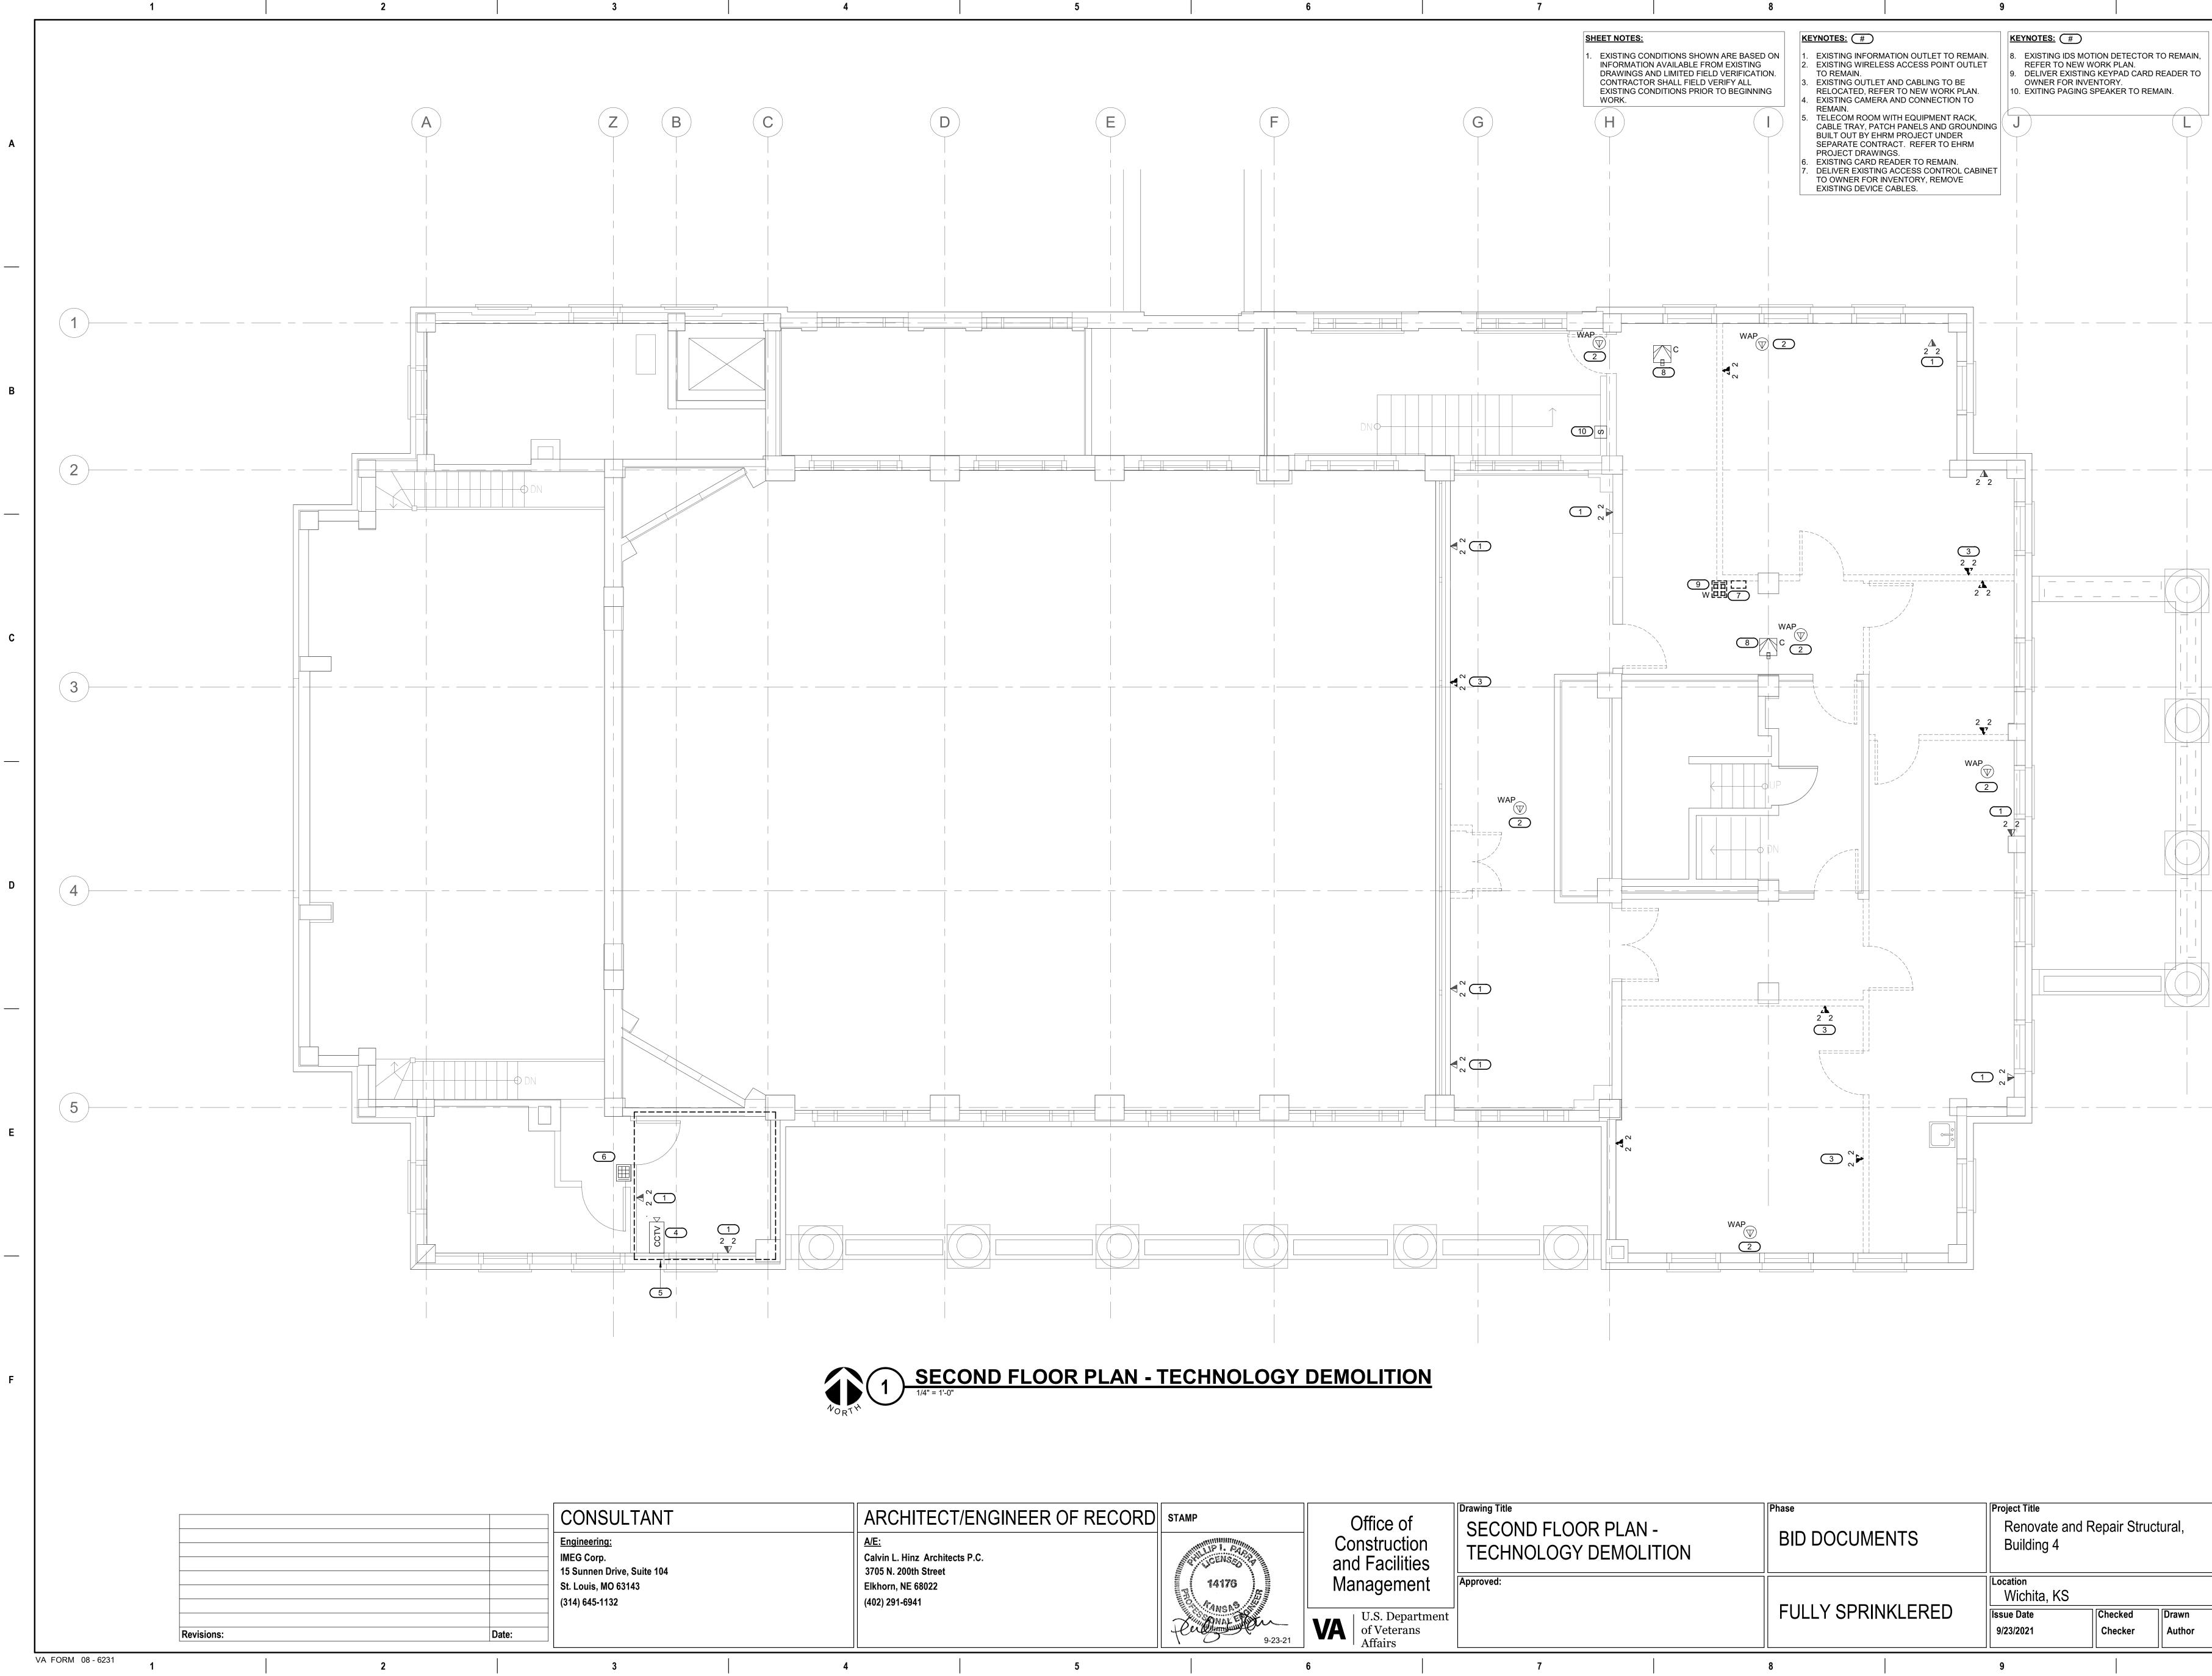
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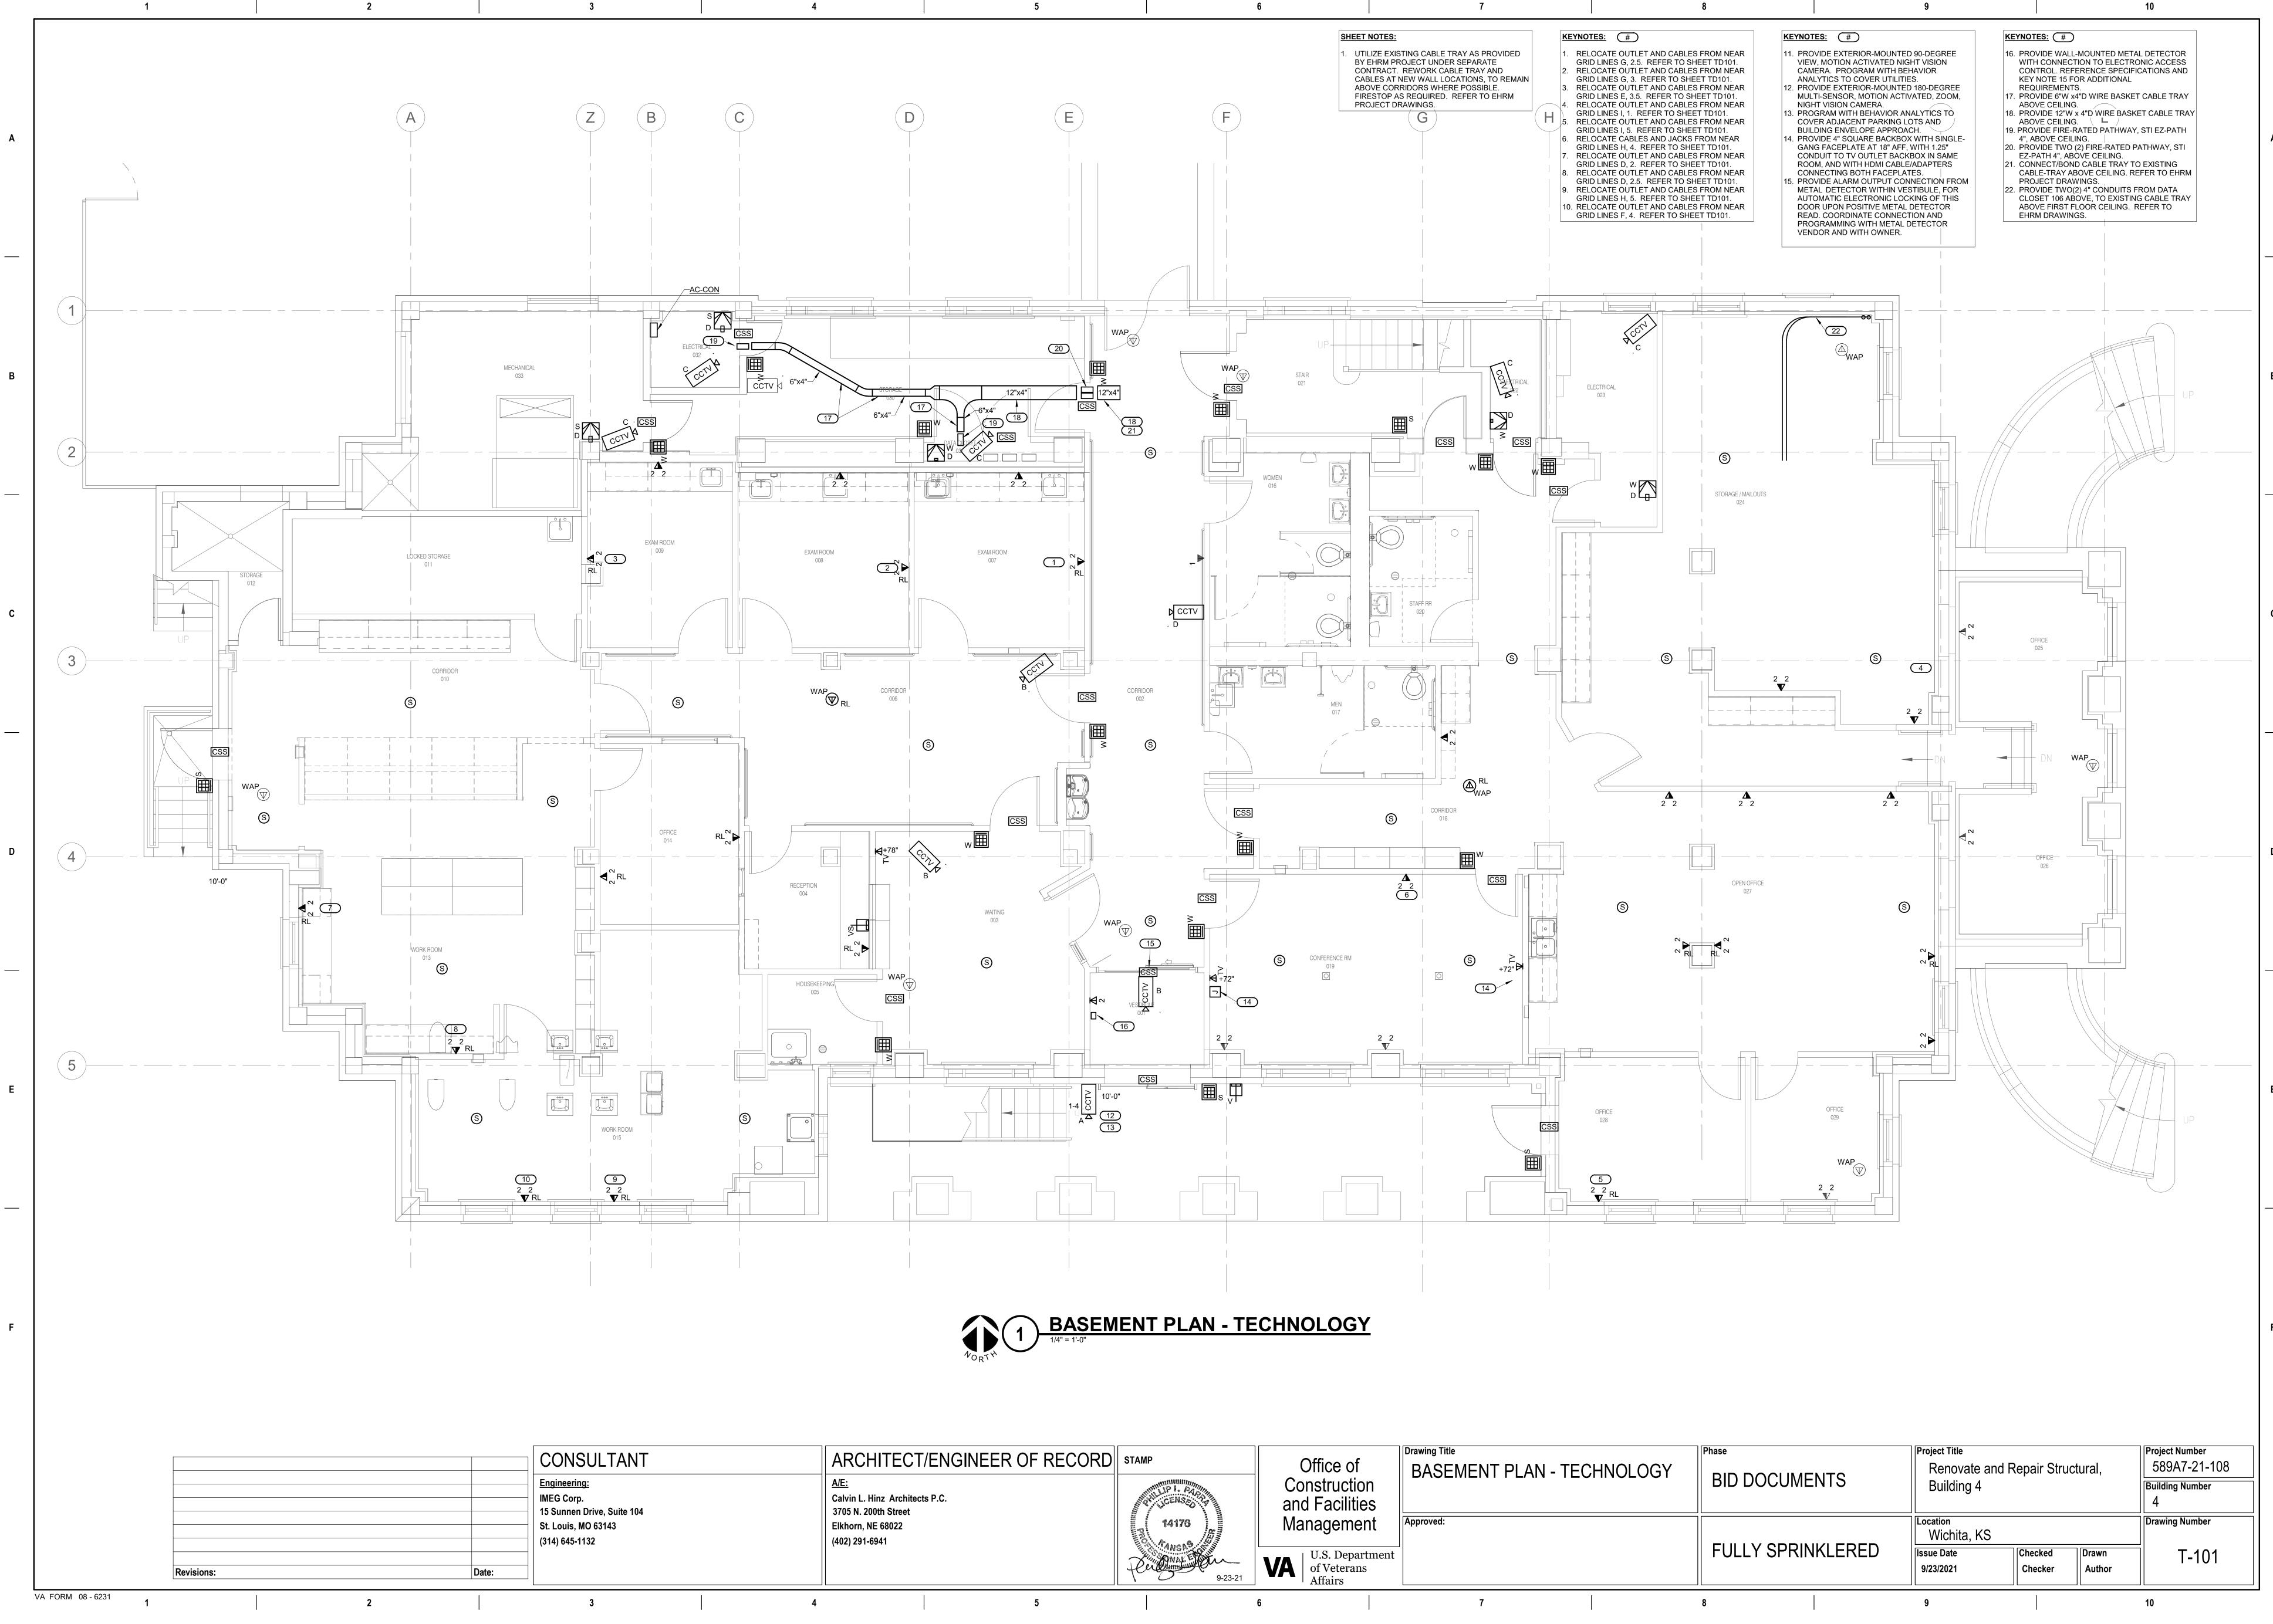
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Department Veterans	Approved:	FULLY SPRINKLERED	Location Wichita, KS Issue Date 9/23/2021 Checker
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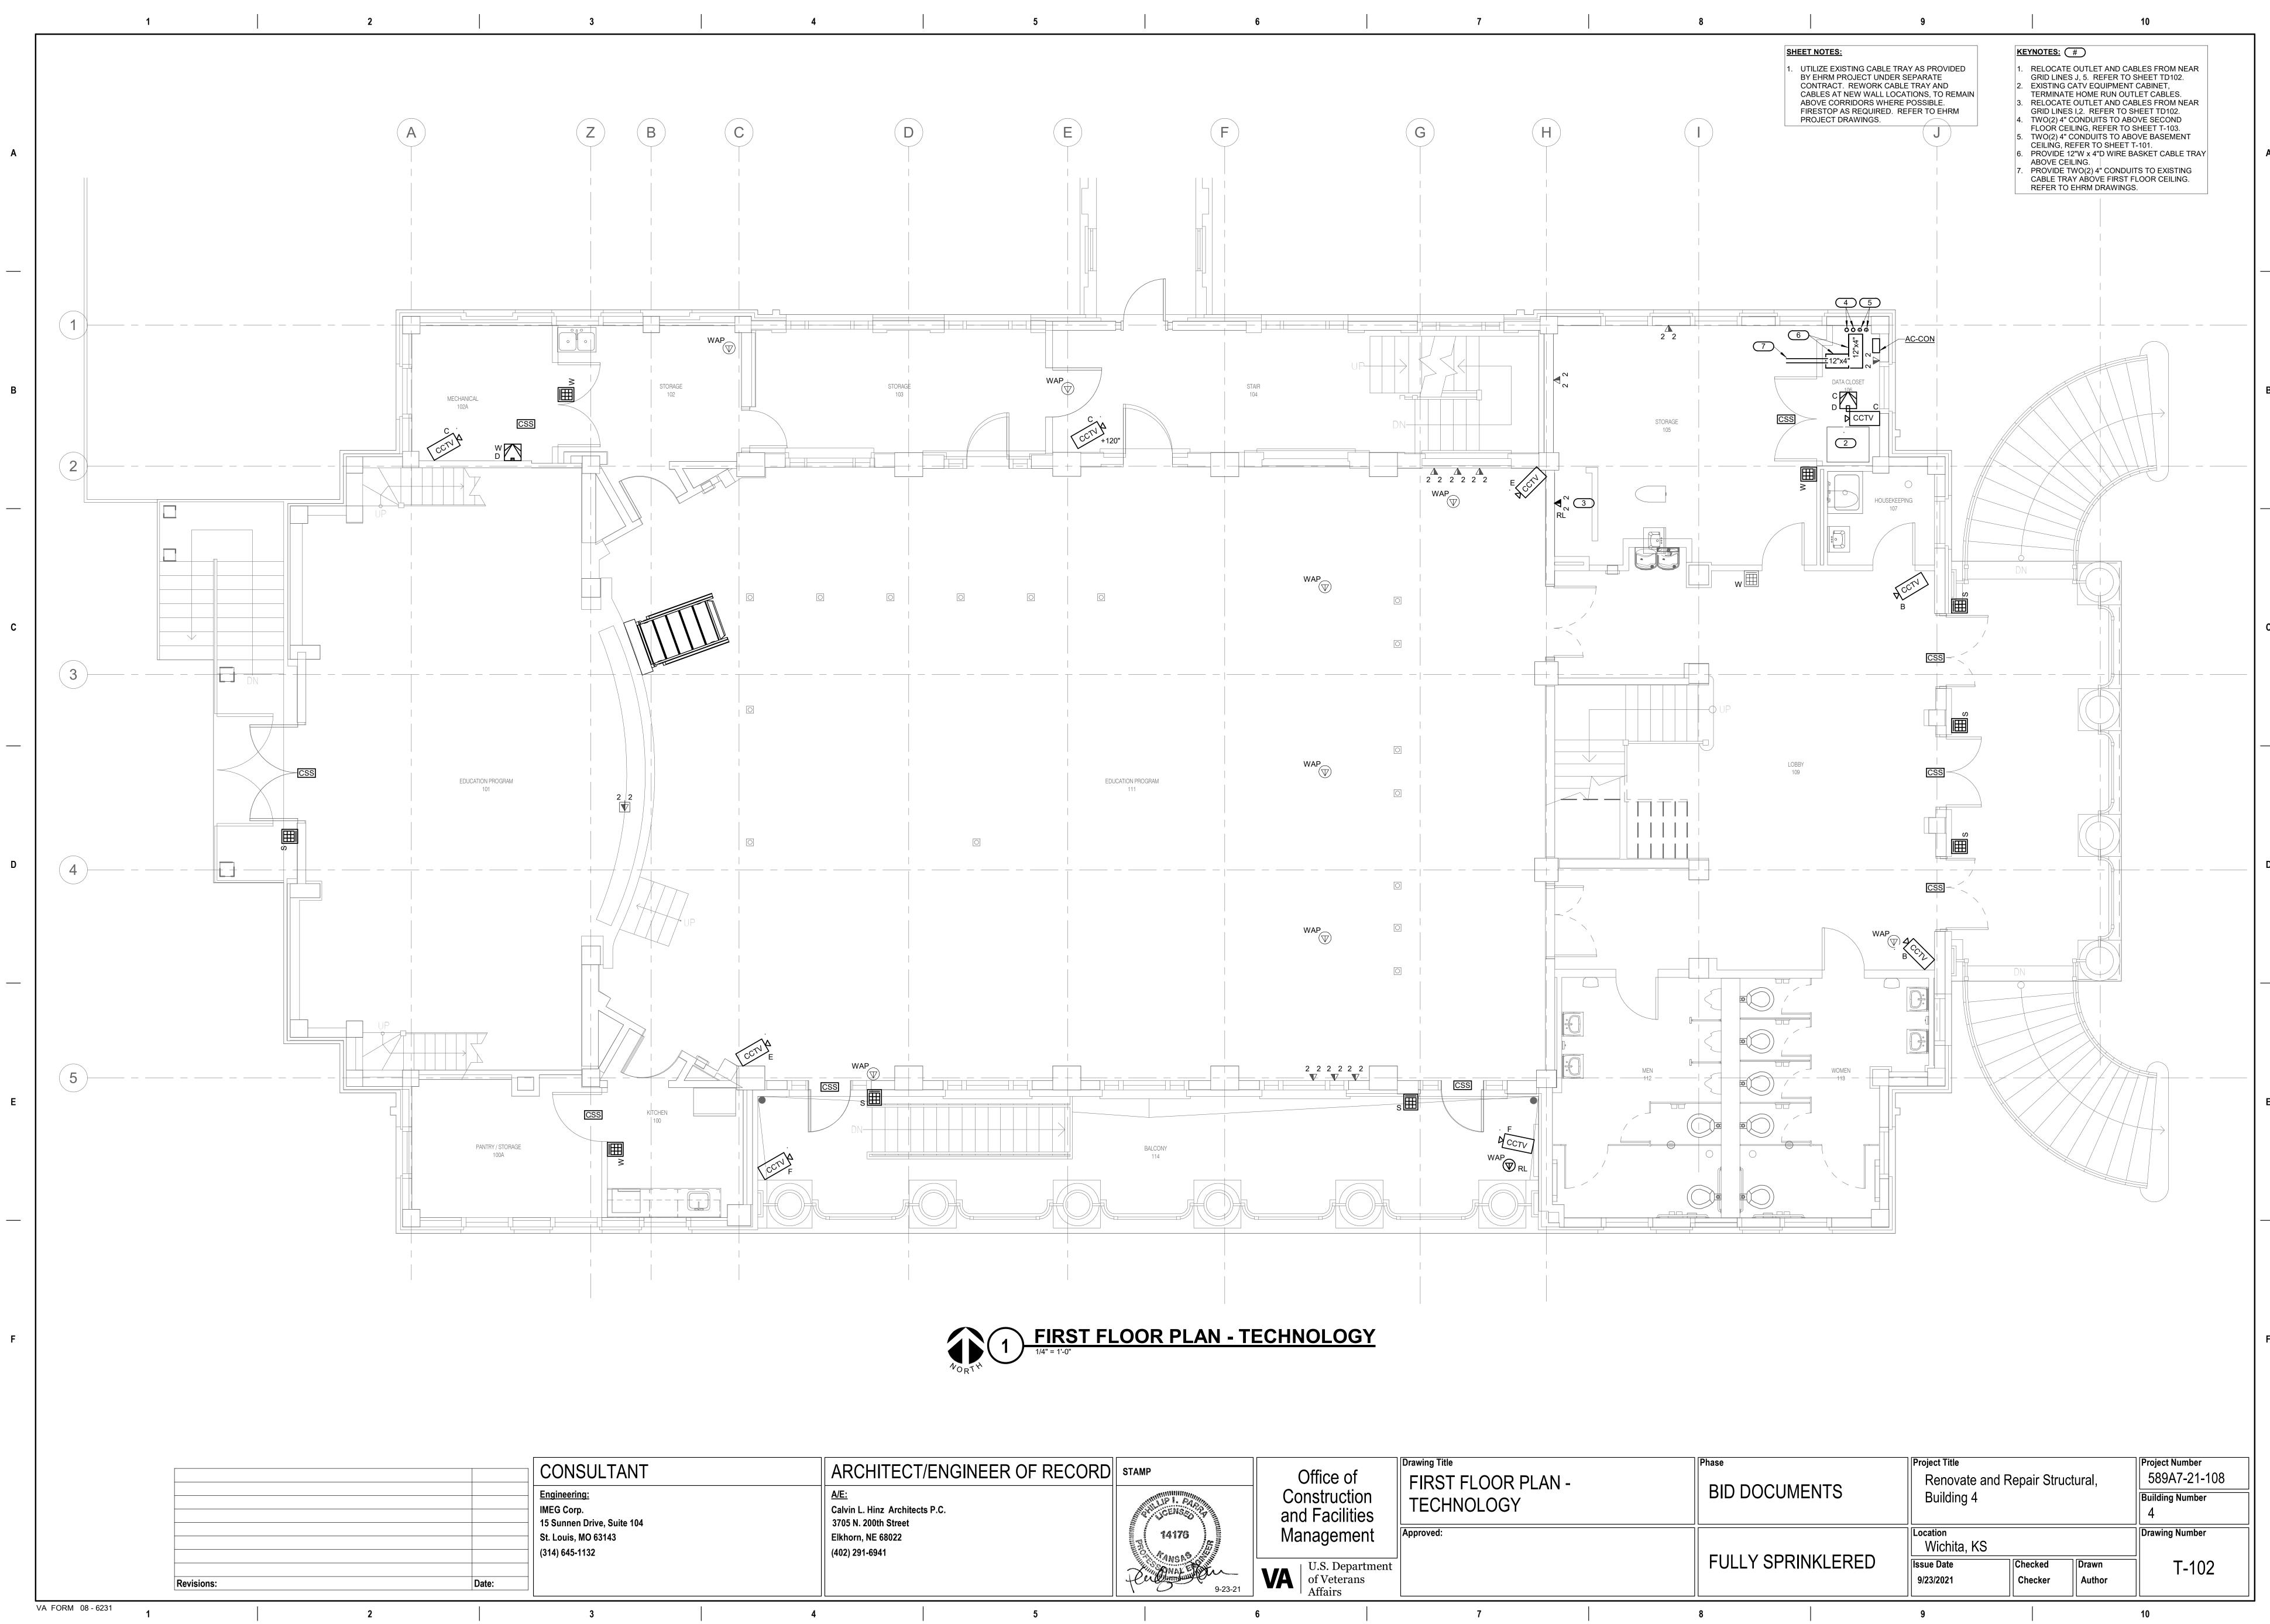
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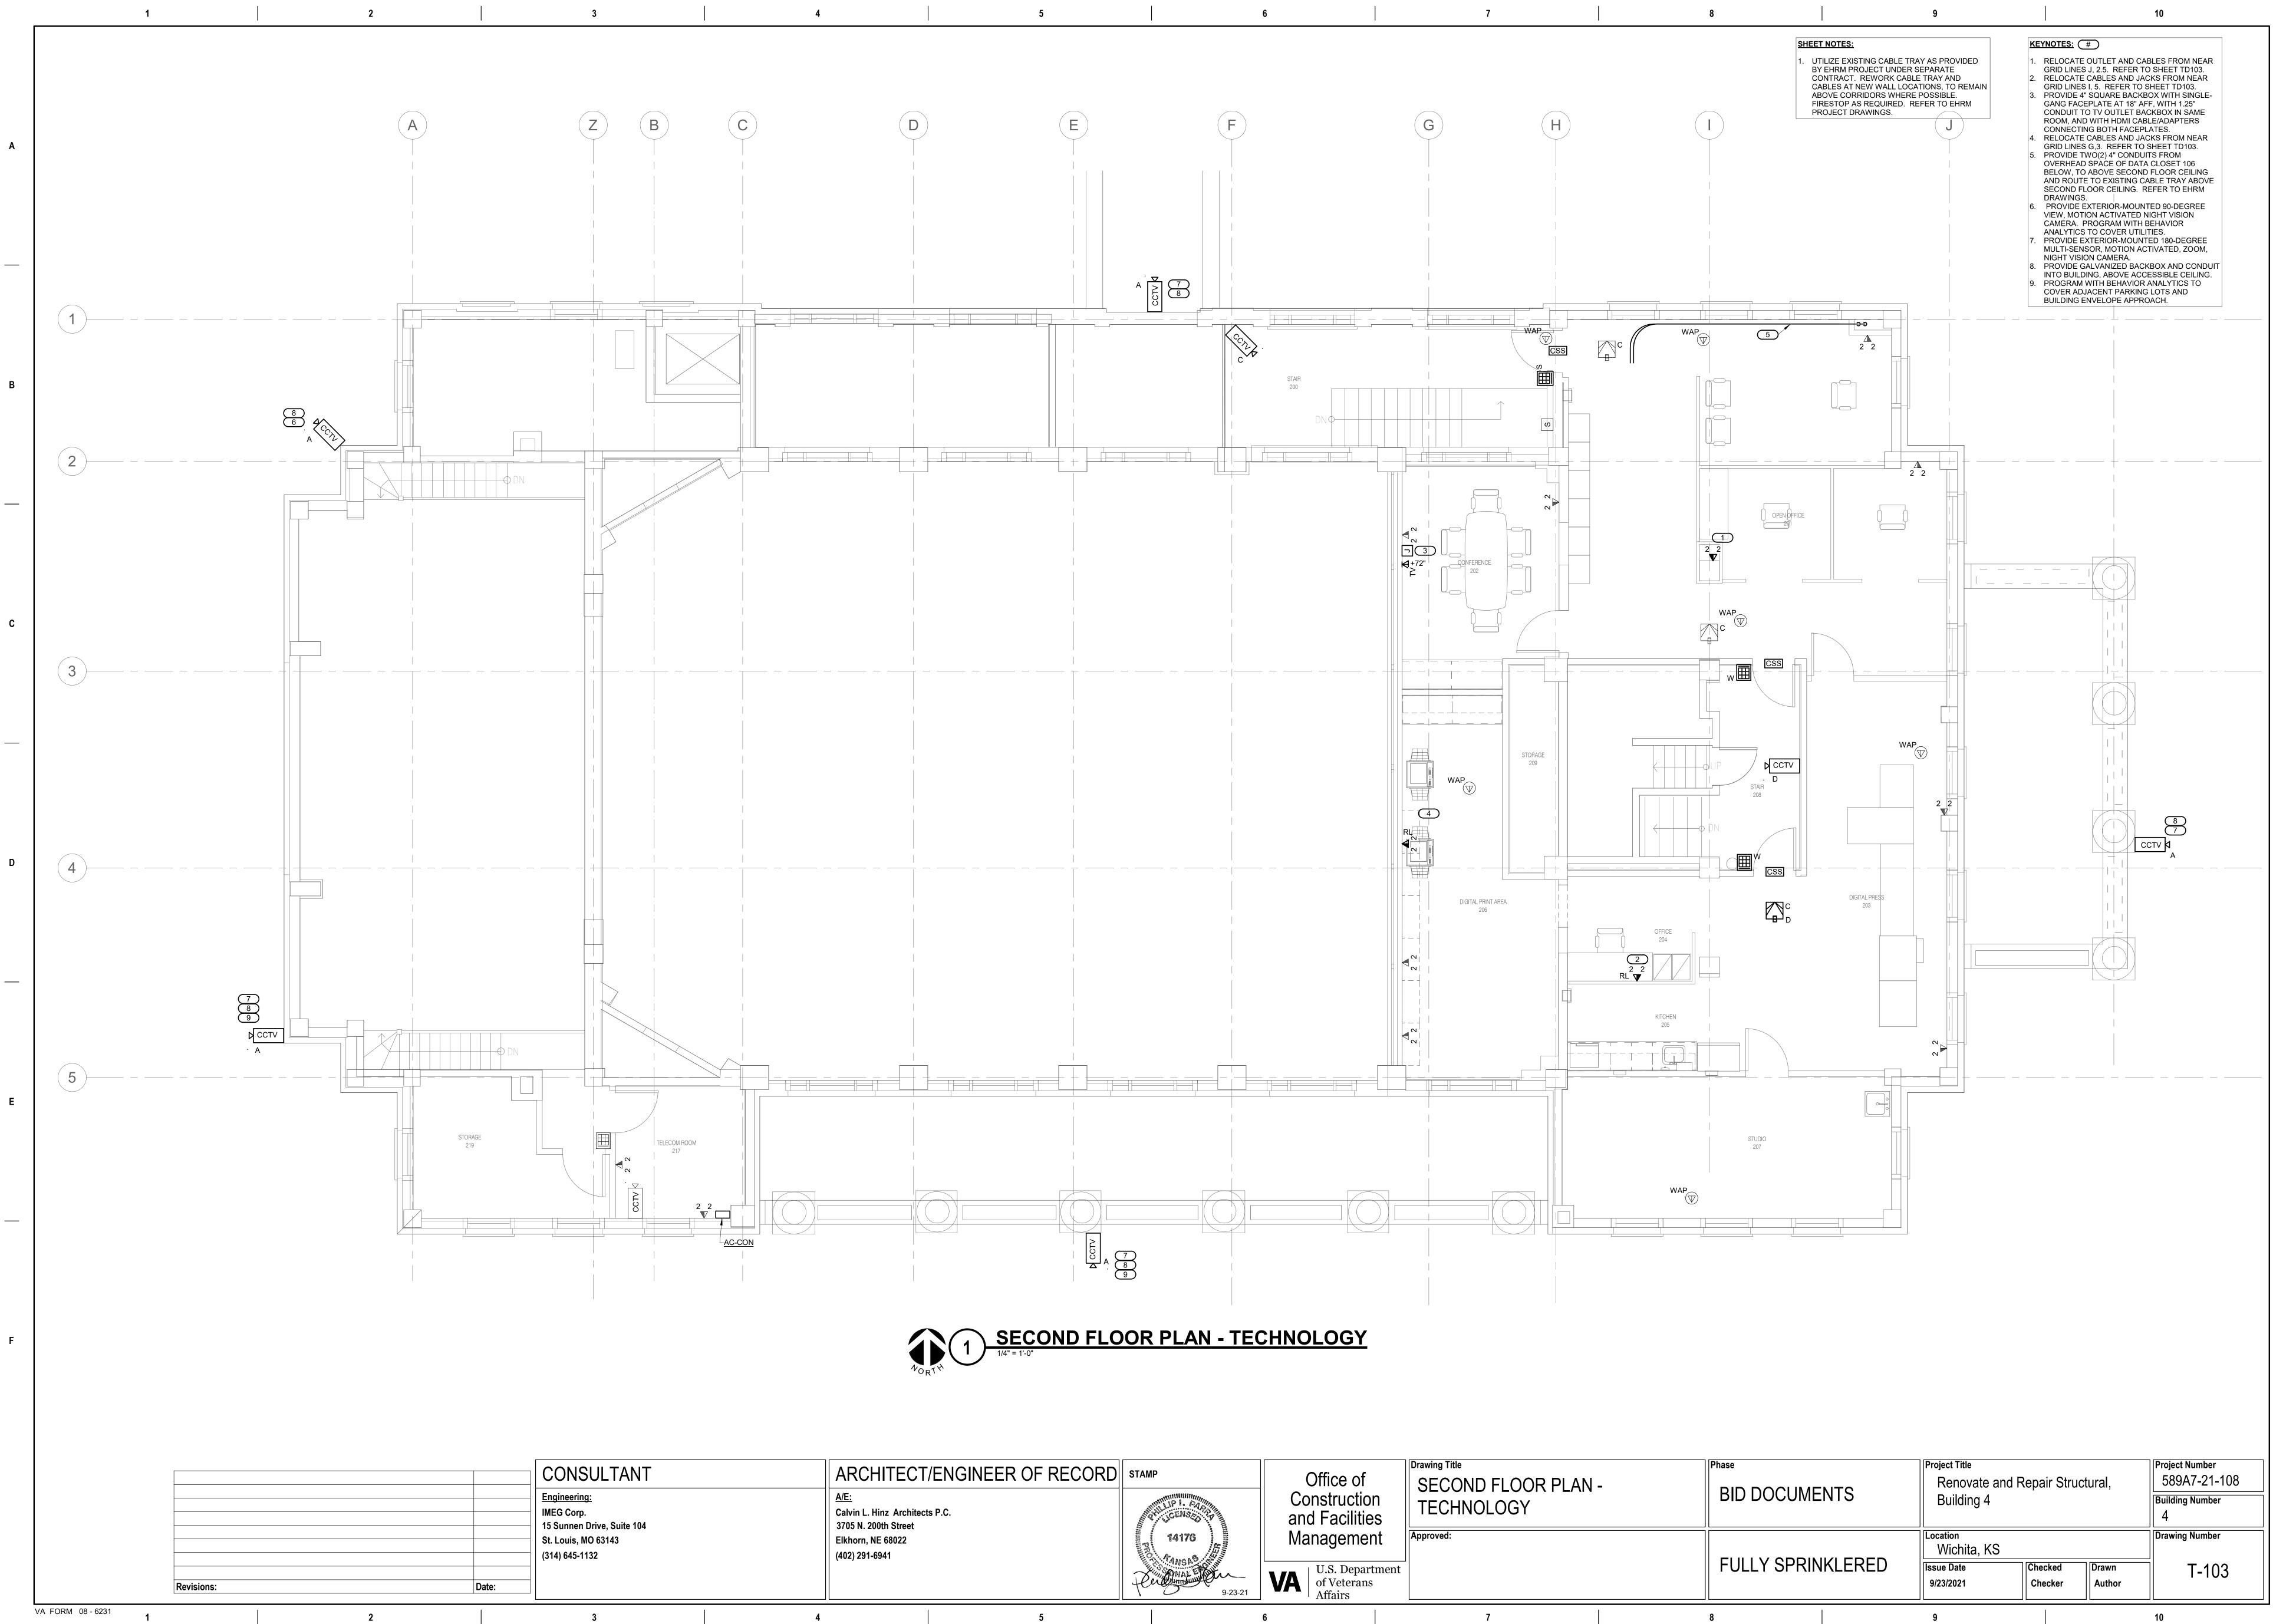




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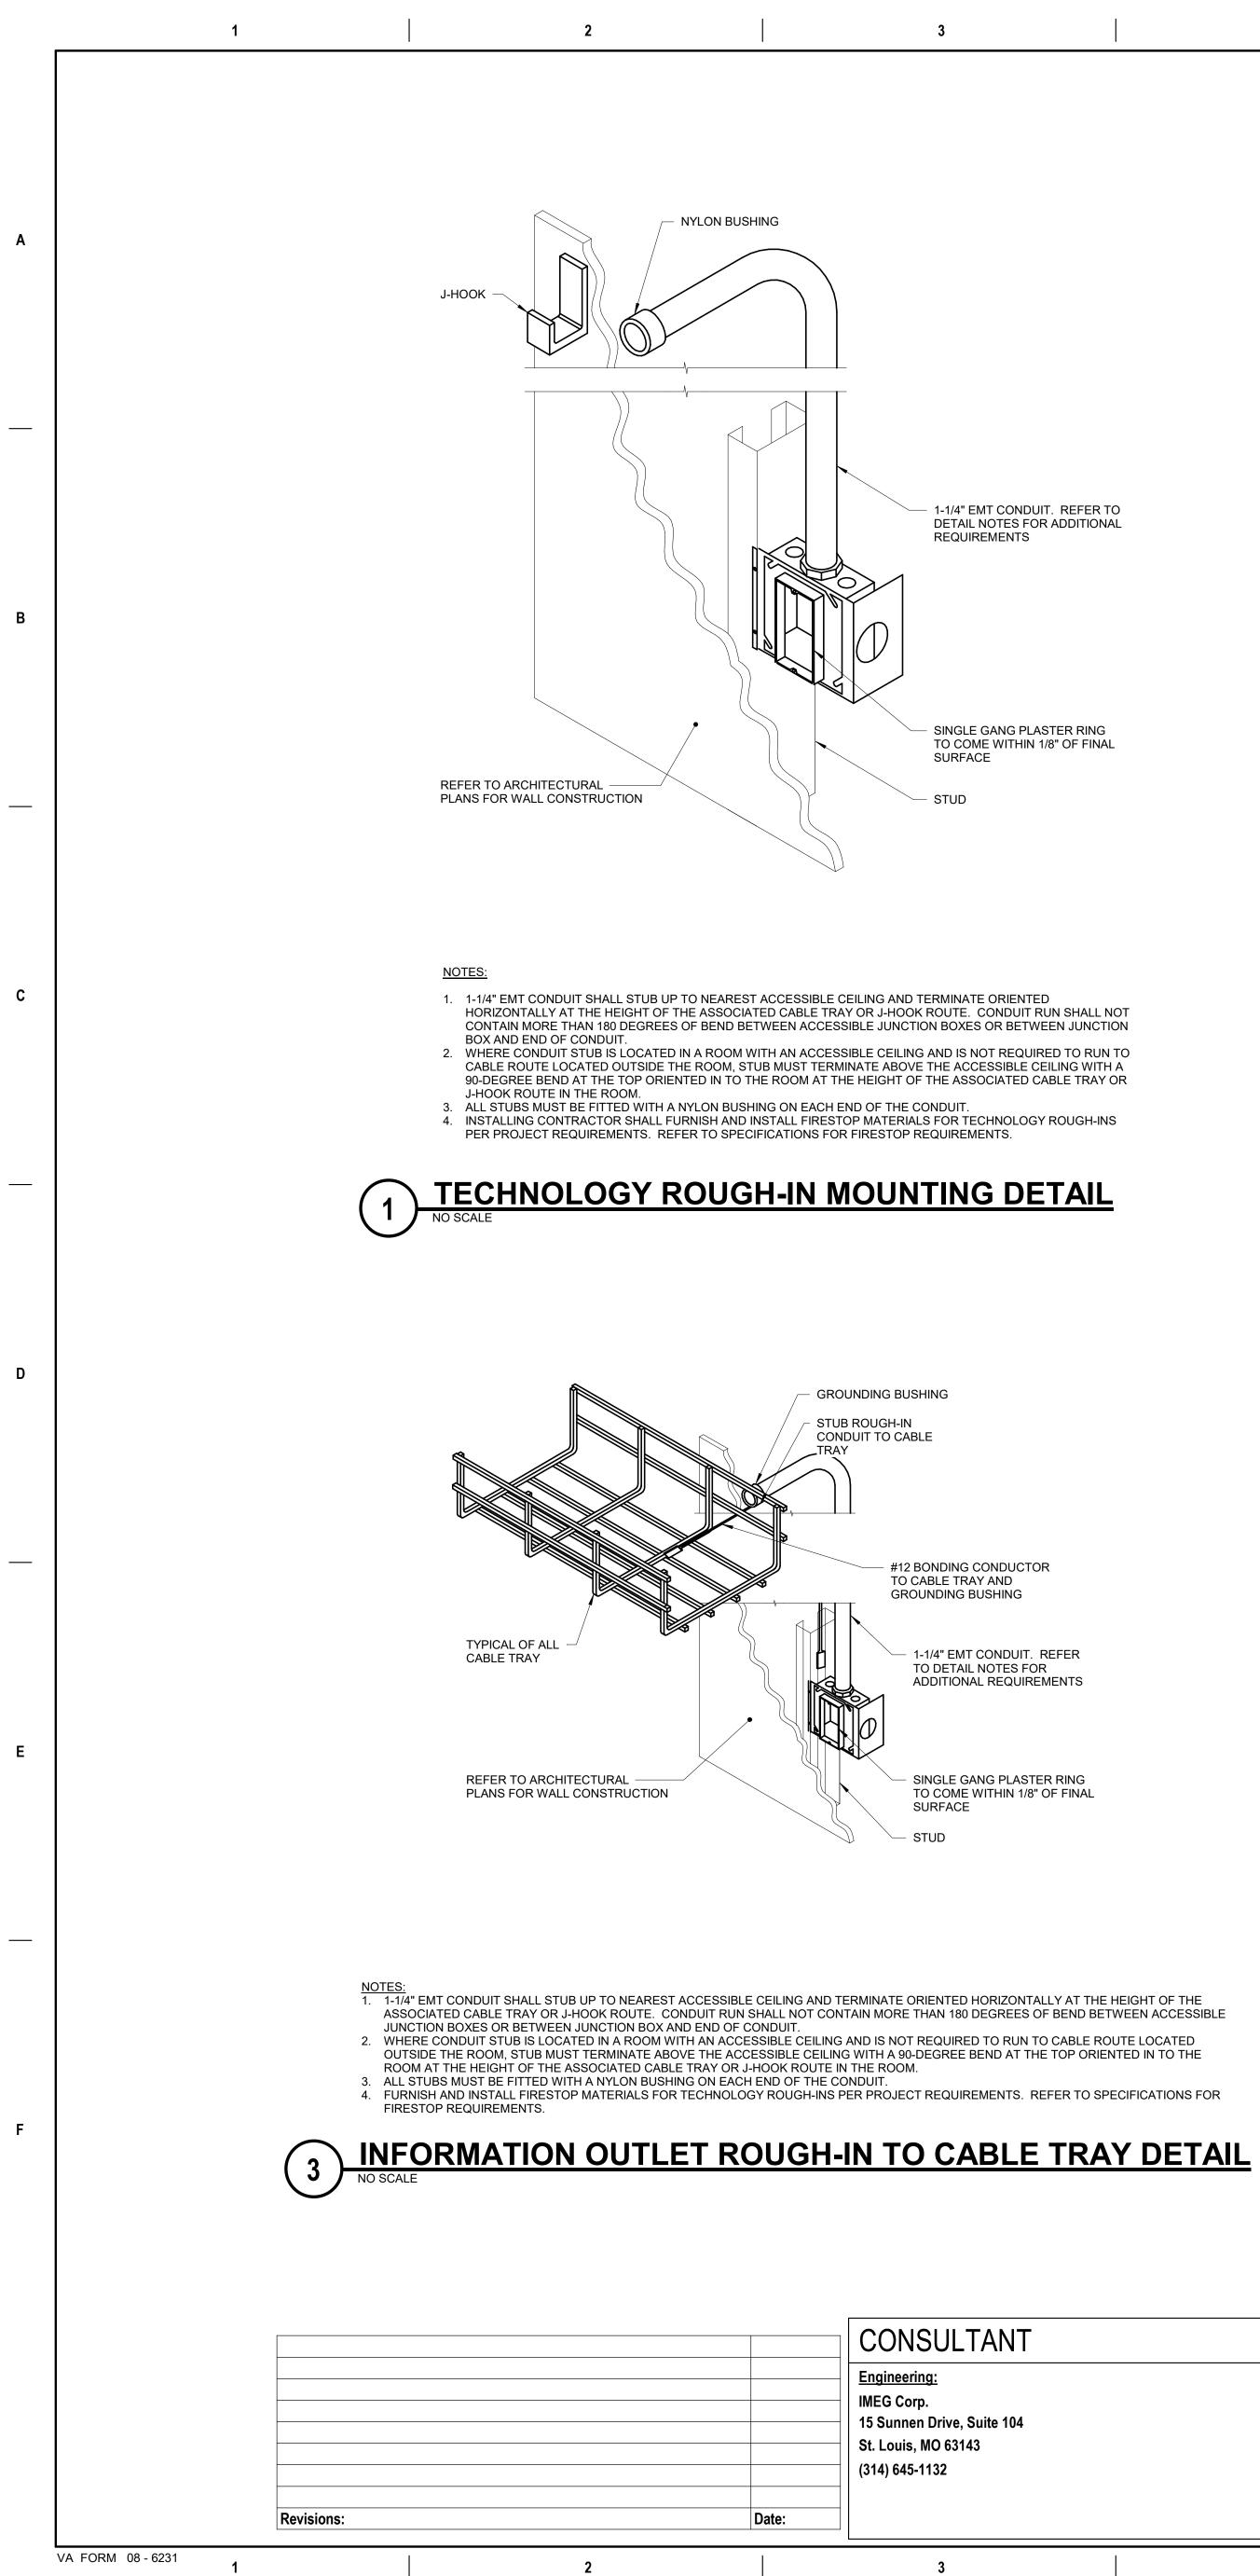
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T 4	ARCHITECT/ENGINEER OF RECORD <u>A/E:</u> Calvin L. Hinz Architects P.C. 3705 N. 200th Street Elkhorn, NE 68022 (402) 291-6941	STAMP 14176 14176 P-23-21	Office Constru- and Fac Manage
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of ction ilities	Drawing Title SECOND FLOOR PLAN - TECHNOLOGY	Phase BID DOCUMENTS	Project Title Renovate and Repair Stru Building 4
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REFER TO ARCHITECTURAL

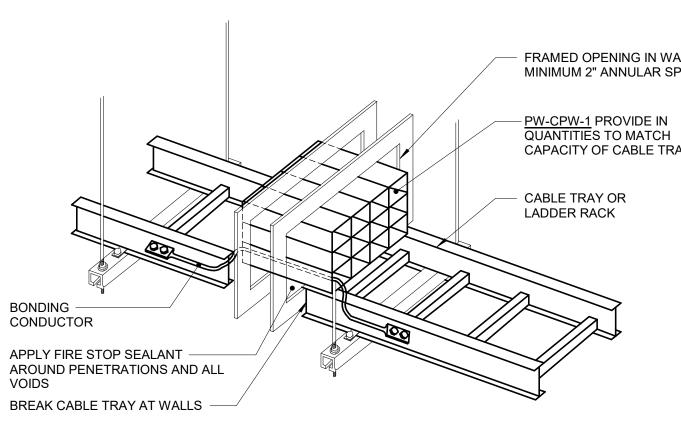
DRAWINGS FOR WALL FINISH

- 1-1/4" EMT CONDUIT. REFER TO DETAIL NOTES FOR ADDITIONAL

TO COME WITHIN 1/8" OF FINAL

3/4" EMT CONDUIT COORDINATE PENETRATION WITH ARCHITECT PRIOR TO ROUGH-IN 4-SQUARE JUNCTION BOX 4 × 4 Δ Δ· - -À -4, CAMERA AS SPECIFIED - 4 1 4 4 NOTES: 1. COORDINATE EXACT LOCATION ON SITE WITH WORK BY OTHER TRADES TO ENSURE COORDINATE EXACT LOCATION ON SITE WITH WORK BY OTHER TRADES TO ENSURE COORDINATE EXACT LOCATION ON SITE WITH WORK BY OTHER TRADES TO ENSURE COORDINATE EXACT LOCATION ON SITE WITH WORK BY OTHER TRADES TO ENSURE DESIRED VIEWING AREA AND SERVICE ACCESS AFTER COMPLETION OF PROJECT AND TO MINIMIZE ANY POSSIBLE DAMAGE TO INSTALLED CAMERA OR ASSOCIATED CABLING. 2. INSTALLING CONTRACTOR SHALL FURNISH AND INSTALL FIRESTOP MATERIALS FOR CAMERA ROUGH-INS PER PROJECT REQUIREMENTS. REFER TO SPECIFICATIONS FOR FIRESTOP REQUIREMENTS. 3. PROVIDE CAMERA MOUNTING ACCESSORIES REQUIRED FOR A COMPLETE INSTALLATION FROM THE SAME MANUFACTURER OF THE CAMERA AND APPROVED BY THE MANUFACTURER FOR USE WITH THE SPECIFIC MODEL NUMBER OF CAMERA INSTALLED. 4. SEAL WALL MOUNT BASE PLATE TO FACADE TO PREVENT WATER INFILTRATION.

2 WALL PENDANT CAMERA MOUNT AND ROUGH-IN DETAIL NO SCALE



NOTES: 1. REFER TO SPECIFICATION SECTION 17080 THROUGH PENETRATION FIRESTOPPING FOR ADDITIONAL INFORMATION. 2. REFER TO SPECIFICATIONS FOR LADDER RACK AND CABLE TRAY INFORMATION. LADDER TYPE CABLE TRAY IS ONLY SHOWN FOR CLARITY OF ILLUSTRATION. 3. PROVIDE GROUNDING LUGS WITH <u>PW-CPW-1</u> AND BOND TO GROUND PER MANUFACTURERS INSTRUCTIONS.

4. PROVIDE #6 AWG GREEN COPPER GROUND WIRE BETWEEN SECTIONS OF CABLE TRAY TO MAINTAIN CONTINUOUS GROUND. ATTACH TO CABLE TRAY WITH MANUFACTURER APPROVED GROUNDING CLAMPS OR LUGS.



9-23-21	Γ	ARCHITECT/ENGINEER OF RECORD <u>A/E:</u> Calvin L. Hinz Architects P.C. 3705 N. 200th Street Elkhorn, NE 68022 (402) 291-6941	STAMP 14176 14176 MAXE	Office Construe and Faci Manage
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e of uction cilities	Drawing Title TECHNOLOGY DETAILS	Phase BID DOCUMENTS	Project Title Renovate and Repair Structural, Building 4	Project 589 Buildin 4
ement Department eterans irs	Approved:	FULLY SPRINKLERED	Location Wichita, KS Issue Date 9/23/2021 Checker Drawn Author	Drawin
	7	8	9	10

CAPACITY OF CABLE TRAY CABLE TRAY OR

FRAMED OPENING IN WALL MINIMUM 2" ANNULAR SPACE

Structural,	Project Number 589A7-21-108 Building Number
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	Drawing Number
ed Drawn er Author	T-301

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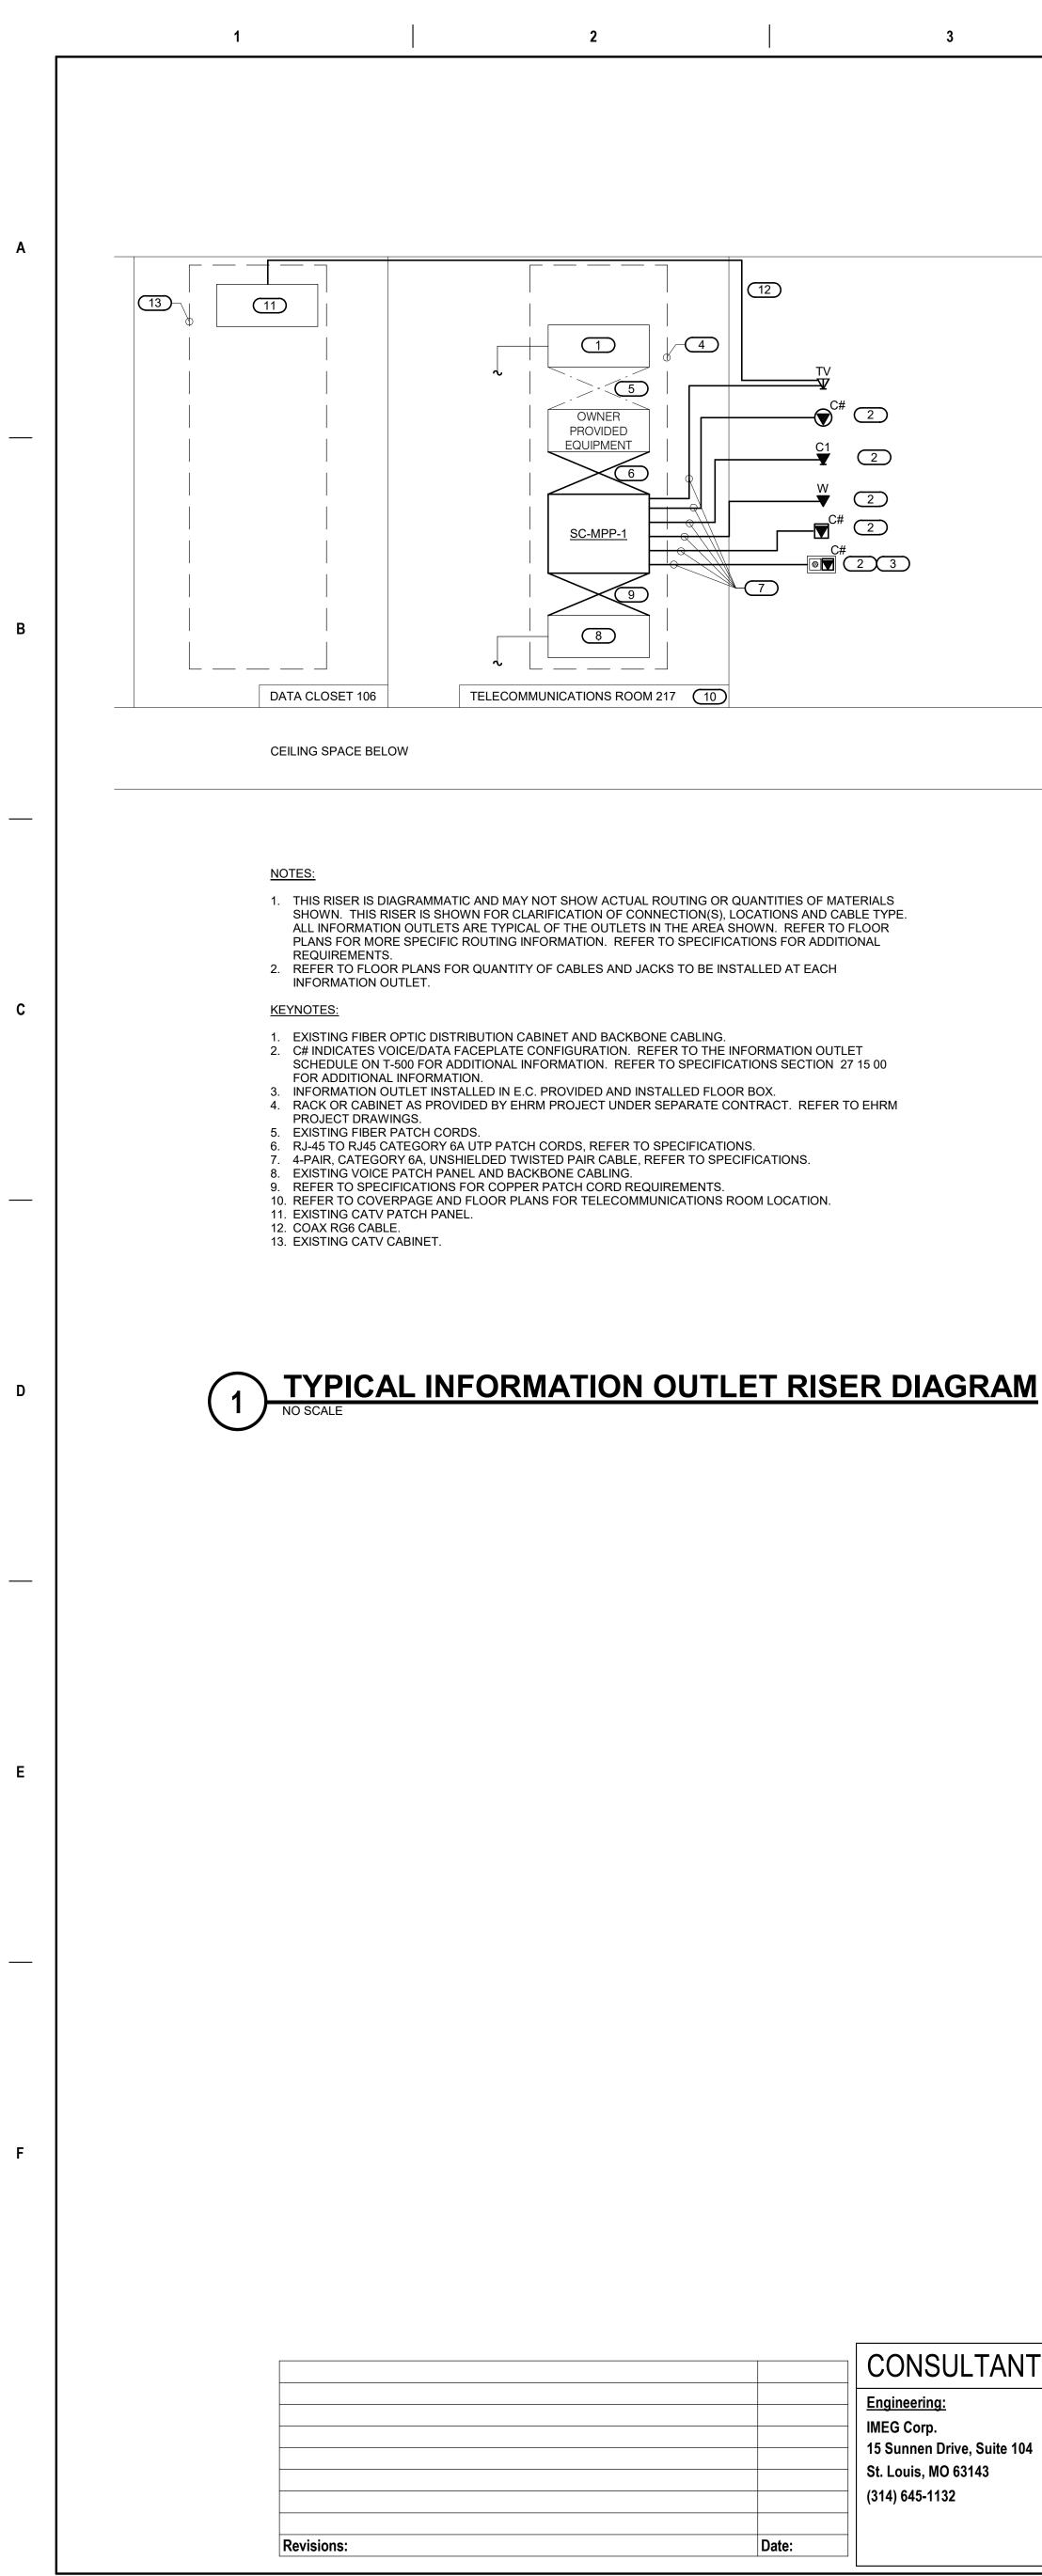
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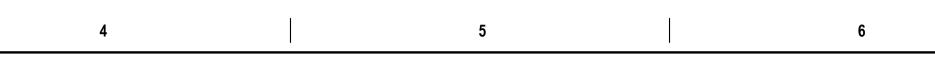
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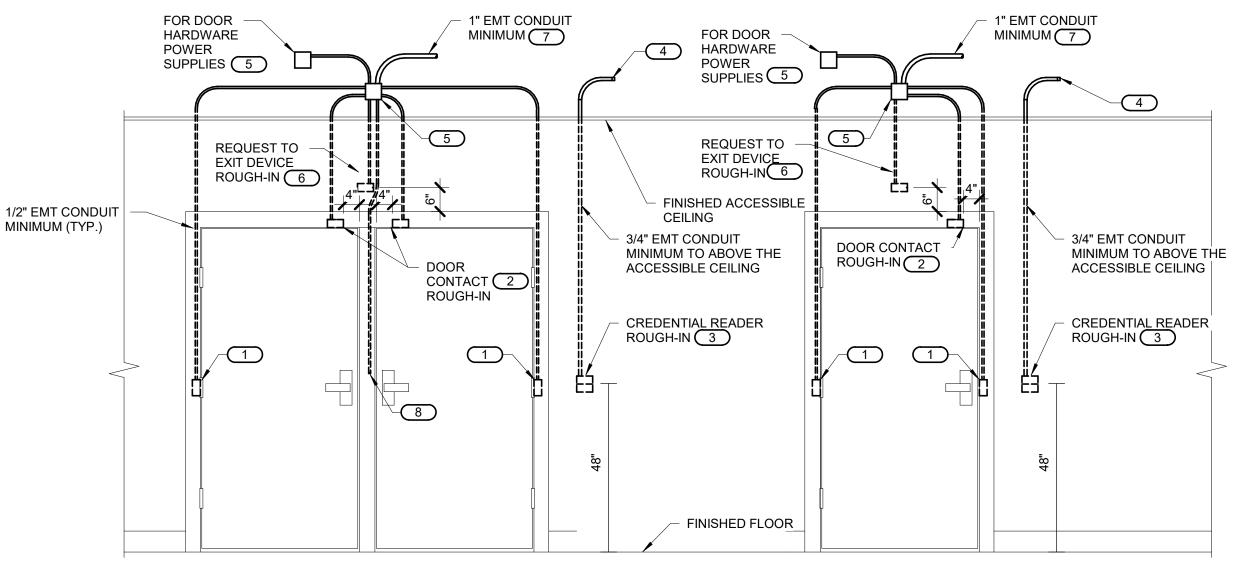
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DOOR FRAME ROUGH-IN DIAGRAM (ALL DOUBLE DOORS WITH OR WITHOUT MULLION) DOOR FRAME ROUGH-IN DIAGRAM (ALL SINGLE DOORS)

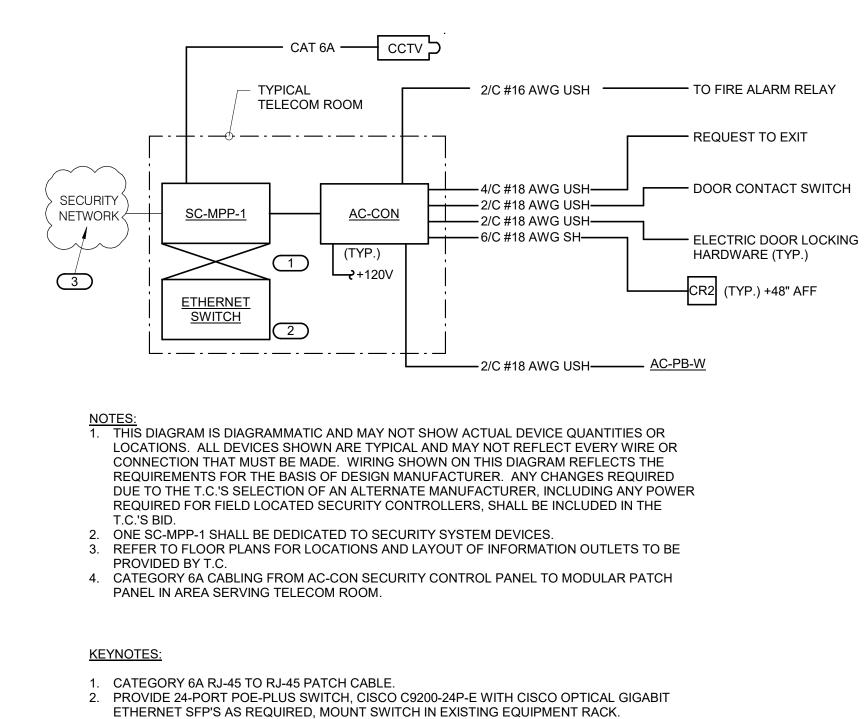
1. CONFIGURATIONS SHOWN IN THE DETAIL ABOVE ARE DIAGRAMMATIC, INTENDED TO DESCRIBE THE CONTROLLED SECURITY SCHEME ROUGH-IN REQUIREMENTS OF THE DOORS. DETAILS ABOVE MAY NOT ACCURATELY REPRESENT DOOR SIZE, DOOR SWING, DOOR HARDWARE, OR DOOR FUNCTIONALITY. REFER TO ARCHITECTURAL DOOR HARDWARE SCHEDULE, DOOR HARDWARE GROUPS AND DOOR HARDWARE SPECIFICATIONS FOR COMPLETE INFORMATION. MIRROR THE DETAIL AS REQUIRED. 2. ROUGH IN SHOWN IN THE DETAIL ABOVE REPRESENTS THE MINIMUM REQUIREMENTS FOR ALL CONTROLLED SECURITY SYSTEM DEVICES AND

- CABLING UNLESS OTHERWISE NOTED. COORDINATE EXACT REQUIREMENTS WITH SELECTED DOOR MATERIALS, DOOR HARDWARE, AND CONTROLLED SECURITY DEVICES AND CABLING PRIOR TO INSTALLATION.
- 3. ALL CABLING IN WALLS AND WHERE EXPOSED ON VERTICAL SURFACES SHALL BE INSTALLED IN EMT CONDUIT OR SURFACE MOUNT RACEWAY. CABLING ROUTED HORIZONTALLY ABOVE THE ACCESSIBLE CEILING MAY BE INSTALLED FREE-AIR CABLING PROPERLY RATED FOR THE CEILING ENVIRONMENT.
- 4. THE ELECTRICAL OR SECURITY CONTRACTOR SHALL NOT MODIFY ANY FIRE RATED DOOR AND/OR DOOR FRAME. REFER TO THE ARCHITECTURAL DOOR SCHEDULE, DOOR HARDWARE SCHEDULE, AND DOOR HARDWARE SPECIFICATION FOR ADDITIONAL INFORMATION. MODIFICATION TO ANY FIRE RATED DOOR AND/OR FRAME WILL REQUIRE A RE-CERTIFICATION OF THE DOOR AND FRAME WITH THE LOCAL AUTHORITY HAVING
- JURISDICTION (AHJ). 5. INSTALLING CONTRACTOR SHALL FURNISH AND INSTALL FIRESTOP MATERIALS FOR ALL CONTROLLED SECURITY SCHEME ROUGH-INS PER PROJECT REQUIREMENTS. REFER TO SPECIFICATIONS FOR ADDITIONAL INFORMATION AND REQUIREMENTS. 6. REFER TO THE ACCESS CONTROL RISER DIAGRAM ON 3/T-400 FOR CABLING REQUIREMENTS AND THE CONTROLLED SECURITY SCHEME SCHEDULE
- ON T-500 FOR ADDITIONAL INFORMATION. 7. INSTALLATION SHALL INCLUDE ALL POWER REQUIRED FOR SYSTEM OPERATION INCLUDING +120VAC. REFER TO THE SUGGESTED MATRIX OF SCOPE RESPONSIBILITY FOR ADDITIONAL INFORMATION.
- KEYNOTES 1. PROVIDE JUNCTION BOXES IN THE DOOR FRAME WHERE SHOWN ON THIS DETAIL. ROUGH-IN SHALL BE PROVIDED WHETHER THE CURRENT SECURITY SCHEME UTILIZES THEM OR NOT. ALL CONDUITS SHALL BE EMT CONDUIT UNLESS OTHERWISE NOTED. FLEXIBLE CONDUIT OF ANY TYPE WILL NOT BE ACCEPTED. COORDINATE INSTALLATION WITH ON-SITE DOOR FRAME INSTALLATION CONTRACTOR.
- 2. ALL DOOR POSITION SWITCHES ARE REQUIRED TO BE RECESSED UNLESS OTHERWISE NOTED. ELECTRIC HINGE MONITORS ARE NOT AN ACCEPTABLE REPLACEMENT FOR THE RECESSED DOOR POSITION SWITCH.
- 3. 4" SQUARE BACKBOX WITH SINGLE GANG PLASTER RING. PROVIDE 2 1/2" DEEP MASONRY BOX WHERE APPLICABLE. REFER TO FLOOR PLAN(S) FOR ACTUAL CREDENTIAL READER TYPE AND ROUGH-IN LOCATIONS. 4. CONDUIT SHALL ROUTE FROM THE CREDENTIAL READER TO THE SECURE SIDE OF THE DOOR. CONDUIT SHALL ROUTE TO THE NEAREST TELECOM ROOM. PROVIDE A NYLON BUSHING ON CONDUIT END.
- 5. MOUNT A MINIMUM 4" SQUARE 2-1/8" DEEP JUNCTION BOX WITH BLANK COVER PLATE ON THE SECURE SIDE OF THE DOOR ABOVE ACCESSIBLE CEILING. INSTALLING CONTRACTOR SHALL SIZE THE JUNCTION BOXES PER SYSTEM INSTALLATION REQUIREMENTS AND APPLICABLE CODES. MAINTAIN ACCESS TO THE JUNCTION BOX.
- 6. PROVIDE A HORIZONTALLY MOUNTED SINGLE GANG BACKBOX FOR THE REQUEST TO EXIT SENSOR. REFER TO THE CONTROLLED SECURITY SCHEME SCHEDULE ON T-500 FOR DOORS THAT REQUIRE THIS ROUGH-IN. 7. CONDUIT SHALL ROUTE TO THE NEAREST TELECOM ROOM. PROVIDE A NYLON BUSHING ON CONDUIT END. 8. CONDUIT INSTALLED IN PERMANENT MULLIONS ONLY. REFER TO THE ARCHITECTURAL DOOR SCHEDULE AND DOOR HARDWARE GROUPS FOR
- LOCATIONS THAT REQUIRE THIS ROUGH-IN. PROVIDE A NYLON BUSHING ON THE CONDUIT END.



Γ	ARCHITECT/ENGINEER OF RECORD	STAMP	Office of	Drawing Title TECHNOLOGY DIAGRAMS	Phase
	<u>A/E:</u> Calvin L. Hinz Architects P.C. 3705 N. 200th Street	Reflicenseo P	Construction and Facilities		BID DOCUM
	Elkhorn, NE 68022 (402) 291-6941	14176	Management	Approved:	
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3. IN EXISTING VA LOCAL POLICE STATION, REPLACE ONE(1) EXISTING NVR WITH RACK-MOUNT TYCO VIDEO EDGE 100TB NVR WITH ALL LICENSING AS REQUIRED. COORDINATE LOCATION AND PROGRAMMING WITH VA. PROVIDE 43" PROFESSIONAL GRADE 4K RESOLUTION WALL-MOUNT MONITOR WITH CONNECTIONS AS REQUIRED, COORDINATE LOCATION AND MOUNTING WITH VA.

ACCESS CONTROL AND VIDEO SURVEILLANCE RISER DIAGRAM 3 NO SCALE

e of uction cilities	Drawing Title TECHNOLOGY DIAGRAMS	Phase BID DOCUMENTS	Project Title Renovate and R Building 4	epair S
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-CR2 (TYP.) +48" AFF

Project Number				
589A7-21-108				
Building Number				
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Drawing Number				
T-401				

2. REFER TO SPECIFICATIONS SI DOOR # 001 VESTIBULE 002 VESTIBULE INTERIOR 005 JANITOR 006A CORRIDOR 006B CORRIDOR 010B CORRIDOR 019A CONFERENCE 019B CONFERENCE 019B CONFERENCE 019B CONFERENCE 021A STAIR 022 ELECTRICAL 023 ELECTRICAL 023 ELECTRICAL 023 ELECTRICAL 023 ELECTRICAL 023 ELECTRICAL 030 STORAGE 031 DATA CLOSET 032 ELECTRICAL 033 MECHANICAL 100A PANTRY/STORAGE 101 EDUCATION/PROGRAM 102A MECHANICAL 106 DATA CLOSET 109A LOBBY 109B LOBBY 109C LOBBY 111A EDUCATION PROGRAM 201 OPEN OFFICE 208A STAIRS 208B STAIRS 208B STAIRS	ITIAL READER TYPE				REMOTE UNLOCK VIA PUSHBUTTON		SCHEDULE REQUE TO EX REQUE INTERNAL CONNECTION INTERNAL CONNECTION	ST IT NUTION NOTION NOTION NUTION NUTION NUTION NUTION NUTION NUTION	• •	LOCAL ALATUS DETECTION	DR LATCH BOLT DR DOOR POSITION SWITCH SPDT (BY OTHERS)	SWITCH FOR OVERHEAD DOOR	EGRESS VAC POWER SUPPLY (BY OTHERS) E BASED LOCKING	O	NOTES
DOOR #Pgo001 VESTIBULE002 VESTIBULE INTERIOR005 JANITOR005 JANITOR006A CORRIDOR006B CORRIDOR010B CORRIDOR019A CONFERENCE019A CONFERENCE019B CONFERENCE021A STAIR022 ELECTRICAL023 ELECTRICAL023 ELECTRICAL030 STORAGE031 DATA CLOSET032 ELECTRICAL033 MECHANICAL100A PANTRY/STORAGE101 EDUCATION/PROGRAM102A MECHANICAL109A LOBBY109B LOBBY111A EDUCATION PROGRAM201 OPEN OFFICE208A STAIRS	MULTIPLE CREDENTIAL READER SINGLE MULTIPLE CREDENTIAL READER TYPE CR1 CR2 CR2 <t< th=""><th></th><th></th><th>COCKED BY EMERGENCY DURESS SEQUENC REMOTE UNLOCK VIA INTERCOM MASTER</th><th>• •</th><th>• •</th><th>• • • INTERNAL ELECTRIFIED HARDWARE CON • • •</th><th>• • •</th><th>• •</th><th></th><th>• •</th><th>DOOR POSITION SWITCH FOR OVERHEAD DO</th><th></th><th></th><th>NOTES</th></t<>			COCKED BY EMERGENCY DURESS SEQUENC REMOTE UNLOCK VIA INTERCOM MASTER	• •	• •	• • • INTERNAL ELECTRIFIED HARDWARE CON • • DOOR POSITION SWITCH FOR OVERHEAD DO			NOTES
001 VESTIBULE002 VESTIBULE INTERIOR005 JANITOR006A CORRIDOR006B CORRIDOR010B CORRIDOR010B CORRIDOR018 CORRIDOR019A CONFERENCE019B CONFERENCE021A STAIR022 ELECTRICAL023 ELECTRICAL023 ELECTRICAL023 ELECTRICAL030 STORAGE031 DATA CLOSET032 ELECTRICAL033 MECHANICAL100A PANTRY/STORAGE101 EDUCATION/PROGRAM102A MECHANICAL109A LOBBY109B LOBBY109C LOBBY111A EDUCATION PROGRAM201 OPEN OFFICE208A STAIRS	CR2 NA CR2 CR			•					. .						NOTES
006B CORRIDOR010B CORRIDOR018 CORRIDOR019A CONFERENCE019B CONFERENCE021A STAIR021B STAIR022 ELECTRICAL023 ELECTRICAL023 ELECTRICAL023 ELECTRICAL030 STORAGE031 DATA CLOSET032 ELECTRICAL033 MECHANICAL100A PANTRY/STORAGE101 EDUCATION/PROGRAM102A MECHANICAL106 DATA CLOSET109A LOBBY109B LOBBY111A EDUCATION PROGRAM111B EDUCATION PROGRAM201 OPEN OFFICE208A STAIRS	CR2								 <						
021A STAIR021B STAIR022 ELECTRICAL023 ELECTRICAL023 ELECTRICAL028A OFFICE030 STORAGE031 DATA CLOSET032 ELECTRICAL033 MECHANICAL100A PANTRY/STORAGE101 EDUCATION/PROGRAM102A MECHANICAL106 DATA CLOSET109A LOBBY109B LOBBY109C LOBBY111A EDUCATION PROGRAM201 OPEN OFFICE208A STAIRS	CR2														
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101 EDUCATION/PROGRAM102A MECHANICAL106 DATA CLOSET109A LOBBY109B LOBBY109C LOBBY111A EDUCATION PROGRAM111B EDUCATION PROGRAM201 OPEN OFFICE208A STAIRS	CR2	•	•		109C LOBBY111A EDUCATION PROGRAM111B EDUCATION PROGRAM201 OPEN OFFICE208A STAIRS	CR2 CR2 CR2 CR2 CR2 CR2 CR2	•	•		•	•	•	• • •	•		•				
									•		•		•		
															SURVEILANCE CAMERA SCHEDULE CAMERA TYPE DESCRIPTION MANUFACTURER AND M A OUTDOOR 4-SENSOR MULTIDIRECTIONAL, 4x4MP RESOLUTION, WALL MOUNT. TYCO ILLUSTRA FLEX, WITH WALL-MOUNT #IBWS-M-ISW B INDOOR 2MP RESOLUTION MINI-DOME, CEILING MOUNT. TYCO ILLUSTRA PRO, IPS02 C INDOOR 2MP RESOLUTION MINI-DOME, WALL MOUNT TYCO ILLUSTRA PRO, IPS02 D INDOOR 4-SENSOR MULTIDIRECTIONAL, 4x4MP RESOLUTION, CEILING MOUNT. TYCO ILLUSTRA FLEX WITH RECESSED MOUNT #IBCR-N E INDOOR 5MP RESOLUTION MINI-DOME, WALL-MOUNT TYCO ILLUSTRA PRO, IPS05 F OUTDOOR 2MP RESOLUTION MINI-DOME, WALL-MOUNT. TYCO ILLUSTRA PRO, IPS02 NOTE: PROVIDE FACIAL BIOMETRICS/RECOGNITION LICENSE #ADVEFVC01 FOR EACH CAMERA OF EVERY TYPE.

CONSULTANT Engineering: IMEG Corp. 15 Sunnen Drive, Suite 104 St. Louis, MO 63143 (314) 645-1132		ARCHITECT/ENGINEER OF RECORD <u>A/E:</u> Calvin L. Hinz Architects P.C. 3705 N. 200th Street Elkhorn, NE 68022 (402) 291-6941	STAMP 14176 ANS P	Office c Construct and Facili Managem
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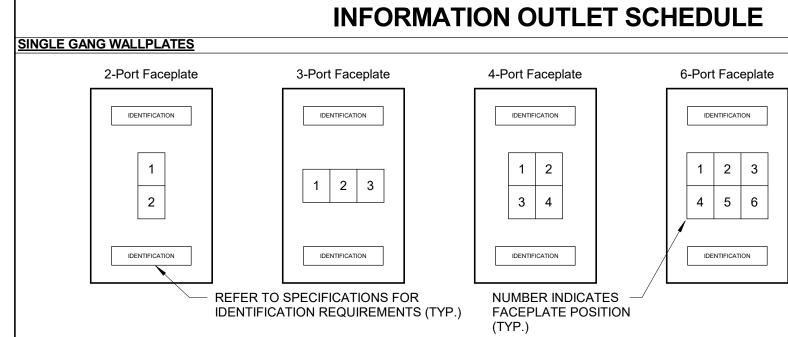
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	TECHNOLOGY EQUIPMENT SCHEDULE
	T ABBREVIATIONS AND THE GENERAL TECHNOLOGY EQUIPMENT SCHEDULE ARE FOR THE CONVENIENCE (IBLE FOR VERIFICATION OF QUANTITIES AND SHALL FURNISH ALL MATERIAL REQUIRED, WHETHER SPECIFI
	ARE NOT TO BE CONSIDERED COMPLETE BUT ARE GIVEN ONLY TO AID THE CONTRACTOR IN THE SEARCH FACTURER AND CATALOG NUMBER ONLY. EACH CONTRACTOR SHALL FIRST READ THE COMPLETE DESCRI
EQUIPMENT LIST ABBREVIATION	EQUIPMENT LIST DESCRIPTION
AC-CON	ACCESS CONTROL PANEL. WALL MOUNT, INCLUDE CONTROLLER, READER INTERFACE MODULES AND INP BOARDS. INCLUDE ASSOCIATED MULTI-OUTPUT 12/24 VOLT POWER SUPPLY.
AC-CR1-W	ACCESS CONTROL AUTHORIZATION DEVICE, CARD READER.
AC-CR2-W	ACCESS CONTROL AUTHORIZATION DEVICE, CARD READER WITH KEYPAD.
IC-VS-W	VIDEO INTERCOM STATION
IC-VSS	VIDEO INTERCOM STAFF STATION

	TECHNOLOGY EQUIPMENT SCHEDULE	
	T ABBREVIATIONS AND THE GENERAL TECHNOLOGY EQUIPMENT SCHEDULE ARE FOR THE CONVENIENCE OF THE CONTR BIBLE FOR VERIFICATION OF QUANTITIES AND SHALL FURNISH ALL MATERIAL REQUIRED, WHETHER SPECIFIED OR NOT, TO	
	S ARE NOT TO BE CONSIDERED COMPLETE BUT ARE GIVEN ONLY TO AID THE CONTRACTOR IN THE SEARCH FOR MATERIA FACTURER AND CATALOG NUMBER ONLY. EACH CONTRACTOR SHALL FIRST READ THE COMPLETE DESCRIPTION OF THE	
EQUIPMENT LIST ABBREVIATION	EQUIPMENT LIST DESCRIPTION	EQUIPMENT LIST MANUFACTURER AND MODEL
AC-CON	ACCESS CONTROL PANEL. WALL MOUNT, INCLUDE CONTROLLER, READER INTERFACE MODULES AND INPUT/OUTPUT BOARDS. INCLUDE ASSOCIATED MULTI-OUTPUT 12/24 VOLT POWER SUPPLY.	SOFTWARE HOUSE C-CURE 9000 I-STAR ULTRA
		NO APPROVED EQUAL
AC-CR1-W	ACCESS CONTROL AUTHORIZATION DEVICE, CARD READER.	
AC-CR2-W IC-VS-W	ACCESS CONTROL AUTHORIZATION DEVICE, CARD READER WITH KEYPAD.	HID RPK40-H AIPHONE IX-DVF
IC-VS-W	VIDEO INTERCOM STATION VIDEO INTERCOM STAFF STATION	AIPHONE IX-DVF
ID-MD	INTRUSION DETECTION MOTION SENSOR.	GE AP669
PA-S-C	FACILITY PAGING SPEAKER, CEILING MOUNT	BOGEN S86T725PG8UBRVR
FA-3-0	FACILITY FAGING SPEAKER, CEILING MOUNT	WITH RE84 ENCLOSURE AND TB8 CEILING TILE BRIDGE
PA-S-W	FACILITY PAGING SPEAKER, WALL-MOUNT	EXISTING
PW-CPW-1	FIRESTOP PATHWAY DEVICE	STI EZ-PATH, SERIES 44
SC-IO-C	 INFORMATION OUTLET, CEILING MOUNT, 2 PORT COVERPLATE AS INDICATED ON DRAWINGS AND INFORMATION OUTLET SCHEDULE. REFER TO INFORMATION OUTLET SCHEDULE ON TA-501 FOR PIN CONFIGURATION INFORMATION. "#"INDICATES INFORMATION OUTLET FACEPLATE CONFIGURATION AS INDICATED ON THE DRAWINGS. REFER TO INFORMATION OUTLET SCHEDULE ON TA-501 FOR ADDITIONAL INFORMATION. INFORMATION OUTLET SCHEDULE ON TA-501 FOR ADDITIONAL INFORMATION. INSTALL INFORMATION OUTLET IN A 4" SQUARE BACKBOX WITH A SINGLE GANG PLASTER RING. MOUNT TO CLOSEST STRUCTURE ELEMENTS (EX. COLUMN). INSTALL A DELXE CORD GRIP FOR STRAIN RELIEF ON UTP CABLE. PROVIDE 20' 	BRACKET: LEVITON 49223-CBC JACK: LEVITON 41089-1WP
SC-IO-F	COIL OF UTP CABLE AT WIRELESS OUTLET LOCATION. INSTALL A 1" EMT CONDUIT 6" BEYOND BOX AND TERMINATE WITH NYLONG BUSHING OR UNLESS OTHERWISE NOTED. PROVIDE REMOVABLE BLANK INSERTS FOR UNUSED PORTS. REFER TO SPECIFICATION SECTION 27 15 00 FOR ADDITIONAL INFORMATION. INFORMATION OUTLET, FLOORBOX OR POKE-THROUGH MOUNT, 4-PORT COVERPLATE AS INDICATED ON DRAWINGS	
	AND INFORMATION OUTLET SCHEDULE. REFER TO INFORMATION OUTLET SCHEDULE ON T-500 FOR PIN CONFIGURATION INFORMATION. " # " INDICATES INFORMATION OUTLET FACEPLATE CONFIGURATION AS INDICATED ON THE PLANS. REFER TO INFORMATION OUTLET SCHEDULE ON T-500 FOR ADDITIONAL INFORMATION.	COVER PLATE: IFP12 SERIES IFP14 SERIES IFP16 SERIES JACK:
	INSTALL INFORMATION OUTLET IN E.C. PROVIDED FLOORBOX. PROVIDE ADAPTER PLATE FOR 106-TYPE FACEPLATE WHERE REQUIRED. COORDINATE ADDITIONAL MOUNTING REQUIREMENTS WITH E.C. PROVIDE REMOVABLE BLANK INSERTS FOR UNUSED PORTS. REFER TO SPECIFICATION SECTION 27 15 00 FOR ADDITIONAL INFORMATION.	CAT 6A HXJ6xx SERIES
SC-IO-W	INFORMATION OUTLET, WALL MOUNT, 2 OR 4 PORT COVER PLATE AS INDICATED ON THE DRAWINGS AND INFORMATION OUTLET SCHEDULE.	
	# INDICATED INFORMATION OUTLET FACEPLATE CONFIGURATION AS INIDCATED ON THE DRAWINGS. INSTALL INFORMATION OUTLET IN A 4" SQUARE BACKBOX WITH A SINGLE GANG PLASTER RING.	APPROVED EQUAL
	INSTALL A 1-1/4" EMT CONDUIT TO NEAREST ACCESSIBLE CEILING. PROVIDE REMOVABLE BLANK INSERTS FOR UNUSED PORTS. REFER TO SPECIFICATIONS FOR ADDITIONAL INFORMATION.	
SC-MPP-1	MODULAR PATCH PANEL, 24 MODULAR RJ-45 TERMINATIONS, MOUNTS DIRECTLY TO EIA/TIA STANDARD 19" RELAY RACK, PORT IDENTIFICATION NUMBERS, PROVIDED WITH COLOR CODING AND LABEL HOLDER KITS, U.L. LISTED. REQUIRES 1.75" MOUNTING SPACES.	HUBBELL CAT 6A: HP6A24
		PANDUIT BELDEN



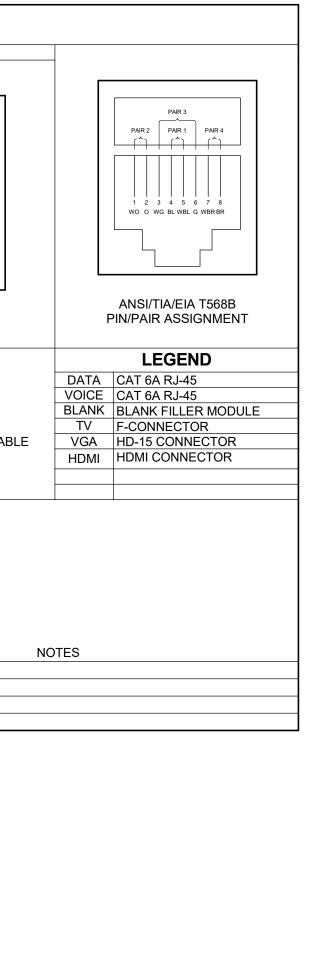
NOTES: 1. PROVIDE REMOVABLE BLANK INSERT(S) FOR ALL UNUSED PORTS. 2. REFER TO SPECIFICAITONS SECTION 27 05 53 FOR ADDITIONAL INFORMATION ON LABELING REQUIREMENTS.

<u>SCHEDULE NOTES:</u>
 1. LOCATION OF FUTURE OR OWNER PROVIDED WIRELESS ACCESS POINT. PROVIDE A 20' SLACK COIL AT THE NEAREST CABLE SUPPORT FOR POSSIBLE RELOCATION AFTER WIRELESS SURVEY.

			FACEPL					
CONFIGURATION	FACEPLATE PORTS	POSITION 1 JACK TYPE	POSITION 2 JACK TYPE	POSITION 3 JACK TYPE	POSITION 4 JACK TYPE	POSITION 5 JACK TYPE	POSITION 6 JACK TYPE	
2D	2	DATA	DATA					
2V-2D	4	VOICE	VOICE	DATA	DATA			
TV	2	TV	DATA					2.
WAP	1	DATA						1.

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